

# STATE OF NORTH CAROLINA DEPARTMENT OF TRANSPORTATION

ROY COOPER
GOVERNOR

J.R. "Joey" Hopkins
SECRETARY

March 4, 2024

County: Wake

**Subject:** Encroachment Contract

SR 2053

E051-092-23-01267

Rivercrest Realty Associates, LLC 8816 Six Forks Rd Raleigh, NC 27615

Dear Sir or Madam,

Attached for your files is a copy of Right of Way Encroachment Agreement, which has been properly executed. This contract covers the following:

815 LF of 8" Sewer main and 75 LF of 4" Sewer service and waterline tap.

CROSSING TO BE BY BORE ONLY, NO PAVEMENT CUTS ALLOWED.

A PERFORMANCE AND INDEMNITY BOND IN THE VALUE OF \$20,000 IS REQUIRED AND SHALL BE POSTED WITH THE DISTRICT OFFICE PRIOR TO THE START OF WORK.

This encroachment is approved subject to the Standard and Special Provisions which are attached to and made a part of the Encroachment Contract.

Sincerely,

Daniel T. Boulware, PE, District Engineer for B. H. Jones, PE, Division Engineer BHJ/DTB/dab

cc: Mr. Daniel Boulware (w/ orig) Town of Rolesville

Attachment

Mailing Address: NC DEPARTMENT OF TRANSPORTATION DIVISION 5 – DISTRICT 1 1575 MAIL SERVICE CENTER RALEIGH, NC 27699-1575 Telephone: (919) 814-6115 Fax: (919) 715-5778 Customer Service: 1-877-368-4968

Location: 4009 DISTRICT DRIVE RALEIGH, NC 27607

Website: www.ncdot.gov

#### **Encroachment Special Provisions**

- 1. NCDOT WORK ZONE TRAFFIC CONTROL QUALIFICATIONS AND TRAINING PROGRAM:
  - A. Effective July 1, 2010, all flagging operations within NCDOT Right of Way require qualified and trained Work Zone Flaggers.
  - B. Effective July 1, 2011, qualified and trained Work Zone Traffic Control Supervisors will be required on Significant Projects.
  - C. Training for this certification is provided by NCDOT approved training sources and by private entities that have been pre-approved to train themselves. If you have questions, contact our web site at https://connect.ncdot.gov/projects/WZTC/Pages/default.aspx, or contact Kenneth Thornewell, PE with NCDOT Work Zone Traffic Control Unit at (919) 814-5037 or kethornewell@ncdot.gov.
- 2. This encroachment agreement only covers work within NCDOT Right-of-Way as shown on the attached plans.
- 3. Current and future state projects take precedence over this encroachment.
- 4. A \$20,000.00 Performance and Indemnity Bond shall be executed and posted with the District Office at 4009 District Drive, Raleigh, North Carolina 27607, prior to beginning any work on the Right of Way. When the project has been completed for a period of one year, upon written request by the Encroacher to the District Office, a final inspection and review will be conducted by NCDOT, and if all work is found satisfactory, the bond will be released.
- 5. If there are installation conflicts with any NCDOT project, all costs associated with the adjustments and or the relocation of utilities shall be the responsibility of the encroacher with no cost to NCDOT.
- 6. Nighttime and weekend operations will NOT be allowed unless written approval is received from the District Engineer. If nighttime or weekend work is allowed or required, all signs must be retroreflective, and a work zone lighting plan must be submitted for approval prior to construction. If written approval is needed, please contact the District Office at 919-814-6115.
- 7. Any personnel or equipment working within five feet of the edge of any travel lane of an undivided facility and within 10 feet of the edge of any travel lane of a divided facility shall require a lane closure with appropriate tapers and signage in accordance with the MUTCD and the MUTCG. No lane of traffic shall be closed or restricted between the hours of 6:00 AM to 9:00 AM and 4:00 PM to 7:00 PM Monday thru Friday, during any time of inclement weather, holiday, or upon District Engineers' directive. Traffic shall be maintained at all times. Any violation of these hours will result in termination of the Encroachment Agreement and liquidated damages in the amount of \$2,000.00 per hour or any portion thereof will be assessed by the District Engineers Office.

Nighttime and weekend operations will NOT be allowed unless written approval is received from the District Engineer. If nighttime or weekend work is allowed or required, all signs must be retroreflective, and a work zone lighting plan must be submitted for approval prior to construction. If written approval is needed, please contact the District Office at 919-814-6115.

8. Notify the Town of Rolesville before starting work.

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- 9. The proposed utilities shall be placed at a minimum depth of 3 feet and at a minimum distance of 3 feet from the edge of pavement or back of curb for installation parallel to the roadway when plowing or trenching. If crossing the roadway, the proposed utility is to be a minimum depth of 5 feet below the roadway travel surface when using the conventional bore method. The proposed utility shall be placed at a minimum depth of 3 feet and at a minimum distance of 3 feet from the edge of pavement or back of curb for installation parallel to the roadway when using the directional bore method.
- 10. The proposed Sewer/Waterlines shall be installed by bore only.
- Pavement cores made to expose existing utilities shall be made with a maximum 18" pavement core. Pavement core locations shall not be placed in the wheel path whenever possible. Vacuum excavation shall be utilized to expose underground utilities. Pavement cores shall be repaired within the same working day. The pavement core shall be retained and reused to fill the core hole. The excavation shall be backfilled and compacted with select material to the bottom of the existing pavement structure or as indicated on the manufacturer's specifications. The retained core shall be placed in the hole and secured with a waterproof, mechanical joint. All materials must be listed on the NCDOT Approved Products List (APL) found here: https://apps.ncdot.gov/vendor/approvedproducts/ Prior to completion, ensure road surface is clean. If the pavement core is damaged and cannot be re-used, the core may be replaced with the surface mix, S9.5C. The asphalt patch shall match the thickness of the existing asphalt or four inches, whichever is greater. Prior to completion, ensure road surface is clean.

If it becomes necessary for NCDOT to make any repairs associated with this encroachment, then the encroaching party will be charged for all costs associated with the repair.

- 12. The proposed installation of street lighting shall be installed on existing poles, and or proposed poles only.
- 13. Guardrail that is damaged during construction shall be repaired to its original condition.
- 14. Fencing that is damaged during construction shall be repaired to its original condition.
- 15. Sidewalk, Curb and Gutter, Driveways and or Paved Walk Way (Trail) that are damaged during construction shall be repaired to its original condition.
- 16. Contractor to notify NCDOT District Engineer's Office 48 hours prior to beginning any work in the Right-of-Way. Notify Daniel T. Boulware, PE at (919) 814-6115.

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#### **Encroachment Standard Provisions**

- 1. An executed copy of this encroachment agreement will be present at the construction site at all times during construction. NCDOT reserves the right to stop all work unless evidence of approval can be shown.
- 2. NCDOT reserves the right to revise, restrict, suspend and/or void this encroachment agreement if the execution and/or operation of said permit is found to be a hazard to the traveling public.
- 3. This encroachment agreement only covers work within NCDOT Right-of-Way. The encroacher is responsible for verifying all right of way. NCDOT does not guarantee the right of way on this road. If the right of way was not obtained by the fee simple method, it is the responsibility of the encroacher to obtain permission from the underlying property owner/owners.
  - Encroacher shall be responsible for obtaining all necessary permanent and/or temporary construction, drainage, utility and/or sight distance easements. All Right of Way and easements necessary for construction and maintenance shall be dedicated to NCDOT with proof of dedication furnished to the District Engineer prior to beginning work.
- 4. Notify the District Engineer's Office at (919) 814-6115 or at 4009 District Drive, Raleigh, NC 27607, prior to beginning and after completion of work.
- 5. The encroacher is responsible for any claim for damages brought by any property owner by reason of the installation.
- 6. The Encroacher shall notify the public, including all adjacent property owners and businesses, a minimum of 2 weeks prior to beginning work.
- 7. Any and all changes noted in red on the plans shall be incorporated into and made part of the approved permit.
- 8. The encroaching party shall comply with all applicable local, state and federal environmental regulations, and shall obtain all necessary state and federal environmental permits, including but not limited to, those related to sediment control, storm water, wetland, streams, endangered species, and historical sites.
- 9. All materials and construction shall be in accordance with NCDOT standards and specifications, including but not limited to, the NCDOT Standard Specifications for Roads and Structures 2012, the NCDOT Roadway Standards Drawings, and NCDOT Policies and Procedures for Accommodating Utilities on Highway Rights of Way.
- 10. The encroacher shall provide traffic control devices, lane closures, road closures, positive protection and/or any other warning or positive protection devices necessary for the safety of road users during construction and any subsequent maintenance. This shall be performed in conformance with the latest NCDOT Roadway Standard Drawings and Standard Specifications for Roads and Structures and Amendments or Supplements thereto. When there is no guidance provided in the Roadway Standard Drawings or Specifications, comply with the Manual on Uniform Traffic Control Devices for Streets and Highways and Amendments or Supplements thereto. No work shall be performed in the Right of Way unless this requirement is satisfied. NCDOT reserves the right to require a written traffic control plan for encroachment operations.

Sidewalk closures shall be installed as necessary. Pedestrian traffic shall be detoured around these closures and shall be signed appropriately and in accordance with The American with Disabilities Act Accessibility Guidelines.

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- 11. No parking or material storage shall be allowed along the shoulders of any NCDOT roadways.
- 12. Two-way traffic shall be maintained at all times.
- 13. No lane closures shall be permitted between the hours of 6:00 AM to 9:00 AM and 4:00 PM to 7:00 PM, Monday through Friday unless otherwise specified in the Special Provisions of this encroachment agreement.
- 14. At the end of each working day, equipment shall be parked outside of the clear recovery zone in order to avoid any obstruction to the travelling public. This clear recovery zone is measure from the edge of the nearest travel lane.
- 15. Work shall not be performed on both sides of the road simultaneously within the same area.
- 16. Ingress and egress shall be maintained to all businesses and dwellings at all times.
- 17. All (cast-in-place and/or pre-cast) splice boxes, handholes, manholes, drainage structures and other appurtenances within NCDOT Right of Way shall be of a NCDOT approved design for traffic bearing, HS-20 loading, and shall be flush mounted. Manholes, handholes and vaults shall not be placed in the ditch-line, side slopes of the ditch or in the pavement.
  - All frames, grates, rings, covers, etc. are to be manufactured in accordance with the requirements of Section 106-1B "Domestic Steel". Foreign castings are not approved for use within NCDOT Right of Way.
- 18. All above ground appurtenances associated with the installation of the proposed utility shall be located/relocated at or as near as possible to the right-of-way line and shall be set outside the Clear Recovery Area as outlined by AASHTO.
- 19. Directional drilling methods have not been given Statewide approval for use on NCDOT right of way. Under no condition shall jetting alone or wet boring with water of utility pipelines be allowed. Directional boring using jetting with a Bentonite (or equivalent material) slurry is approved for this installation at a minimum depth of ten (10) feet below the pavement surface {fifteen (15) feet below the surface of partial and /or full control of access roads} and 5' below any ditch line. Any parallel installation utilizing the directional boring method shall be made at a minimum depth of three (3) feet (cover) below the ground surface and outside the theoretical 1:1 slope from the existing edge of pavement where the parallel installation crosses a paved roadway. The tip of the drill string shall have a cutter head. Detection wire shall be installed with non-ferrous material. Any changes shall be submitted to the District Engineer prior to any consideration. For multiple conduit installations (including perpendicular and parallel installations), install conduits with five (5) feet horizontal separation between each conduit or install multiple conduits with a single duct. An overbore shall not be more than two (2) inches greater than the diameter of the pipe, encasement, or duct. An overbore exceeding two (2) inches greater than the diameter of the pipe, encasement, or duct will be considered if the encroachment agreement includes a statement signed and sealed by a North Carolina Registered Professional Engineer indicating that an overbore in excess of two (2) inches of the diameter of the pipe, encasement, or duct will arch and no damage will be done to the pavement or subgrade. HDPE Pipe installed by directional boring shall not be connected to existing pipe or fittings for one week from the time of installation to allow tensional stresses to relax.
- 20. All crossings of state maintained routes shall be by bore only, unless otherwise stated in this encroachment agreement.
- 21. Underground utilities may cross perpendicularly but not run longitudinally under the pavement.

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- 22. At points where the utility is placed under existing storm drainage, the trench will be backfilled with concrete up to the outside diameter of the existing pipe in compliance with NCDOT standards.
- 23. The paving of this roadway shall be in accordance with the revised NCDOT 2012 Standard Specifications, Sections 610, 1012 and 1020. The Contractor shall follow all procedures of the attached Quality Management System (QMS) for asphalt pavement Maintenance Version. The Contractor must adhere to all testing requirements and quality control requirements specified. The Contractor shall contact the NCDOT Division 5 QA Supervisor at (919) 562-0018 prior to producing plant mix and make the Supervisor aware that the mix is being produced for a future NCDOT road. Only NCDOT approved mix designs will be acceptable. A quality control plan shall be submitted to the District Engineer's Office prior to asphalt production. Use form QMS-MV1 for the Quality Control Plan submittal. Failing mixes and/or densities are subject to penalties including monetary payments or removal and replacement.
- 24. Roadway certification reports sealed by a Professional Engineer shall be submitted to the North Carolina Department of Transportation at 4009 District Drive, Raleigh, North Carolina, indicating the following:
  - \* Pavement thickness by type
  - \* Pavement density, core and/or test locations
  - \* Base thickness
  - \* Base density
  - \* Subgrade density

Test frequency and method shall be in conformance with the NCDOT "Materials and Tests" Manual. Test must be performed by a Certified Technician including name and Certification number on report.

- 25. Any existing driveways, pavement, sidewalk, curb and gutter or drainage structures that are damaged during construction shall be repaired to their original condition.
- 26. All meter bases and services shall be located/relocated at or as near as possible to the right-of-way line.
- 27. Pedestals shall be placed a maximum of one foot inside the Right of Way.
- 28. Fire Hydrants shall be of the break-away type. Hydrants shall be placed a maximum of one foot inside the right of way in ditch sections or a minimum of 6 feet behind the curb in curb and gutter sections.
- 29. Hot boxes shall be located outside sight distance triangles and off of the NCDOT Right-of-Way.
- 30. When surface area in excess of one acre will be disturbed, the Encroacher shall submit a Sediment and Erosion Control Plan which has been approved by the appropriate regulatory agency or authority prior to beginning any work on the Right of Way. Failure to provide this information shall be grounds for suspension of operations.
- 31. All erosion control devices and measures shall be constructed, installed, maintained, and removed by the Encroacher in accordance with all applicable Federal, State, and Local laws, regulations, ordinances, and policies. All earth areas shall be regraded and seeded in accordance with NCDOT Standards Specifications for Roads and Structures 1995. Seeding rates per acre shall be the following: \* Year Round Mixture: 50# Pensacola Bahia Grass; 50# KY 31 Tall Fescue; 5# Centipede; 500# 10-20-20 Fertilizer; 4000# Limestone;
  - \* 2:1 Slopes Standard Mix: Use Year Round Mixture (Delete Centipede); Add 25# Service Lespedeza; \* If Using Crown Vetch on 2:1 Slope (September-May): Use Year Round Mixture; Add Crown Vetch 15 lbs./Ac.; (Delete Centipede and Bahia)

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- 32. The applicant is responsible for identifying project impacts to waters of the United States (wetlands, intermittent streams, perennial streams and ponds) located within the NCDOT right-of-way. The discharge of dredged or fill material into waters of the United States requires authorization from the United States Army Corps of Engineers (USACE) and certification from the North Carolina Division of Water Quality (NCDWQ). The applicant is required to obtain pertinent permits or certification from these regulatory agencies if construction of the project impacts waters of the United States within the NCDOT right-of-way. Additional information can be obtained by contacting the USACE or NCDWQ.
- 33. The applicant is responsible for avoiding impacts to federally protected species during project construction. Bald eagle, Michaux's sumac, smooth coneflower, dwarf wedgemussel, harperella, red-cockaded woodpecker and tar spinymussel are federally protected species that have been identified within NCDOT right-of-way in Durham, Person, Granville, Wake, Franklin, Vance, and Warren counties. Additional information can be obtained by contacting the North Carolina Natural Heritage Program or the United States Fish and Wildlife Services.
- 34. The applicant is responsible for complying with the Neuse and Tar-Pamlico Riparian Buffer Rule as regulated by the NCDWQ. The Rule regulates activity within a 50-foot buffer along perennial streams, intermittent streams and ponds. Additional information can be obtained by contacting the NCDWQ.
- 35. Existing drainage patterns shall be maintained at all times throughout the proposed construction. The encroacher shall keep the roadway clean of dirt and debris at all times throughout the duration of the project.
- 36. The Division Traffic Engineer shall be notified at (919) 220-4600 prior to any excavation within 500 feet of a signalized intersection or if there are existing NCDOT signs in or near the proposed work zone. All traffic signal or detection cables must be located prior to excavation. All signal work and traffic signs shall be coordinated with the Division Traffic Engineer. Costs to relocate, replace, or repair NCDOT signs, signals, or associated equipment shall be the responsibility of the Encroacher.
- 37. All temporary and final pavement markings, reflective pavement markings and signage are the responsibility of the Encroacher. All final pavement markings shall be thermoplastic. Any pavement markings that are damaged or obliterated shall be restored at no expense to NCDOT.
- 38. All Traffic signs moved shall be reinstalled as soon as possible to meet NCDOT specifications.
- Strict compliance with the Policies and Procedures for Accommodating Utilities on Highway Right of Way manual shall be required.
- 40. It shall be the responsibility of the Encroacher to determine the location of other utilities within the encroachment area. The Encroacher shall be responsible for notifying other utility owners and providing protection and safeguards to prevent damage or interruption to existing facilities and to maintain accessibility to existing utilities.
- 41. All earth areas disturbed shall be regraded and reseeded in accordance with Division of Highways Standards and Specifications.
- 42. The Encroacher shall remove all trees, stumps and vegetative material from the right of way and dispose of in a licensed landfill or disposal site.
- 43. Excavated material shall not be placed on the roadway at any time.
- 44. Trenching, bore pits and/or other excavations shall not be left open or unsafe overnight. The Contractor shall comply with all OSHA requirements and provide a competent person on site to supervise excavation at all times.

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- 45. All excavations inside the theoretical 1:1 slope from the existing edge of pavement to the bottom of the nearest excavation wall should be made in accordance with the following conditions. Traffic should be moved to a travel lane outside the limits of a theoretical one-to-one slope from the bottom of the nearest trench wall to the pavement surface. Active excavation shoring, such as sheet piling, shall be installed. The design of the shoring shall include the effects of traffic loads. The shoring system shall be designed and sealed by an engineer registered in North Carolina. Trench boxes shall not be accepted as shoring. The trench backfill material should meet the Statewide Borrow Criteria.
- 46. Excavated areas adjacent to pavement having more than a 2 inch drop shall be made safe with a 6:1 or flatter slope and shall be designated by appropriate delineation during periods of construction inactivity, including, but not limited to, night and weekend hours.
- 47. Backfill material is to be placed at a maximum of 6 inch loose layers and each layer thoroughly compacted. All embankment backfill shall be compacted to 95% density and all subgrade to 100% density in accordance with AASHTO T-99 as modified by NCDOT. They shall be signed by a Professional Engineer and sent to the District Engineers Office at 4009 District Drive, Raleigh, NC 27607.
- 48. No commercial advertising shall be allowed within NCDOT Right of Way.
- 49. Guardrail shall be installed where warranted and in accordance with the guidelines shown in the 2012 Highway Design Branch Roadway Standard Drawings.
  - Guardrail removed or damaged during construction shall be replaced or repaired to their original condition.
- 50. Poles shall be located/relocated at or as near as possible to the right-of-way line, shall be set outside the Clear Recovery Area as outlined by AASHTO and outside sight distance triangles.
  - Poles located within guardrail sections shall be installed a minimum of 5 feet behind any guardrail. When applicable, poles shall be placed behind sidewalk.
  - Any associated guy wires to ground anchors and stub poles shall not be placed between a pole and the travel way and should be located outside the clear recovery area.
  - Minimum vertical clearance shall be 18' for aerial crossings over NCDOT roadways and 15'-6" for installations parallel to the roadway.
- 51. Fire Hydrants shall be of the break-away type. Hydrants shall be placed a maximum of one foot inside the right of way in ditch sections or a minimum of 6 feet behind the curb in curb and gutter sections.
- 52. Retaining walls or other vertical structures shall not be permitted inside NCDOT right of way.
- 53. Current and future state projects take precedence over this encroachment.

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ROUTE SR-2053 PROJECT JONES DAIRY STORAGE FACILITY COUNTY OF WAKE

ROUTE SR-2053 PROJECT	JONES DAIRY STORAGE FACILITY COUNTY OF WAKE
DEPARTMENT OF TRANSPORTATION	THREE PARTY RIGHT OF WAY
AND	ENCROACHMENT AGREEMENT ON
RIVERCREST REALTY ASSOCIATES, LLC	PRIMARY AND SECONDARY SYSTEM
8816 Six Forks Rd, #201, Raleigh, NC 27615	
-AND-	
City of Raleigh	
1 Exchange Plaza, #620, Raleigh, NC 27601	
of Transportation, party of the first part; and CI	this the <u>25th</u> day of <u>June</u> , 20 <u>24</u> , by and between the Department of RALEIGH  party of the second part; and RIVERCREST REALTY ASSOCIATES, LLC
	party of the second part, and party of the third part,
THAT WHEREAS, the party of the second Route(s) SR-2053 SR-2053 (JONES DAIRY ROAD) AND SR-4403 (WINTER SPE	WITNESSETH  ond part desires to encroach on the right of way of the public road designated as , locatedFROM THE INTERECTION OF
with the construction and/or erection of: APPROX	(IMATELY 700-LF OF SEWER MAIN CONSTRUCTION IN JONES DAIRY RIGHT-OF-WAY & TAP AND EXTENSION OF

WHEREAS, it is to the material advantage of the party of the second part to effect this encroachment, and the party of the first part in the exercise of authority conferred upon it by statute, is willing to permit the encroachment within the limits of the right of way as indicated, subject to the conditions of this agreement;

WATER SERVICES FOR FIRE PROTECTION AND DOMESTIC WATER SERVICE

NOW, THEREFORE, IT IS AGREED that the party of the first part hereby grants to the party of the second part the right and privilege to make this encroachment as shown on attached plan sheet(s), specifications and special provisions which are made a part hereof upon the following conditions, to wit:

That the installation, operation, and maintenance of the above described facility will be accomplished in accordance with the party of the first part's latest <u>UTILITIES ACCOMMODATIONS MANUAL</u>, and such revisions and amendments thereto as may be in effect at the date of this agreement. Information as to these policies and procedures may be obtained from the Division Engineer or State Utilities Manager of the party of the first part.

That the said party of the second part binds and obligates himself to install and maintain the encroaching facility in such safe and proper condition that it will not interfere with or endanger travel upon said highway, nor obstruct nor interfere with the proper maintenance thereof, to reimburse the party of the first part for the cost incurred for any repairs or maintenance to its roadways and structures necessary due to installation and existence of the facilities of the party of the second part, and if at any time the party of the first part shall require the removal of or changes in the location of the said facilities, that the said party of the second part binds himself, his successors and assigns, to promptly remove or alter the said facilities, in order to conform to the said requirement, without any cost to the party of the first part.

That the party of the second part agrees to provide during construction and any subsequent maintenance proper signs, signal lights, flagmen and other warning devices for the protection of traffic in conformance with the latest Manual on Uniform Traffic Control Devices for Streets and Highways and Amendments or Supplements thereto. Information as to the above rules and regulations may be obtained from the Division Engineer of the party of the first.

That the party of the second part hereby agrees to indemnify and save harmless the party of the first part from all damages and claims for damage that may arise by reason of the installation and maintenance of this encroachment.

That the party of the second part agrees to restore all areas disturbed during installation and maintenance to the satisfaction of the Division Engineer of the party of the first part. The party of the second part agrees to exercise every reasonable precaution during construction and maintenance to prevent eroding of soil; silting or pollution of rivers, streams, lakes, reservoirs, other water impoundments, ground surfaces or other property; or pollution of the air. There shall be compliance with applicable rules and regulations of the North Carolina Division of Environmental Management, North Carolina Sedimentation Control Commission, and with ordinances and regulations of various counties, municipalities and other official agencies relating to pollution prevention and control. When any installation or maintenance operation disturbs the ground surface and existing ground cover, the party of the second part agrees to remove and replace the sod or otherwise reestablish the grass cover to meet the satisfaction of the Division Engineer of the party of the first part.

That the party of the second part agrees to assume the actual cost of any inspection of the work considered to be necessary by the Division Engineer of the party of the first part.

That the party of the second part agrees to have available at the construction site, at all times during construction, a copy of this agreement showing evidence of approval by the party of the first part. The party of the first part reserves the right to stop all work unless evidence of approval can be shown.

Provided the work contained in this agreement is being performed on a completed highway open to traffic; the party of the second part agrees to give written notice to the Division Engineer of the party of the first part when all work contained herein has been completed. Unless specifically requested by the party of the first part, written notice of completion of work on highway projects under construction will not be required.

That in the case of noncompliance with the terms of this agreement by the party of the second part, the party of the first part reserves the right to stop all work until the facility has been brought into compliance or removed from the right of way at no cost to the party of the first part.

That it is agreed by both parties that this agreement shall become void if actual construction of the work contemplated herein is not begun within one (1) year from the date of authorization by the party of the first part unless written waiver is secured by the party of the second part from the party of the first part.

During the performance of this contract, the second party, for itself, its assignees and successors in interest (hereinafter referred to as the "contractor"), agrees as follows:

- a. Compliance with Regulations: The contractor shall comply with the Regulations relative to nondiscrimination in Federally-assisted programs of the U.S. Department of Transportation, Title 49, Code of Federal Regulations, Part 21, as they may be amended from time to time, (hereinafter referred to as the Regulations), which are herein incorporated by reference and made a part of this contract.
- b. Nondiscrimination: The contractor, with regard to the work performed by it during the contract, shall not discriminate on the grounds of race, color, or national origin in the selection and retention of subcontractors, including procurements of materials and leases of equipment. The contractor shall not participate either directly or indirectly in the discrimination prohibited by Section 21.5 of the Regulations, including employment practices when the contract covers a program set forth in Appendix B of the Regulations.
- c. <u>Solicitations for Subcontracts, including Procurements of Materials and Equipment:</u> In all solicitations either by competitive bidding or negotiation made by the contractor for work to be performed under a subcontract, including procurements of materials or leases of equipment, each potential subcontractor or supplier shall be notified by the contractor of the contractor's obligations under this contract and the Regulations relative to nondiscrimination on the grounds of race, color, or national origin.
- d. <u>Information and Reports</u>: The contractor shall provide all information and reports required by the Regulations, or directives issued pursuant thereto, and shall permit access to its books, records, accounts, other sources of information, and its facilities as may be determined by the Department of Transportation or the Federal Highway Administration to be pertinent to ascertain compliance with such Regulations or directives. Where any information required of a contractor is in the exclusive possession of another who fails or refuses to furnish this information, the contractor shall so certify to the Department of Transportation, or the Federal Highway Administration as appropriate, and shall set forth what efforts it has made to obtain the information.
- e. <u>Sanctions for Noncompliance</u>: In the event of the contractor's noncompliance with the nondiscrimination provisions of this contract, the Department of Transportation shall impose such contract sanctions as it or the Federal Highway Administration may determine to be appropriate, including, but not limited to.
  - (1) withholding of payments to the contractor under the contract until the contractor complies, and/or
  - (2) cancellation, termination or suspension of the contract, in whole or in part.
- f. Incorporation of Provisions: The contractor shall include the provisions of paragraphs "a" through "f" in every subcontract, including procurements of materials and leases of equipment, unless exempt by the Regulations, or directives issued pursuant thereto. The contractor shall take such action with respect to any subcontract or procurement as the Department of Transportation or the Federal Highway Administration may direct as a means of enforcing such provisions including sanctions for noncompliance: Provided, however, that, in the event a contractor becomes involved in, or is threatened with, litigation with a subcontractor or supplier as a result of such direction, the contractor may request the Department of Transportation to enter into such litigation to protect the interests of the State, and, in addition, the contractor may request the United States to enter into such litigation to protect the interests of the United States.

That when title to the subject that constitutes the aforesaid encroachment passes from the party of the second part and vests in the party of the third part, the party of the third part agrees to assume all responsibilities and rights and to perform all obligations as agreed to herein by the party of the second part.

R/W (166): Party of the Second Part certifies that this agreement is true and accurate copy of the form R/W (166) incorporating all revisions to date.

IN WITNESS WHEREOF, each of the parties to this agreement has caused the same to be executed the day and year first above written.

**DEPARTMENT OF TRANSPORTATION** 

	DI.
	FOR DIVISION ENGINEER
WITNESS:	
Beron Holser	RIVERLEST LEAVY ASSOCIATES, LU
12	DOWARAN LATURES
BBUS SIX FOLING Rd. STE 201	BBIL SIX FOUNTS. SE 201
FATERIA, NC 27615	RADIENT NC 27605
	Second Party
WITNESS: — DocuSigned by:	DocuSigned by:
Cassidy R. Fhirmard (1967)	Paul Zallam
—48A968CF29FA44B  City Clerk or designee Cassidy Pritchard	
City of Raleigh	Paul Kallam, Director of Transportation  City of Raleigh
	Third Party

#### MA-22-09 CONDITIONS OF APPROVAL

- ACCOMPANYING EXHIBIT D CONCEPT PLAN, LOCATIONS SHOWN FOR COMMITTED ELEMENTS
- BUFFER OTHERWISE REQUIRED BY THE LDO (THE "UNDISTURBED VEGETATION AREA"). THIS SHALL EXCLUDE MINOR ENCROACHMENTS FOR SITE DESIGN FEATURES. SUCH AS DRAINAGE AREAS OR
- ALL EXTERIOR LIGHT FIXTURES SHALL BE FULL CUTOFF FIXTURES, EXCEEDING THE MINIMUM
- STANDARD OF "CUTOFF FIXTURES" AS REQUIRED BY LDO § 6.6.G.2.
- IF THE EXISTING VEGETATION IS REMOVED IN THE BUFFER AREA OTHERWISE REQUIRED BY THE VEGETATION AREA TO THE RIGHT-OF-WAY ON JONES DAIRY ROAD, THE FOLLOWING ADDITIONAL PERIMETER EASEMENT THAT WOULD PREVENT SUCH PLANTINGS: FAST-GROWING DENSE EVERGREEN TREES 15-FT ON CENTER. THE EVERGREEN TREES SHALL HAVE A MINIMUM MATURE HEIGHT OF 30-FT AND A SPREAD OF 12-FT. INSTALL HEIGHT SHALL BE 4-FT MINIMUM.
- AT LEAST SEVENTY-FIVE PERCENT (75%) OF ANY REQUIRED PLANTS IN THE STORMWATER CONTROL MEASURE POND, EXCLUDING GRASSES, SHALL BE POLLINATOR PLANTS SUCH AS NATIVE MILKWEEDS AND OTHER NECTAR-RICH FLOWERS.
- GATES TO ACCESS AREAS WITH EXTERIOR-ACCESS STORAGE UNITS SHALL BE LOCKED BETWEEN ON EXTERIOR FAÇADES FACING A PUBLIC RIGHT-OF-WAY OR EXTERIOR FAÇADES FACING PINS
- 1850700632, 1850604353, 1850605343, 1850606333, 1850607323, AND 1850608313; 7.1. THE FOLLOWING MATERIALS ARE PROHIBITED: CINDERBLOCK, CONCRETE, METAL SIDING, AND
- 7.2. BRICK, EIFS BRICK, STONE, OR CONCRETE MASONRY COMPONENTS SHALL BE A MINIMUM OF

# SITE PLAN REVIEW DRAWINGS: FOR

# JONES DAIRY STORAGE FACILITY

1200 JONES DAIRY RD ROLESVILLE, NC 27587

SITE PLAN#: SDP-23-03 REZONING CASE #: MA-22-09 TEXT AMENDMENT CASE #: TA-22-02

**Sheet List Table** 

COVER

**GRADING & DRAINAGE PLAN** 

SITE UTILITY PLAN

OFF-SITE UTILITY PLAN OFF-SITE UTILITY PROFILE

FIRE HOSE LAY PLAN

SITE DETAILS

SITE DETAILS SITE DETAILS

SITE DETAILS

SITE DETAILS SITE DETAILS SITE DETAILS SITE DETAILS

HANDLING

REPORTING

- 5.1.6.D.5.b. 'INDUSTRIAL. LIGHT' PRINCIPAL USE SELF-SERVICE STORAGE SHALL BE CONTAINED WITHIN A FULLY ENCLOSED BUILDING AND CONTAINED IN A SINGLE BUILDING, ACCESS INTERNALLY, EXCEPT IN THE GENERAL INDUSTRIAL DISTRICT NOT LOCATED ON N MAIN ST OR S MAIN ST.
- 5.1.6.I.4. 'WAREHOUSING' PRINCIPAL USE EXAMPLES. INCLUDES WAREHOUSES AND

#### APPROVED ALTERNATE PARKING PLAN CONDITIONS:

- 1 PARKING SPACE PER 100 SELF-STORAGE UNITS.
- PARKING PERMITTED BETWEEN A PROPOSED BUILDING AND THE STREET FRONTAGE.

Sheet Number

C7.1

### **ATTENTION CONTRACTORS**

The *Construction Contractor* responsible for the extension of water, sewer, and/or reuse, as approved in these plans, is responsible for contacting the Public Utilities Department at (919) 996-4540 at least twenty four hours prior to beginning any of their construction.

Failure to notify both City Departments in advance of beginning construction, will result in the issuance of monetary fines, and require reinstallation of any water or sewer facilities not inspected as a result of this notification failure.

Failure to call for Inspection, Install a Downstream Plug, have Permitted Plans on the Jobsite, or any other Violation of City of Raleigh Standards will result in a Fine and Possible Exclusion from future work in the *City of Raleigh*.

**Sheet List Table** 

C7.0 ROAD WIDENING PLAN - DEMO, SITE AND SIGNAGE &

STRIPING PLANS

ROAD WIDENING PLAN - GRADING, DRAINAGE & **EROSION CONTROL PLAN** 

JONES DAIRY ROAD - CROSS SECTIONS STA. 10+00 -

JONES DAIRY ROAD - CROSS SECTIONS STA. 11+00 -

JONES DAIRY ROAD - CROSS SECTIONS STA. 12+00 -

JONES DAIRY ROAD - CROSS SECTIONS STA. 13+00 -

JONES DAIRY ROAD - CROSS SECTIONS STA. 14+00 -

JONES DAIRY ROAD - CROSS SECTIONS STA, 15+00 -

JONES DAIRY ROAD DRIVEWAY STEM PROFILE

C7.8 JONES DAIRY ROAD - CROSS SECTIONS STA. 16+00 -

### SITE DATA TABLE

SITE DAT	AIADLL
PROJECT NAME:	JONES DAIRY STORAGE FACILITY
SITE PLAN NUMBER	SDP-23-03
PROPERTY OWNER/ DEVELOPER:	ROLESVILLE (LOCKBOX) LLC 8816 SIX FORKS ROAD, SUITE 201 RALEIGH, NC 27615
REAL ESTATE ID:	0162697
PIN:	1850608722
DEED ACRES:	5.50 ACRES
PROPERTY ADDRESS:	1200 JONES DAIRY RD, ROLESVILLE NC 27587
	·
PROPERTY ZONING:	GI-CZ
CURRENT USE:	VACANT
PROPOSED USE:	SELF STORAGE (COMMERCIAL)
DISTURBED AREA:	5.77 ACRES
CURRENT IMPERVIOUS:	0 ACRES
PROPOSED IMPERVIOUS:	2.92 ACRES
TREE SAVE SUMMARY:	
REQUIRED TREE PRESERVATION:	10% SAVE = 0.10*4.76 (TREE AREA ON-SITE) = 0.476 ACRES
PROVIDED TREE PRESERVATION:	0.607 ACRES = 13%
PARKING SUMMARY:	
REQUIRED VEHICULAR SPACES:	1 SPACE PER 100 STORAGE UNITS = 540/100 = 6 SPACES
PROVIDED VEHICULAR SPACES:	7 SPACES
ADA PARKING SUMMARY:	
REQUIRED VEHICULAR SPACES:	1 SPACE
PROVIDED VEHICULAR SPACES:	1 SPACE
BUILDING HEIGHT:	MAXIMUM BUILDING HEIGHT: WITHOUT SPRINKLERS: 35-FT WITH SPRINKLERS: 60-FT PROVIDED BUILDING HEIGHTS: 16 FT
BUILDING SQUARE FOOTAGE(S):	CLIMATE CONTROLLED BUILDING: 62,610 SQFT STORAGE BUILDING(S): 1800 SQFT (2), 3600 SQFT (2), 6600 SQFT
NUMBER OF STORAGE UNITS:	### TOTAL NUMBER OF UNITS: 540  ### BUILDING 'A'   5X5: 61 UNITS   5X10: 82 UNITS   10X7.5: 28 UNITS   10X10: 137 UNITS   10X15: 53 UNITS   10X20: 53 UNITS   10X20: 53 UNITS   10X25: 16 UNITS   10X20: 16 UNITS   10X20: 18 UNITS  ### BUILDING 'B'   10X20: 18 UNITS  ### BUILDING 'D'   10X30: 22 UNITS  ### BUILDING 'E'   10X10: 18 UNITS  ### BUILDING 'F'   10X10: 18 UNITS  ### BUILDING 'F'   10X10: 18 UNITS
BUILDING/STRUCTURE SETBACKS:	
FRONT:	30-FT
SIDE:	15-FT
REAR:	
LANDSCAPE BUFFERS:	<del></del>
	50' TVDE "A" BLIEFED (SOLITH & WEST OF BAROEL)
ADJACENT PROPERTY:	
ADJACENT PROPERTY:	SEE CONDITION 4 (EAST OF PARCEL)
WATERSHED:	NEUSE RIVER
RIVER BASIN:	SANFORD CREEK (NEUSE)
SURFACE WATER CLASSIFICATION:	NONE

#### KEEP THESE TWO IN THE SET.


C0.0

C2.0

C6.1

C6.3

C6.4

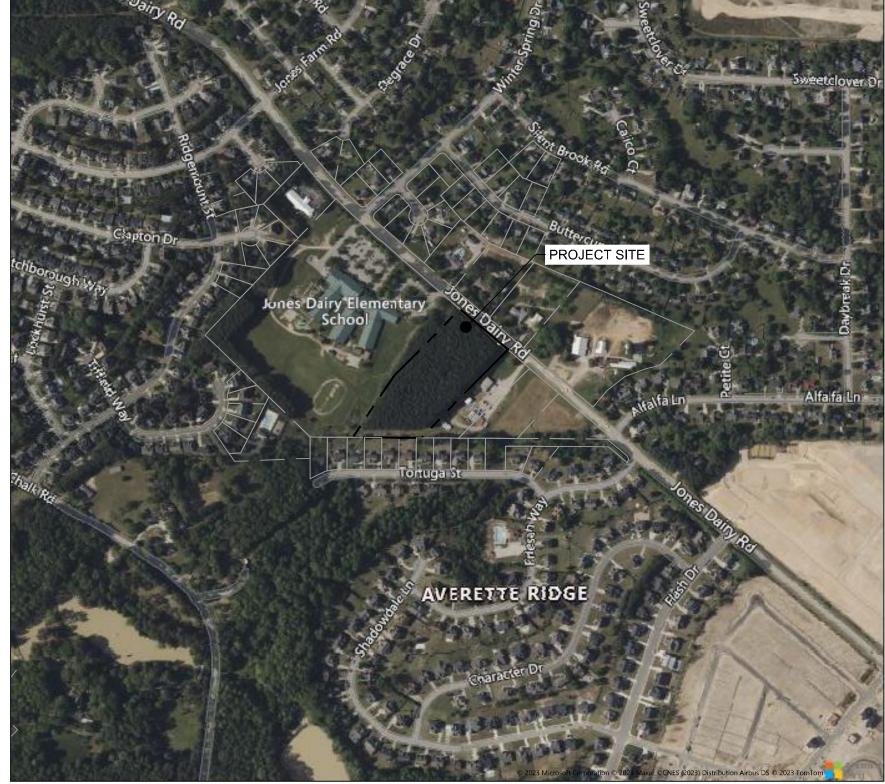

#### **VICINITY MAP** SCALE 1"=500'

# PROJECT TEAM

## LAND OWNER

CONTACT: ROLESVILLE (LOCKBOX) LLC 8816 SIX FORKS ROAD, SUITE 201 RALEIGH NC, 27615

## DEVELOPER

RIVERCREST REALTY INVESTORS **CONTACT: BRIAN HOLDER** PHONE: (919) 846-4046 8816 SIX FORKS ROAD, SUITE 201 RALEIGH, NC 27615

## **CIVIL ENGINEER**

TIMMONS GROUP CONTACT: GARRETT FRANK, PE, PLA PHONE: (919) 866-4503 5410 TRINITY ROAD, SUITE 102 RALEIGH, NC 27607

Sewer Collection / Extension System The City of Raleigh consents to the connection and extension of the City's public sewer system as shown on this plan. The material and Construction methods used for this project shall conform to the standards and specifications of the City's Public Utilities Handbook

Public Utilities Department Permit # S-5375 Authorization to Construct

# CITY OF RALEIGH - PLANS AUTHORIZED FOR CONSTRUCTION

APPROVED

ELECTRONIC APPROVAL: THIS APPROVAL IS BEING ISSUED ELECTRONICALLY. TH APPROVAL IS VALID ONLY UPON THE SIGNATURE OF A CITY OF RALEIGH REVIEW OFFICER BELOW. THE CITY WILL RETAIN A COPY OF THE APPROVED PLANS. ANY WORK AUTHORIZED BY THIS APPROVAL MUST PROCEED IN ACCORDANCE WITH THE PLANS KEPT ON FILE WITH THE CITY. THIS ELECTRONIC APPROVAL MAY NOT BE EDITED ONCE ISSUED. ANY MODIFICATION TO THIS APPROVAL ONCE ISSUED WILL INVALIDATE THIS APPROVAL.

CITY OF RALEIGH DEVELOPMENT APPROVAL

RALEIGH WATER REVIEW OFFICER

EROSION CONTROL, STORMWATE

AND FLOODPLAIN MANAGEMENT

ENVIRONMENTAL CONSULTANT SIGNATURE

EROSION CONTROL ☐ S-STORMWATER MGMT. ☐ S-

FLOOD STUDY 

S-



04/05/2023


L. BARNES

**DESIGNED BY** CHECKED BY G. FRANK

AS SHOWN

*54832* 

SHEET NO. C0.0

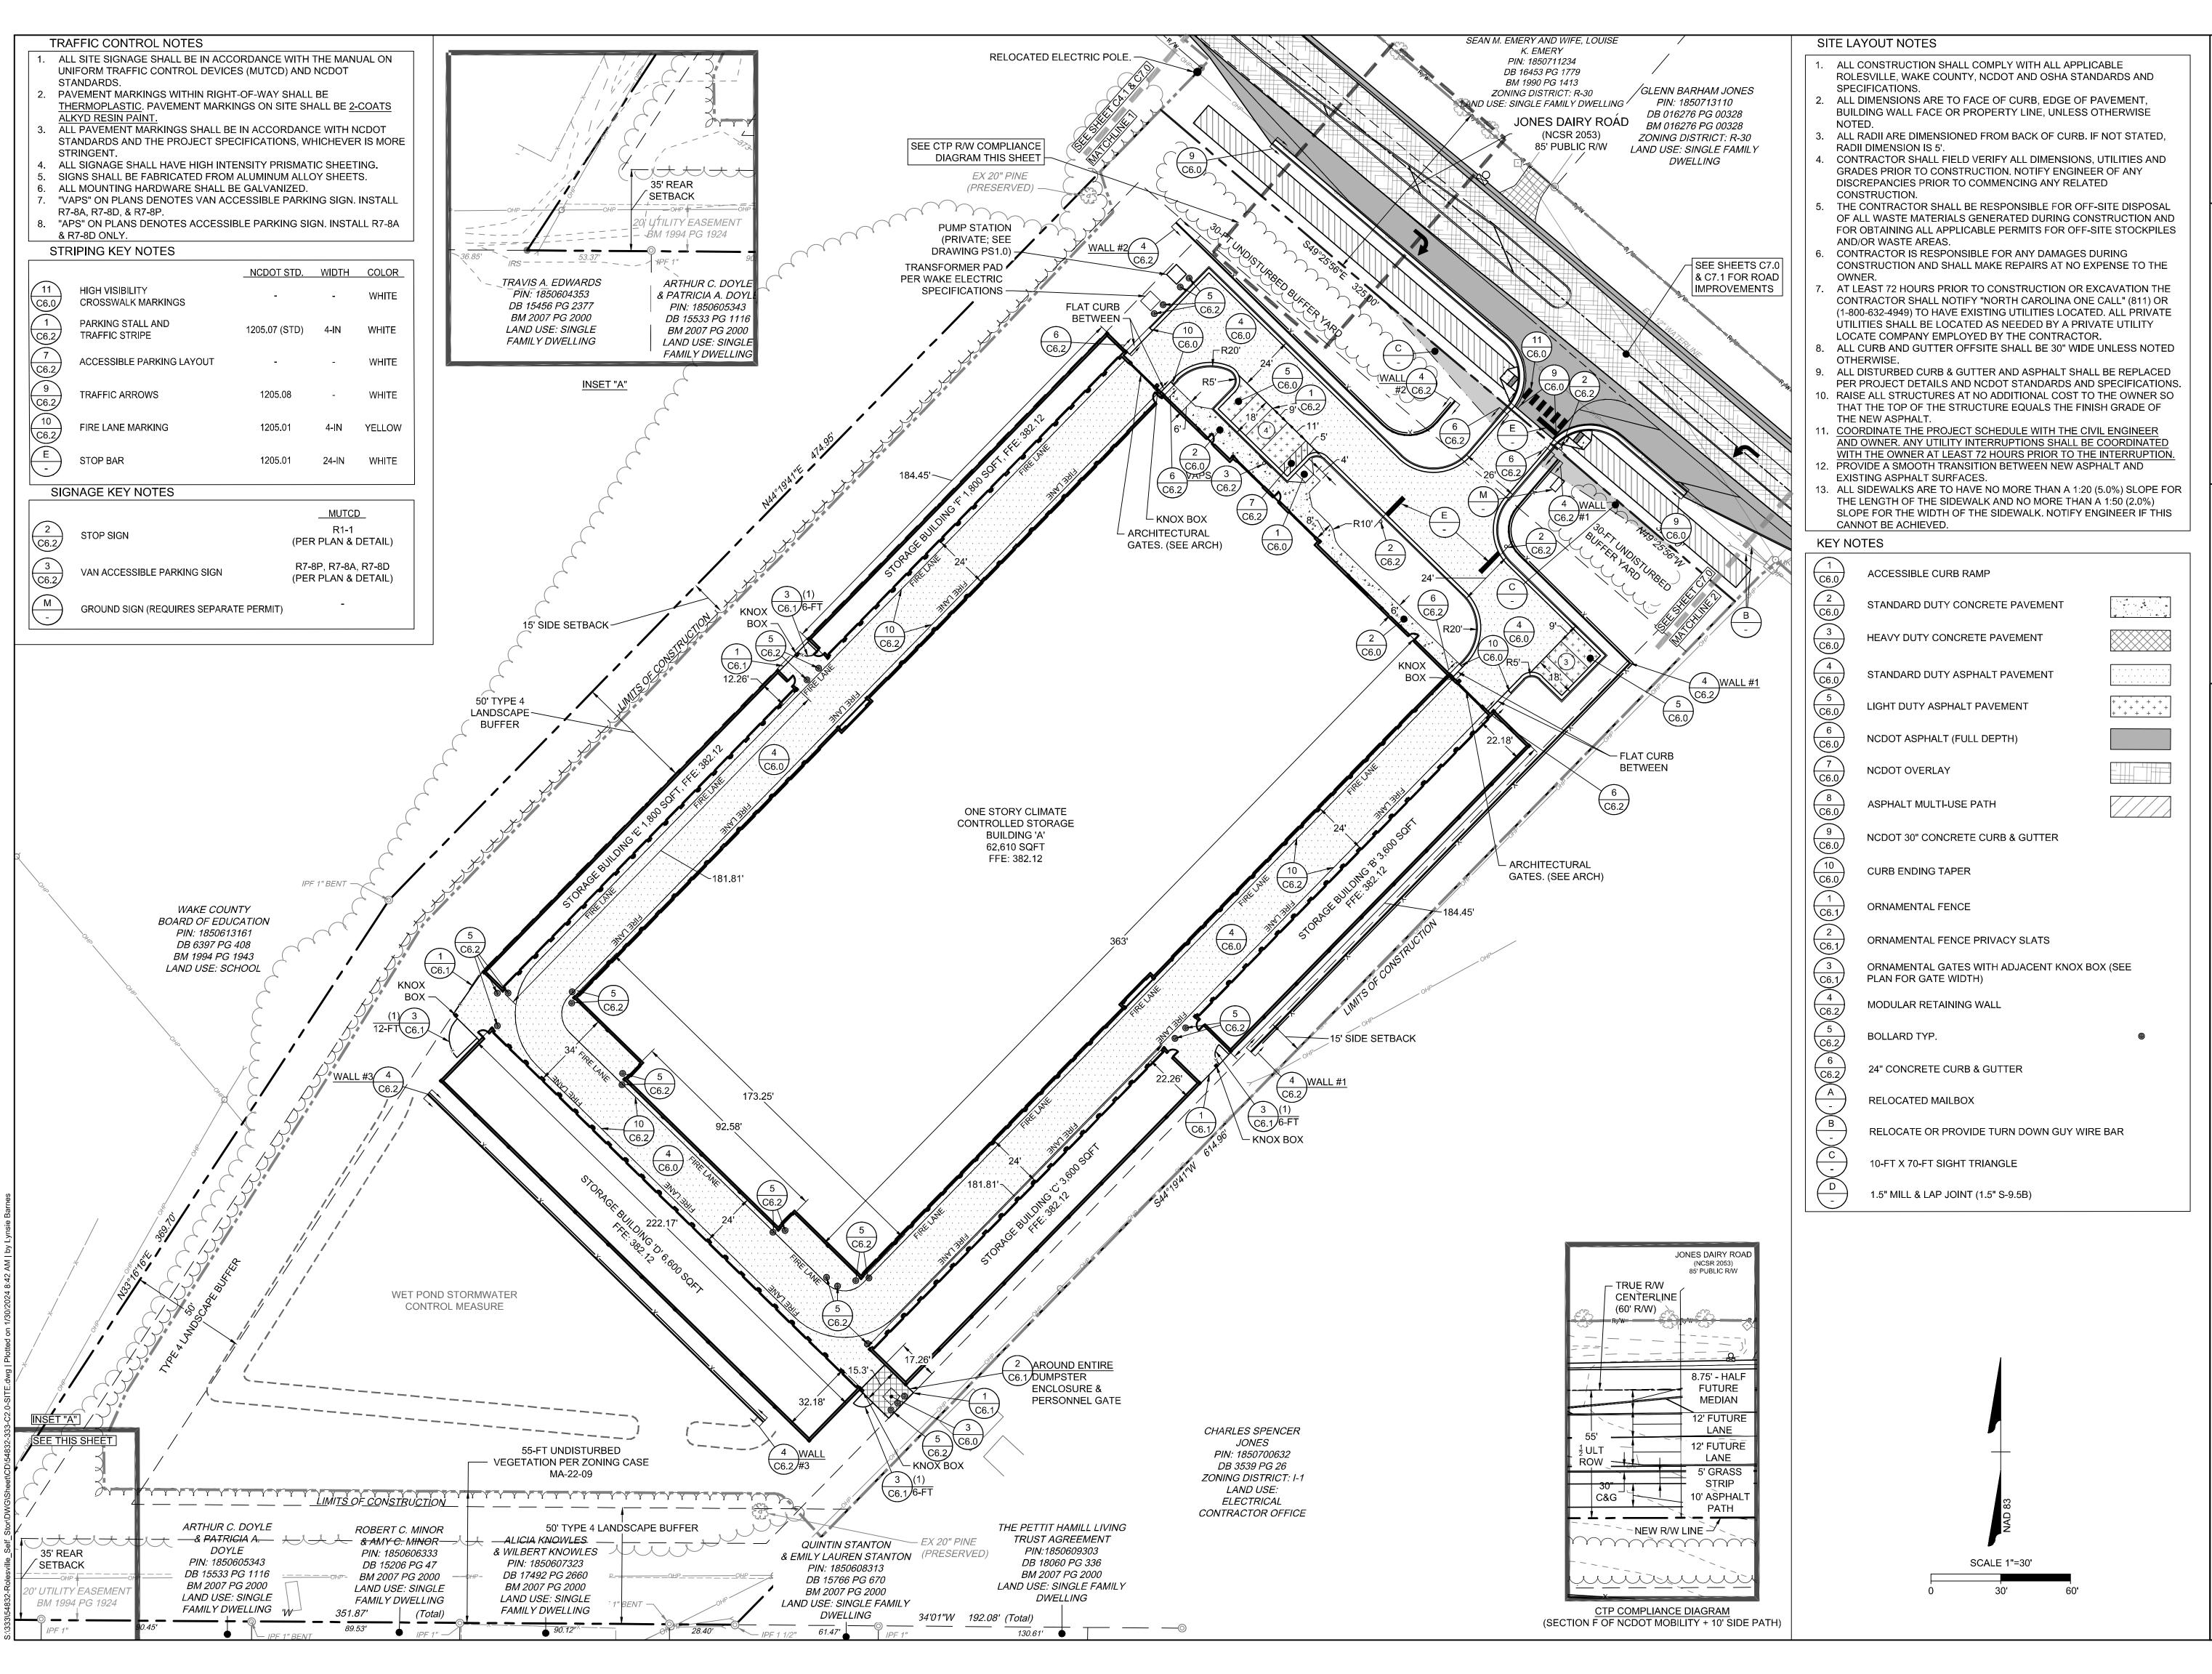




DATE 04/05/2023

DRAWN BY L. BARNES **DESIGNED BY** G. FRANK

CHECKED BY G. FRANK SCALE

AS SHOWN

JOB NO. 54832 SHEET NO. C2.0

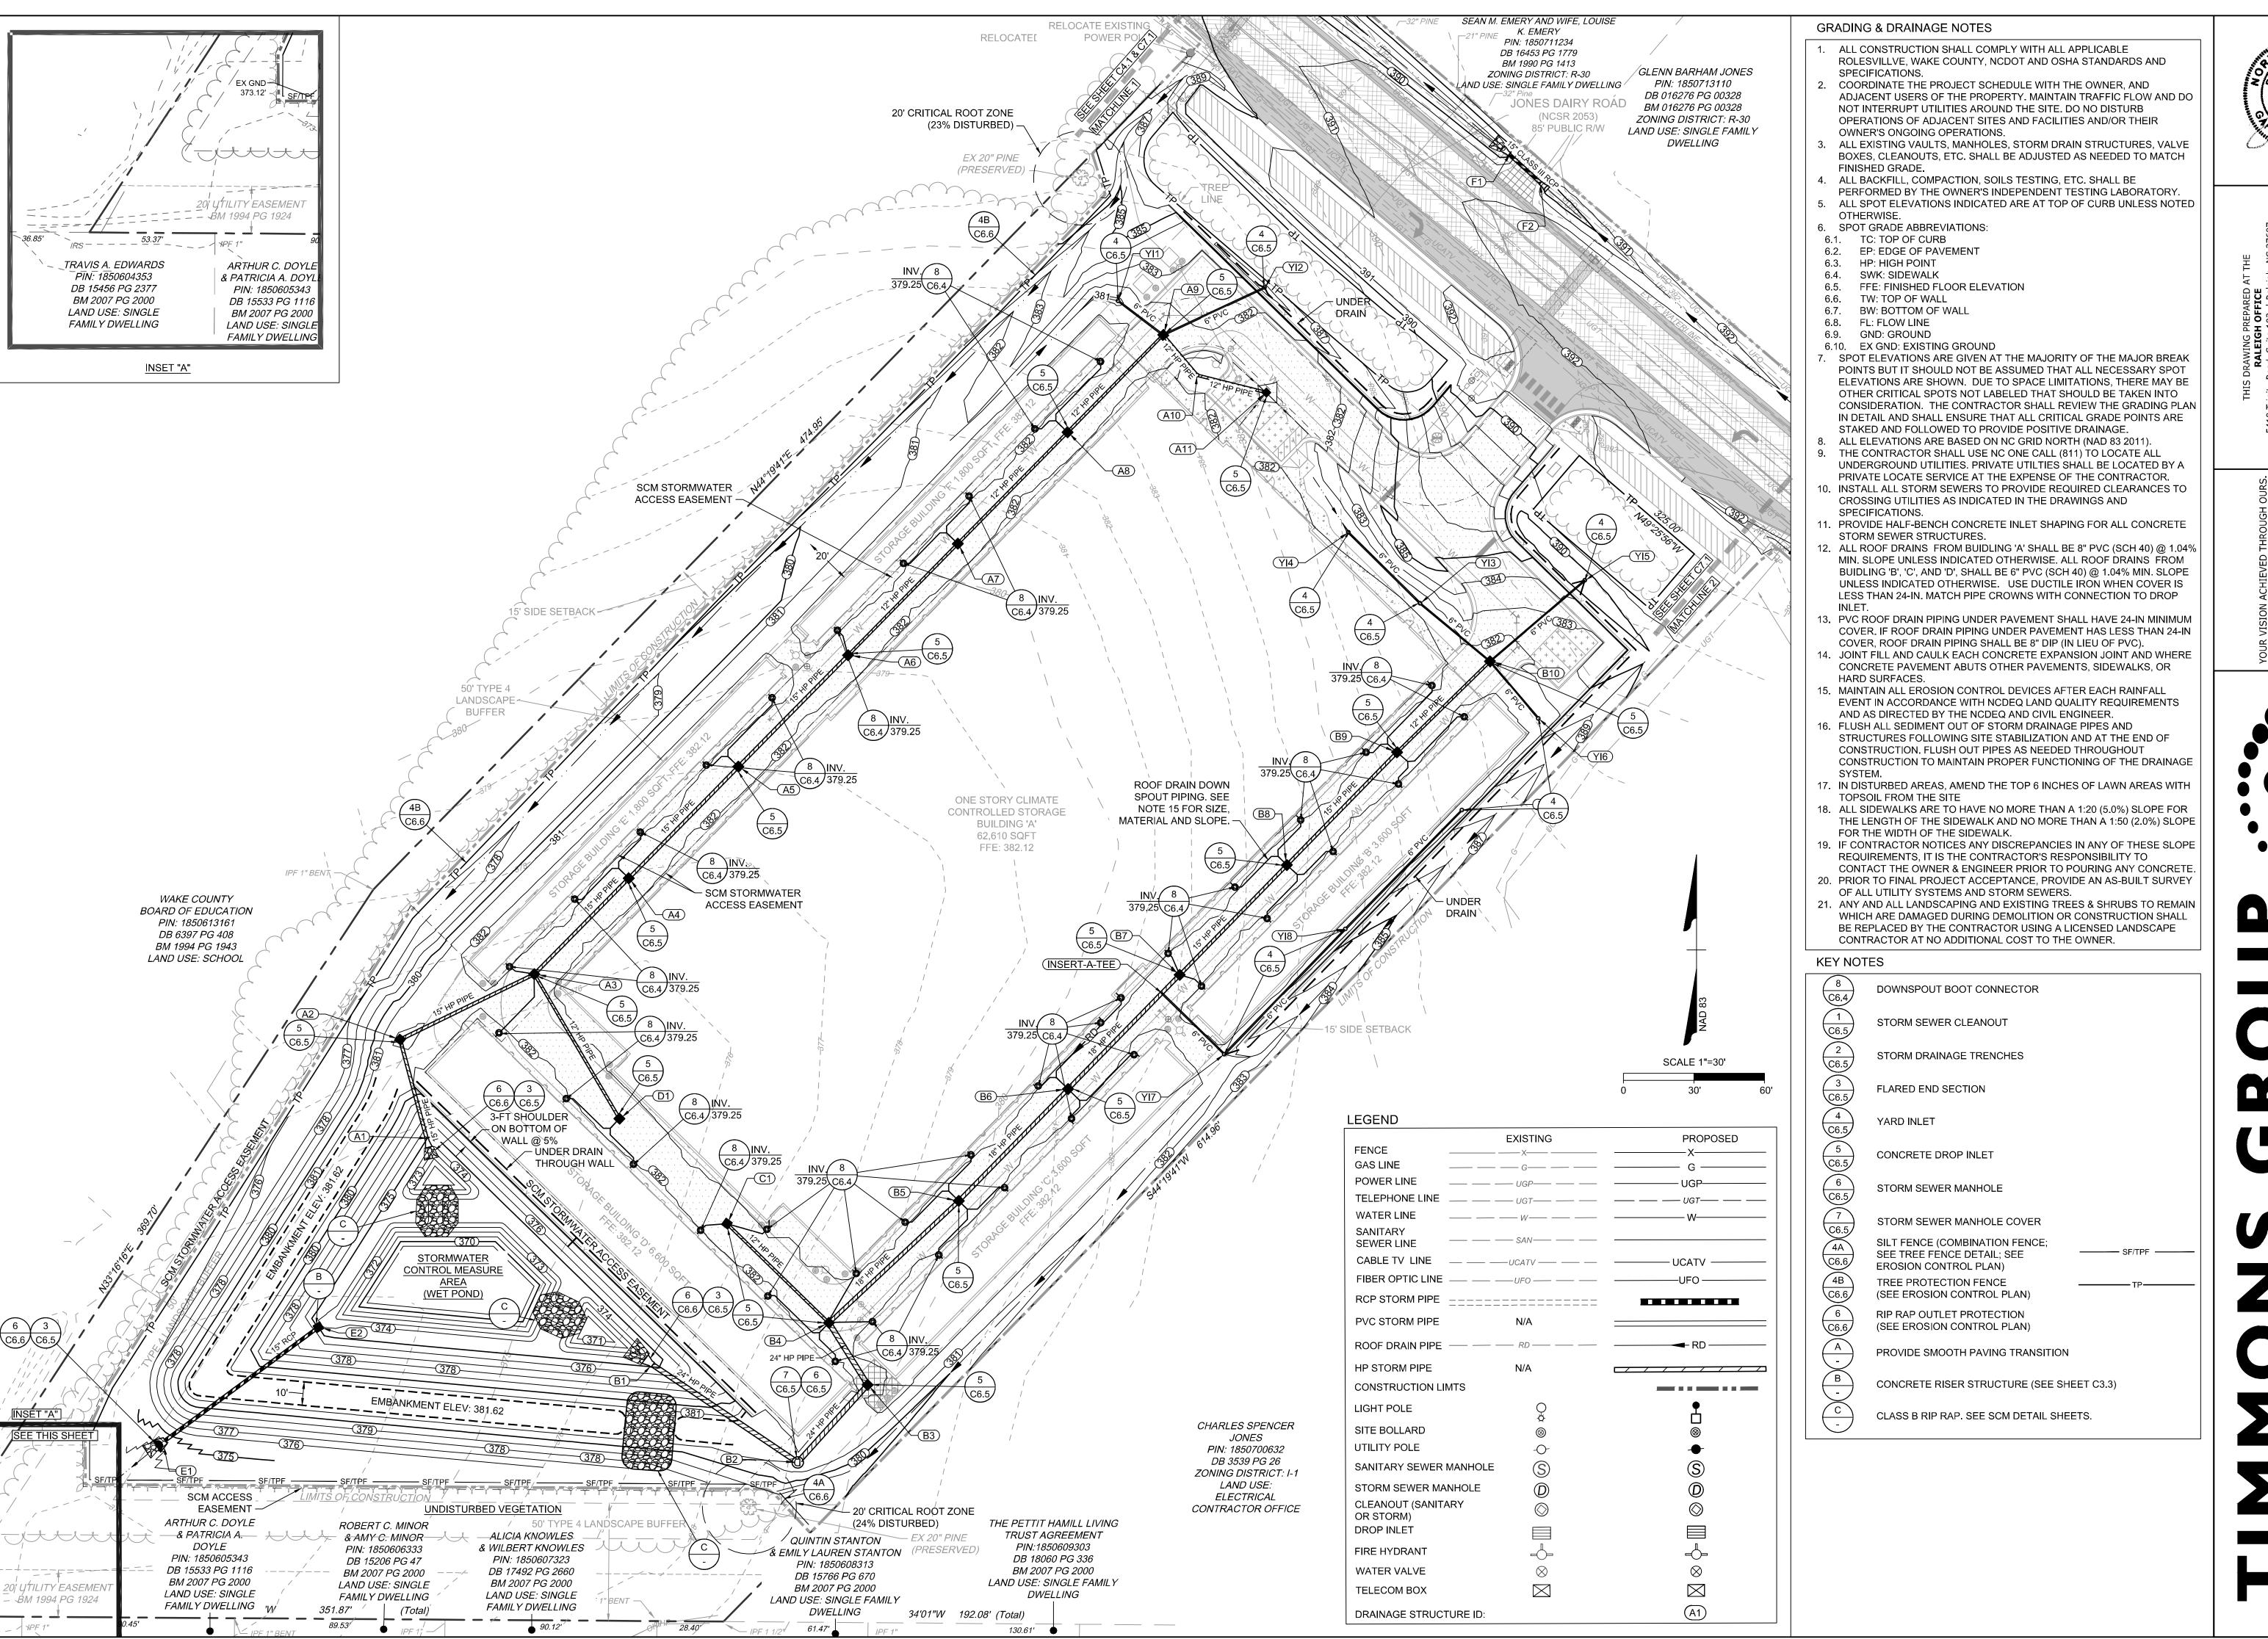





DATE 04/05/2023


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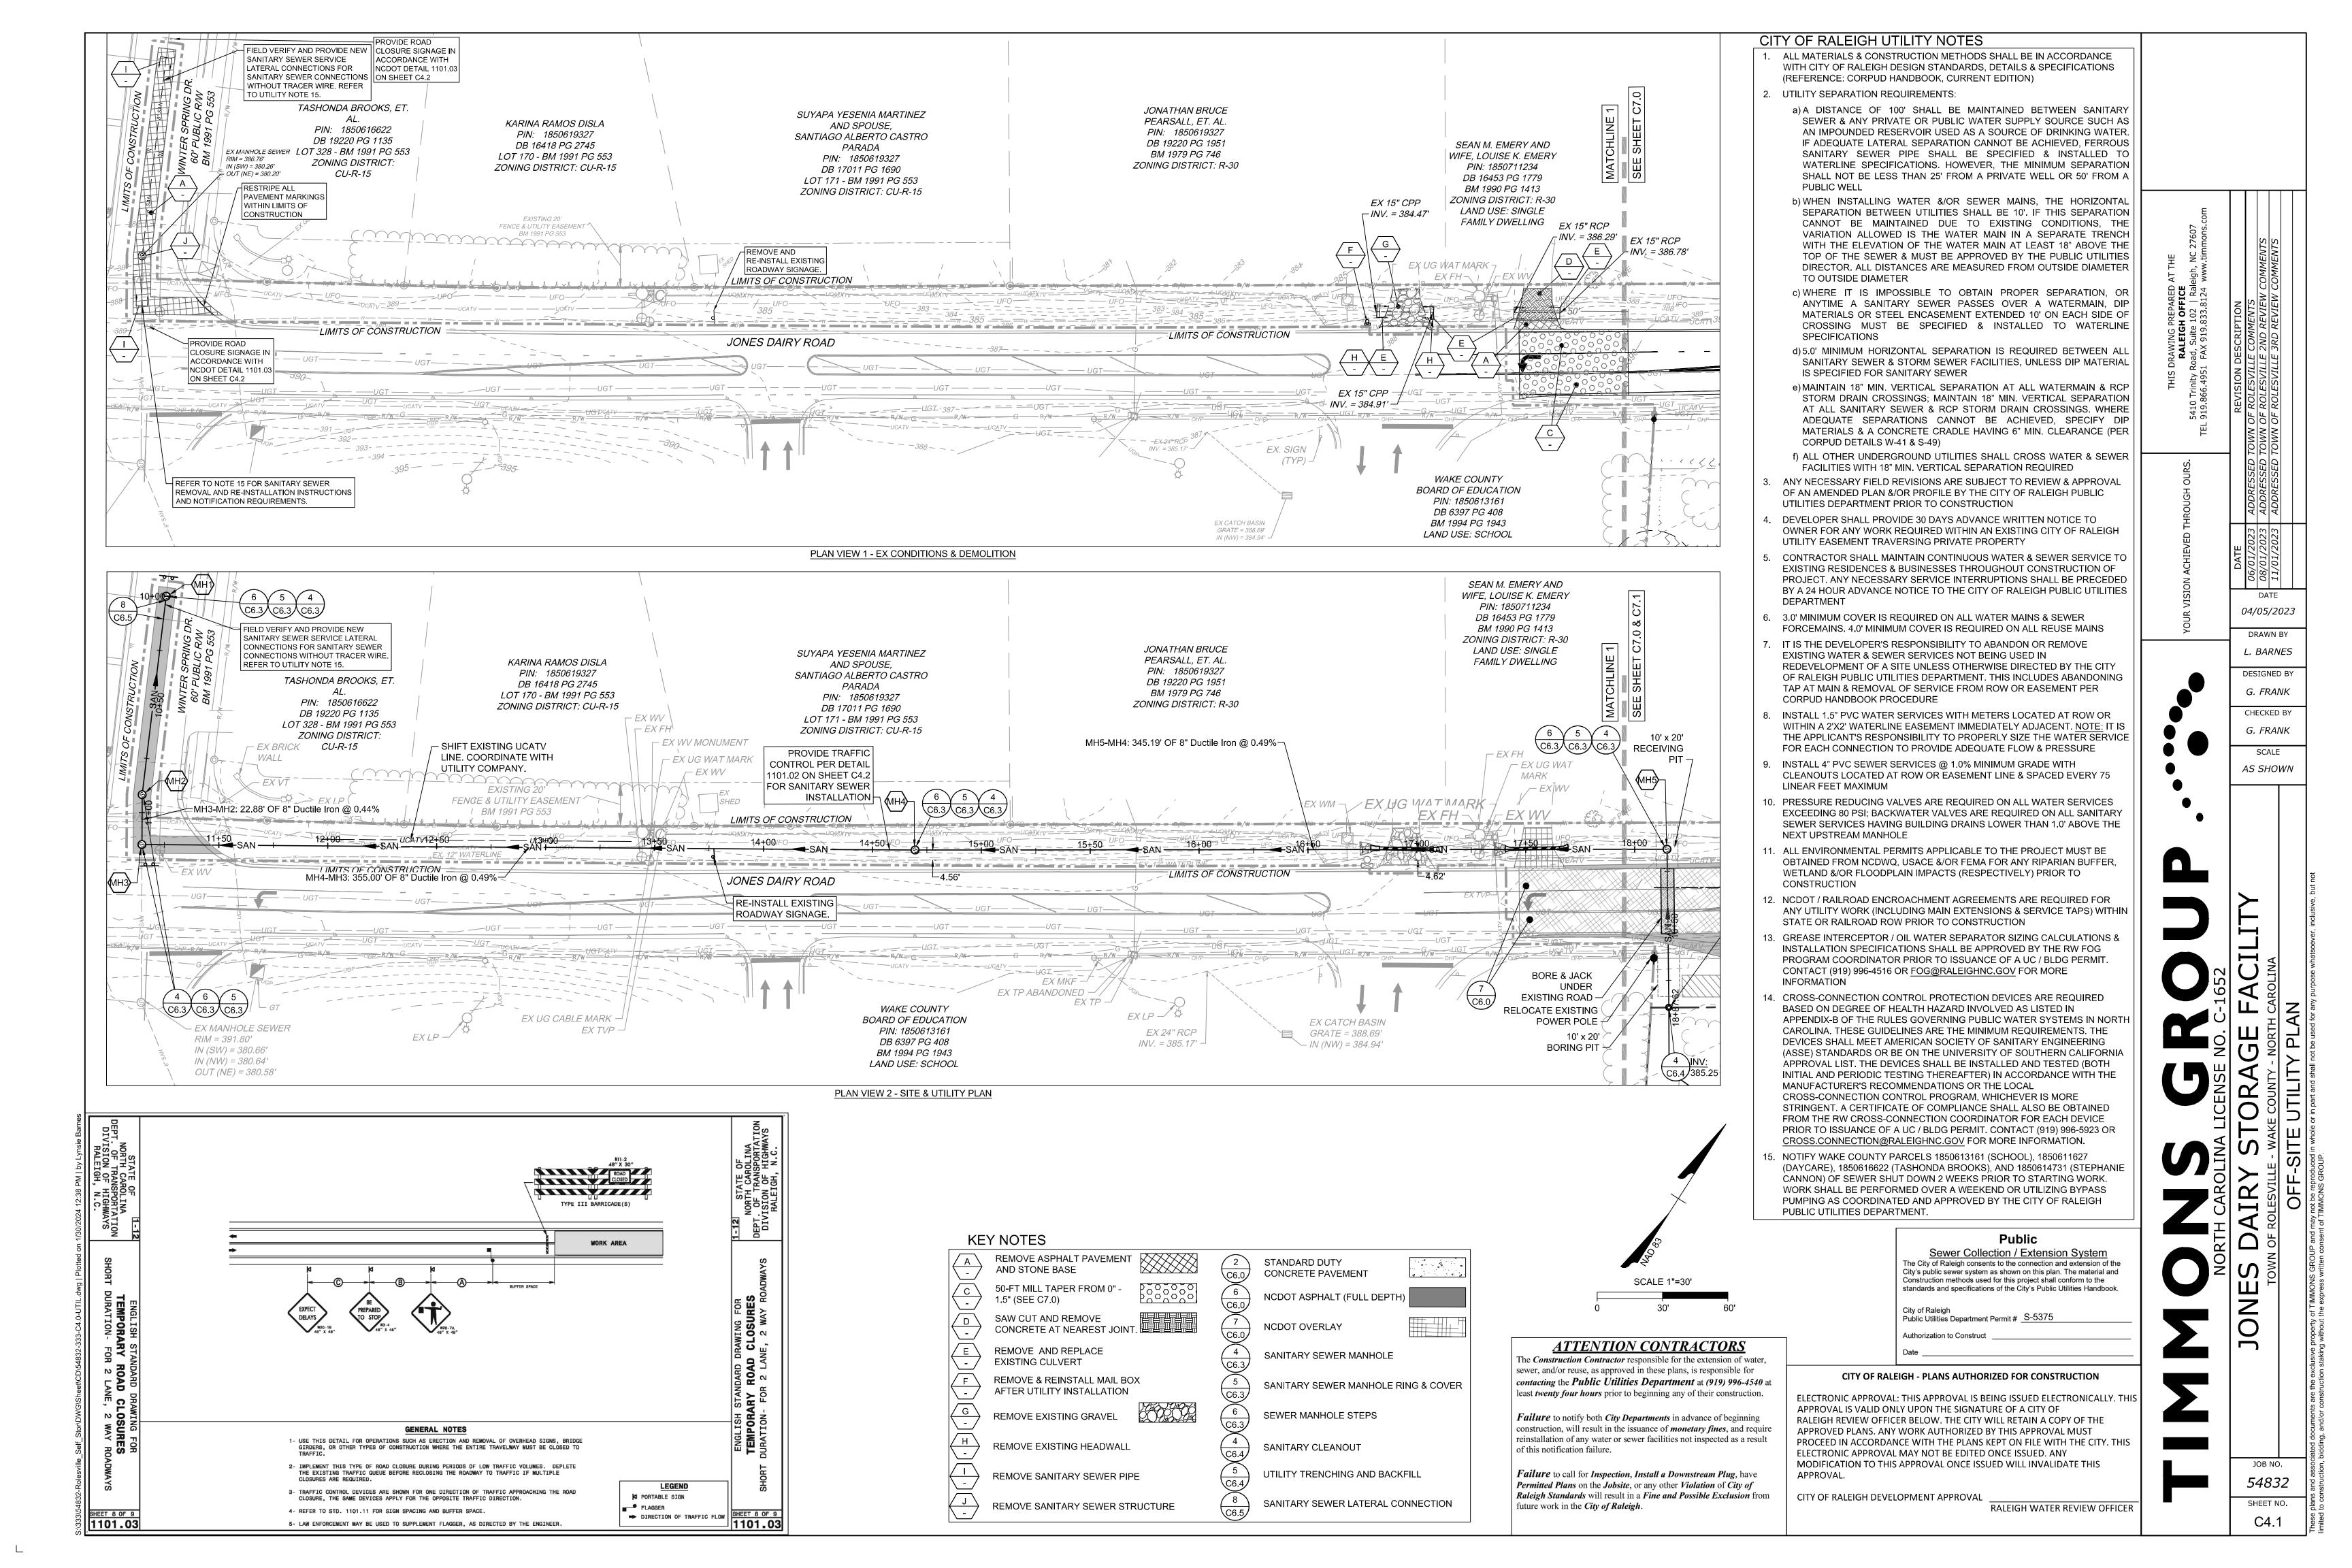
**DESIGNED BY** G. FRANK CHECKED BY G. FRANK


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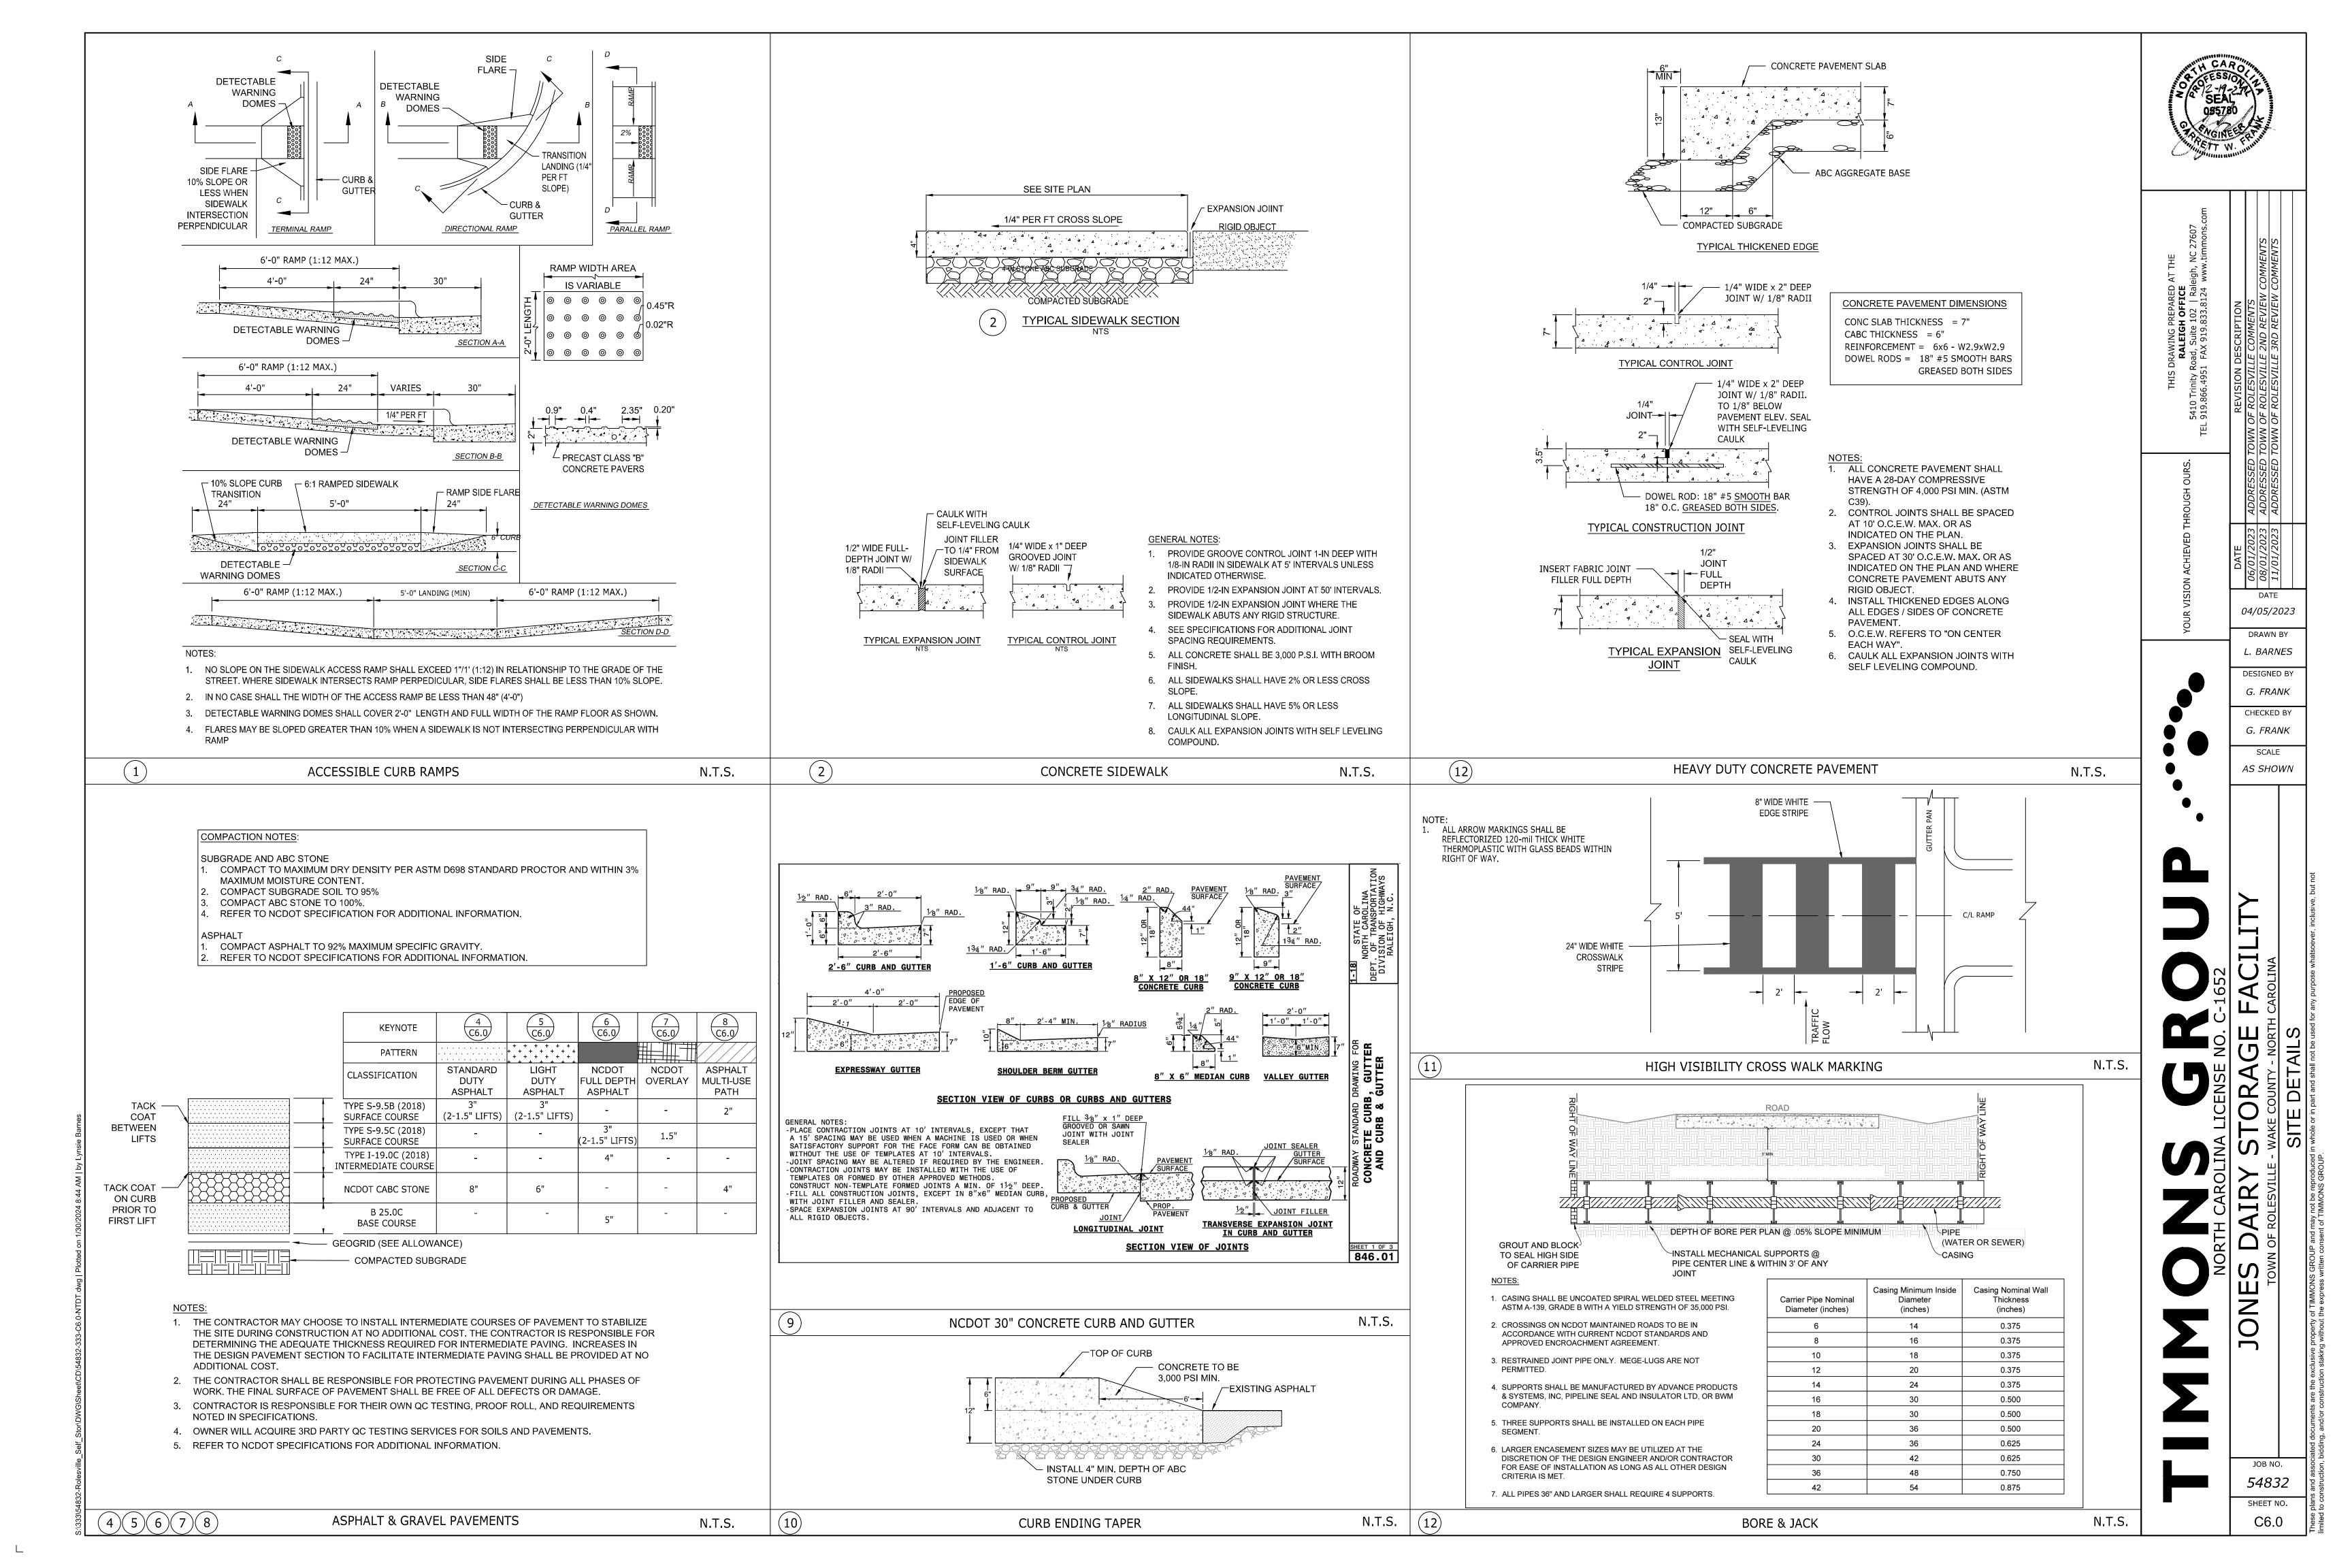
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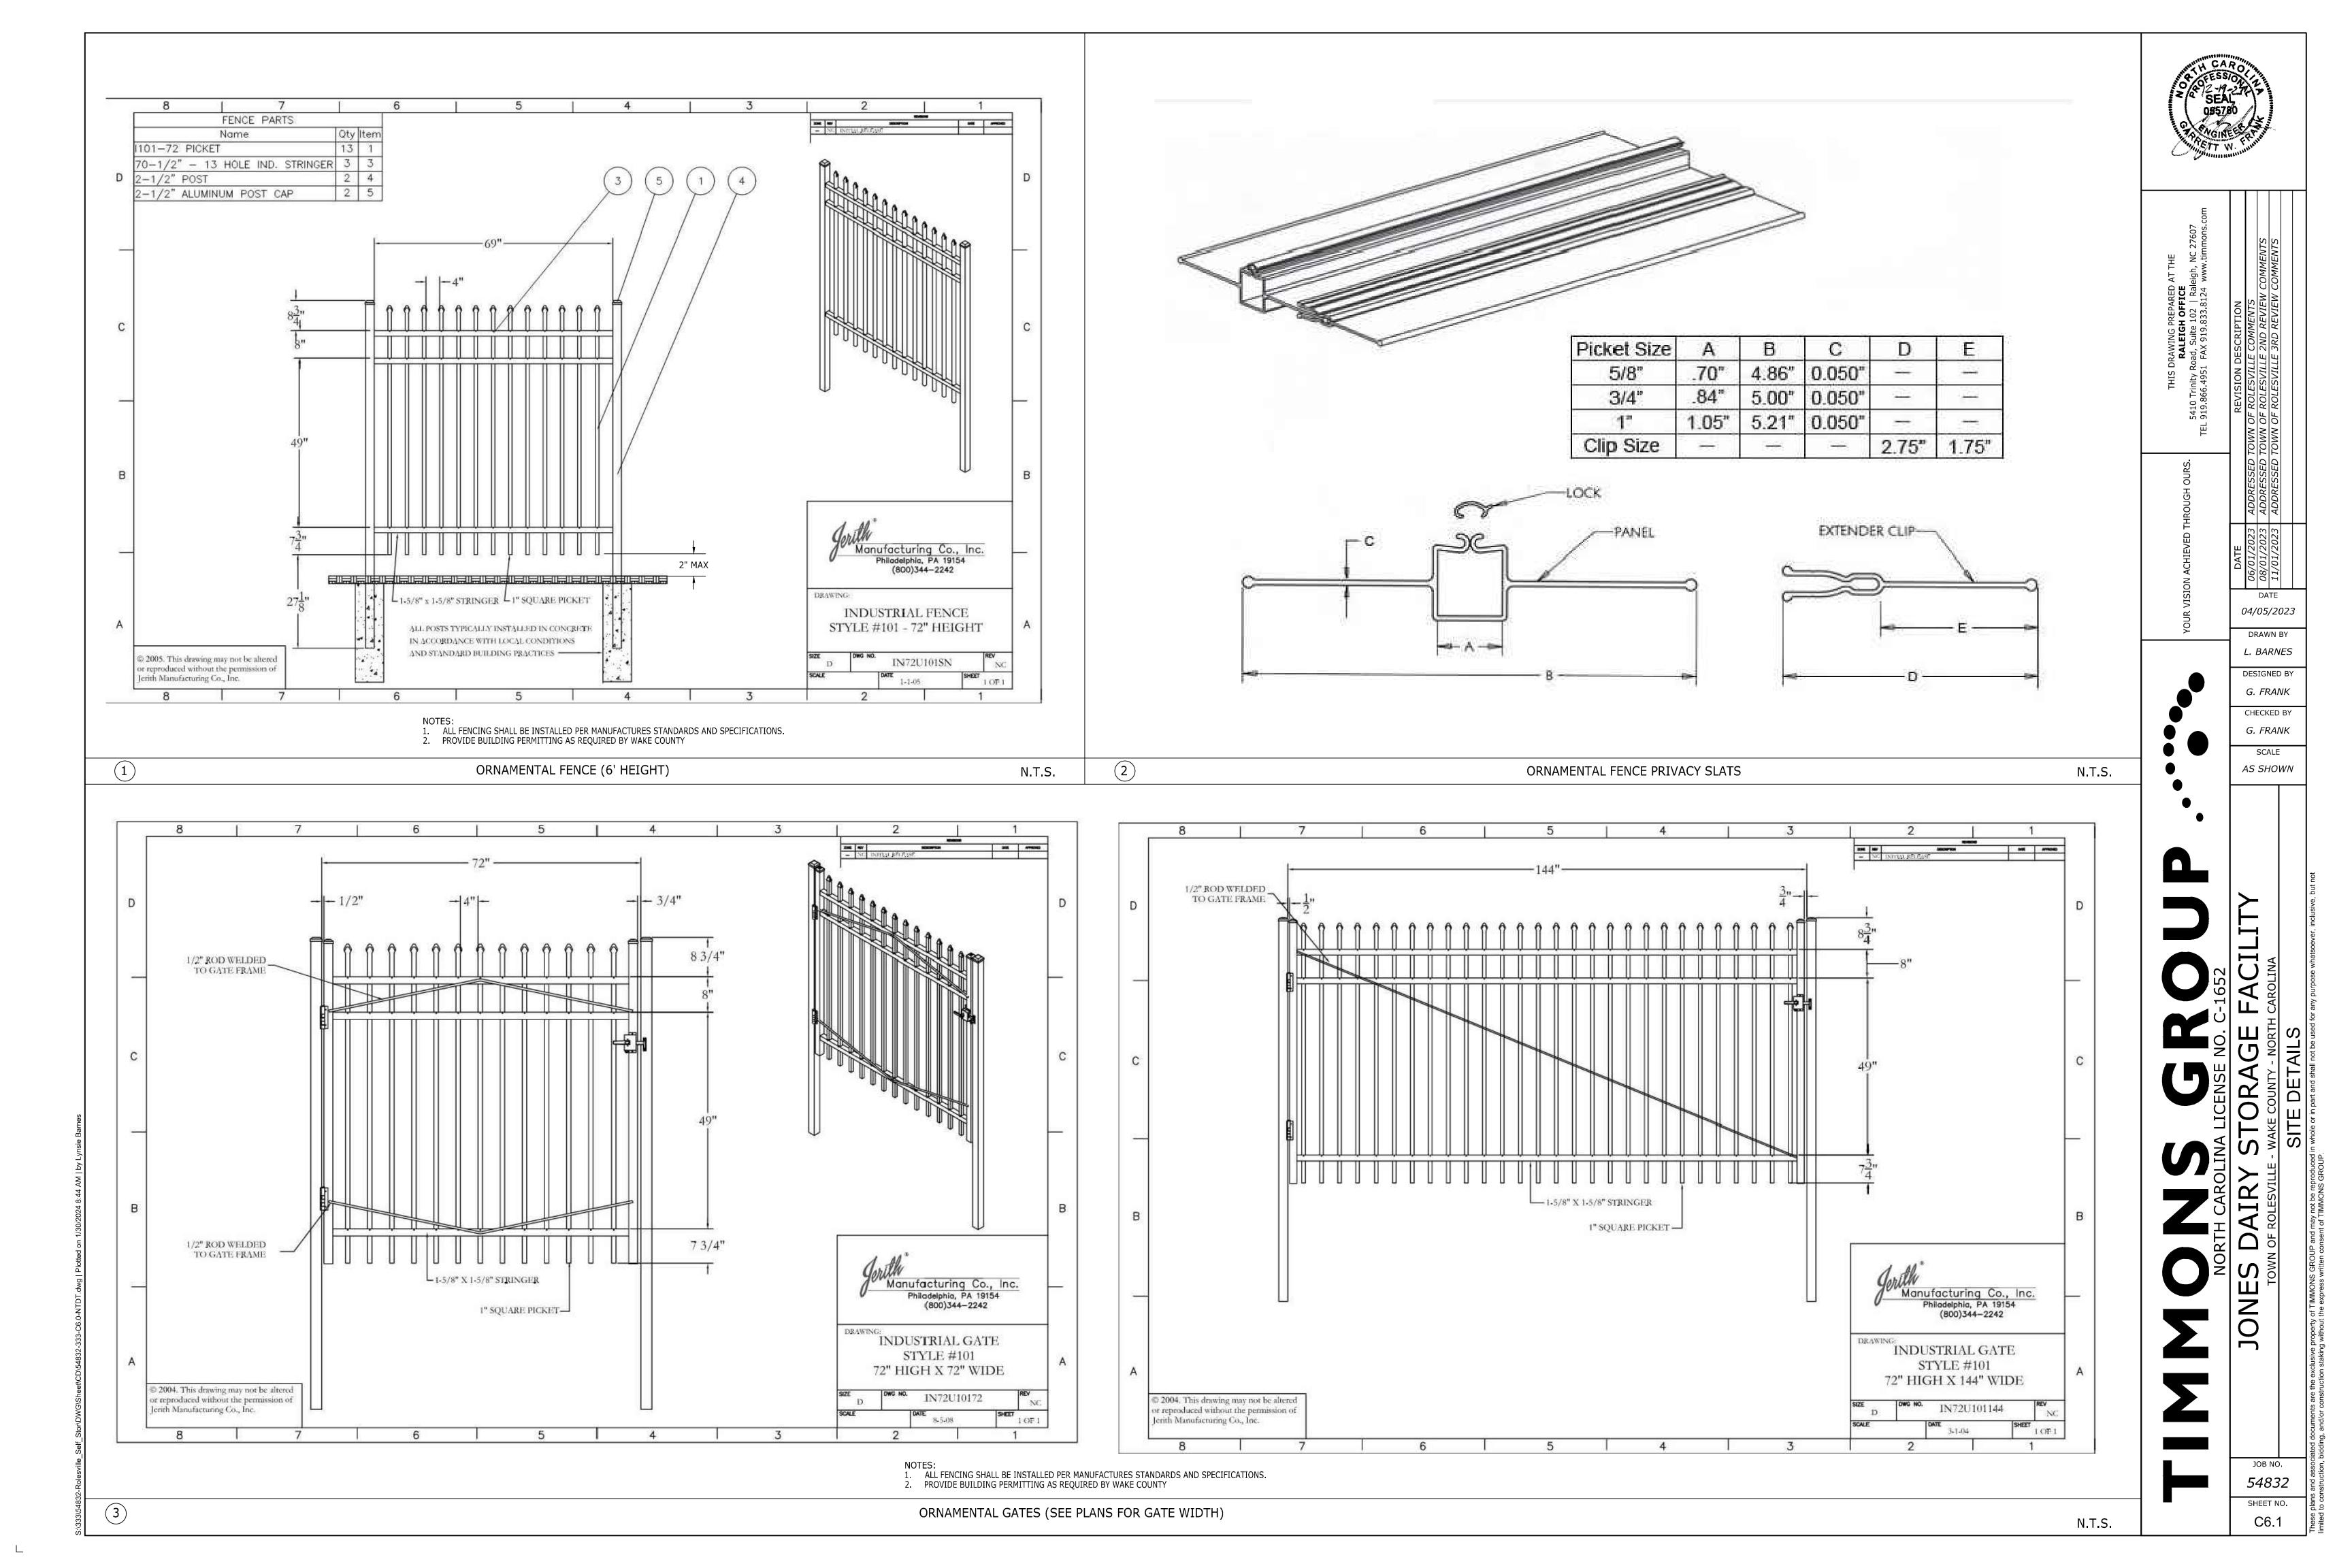
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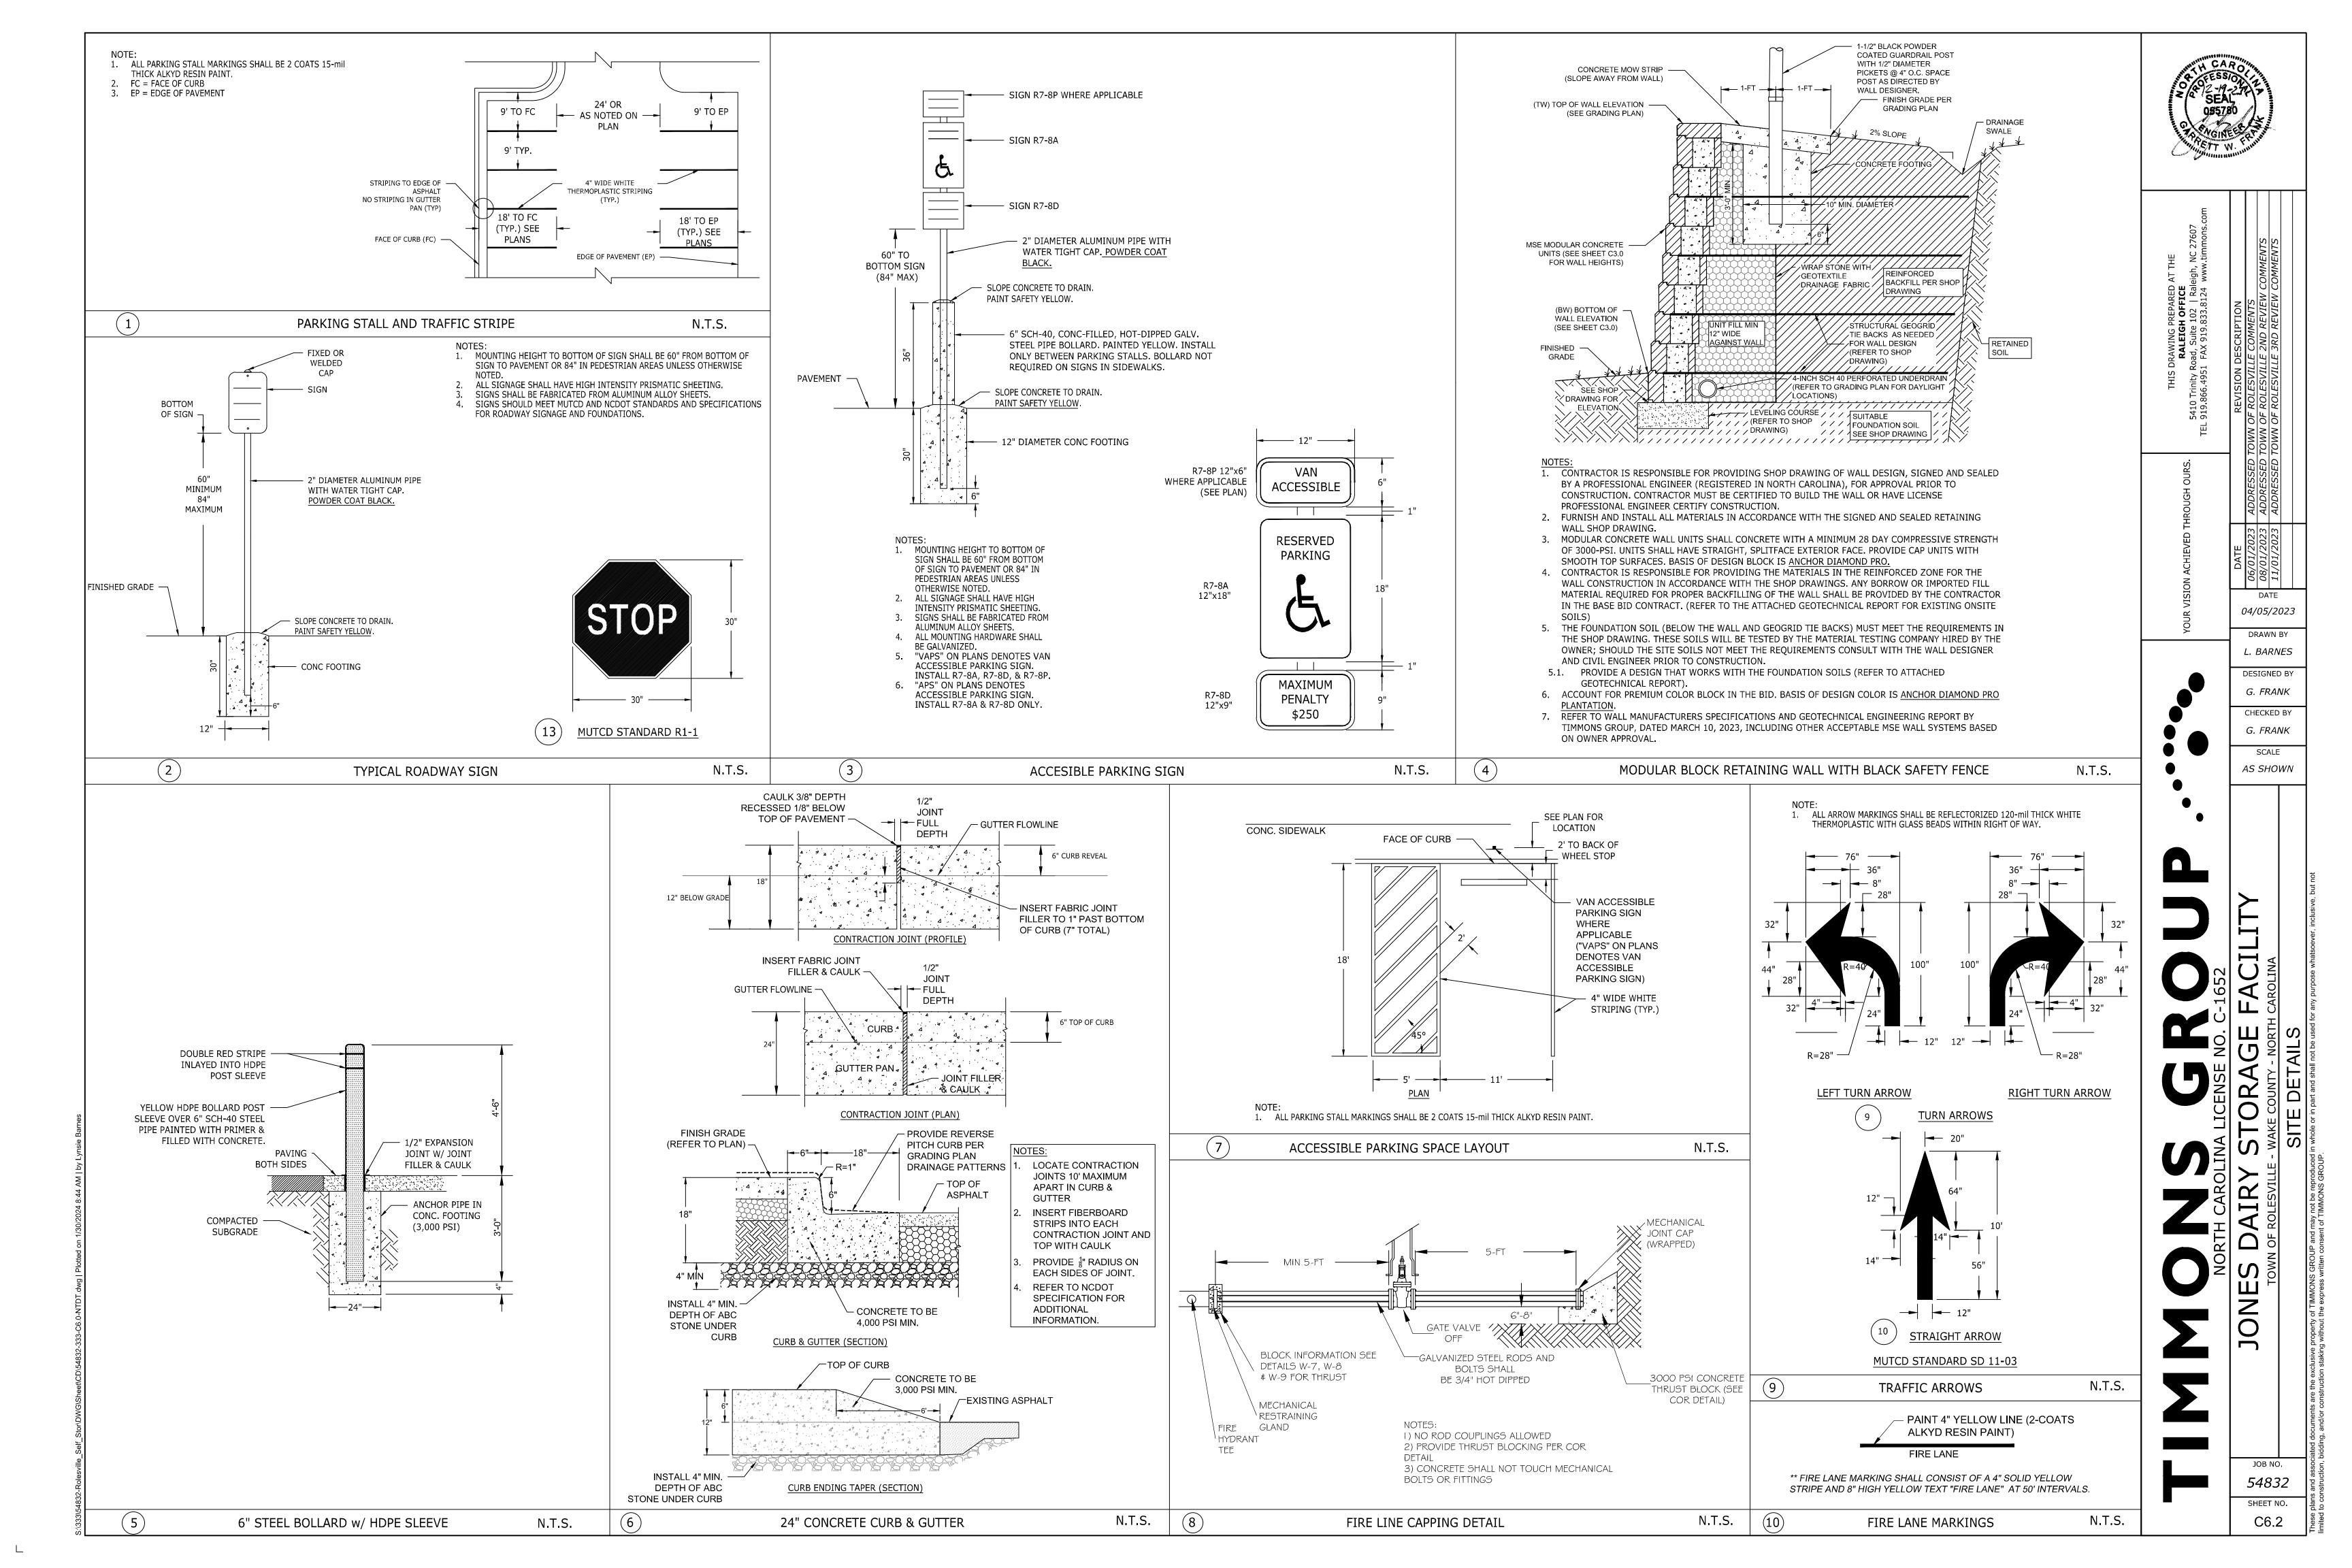











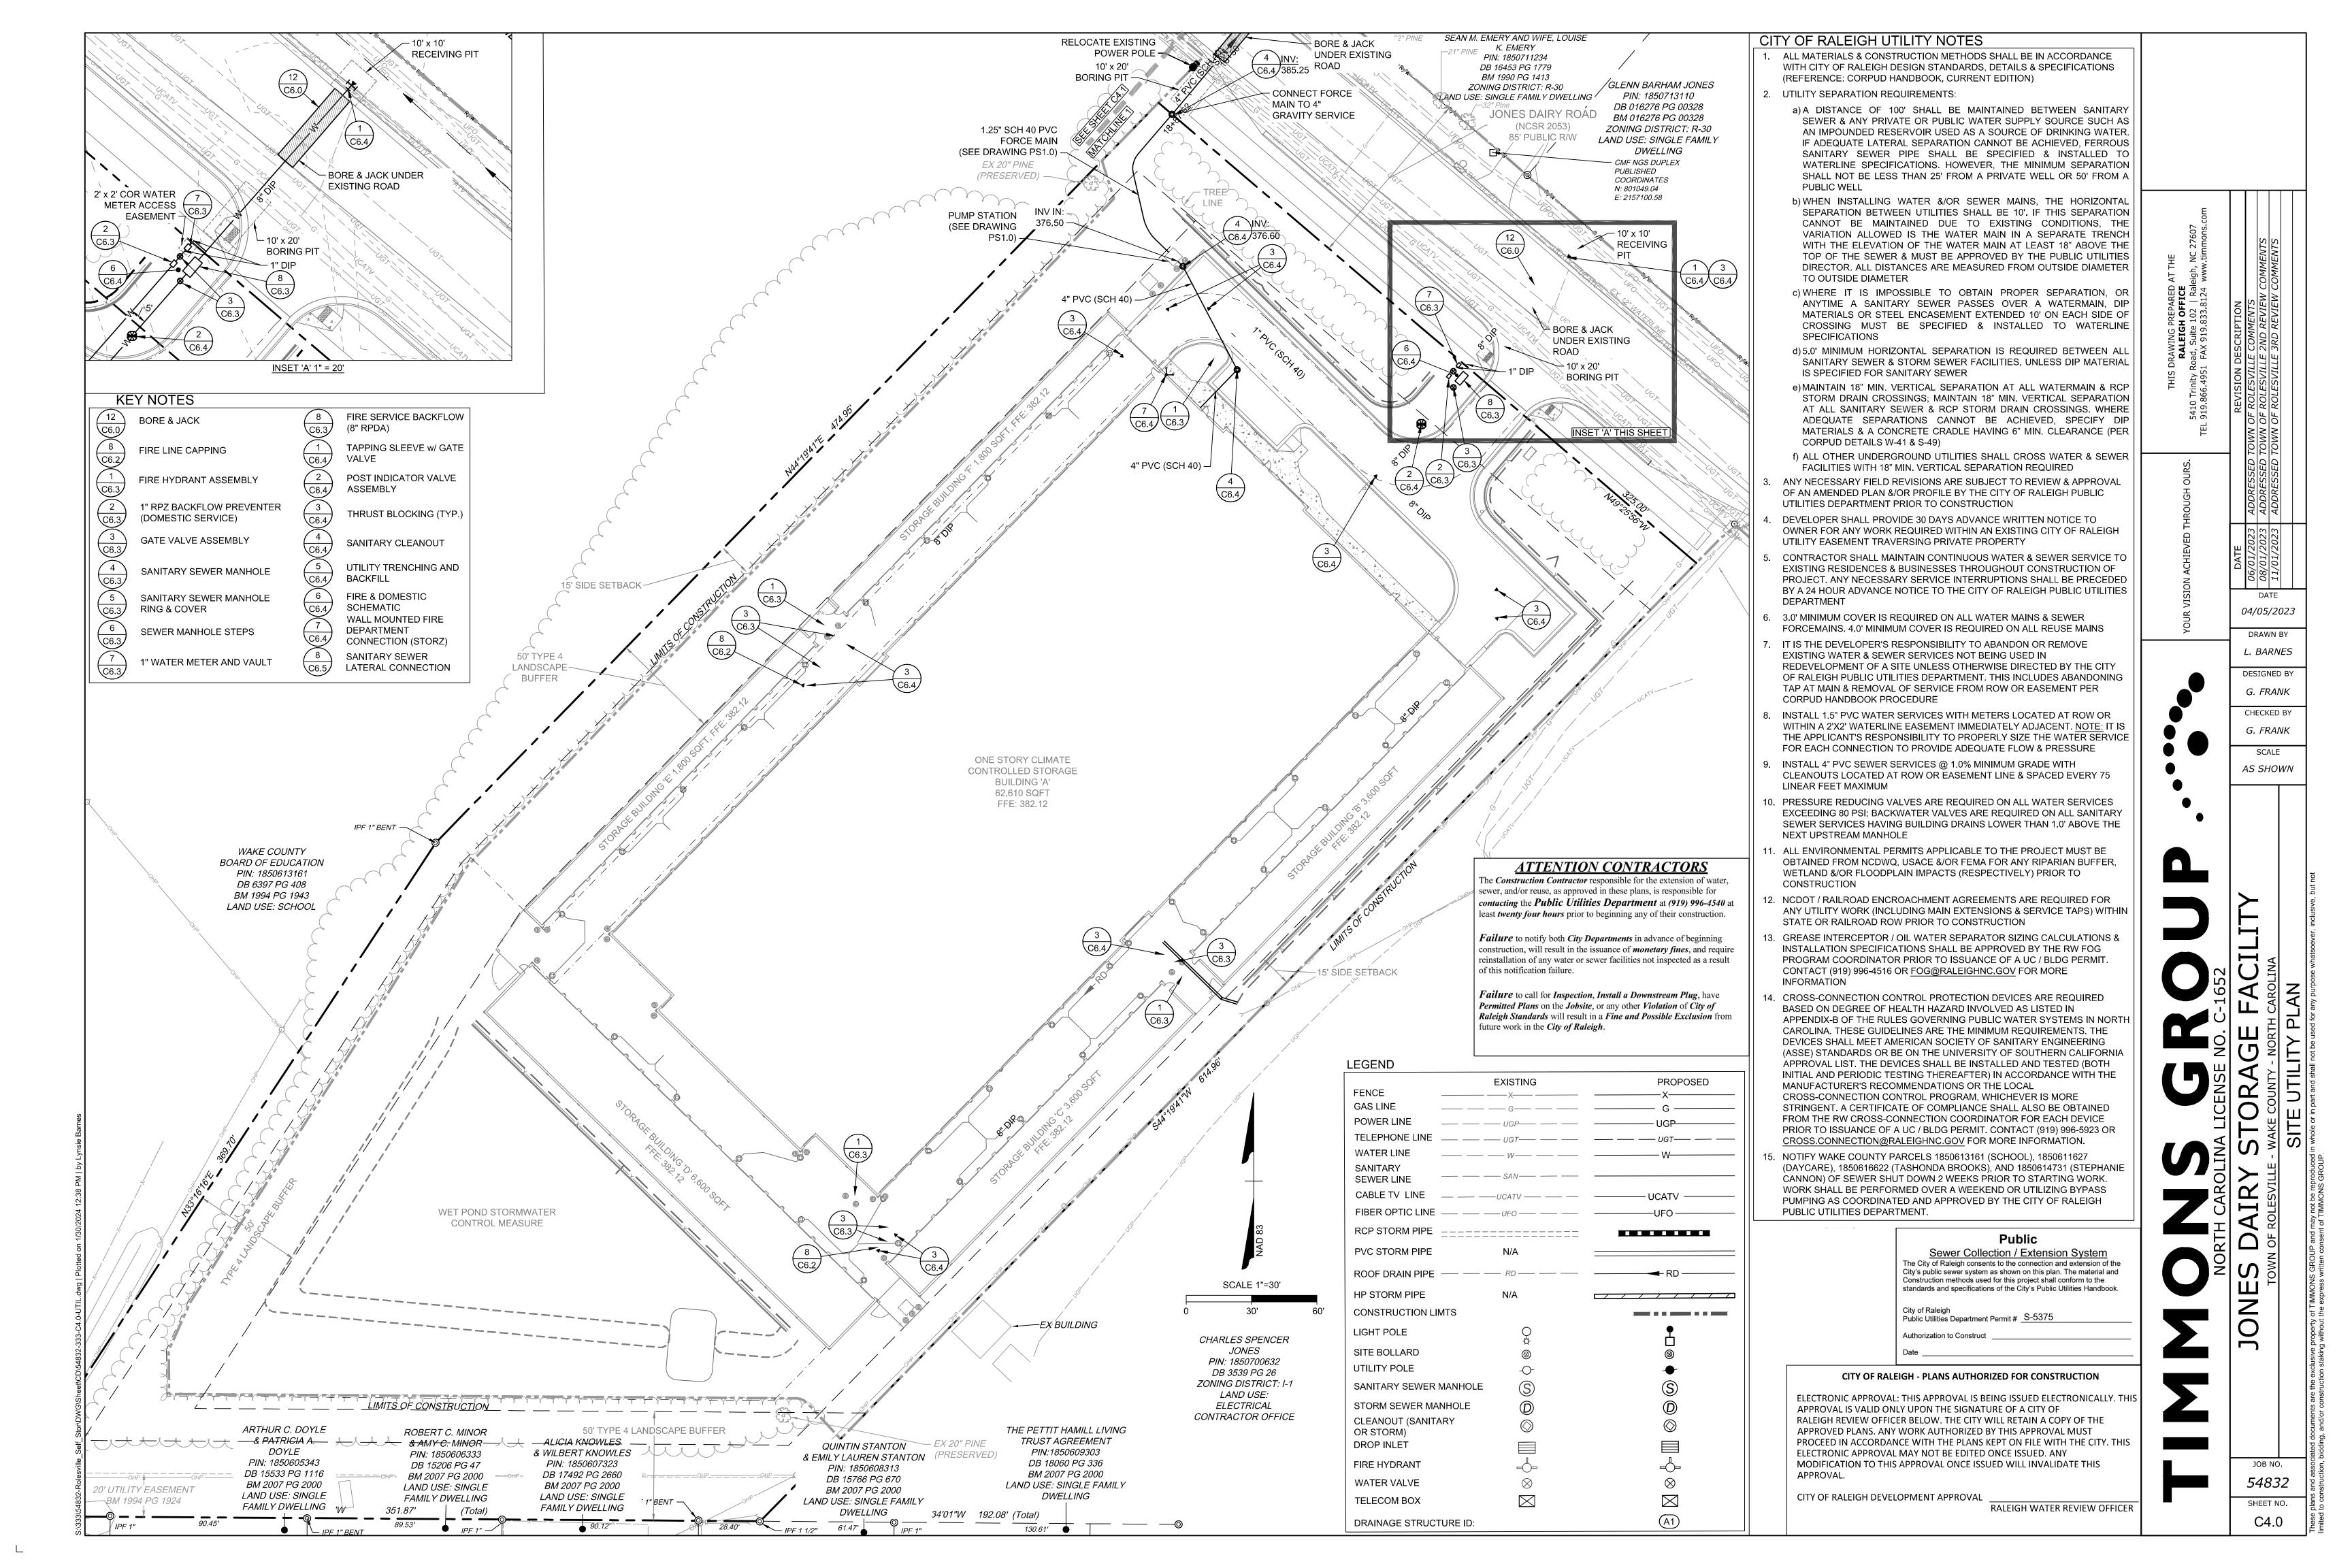


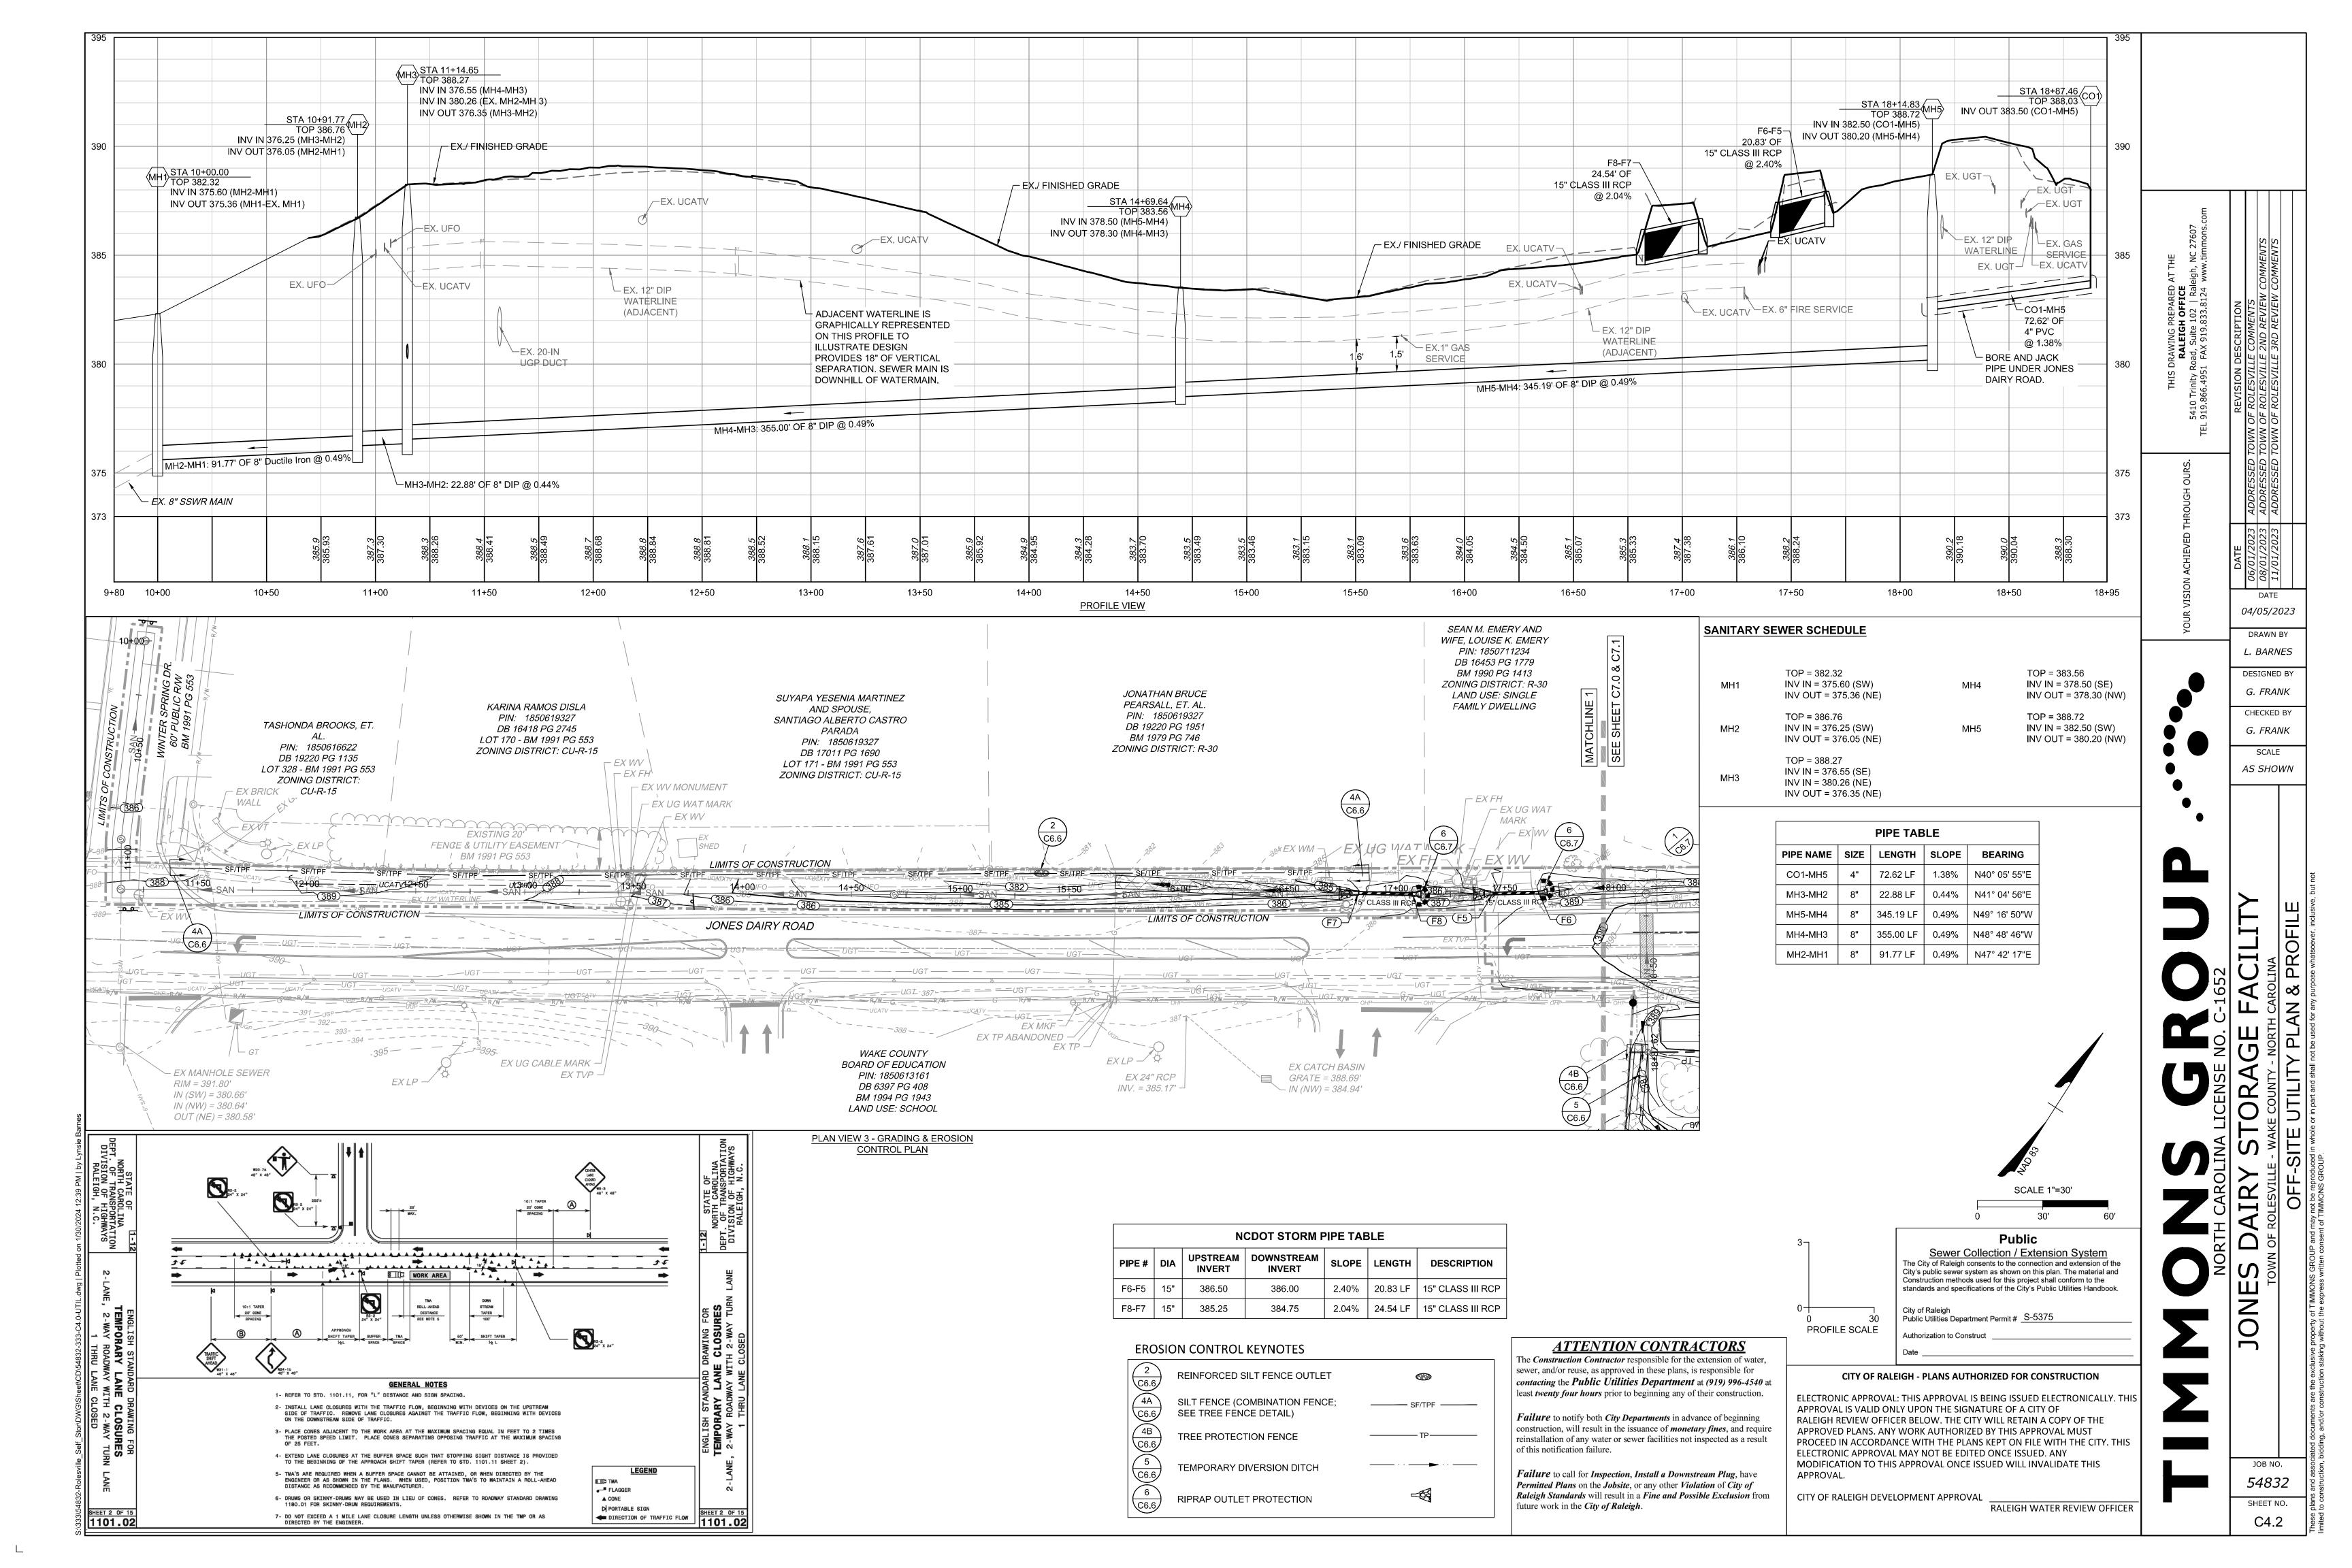


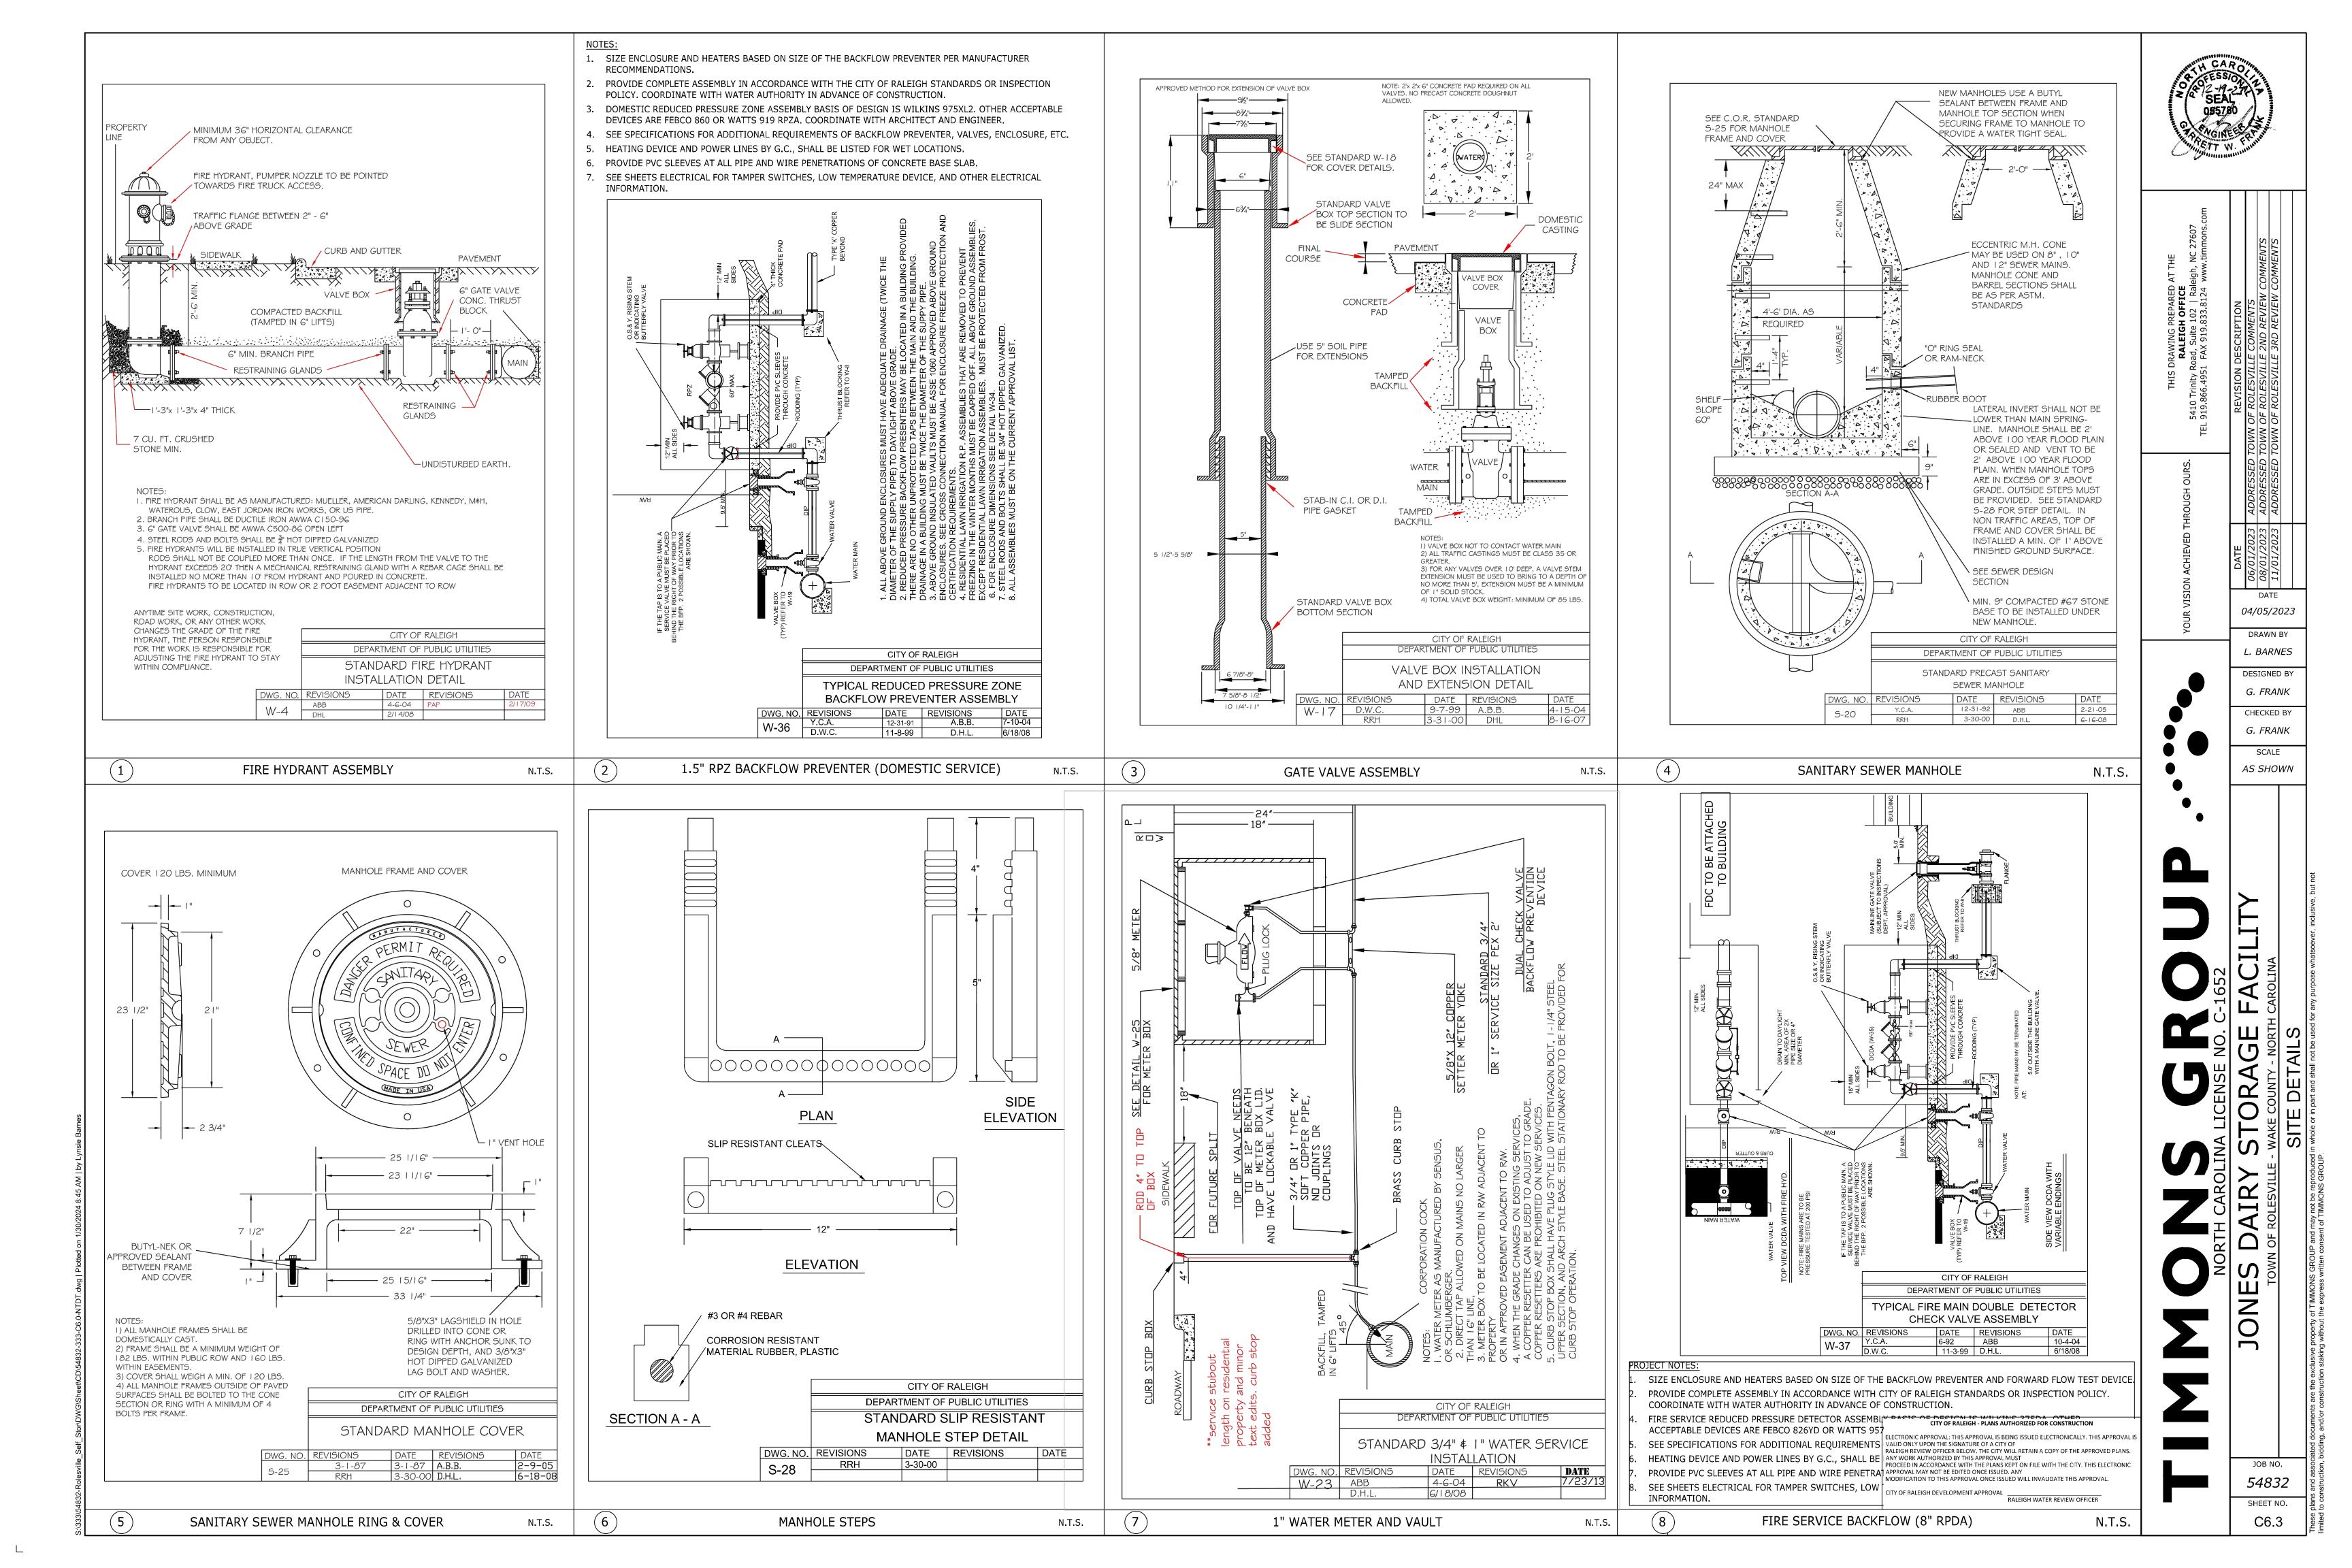

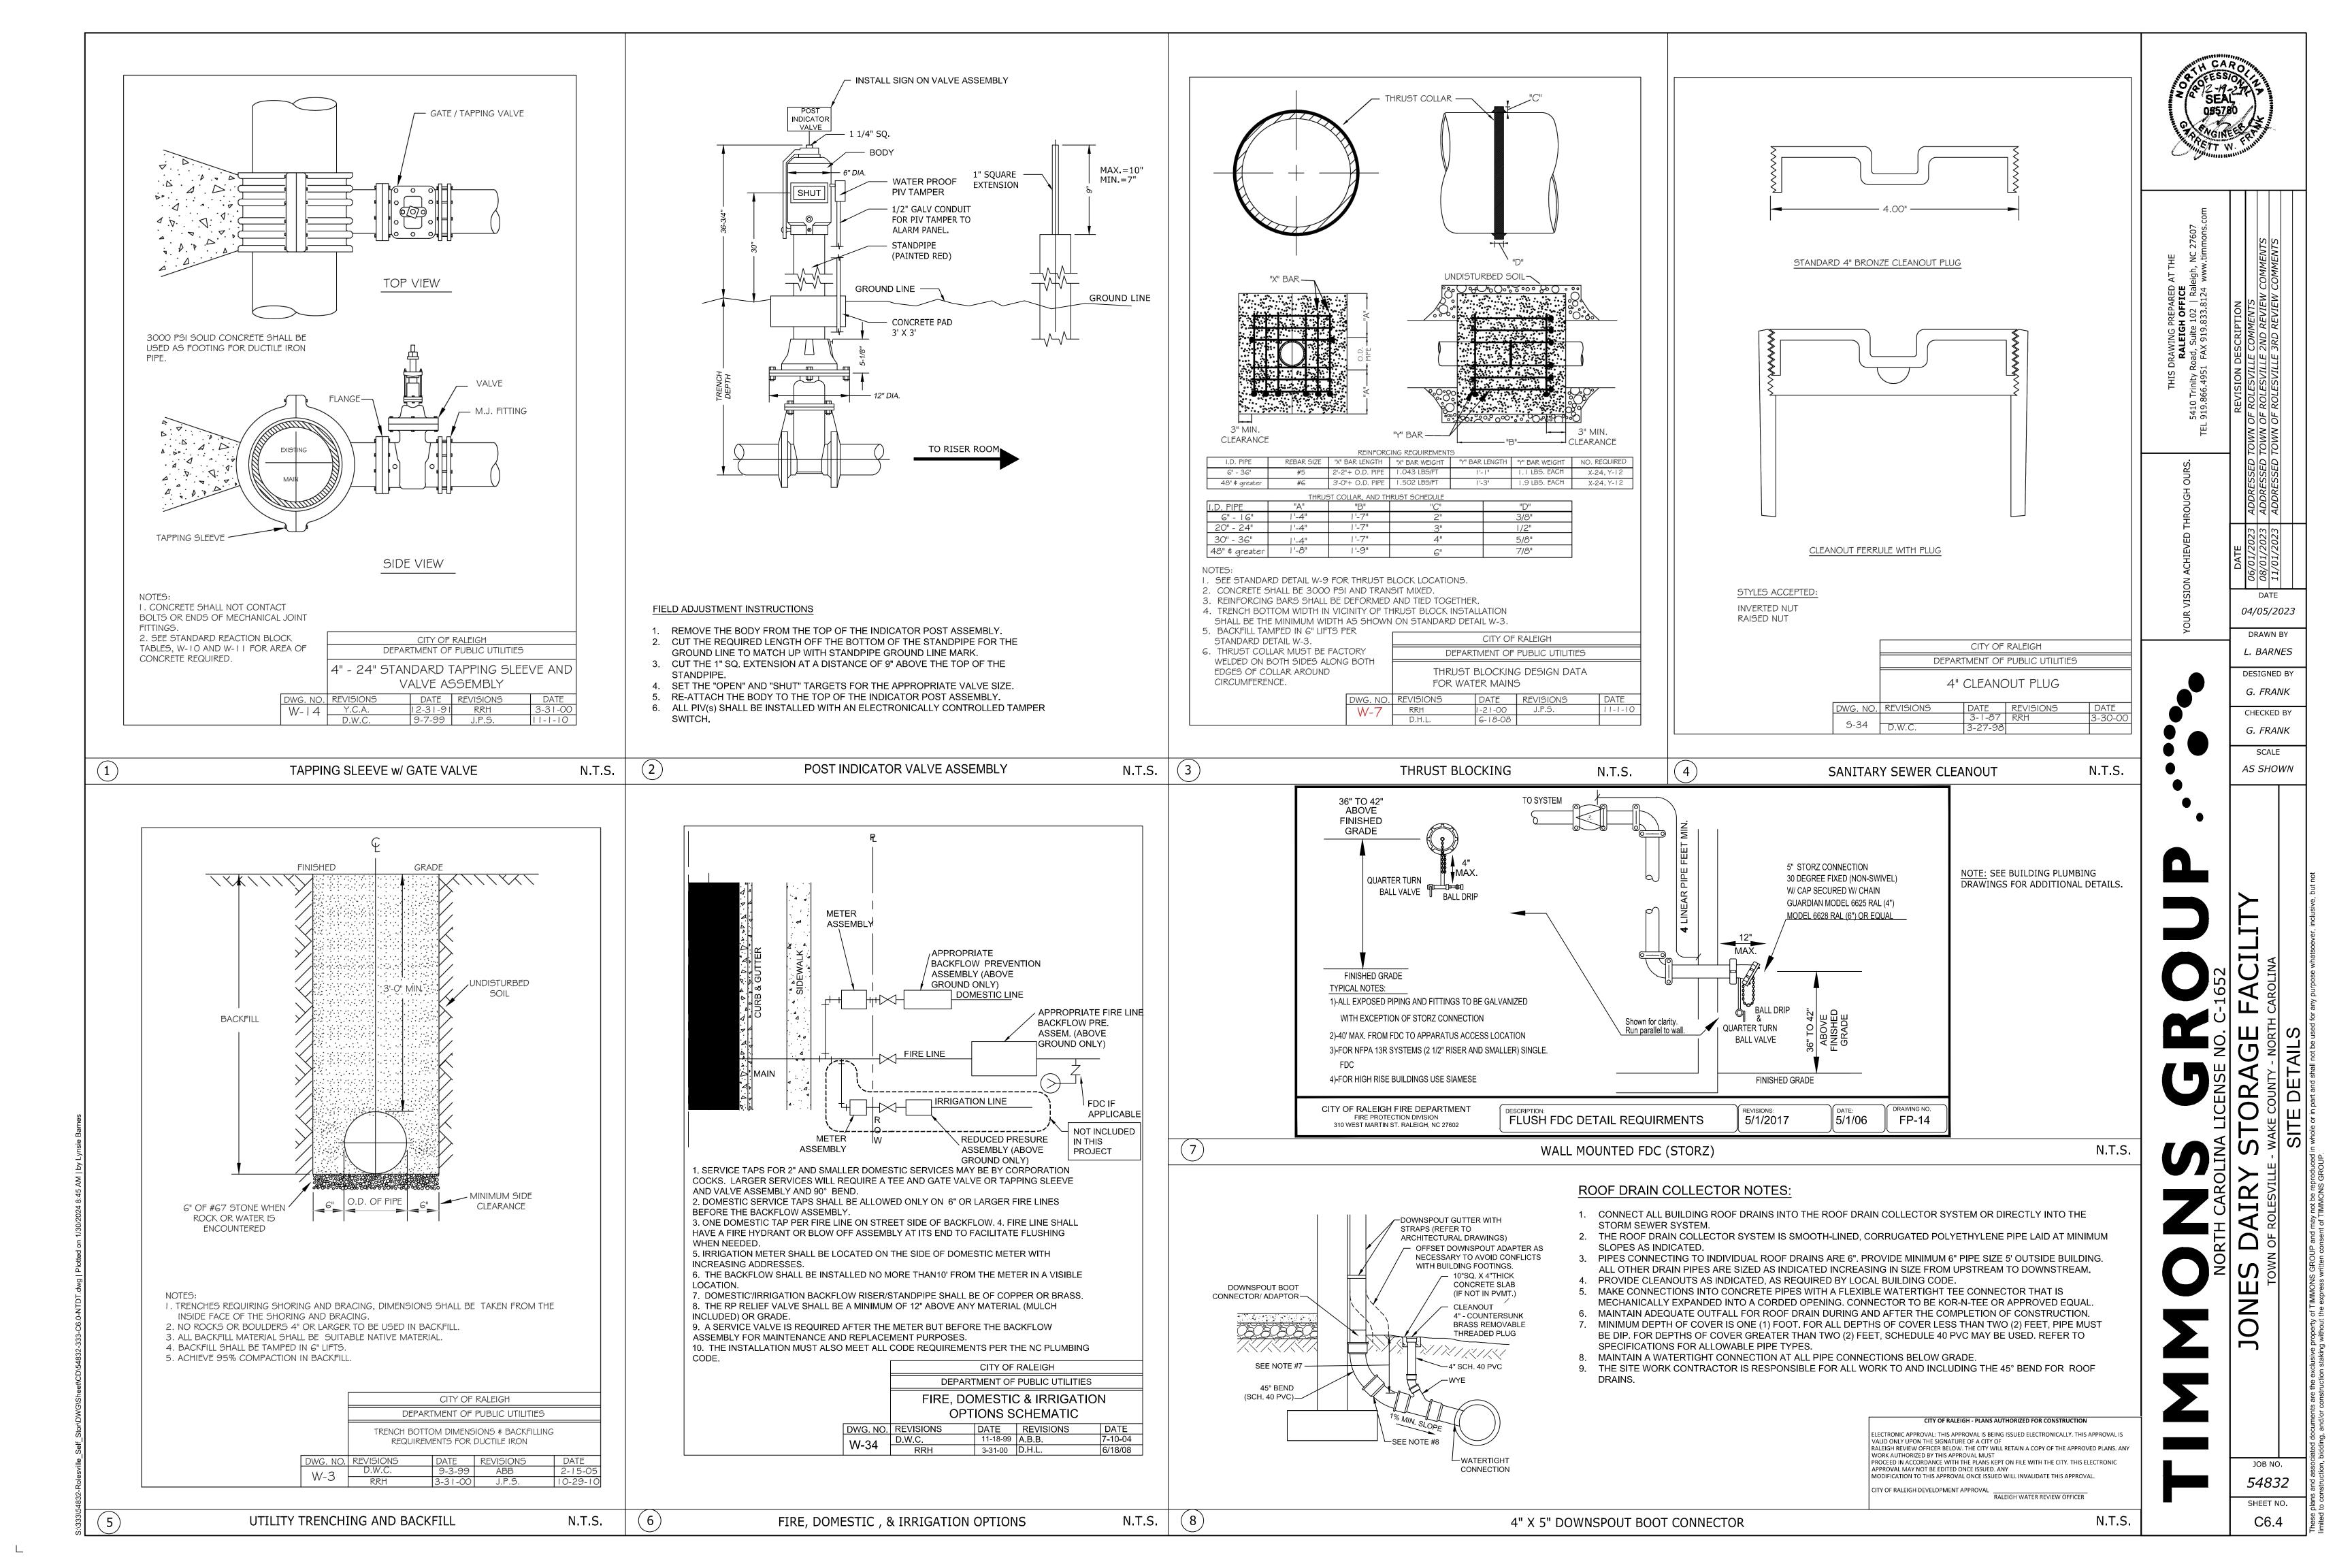

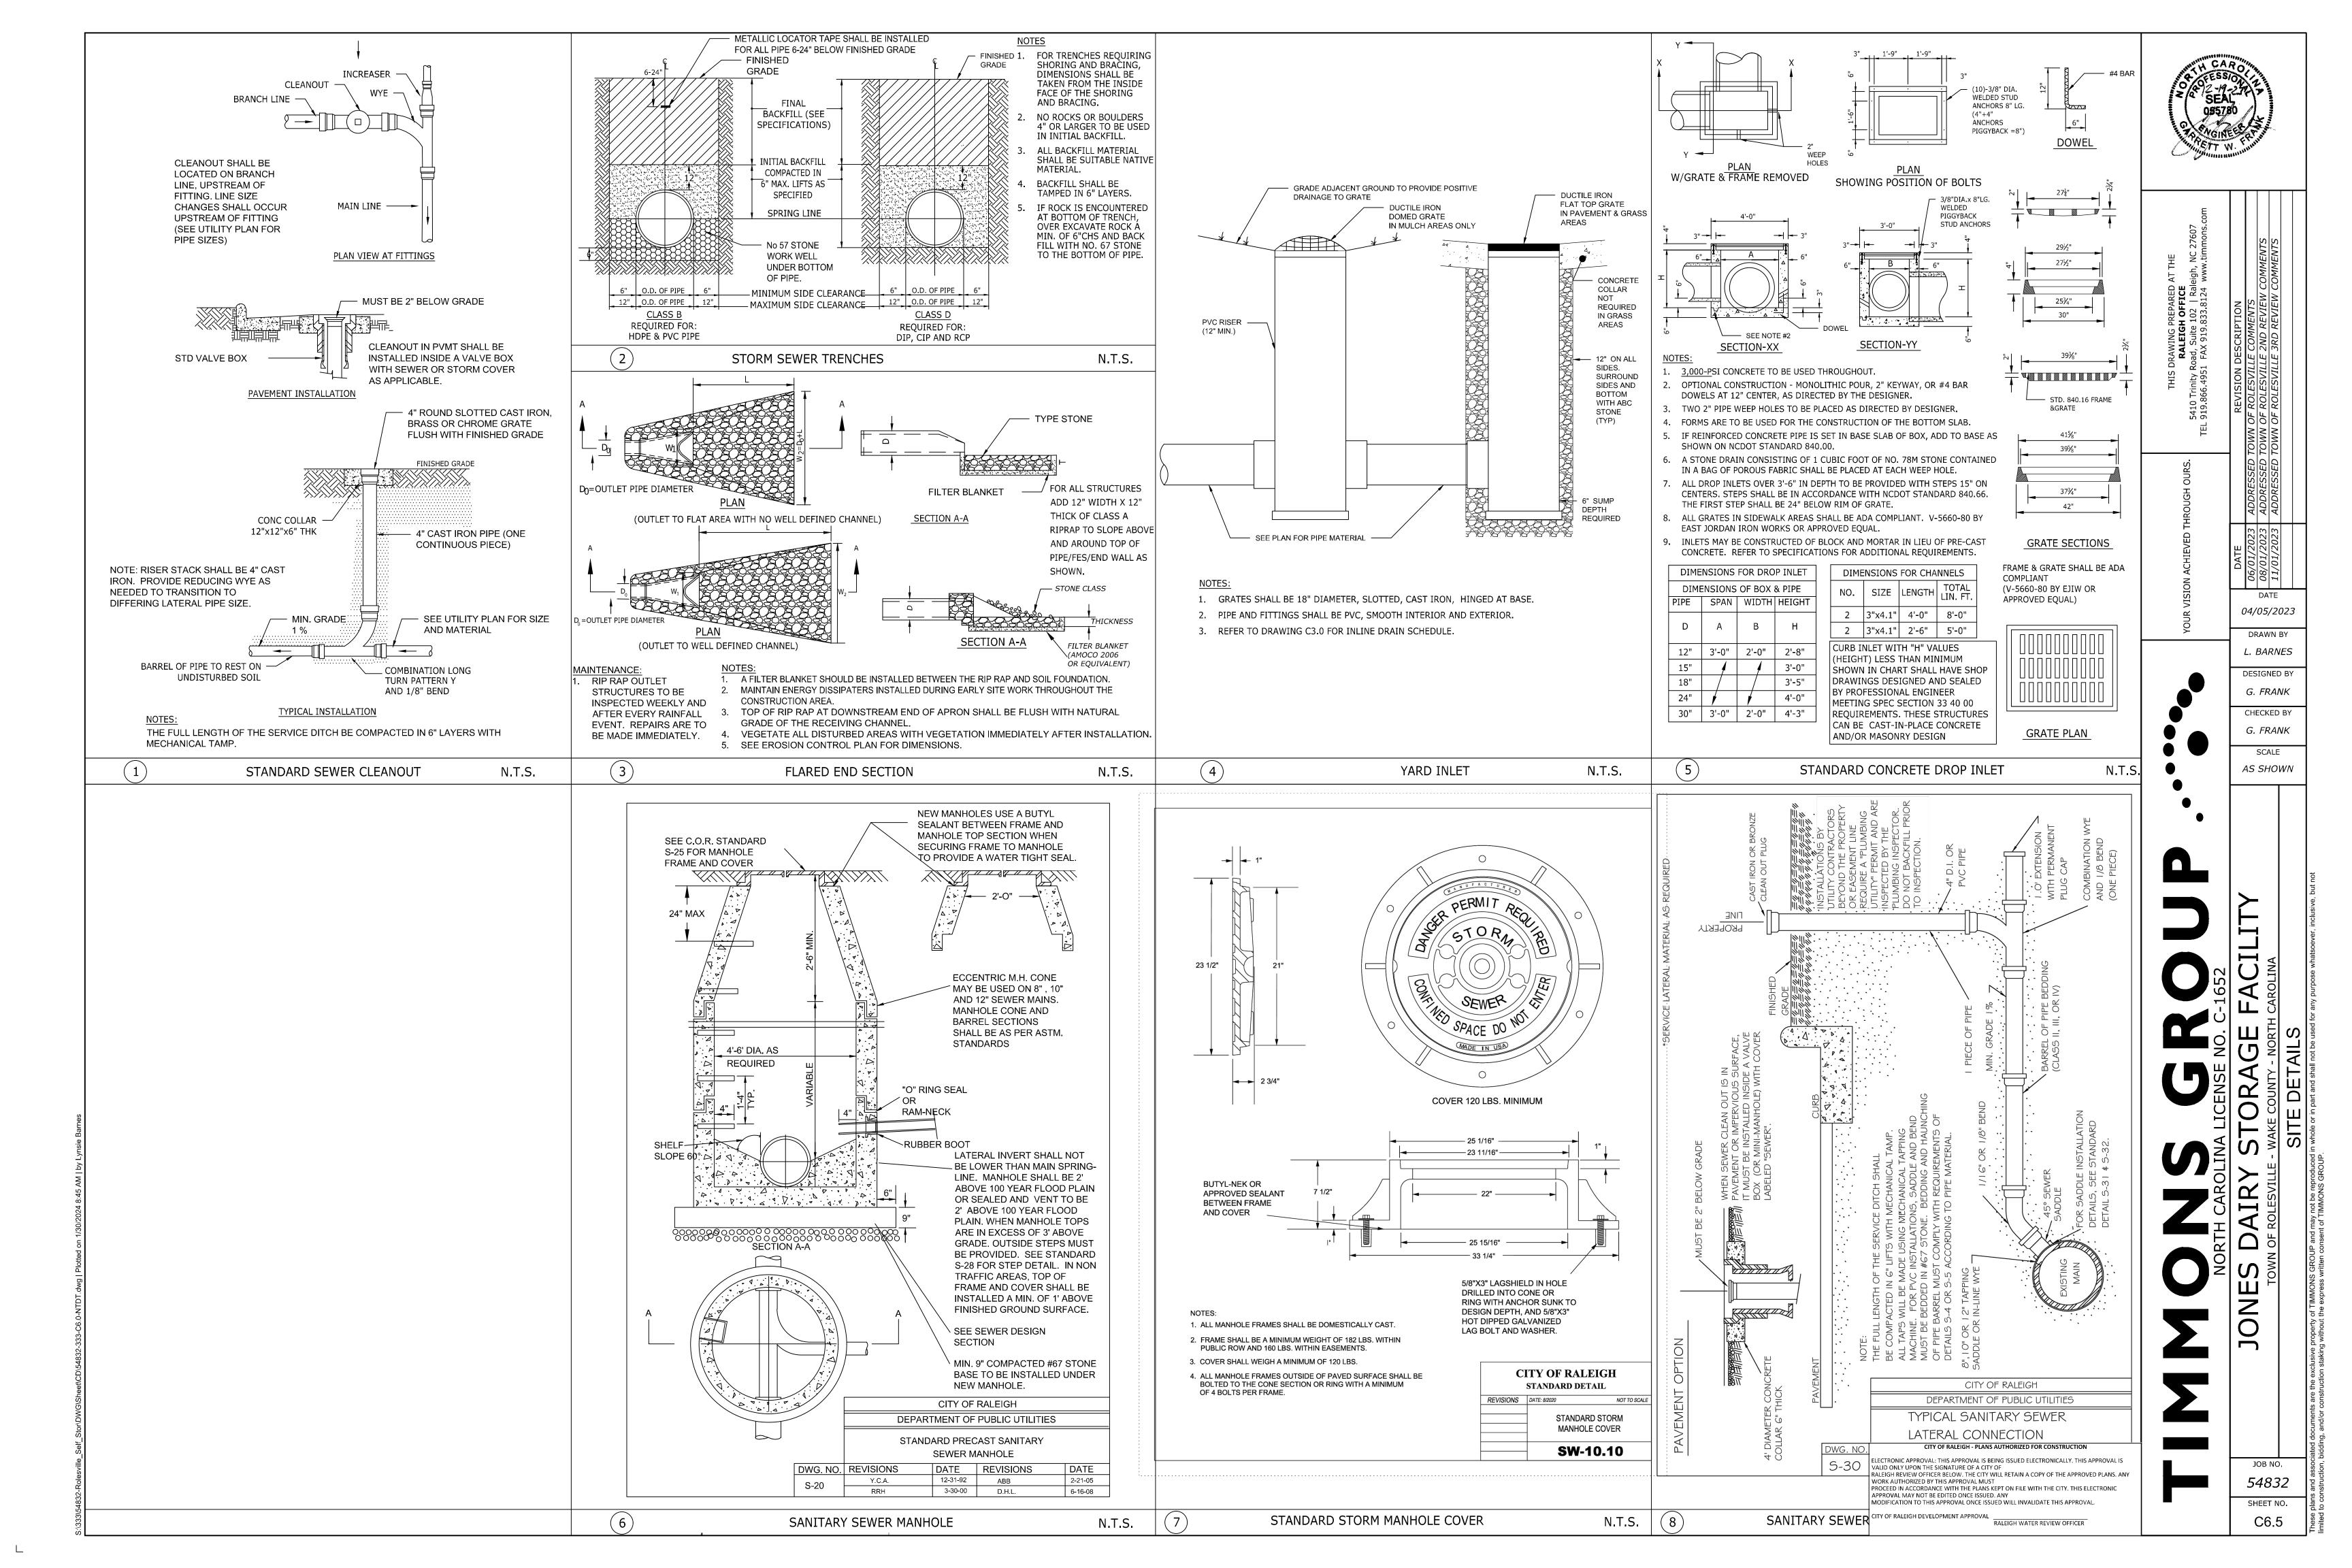

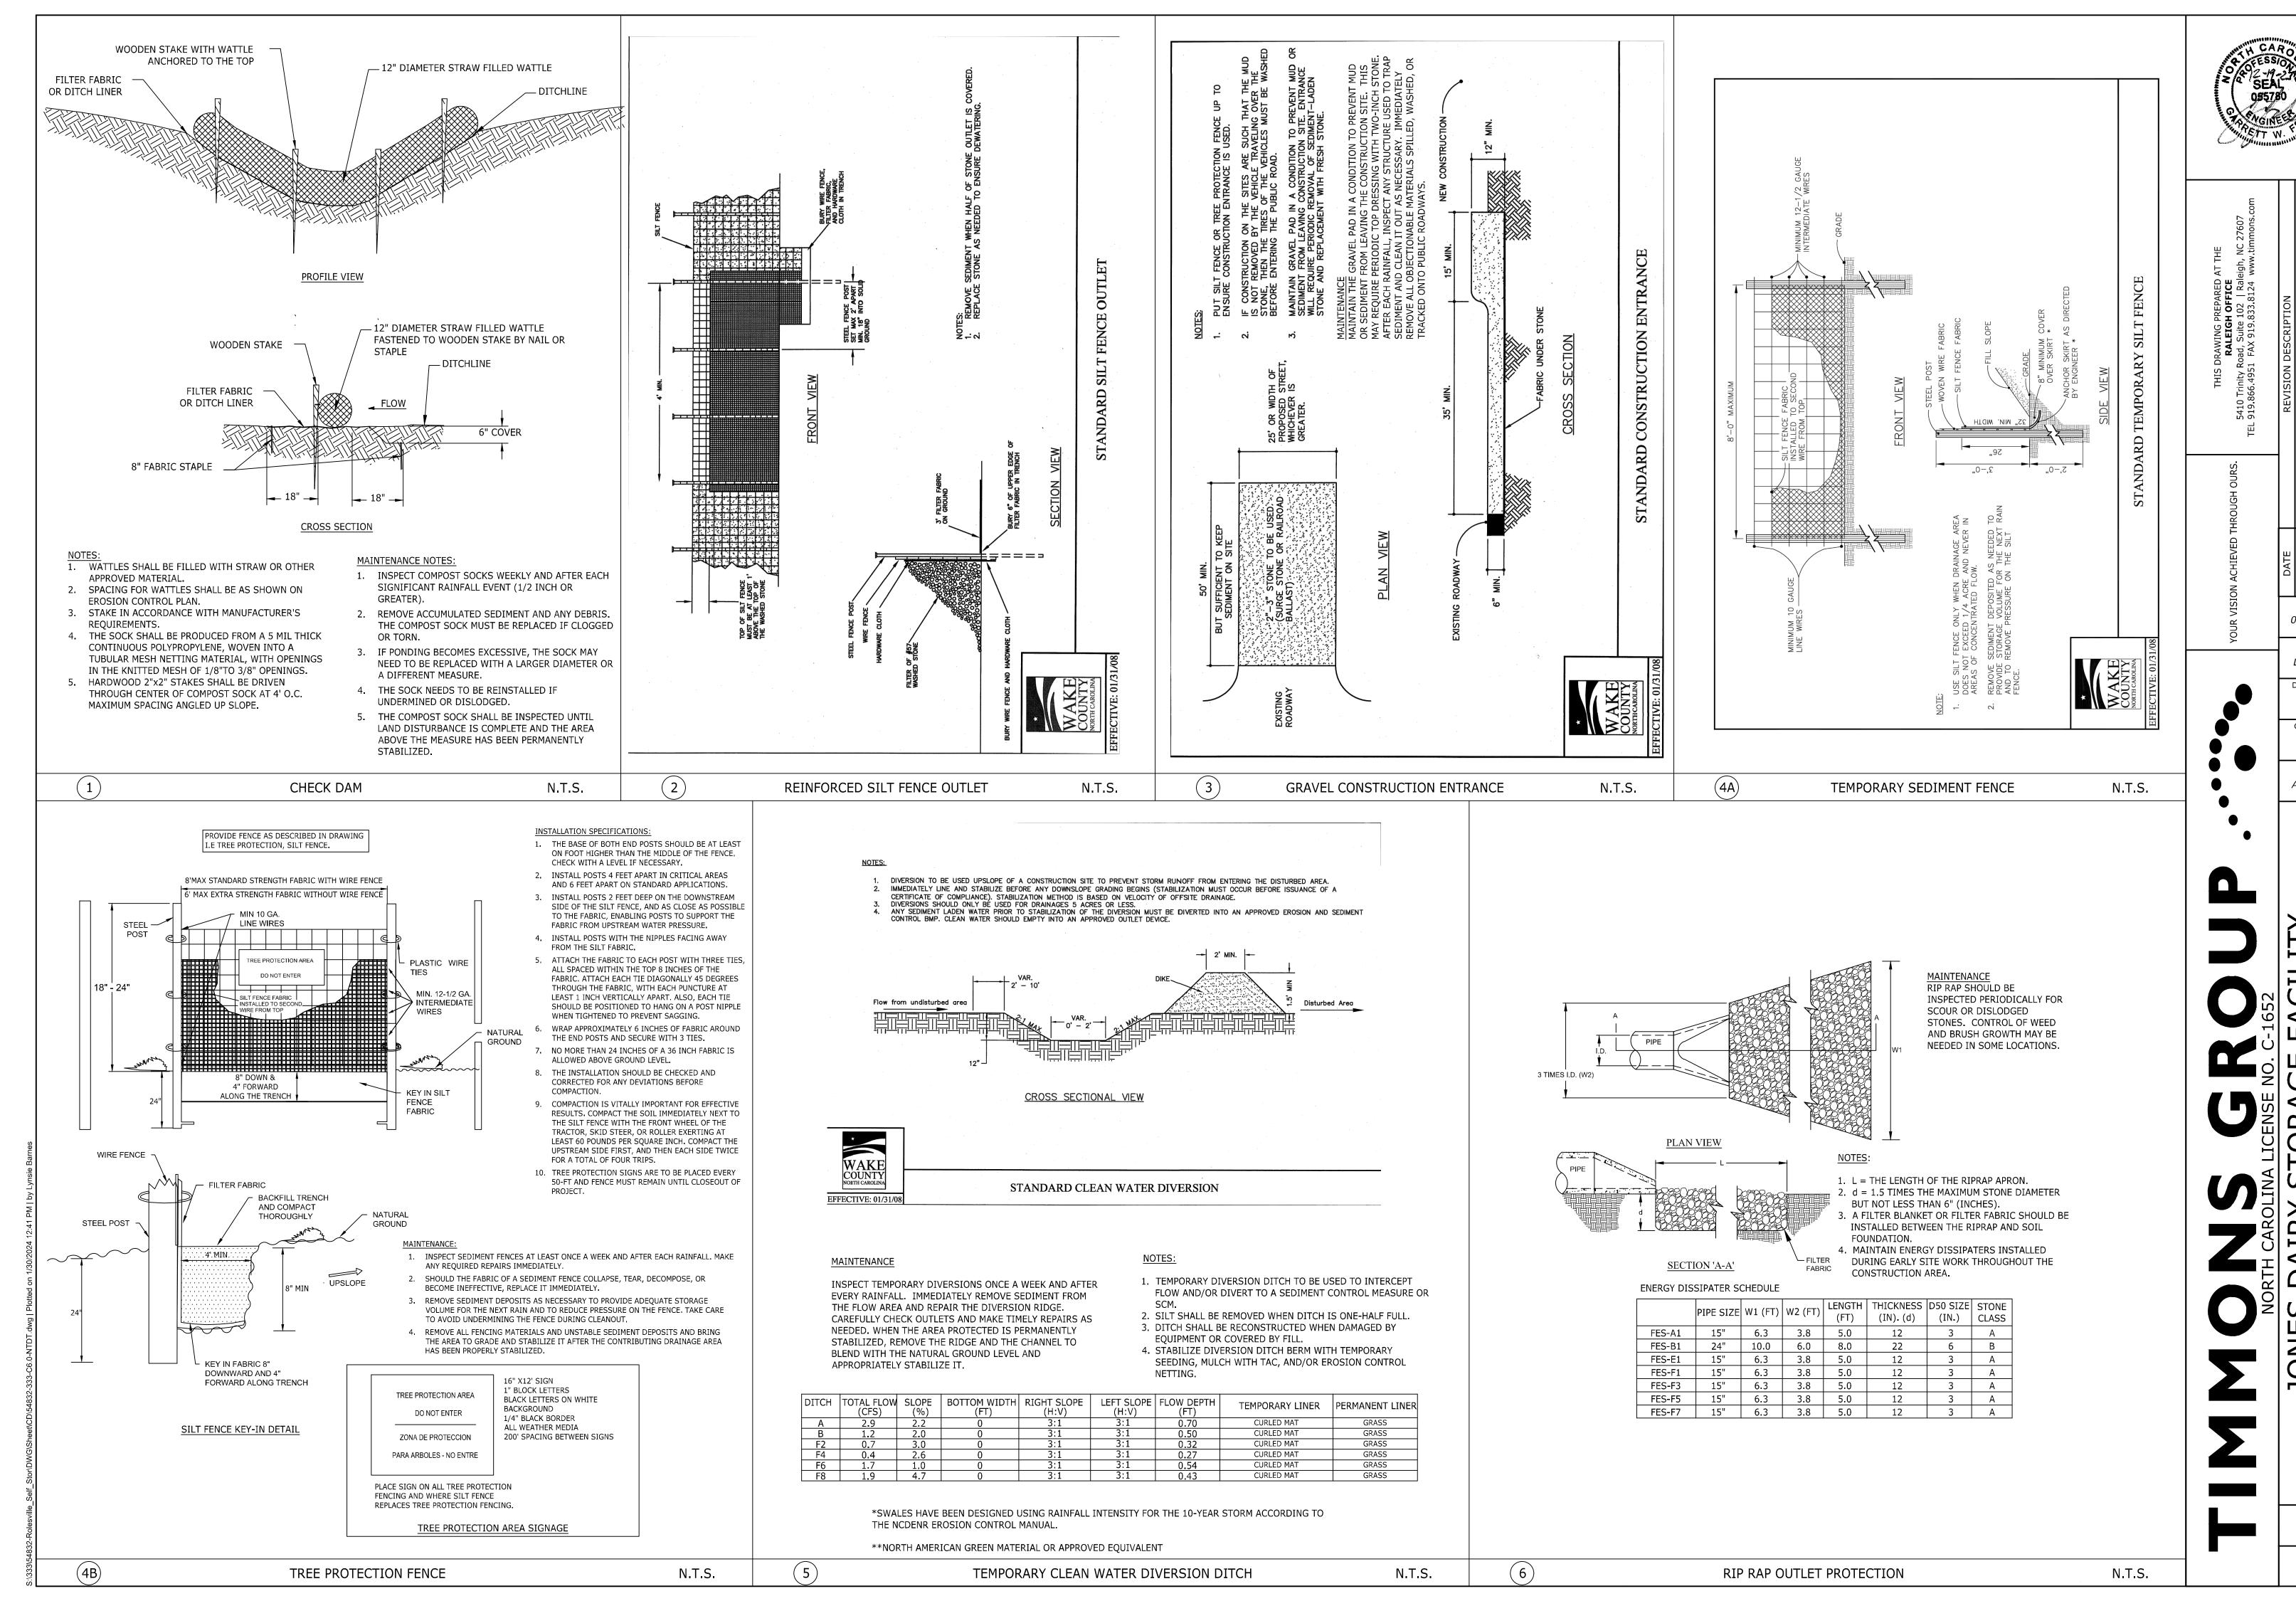

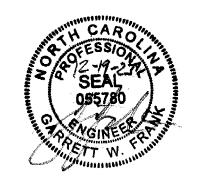

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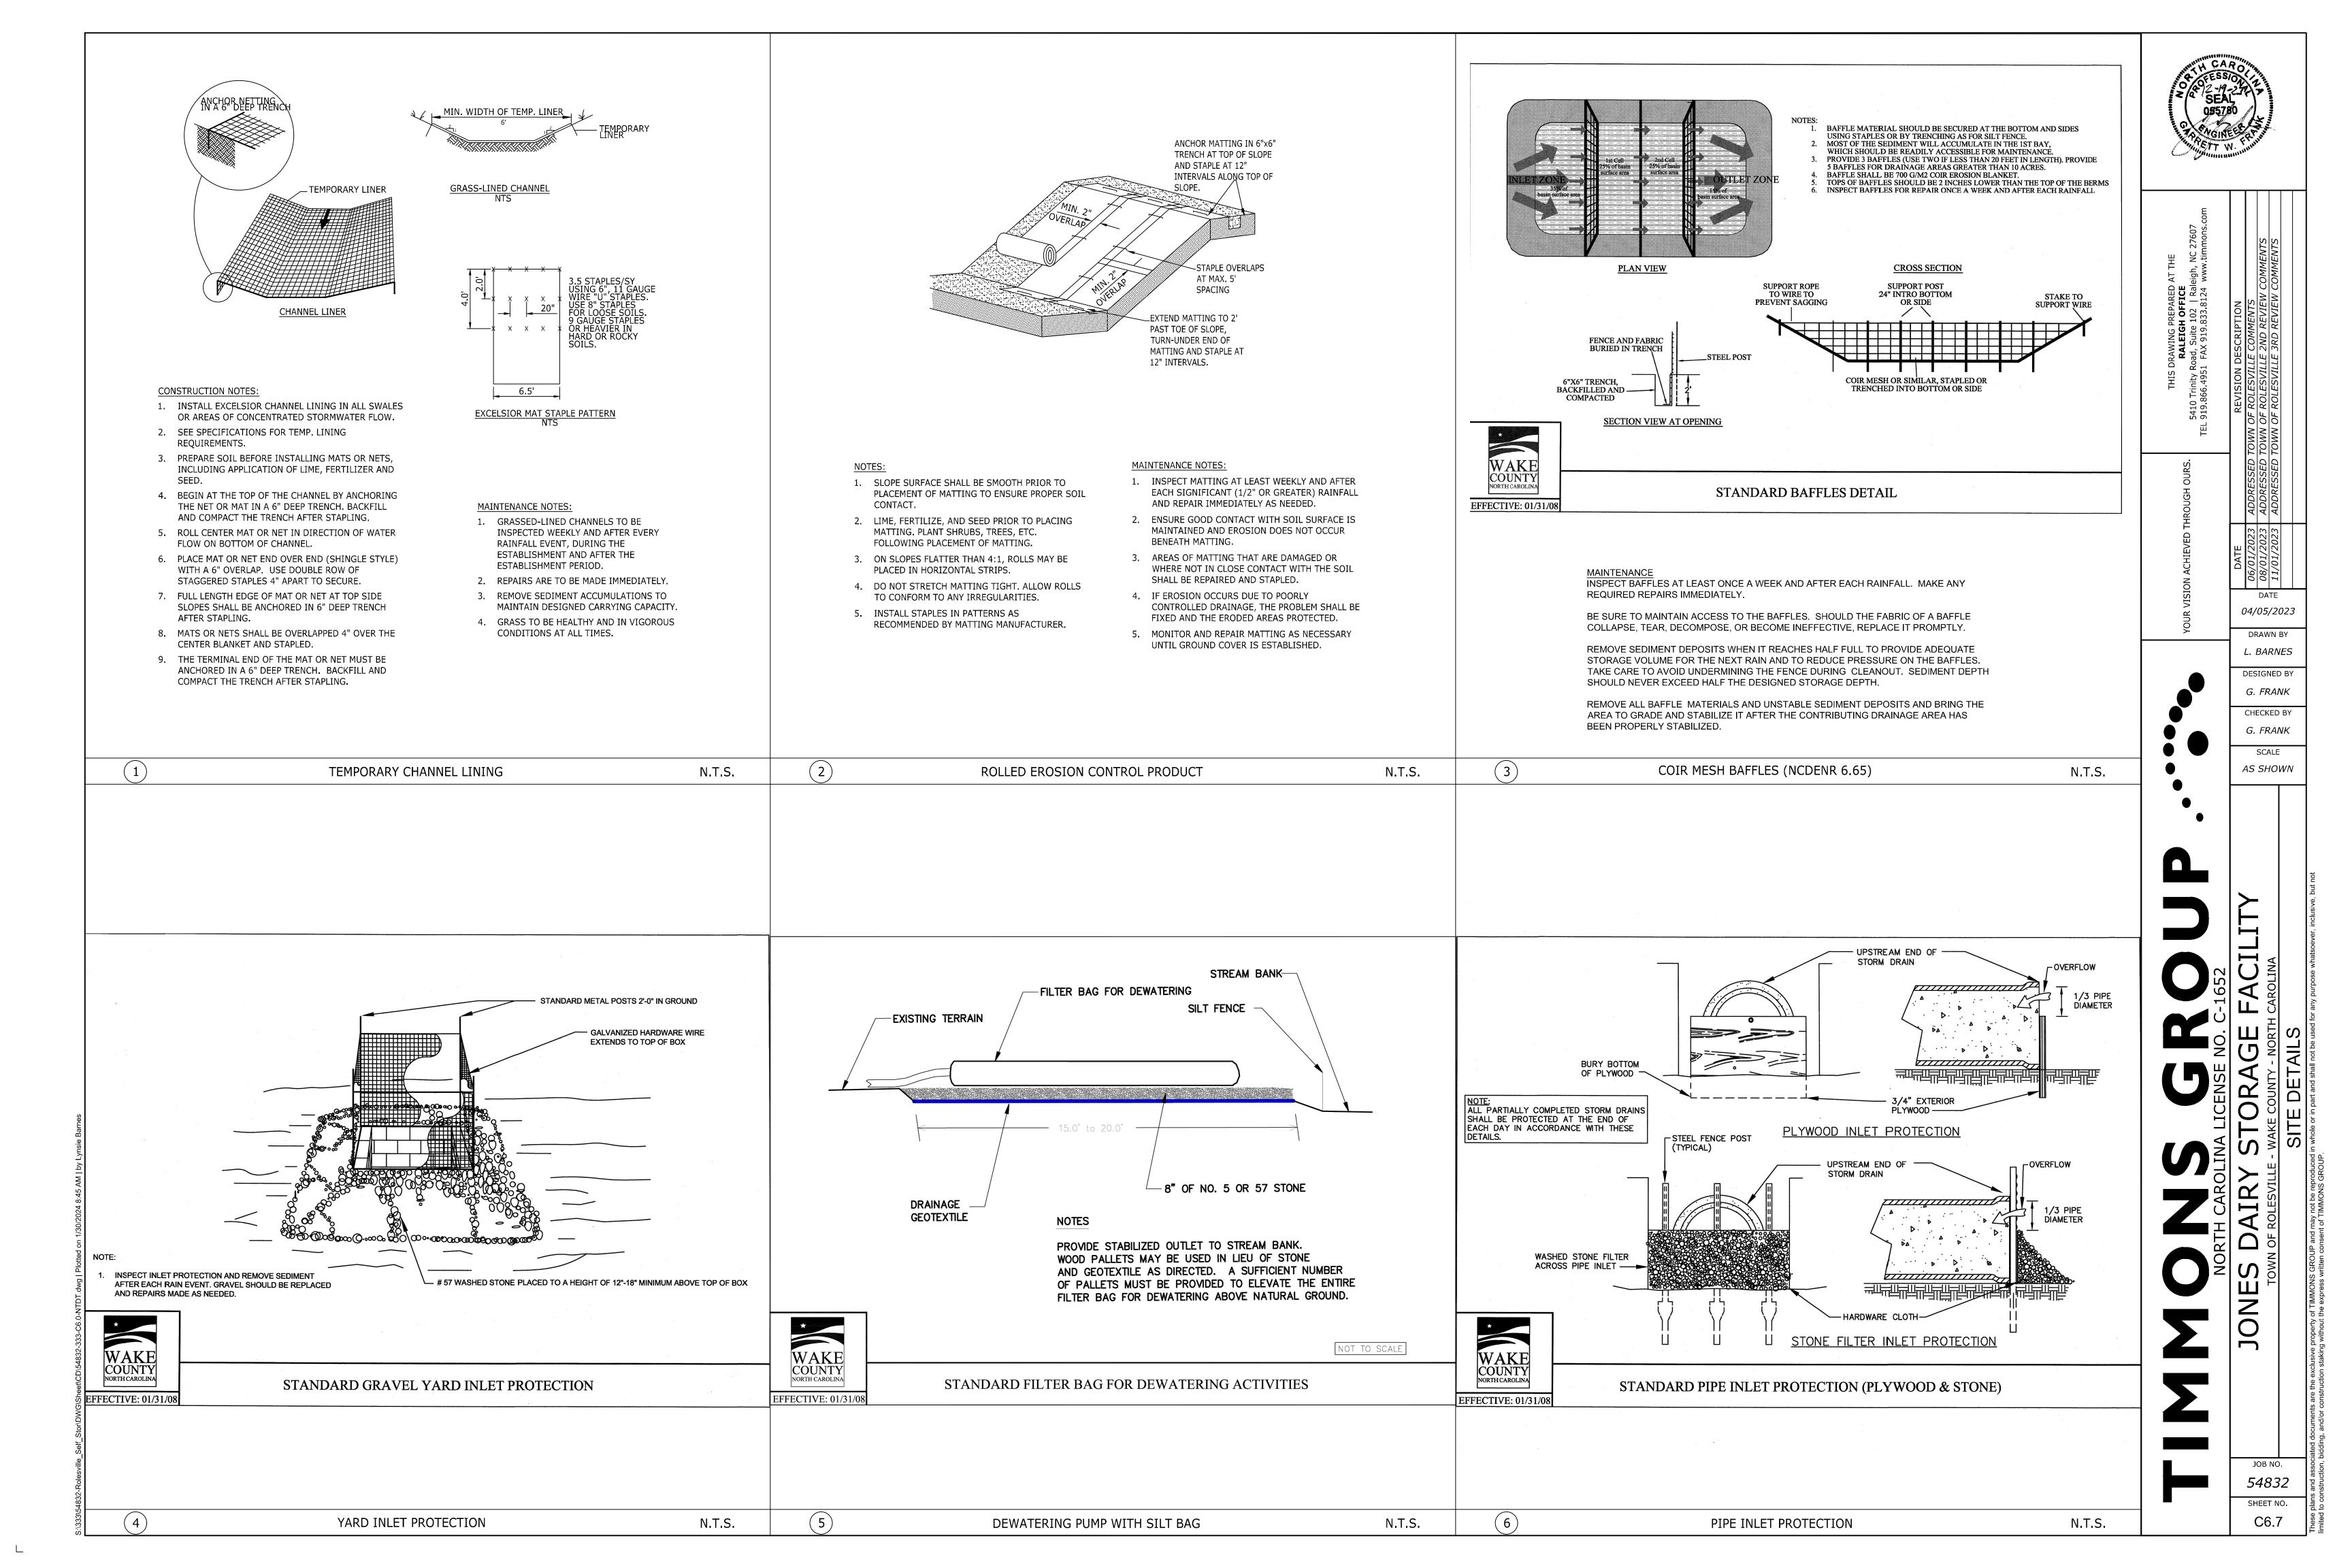
L. BARNES DESIGNED BY G. FRANK


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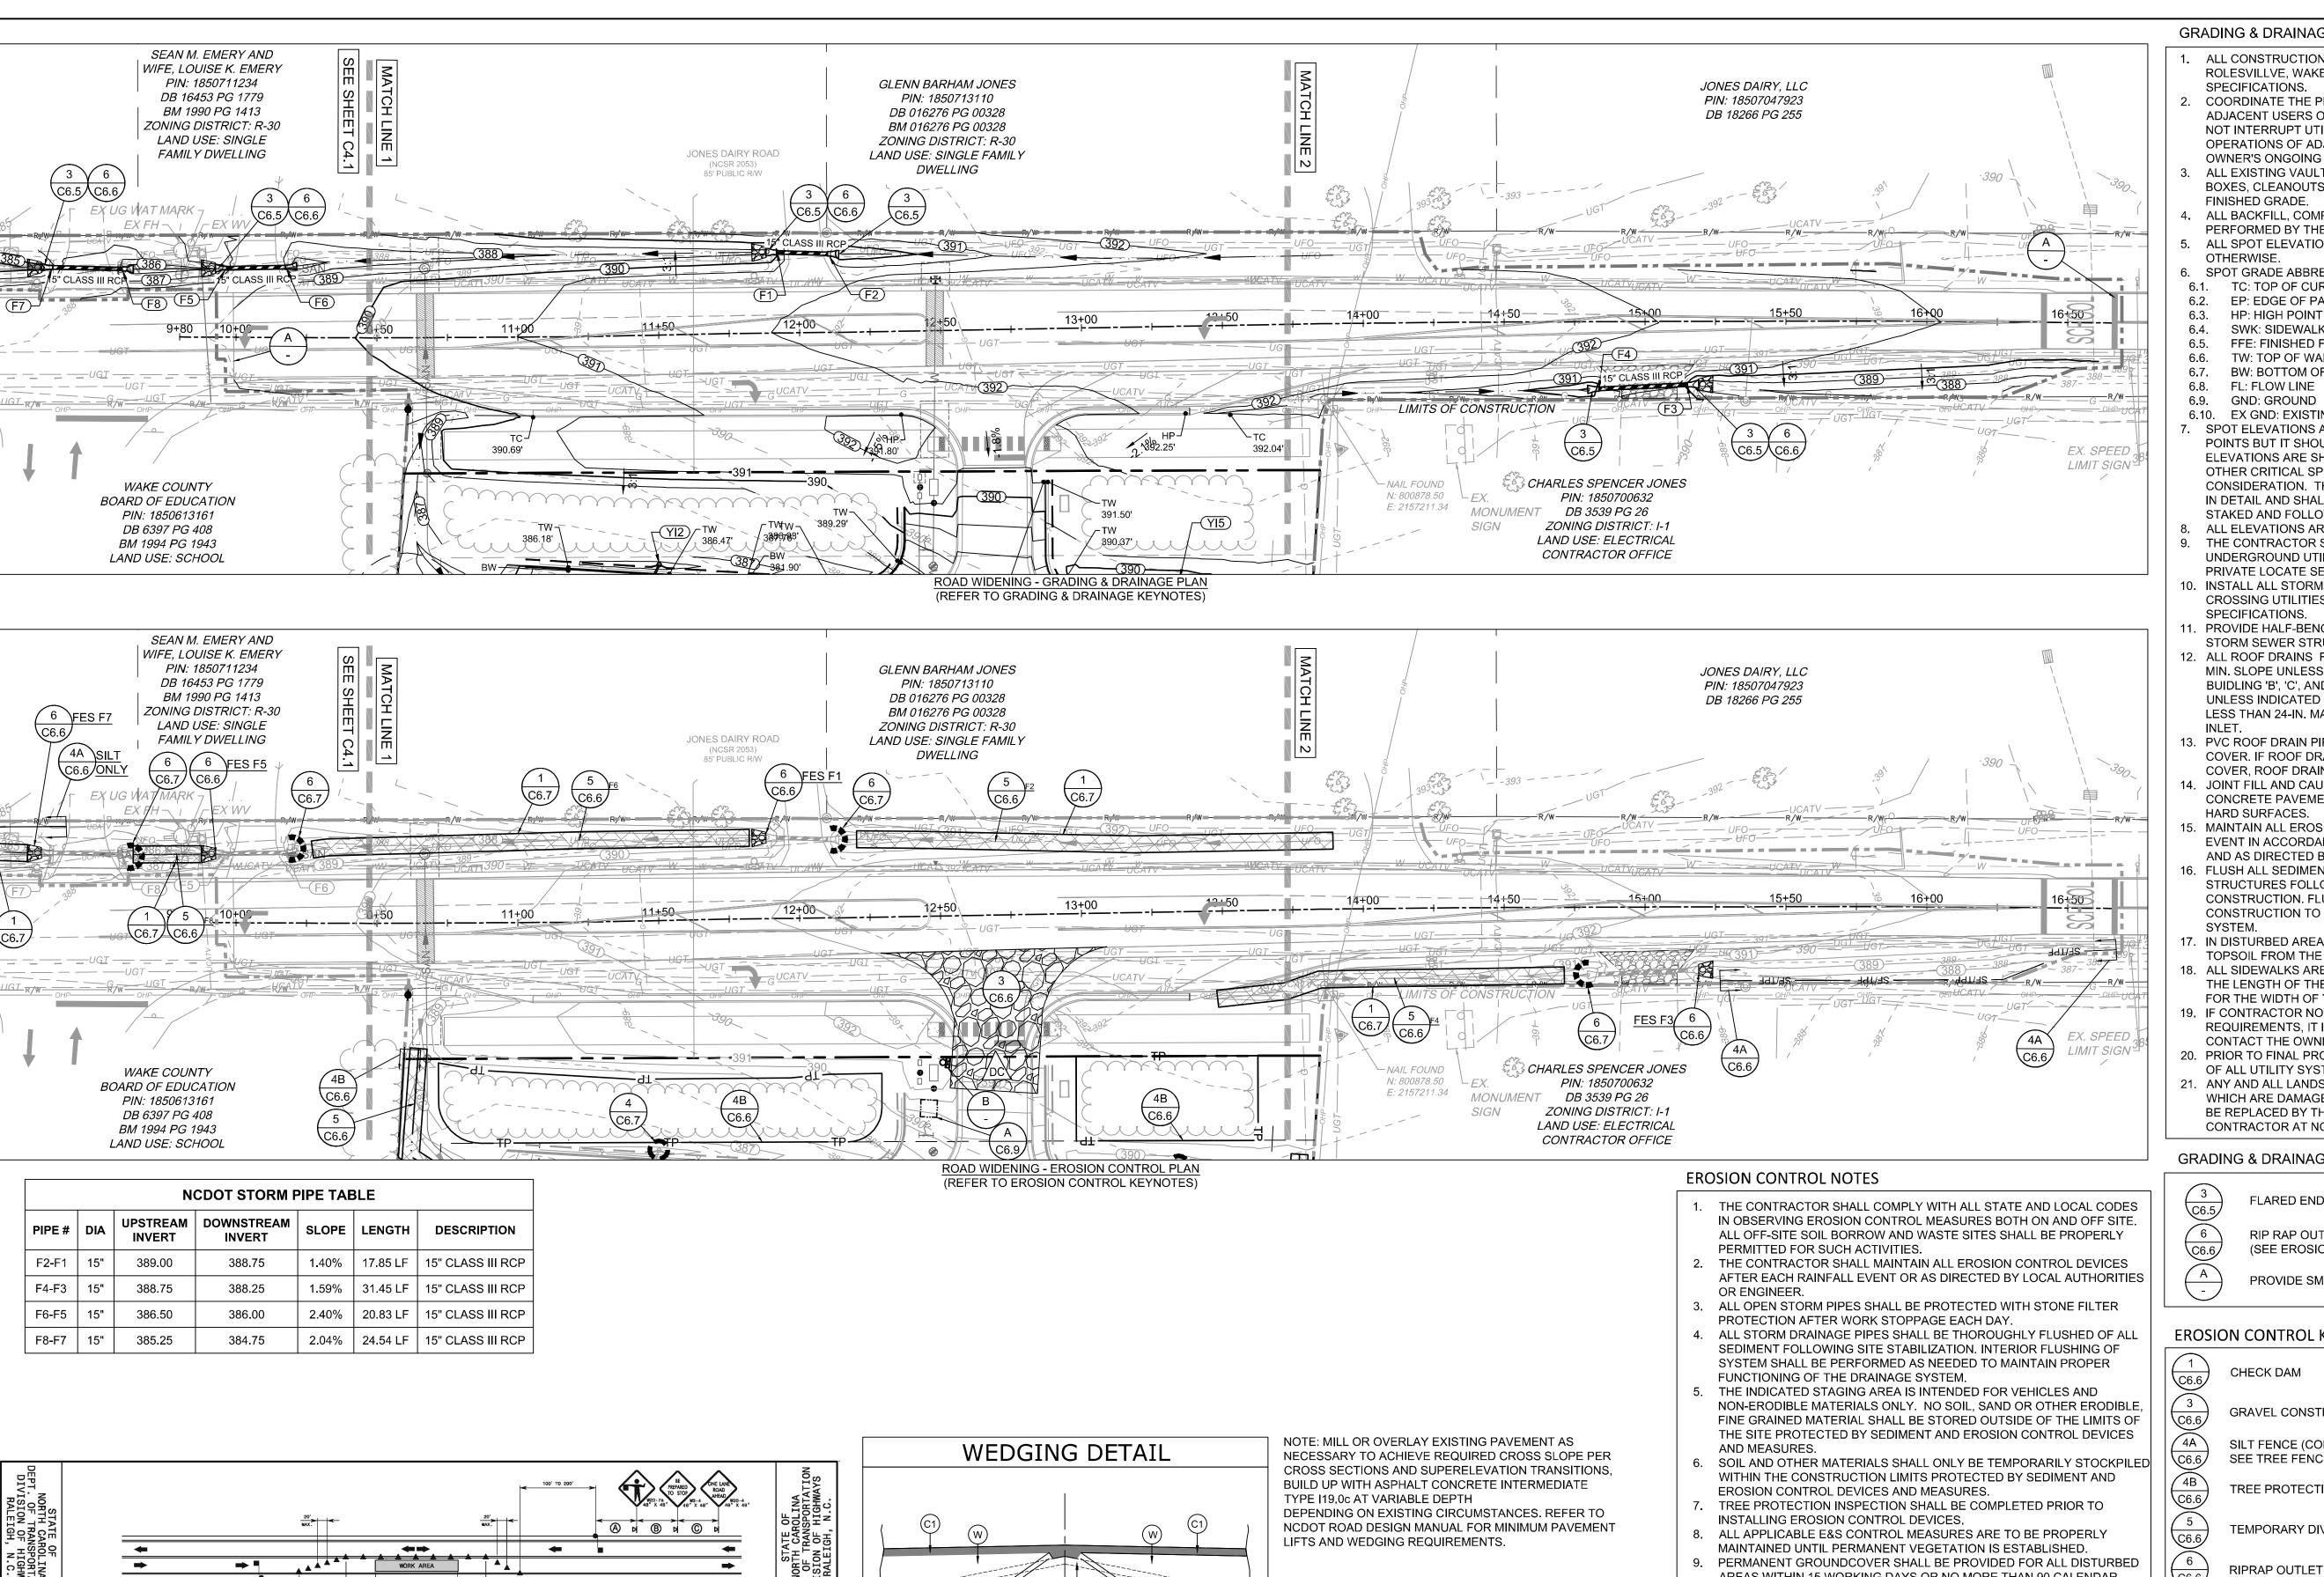
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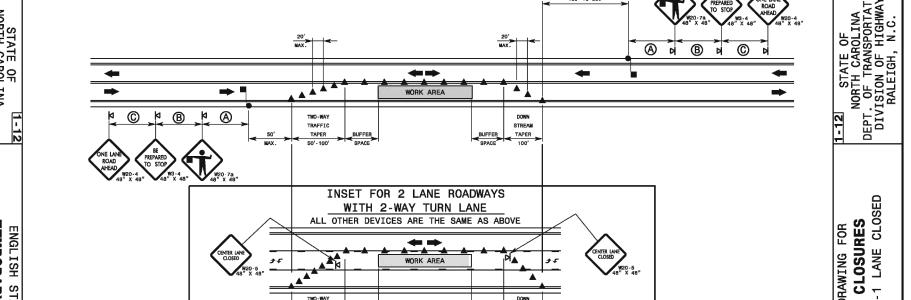
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JOB NO. *54832* SHEET NO.







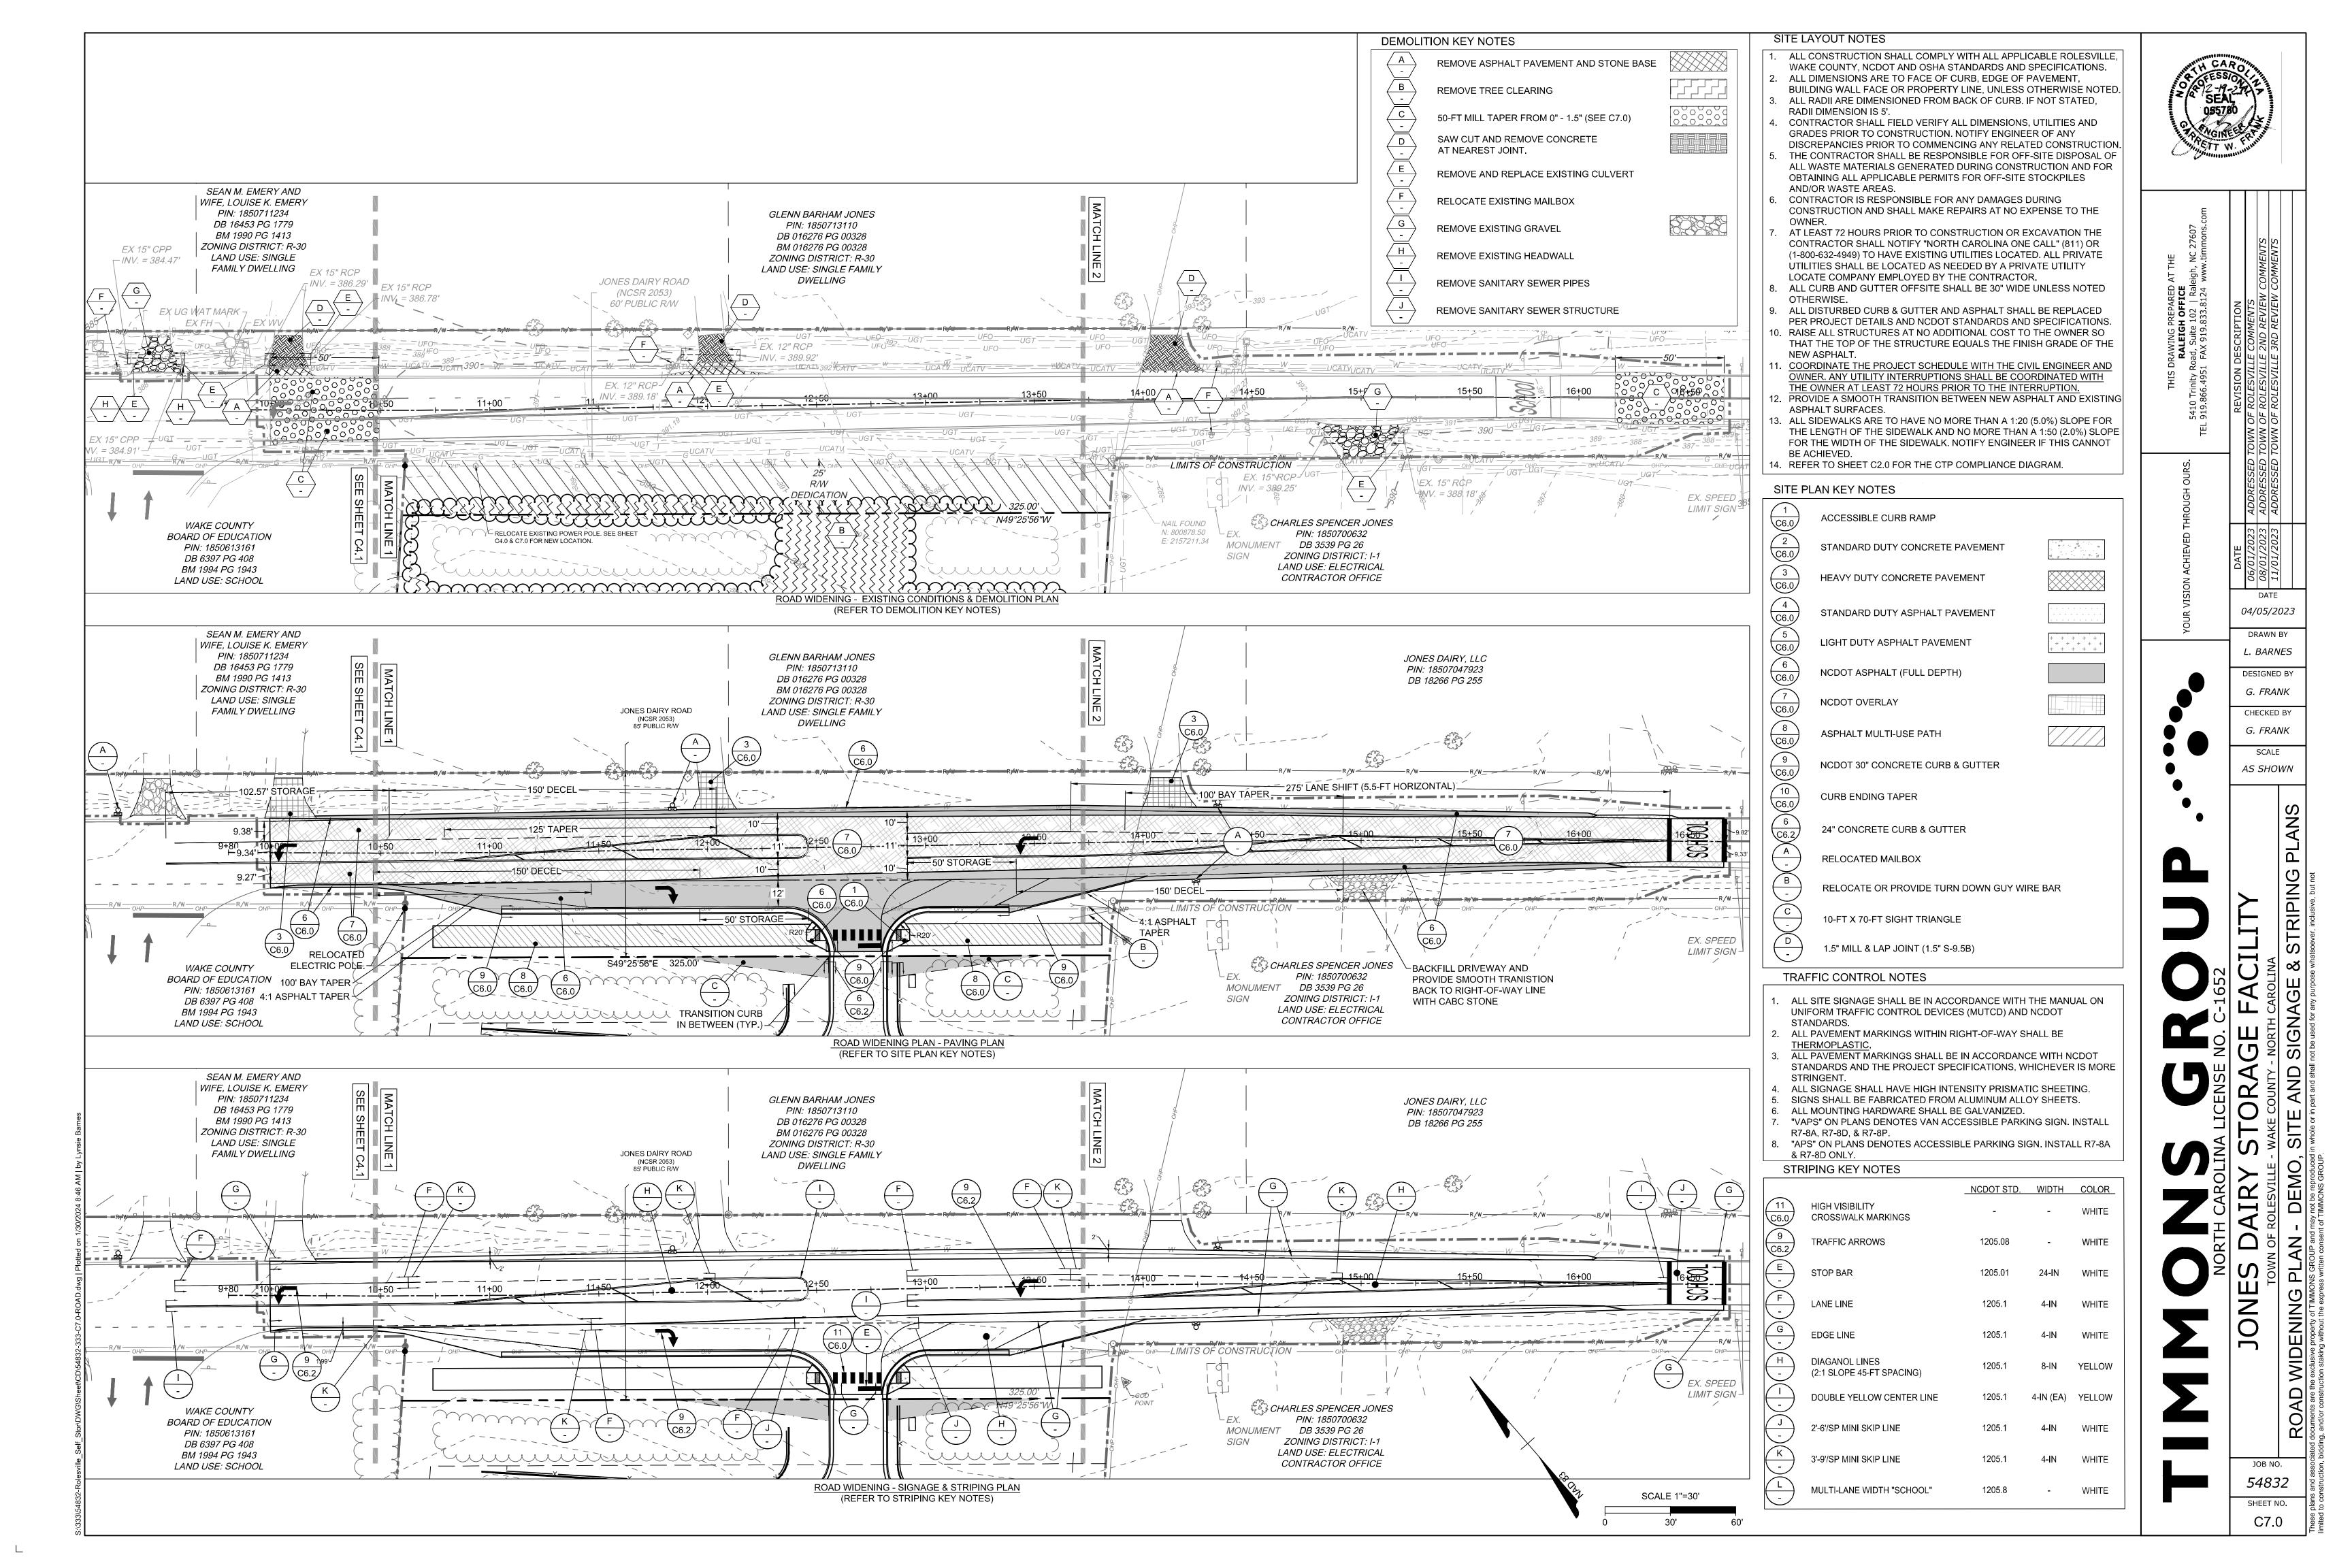

- REFER TO STD. 1101.11 SHEET 4 FOR SIGN SPACING.

2- INSTALL LANE CLOSURES WITH THE TRAFFIC FLOW, BEGINNING WITH DEVICES ON THE UPSTREAM SIDE OF TRAFFIC. REMOVE LANE CLOSURES AGAINST THE TRAFFIC FLOW, BEGINNING WITH DEVICES ON THE DOWNSTREAM SIDE OF TRAFFIC. - PLACE CONES THRU THE WORK AREA AT THE MAXIMUM SPACING EQUAL IN FEET TO 2 TIMES THE POSTED SPEED LIMIT.

- EXTEND LANE CLOSURES AT THE BUFFER SPACE SUCH THAT STOPPING SIGHT DISTANCE IS PROVIDED TO THE FLAGGER (REFER TO STD. 1101.11 SHEET 2). - DO NOT STOP TRAFFIC IN ANY ONE DIRECTION FOR MORE THAN 5 MINUTES AT A TIME. - DRUMS OR SKINNY-DRUMS MAY BE USED IN LIEU OF CONES. REFER TO ROADWAY STANDARD DRAWING 1180.01 FOR SKINNY-DRUM REQUIREMENTS.

- REFER TO 2009 MUTCD, CHAPTER 6, FOR FLAGGER CONTROL, REQUIREMENTS, AND PROCEDURES.


O- DO NOT EXCEED A 1 MILE LANE CLOSURE LENGTH UNLESS OTHERWISE SHOWN IN THE TMP OR AS DIRECTED BY THE ENGINEER.

GENERAL NOTES FOR PILOT CAR OPERATIONS
1- USE PILOT CARS WHEN DIRECTED BY THE ENGINEER. 2- IF ROADWAY WIDTH IS LESS THAN 22 FEET (EOP TO EOP), CONES MAY NOT BE REQUIRED ALONG WORK AREA, AND AT THE DISCRETION OF THE ENGINEER, CONES MAY BE OMITTED ALONG THE WORK AREA IF USING A PILOT CAR. 3- CONES ARE ALWAYS REQUIRED IN THE UPSTREAM AND DOWNSTREAM TAPERS. 4- MOUNT SIGN G20-4 "PILOT CAR FOLLOW ME" AT A CONSPICUOUS POSITION ON THE REAR OF THE PILOT VEHICLE.

5- DO NOT INSTALL MORE THAN ONE (1) MILE OF LANE CLOSURE, MEASURED FROM THE BEGINNING | A P S 6- ADVISE RESIDENTS AND BUSINESSES WITHIN THE LANE CLOSURE LIMITS ABOUT METHODS OF SAFE EGRESS AND INGRESS FROM DRIVEWAYS DURING FLAGGING AND PILOT CAR OPERATIONS FLAGGER PORTABLE SIGN ◆ DIRECTION OF TRAFFIC FLOW

# DETAIL SHOWING METHOD OF WEDGING

PAVEMENT SCHEDULE			
C1	PROP. APPROX. 1.5" ASPHALT CONCRETE SURFACE COURSE, TYPE S9.5C.		
W	PROP. VAR. DEPTH ASPHALT CONCRETE SURFACE COURSE, TYPE S9.5C.		
U	EXISTING PAVEMENT		

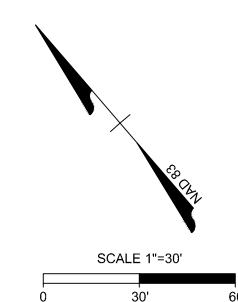


- AREAS WITHIN 15 WORKING DAYS OR NO MORE THAN 90 CALENDAR DAYS (WHICHEVER IS SHORTER).
- 10. TOTAL DISTURBED AREA: 5.77 AC.

NCDOT STORM STRUCTURE TABLE				
STRUCTURE#	ТОР	STRUCTURE HEIGHT	DESCRIPTION	
F1	390.44	N/A	15" FES	
F2	390.19	N/A	15" FES	
F3	389.69	N/A	15" FES	
F4	390.19	N/A	15" FES	
F5	387.44	N/A	15" FES	
F6	387.94	N/A	15" FES	
F7	386.19	N/A	15" FES	
F8	386.69	N/A	15" FES	

### **GRADING & DRAINAGE NOTES**

- ALL CONSTRUCTION SHALL COMPLY WITH ALL APPLICABLE ROLESVILLVE, WAKE COUNTY, NCDOT AND OSHA STANDARDS AND SPECIFICATIONS.
- COORDINATE THE PROJECT SCHEDULE WITH THE OWNER, AND ADJACENT USERS OF THE PROPERTY. MAINTAIN TRAFFIC FLOW AND DO NOT INTERRUPT UTILITIES AROUND THE SITE. DO NO DISTURB OPERATIONS OF ADJACENT SITES AND FACILITIES AND/OR THEIR
- OWNER'S ONGOING OPERATIONS. ALL EXISTING VAULTS, MANHOLES, STORM DRAIN STRUCTURES, VALVE BOXES, CLEANOUTS, ETC. SHALL BE ADJUSTED AS NEEDED TO MATCH
- FINISHED GRADE. ALL BACKFILL, COMPACTION, SOILS TESTING, ETC. SHALL BE
- PERFORMED BY THE OWNER'S INDEPENDENT TESTING LABORATORY ALL SPOT ELEVATIONS INDICATED ARE AT TOP OF CURB UNLESS NOTED
- SPOT GRADE ABBREVIATIONS:
- 6.1. TC: TOP OF CURB
- 6.2. EP: EDGE OF PAVEMENT
- 6.4. SWK: SIDEWALK 6.5. FFE: FINISHED FLOOR ELEVATION
- 6.6. TW: TOP OF WALL
- 6.7. BW: BOTTOM OF WALL 6.8. FL: FLOW LINE
- 6.9. GND: GROUND
- 6.10. EX GND: EXISTING GROUND
- SPOT ELEVATIONS ARE GIVEN AT THE MAJORITY OF THE MAJOR BREAK POINTS BUT IT SHOULD NOT BE ASSUMED THAT ALL NECESSARY SPOT ELEVATIONS ARE SHOWN. DUE TO SPACE LIMITATIONS, THERE MAY BE OTHER CRITICAL SPOTS NOT LABELED THAT SHOULD BE TAKEN INTO CONSIDERATION. THE CONTRACTOR SHALL REVIEW THE GRADING PLAN IN DETAIL AND SHALL ENSURE THAT ALL CRITICAL GRADE POINTS ARE STAKED AND FOLLOWED TO PROVIDE POSITIVE DRAINAGE.
- ALL ELEVATIONS ARE BASED ON NC GRID NORTH (NAD 83 2011). THE CONTRACTOR SHALL USE NC ONE CALL (811) TO LOCATE ALL UNDERGROUND UTILITIES. PRIVATE UTILTIES SHALL BE LOCATED BY A PRIVATE LOCATE SERVICE AT THE EXPENSE OF THE CONTRACTOR. 10. INSTALL ALL STORM SEWERS TO PROVIDE REQUIRED CLEARANCES TO
- CROSSING UTILITIES AS INDICATED IN THE DRAWINGS AND SPECIFICATIONS. 1. PROVIDE HALF-BENCH CONCRETE INLET SHAPING FOR ALL CONCRETE
- STORM SEWER STRUCTURES. 12. ALL ROOF DRAINS FROM BUIDLING 'A' SHALL BE 8" PVC (SCH 40) @ 1.04% MIN. SLOPE UNLESS INDICATED OTHERWISE. ALL ROOF DRAINS FROM BUIDLING 'B', 'C', AND 'D', SHALL BE 6" PVC (SCH 40) @ 1.04% MIN. SLOPE UNLESS INDICATED OTHERWISE. USE DUCTILE IRON WHEN COVER IS LESS THAN 24-IN, MATCH PIPE CROWNS WITH CONNECTION TO DROP
- 13. PVC ROOF DRAIN PIPING UNDER PAVEMENT SHALL HAVE 24-IN MINIMUM COVER. IF ROOF DRAIN PIPING UNDER PAVEMENT HAS LESS THAN 24-IN COVER, ROOF DRAIN PIPING SHALL BE 8" DIP (IN LIEU OF PVC). 4. JOINT FILL AND CAULK EACH CONCRETE EXPANSION JOINT AND WHERE CONCRETE PAVEMENT ABUTS OTHER PAVEMENTS, SIDEWALKS, OR
- HARD SURFACES. . MAINTAIN ALL EROSION CONTROL DEVICES AFTER EACH RAINFALL EVENT IN ACCORDANCE WITH NCDEQ LAND QUALITY REQUIREMENTS
- AND AS DIRECTED BY THE NCDEQ AND CIVIL ENGINEER. FLUSH ALL SEDIMENT OUT OF STORM DRAINAGE PIPES AND STRUCTURES FOLLOWING SITE STABILIZATION AND AT THE END OF CONSTRUCTION. FLUSH OUT PIPES AS NEEDED THROUGHOUT CONSTRUCTION TO MAINTAIN PROPER FUNCTIONING OF THE DRAINAGE
- 7. IN DISTURBED AREAS, AMEND THE TOP 6 INCHES OF LAWN AREAS WITH
- TOPSOIL FROM THE SITE 18. ALL SIDEWALKS ARE TO HAVE NO MORE THAN A 1:20 (5.0%) SLOPE FOR THE LENGTH OF THE SIDEWALK AND NO MORE THAN A 1:50 (2.0%) SLOPE
- FOR THE WIDTH OF THE SIDEWALK. 9. IF CONTRACTOR NOTICES ANY DISCREPANCIES IN ANY OF THESE SLOPE REQUIREMENTS, IT IS THE CONTRACTOR'S RESPONSIBILITY TO
- CONTACT THE OWNER & ENGINEER PRIOR TO POURING ANY CONCRETE. 20. PRIOR TO FINAL PROJECT ACCEPTANCE, PROVIDE AN AS-BUILT SURVEY OF ALL UTILITY SYSTEMS AND STORM SEWERS.
- 21. ANY AND ALL LANDSCAPING AND EXISTING TREES & SHRUBS TO REMAIN WHICH ARE DAMAGED DURING DEMOLITION OR CONSTRUCTION SHALL BE REPLACED BY THE CONTRACTOR USING A LICENSED LANDSCAPE CONTRACTOR AT NO ADDITIONAL COST TO THE OWNER.


# **GRADING & DRAINAGE KEY NOTES**

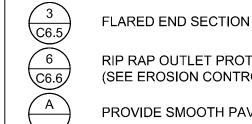

RIP RAP OUTLET PROTECTION (SEE EROSION CONTROL PLAN)

PROVIDE SMOOTH PAVING TRANSITION

DUST CONTROL

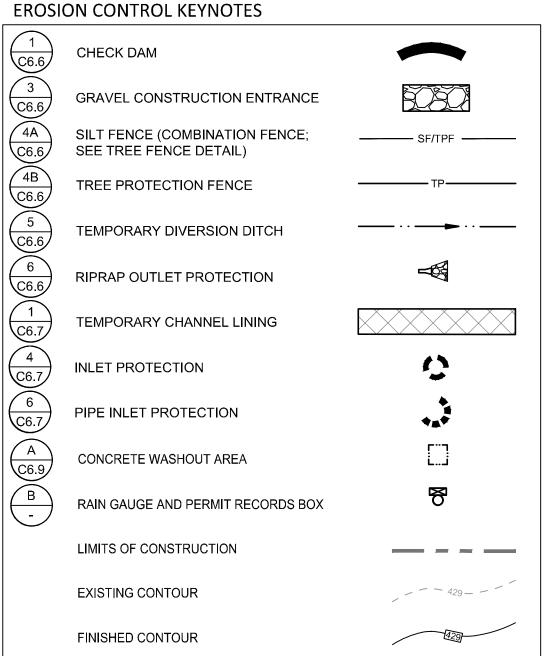

/DC\

DATE

04/05/2023 L. BARNES


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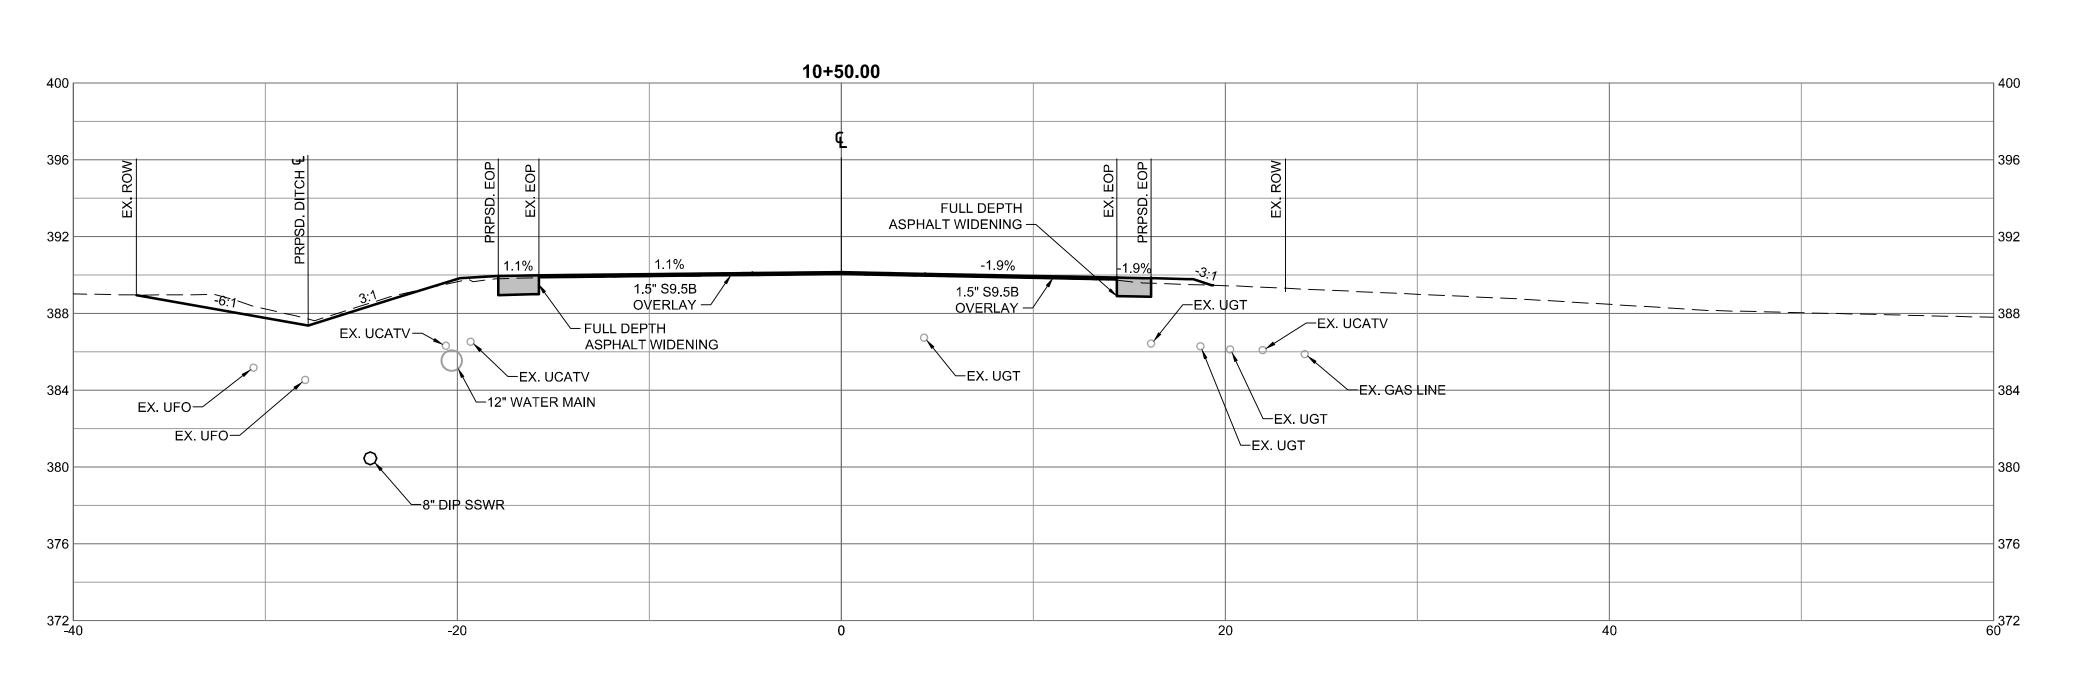
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SCALE AS SHOWN

SHEET NO.

*54832* C7.1



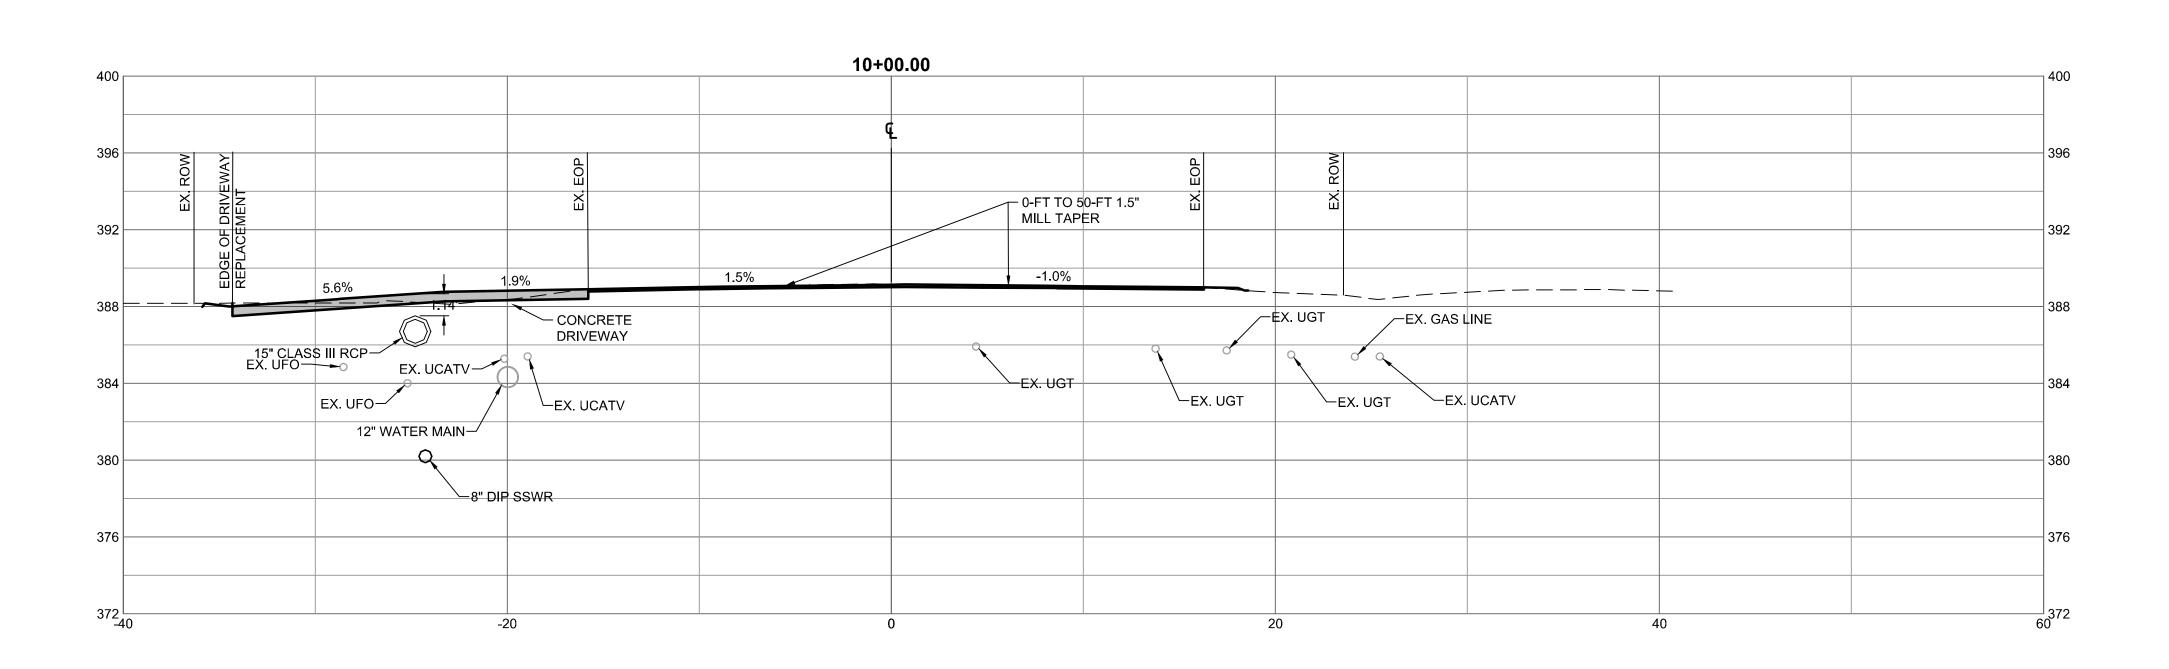

DETAIL SHOWING METHOD OF WEDGING

NOTE: MILL OR OVERLAY EXISTING PAVEMENT AS NECESSARY TO ACHIEVE REQUIRED CROSS SLOPE PER CROSS SECTIONS AND SUPERELEVATION TRANSITIONS, BUILD UP WITH ASPHALT CONCRETE INTERMEDIATE TYPE I19.0c AT VARIABLE DEPTH DEPENDING ON EXISTING CIRCUMSTANCES. REFER TO NCDOT ROAD DESIGN MANUAL FOR MINIMUM PAVEMENT LIFTS AND WEDGING REQUIREMENTS.


PAVEMENT SCHEDULE			
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W	PROP. VAR. DEPTH ASPHALT CONCRETE SURFACE COURSE, TYPE S9.5C.		
U	EXISTING PAVEMENT		



RALEIGH OFFICE 5410 Trinity Road, Suite 102   Raleigh, NC 27607 TEL 919.866.4951 FAX 919.833.8124 www.timmons.com	REVISION DESCRIPTION SED TOWN OF ROLESVILLE COMMENTS	SED TOWN OF ROLFSVILLE 2ND REVIEW COMMENTS
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REVISION	23   ADDRESSED TOWN OF ROLESVI	23   ADDRESSED TOWN OF ROLESVI	23   ADDRESSED TOWN OF ROLESVI	
DATE	06/01/2023	08/01/2023	11/01/2023	

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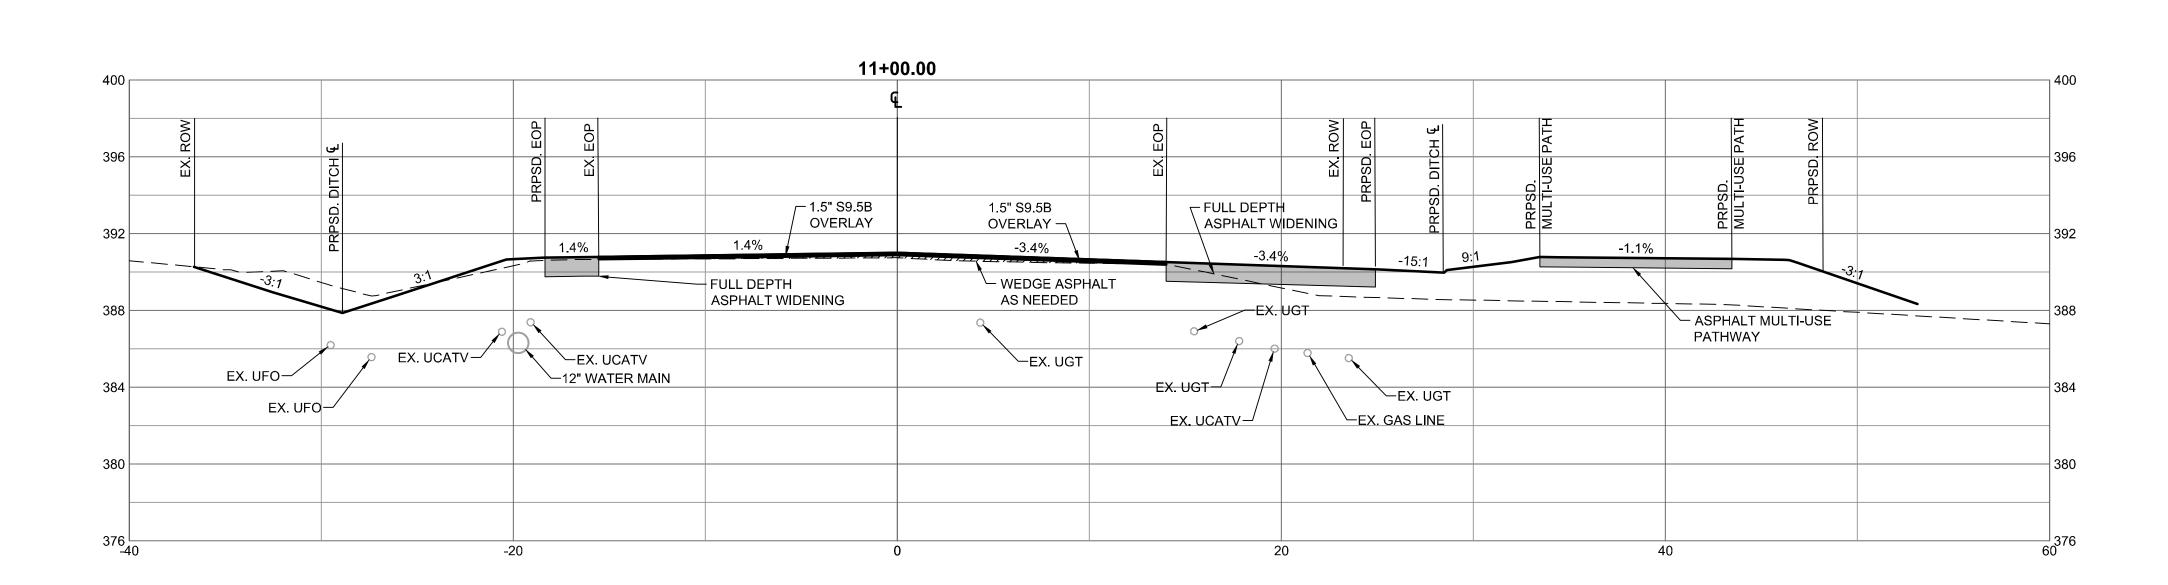
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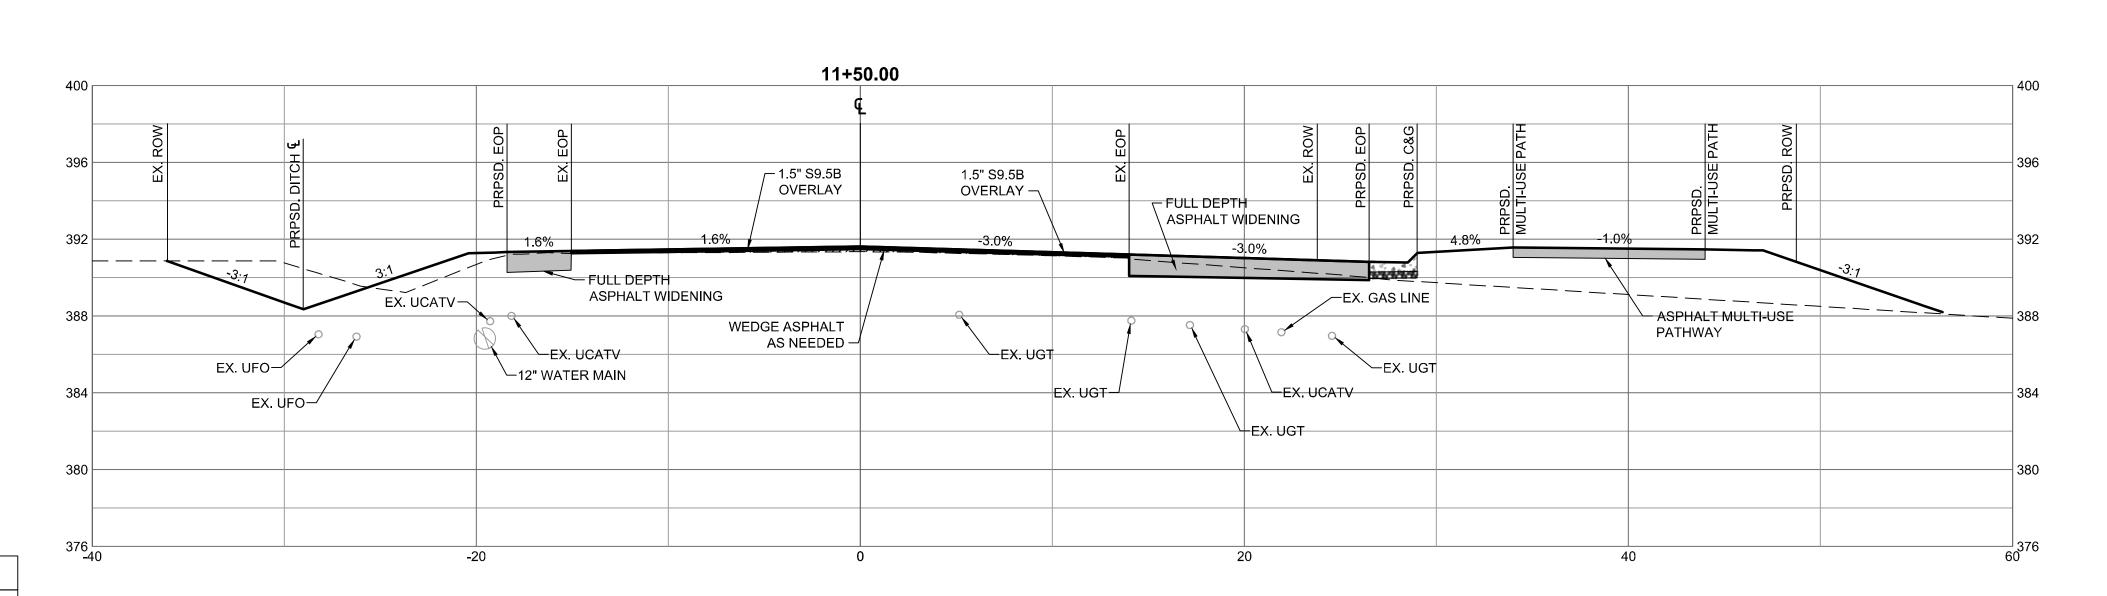
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JOB NO.

SECTION SCALE

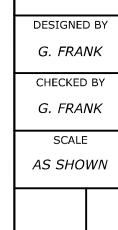*54832* SHEET NO.





C1 W C1

2½"

MIN.

W MIN.

DETAIL SHOWING METHOD OF WEDGING

NOTE: MILL OR OVERLAY EXISTING PAVEMENT AS NECESSARY TO ACHIEVE REQUIRED CROSS SLOPE PER CROSS SECTIONS AND SUPERELEVATION TRANSITIONS, BUILD UP WITH ASPHALT CONCRETE INTERMEDIATE TYPE 119.0c AT VARIABLE DEPTH DEPENDING ON EXISTING CIRCUMSTANCES. REFER TO NCDOT ROAD DESIGN MANUAL FOR MINIMUM PAVEMENT LIFTS AND WEDGING REQUIREMENTS.

	PAVEMENT SCHEDULE
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U	EXISTING PAVEMENT

SECTION SCALE

NORTH CAROLINA LICENSE
JONES DAIRY STORA

DATE 04/05/2023

DRAWN BY

L. BARNES

DESIGNED BY

G. FRANK


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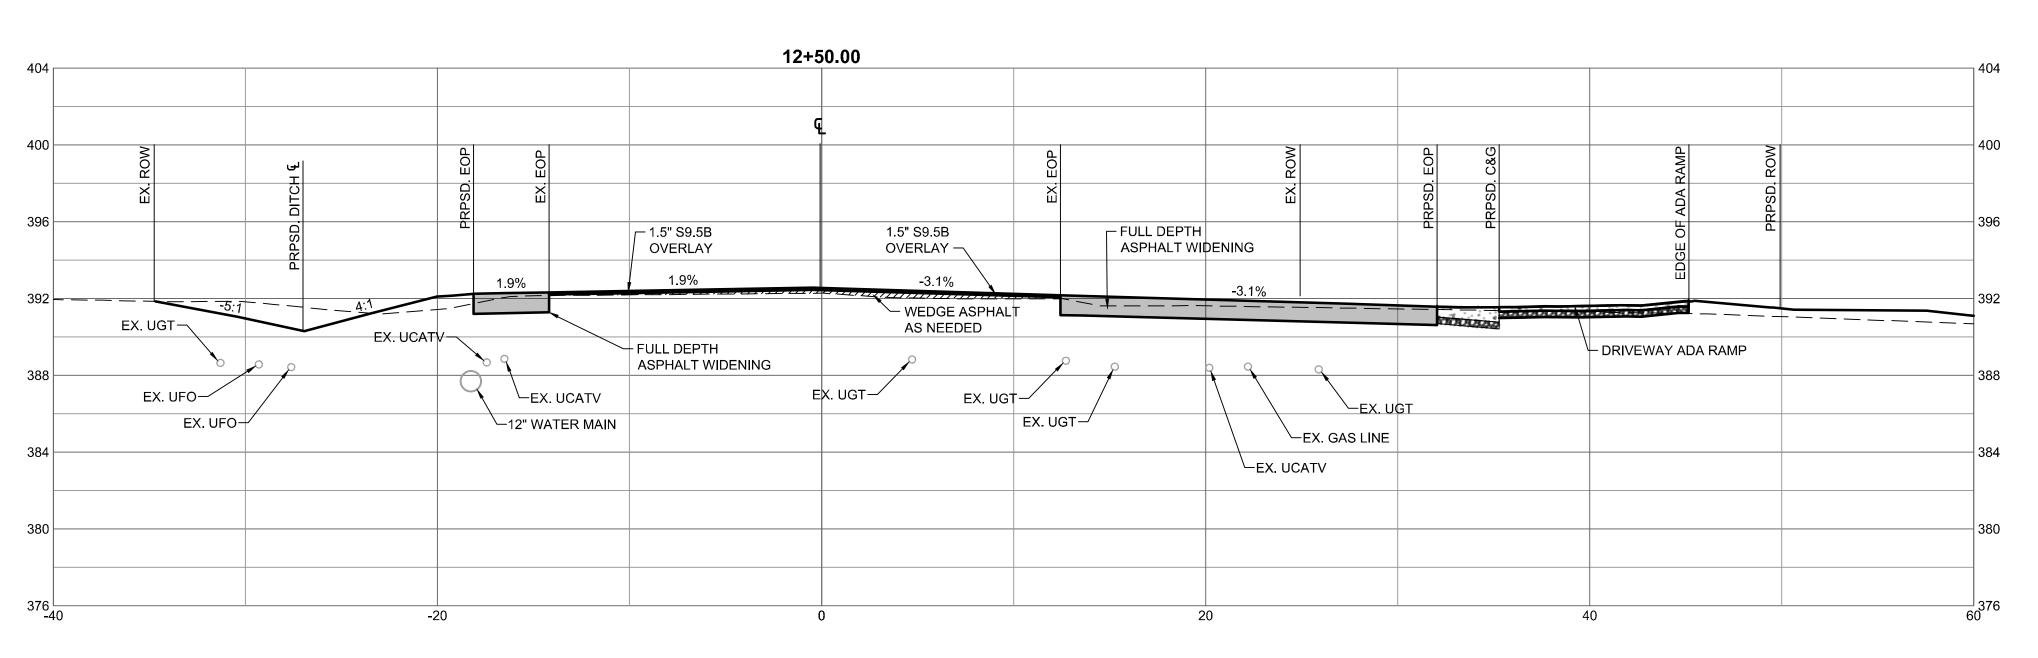
G. FRANK

SCALE

AS SHOWN

JOB NO.
54832
SHEET NO.
C7.3




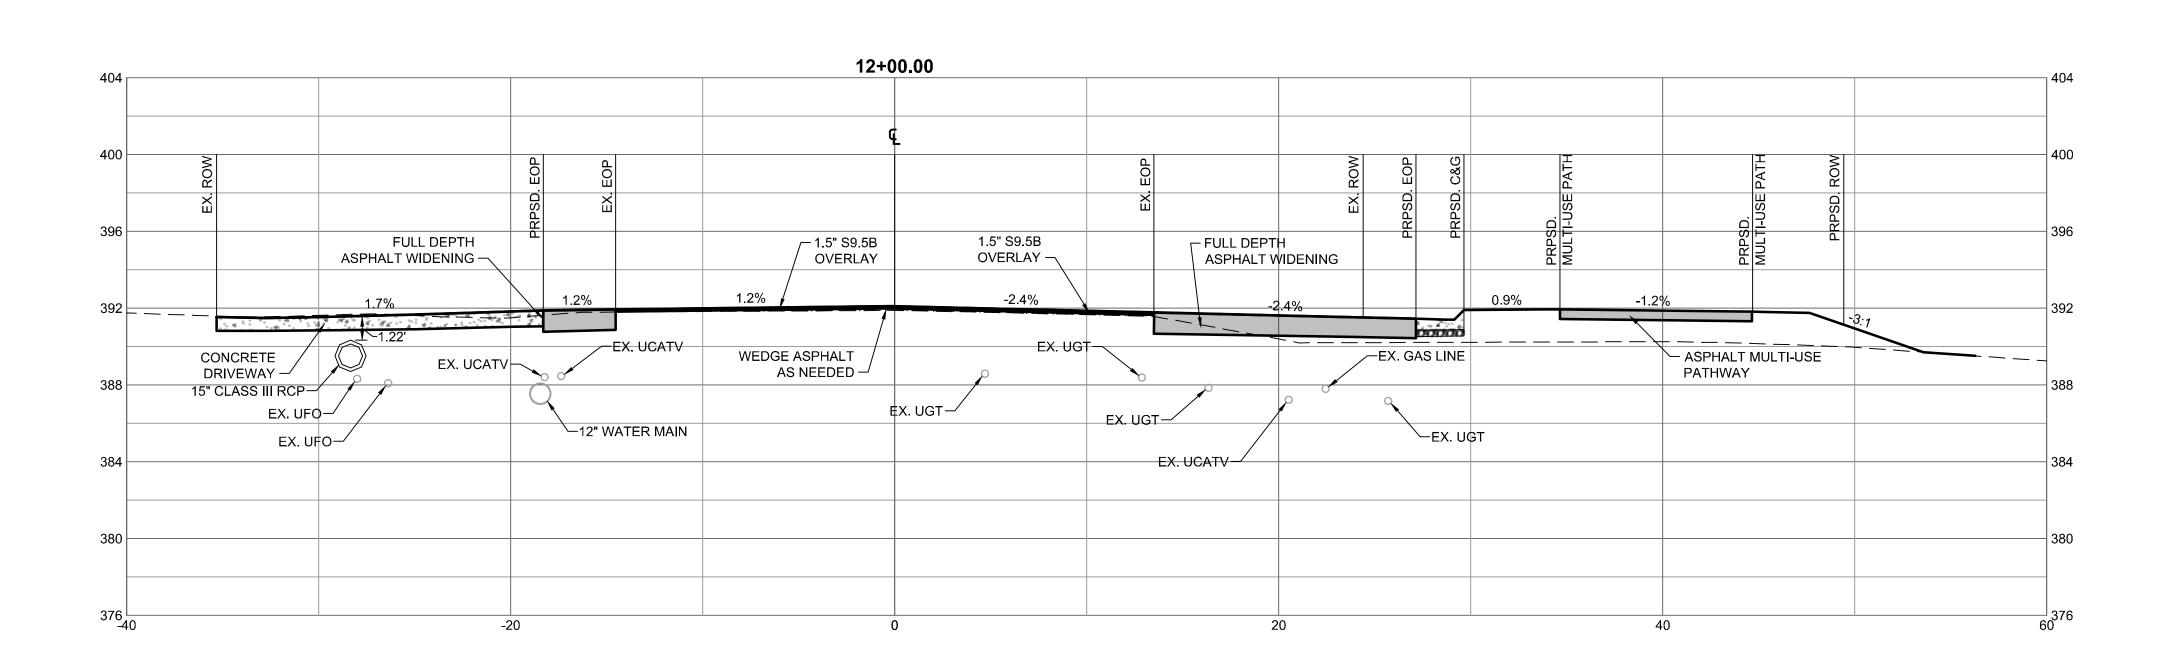

DETAIL SHOWING METHOD OF WEDGING

NOTE: MILL OR OVERLAY EXISTING PAVEMENT AS NECESSARY TO ACHIEVE REQUIRED CROSS SLOPE PER CROSS SECTIONS AND SUPERELEVATION TRANSITIONS, BUILD UP WITH ASPHALT CONCRETE INTERMEDIATE TYPE I19.0c AT VARIABLE DEPTH DEPENDING ON EXISTING CIRCUMSTANCES. REFER TO NCDOT ROAD DESIGN MANUAL FOR MINIMUM PAVEMENT LIFTS AND WEDGING REQUIREMENTS.

PAVEMENT SCHEDULE		
C1	PROP. APPROX. 1.5" ASPHALT CONCRETE SURFACE COURSE, TYPE S9.5C.	
W	PROP. VAR. DEPTH ASPHALT CONCRETE SURFACE COURSE, TYPE S9.5C.	
U	EXISTING PAVEMENT	

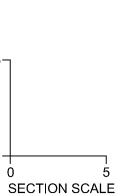


04/05/2023 DRAWN BY L. BARNES DESIGNED BY


G. FRANK CHECKED BY G. FRANK SCALE

AS SHOWN

JOB NO.

*54832* SHEET NO. C7.4

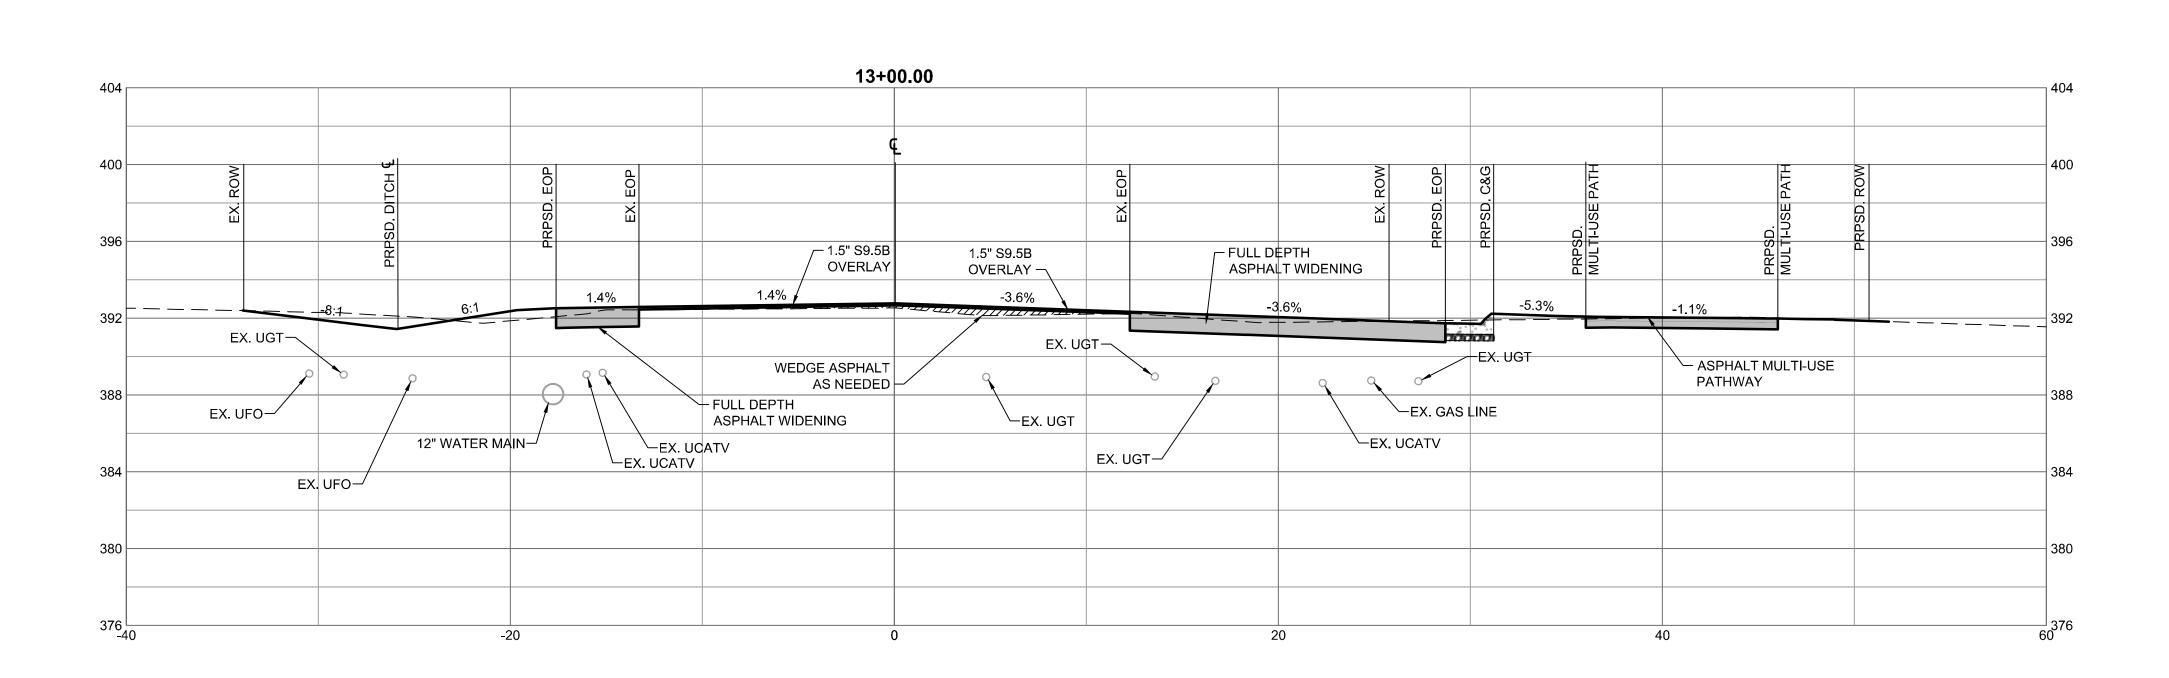


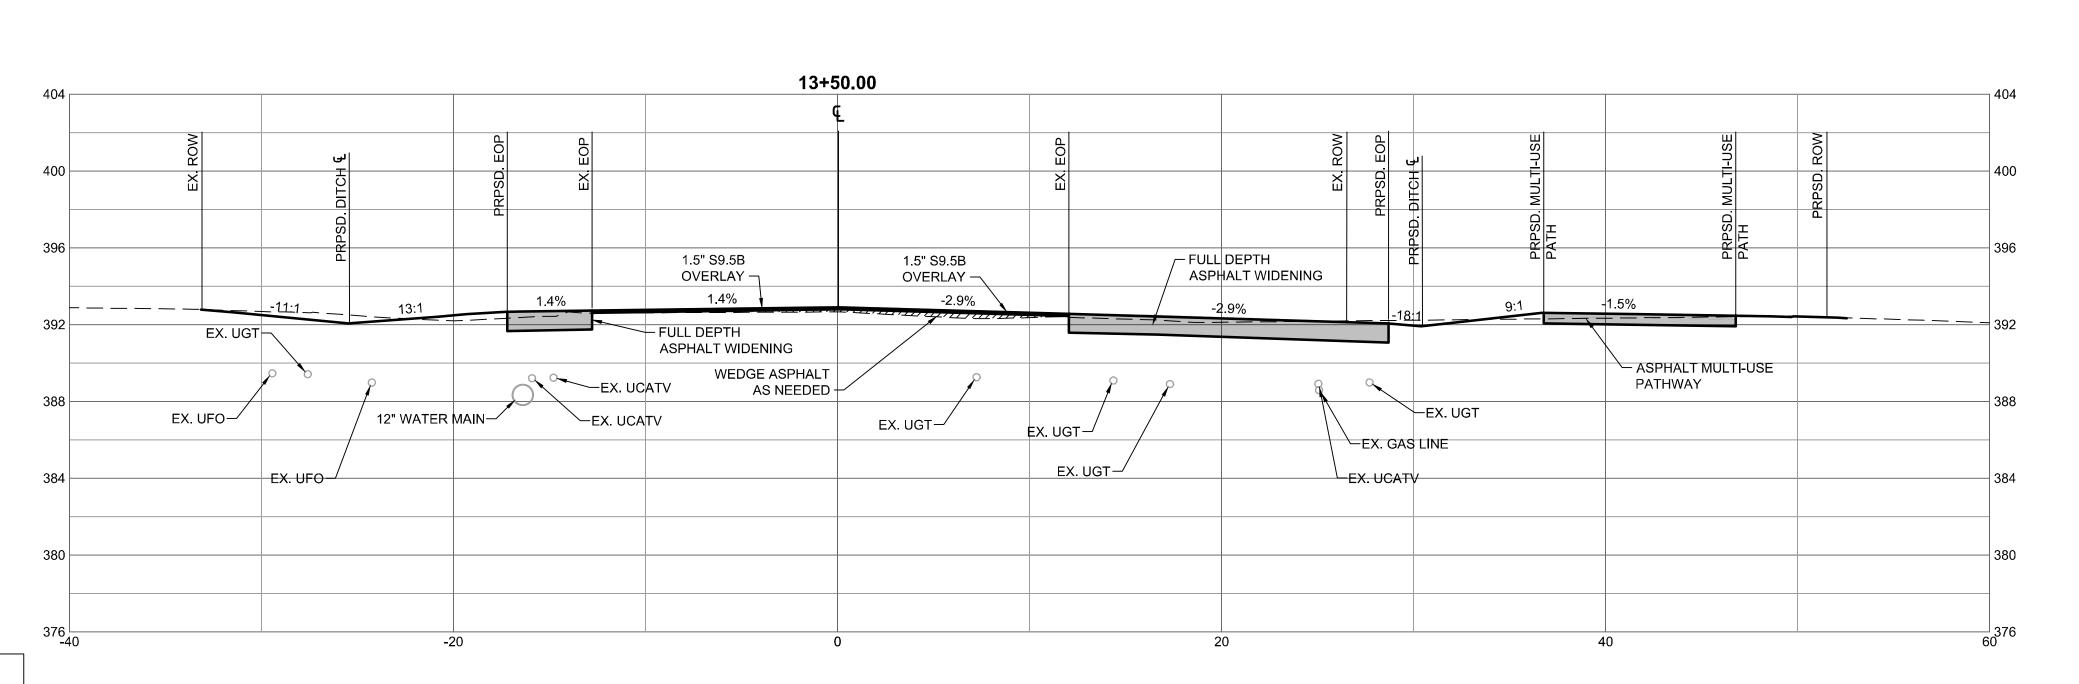

DETAIL SHOWING METHOD OF WEDGING

NOTE: MILL OR OVERLAY EXISTING PAVEMENT AS NECESSARY TO ACHIEVE REQUIRED CROSS SLOPE PER CROSS SECTIONS AND SUPERELEVATION TRANSITIONS, BUILD UP WITH ASPHALT CONCRETE INTERMEDIATE TYPE I19.0c AT VARIABLE DEPTH DEPENDING ON EXISTING CIRCUMSTANCES. REFER TO NCDOT ROAD DESIGN MANUAL FOR MINIMUM PAVEMENT LIFTS AND WEDGING REQUIREMENTS.

PAVEMENT SCHEDULE		
C1	PROP. APPROX. 1.5" ASPHALT CONCRETE SURFACE COURSE, TYPE S9.5C.	
W	PROP. VAR. DEPTH ASPHALT CONCRETE SURFACE COURSE, TYPE S9.5C.	
U	EXISTING PAVEMENT	

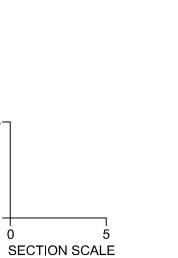



04/05/2023 DRAWN BY L. BARNES

DESIGNED BY G. FRANK CHECKED BY G. FRANK SCALE

AS SHOWN

JOB NO. *54832* SHEET NO. C7.5

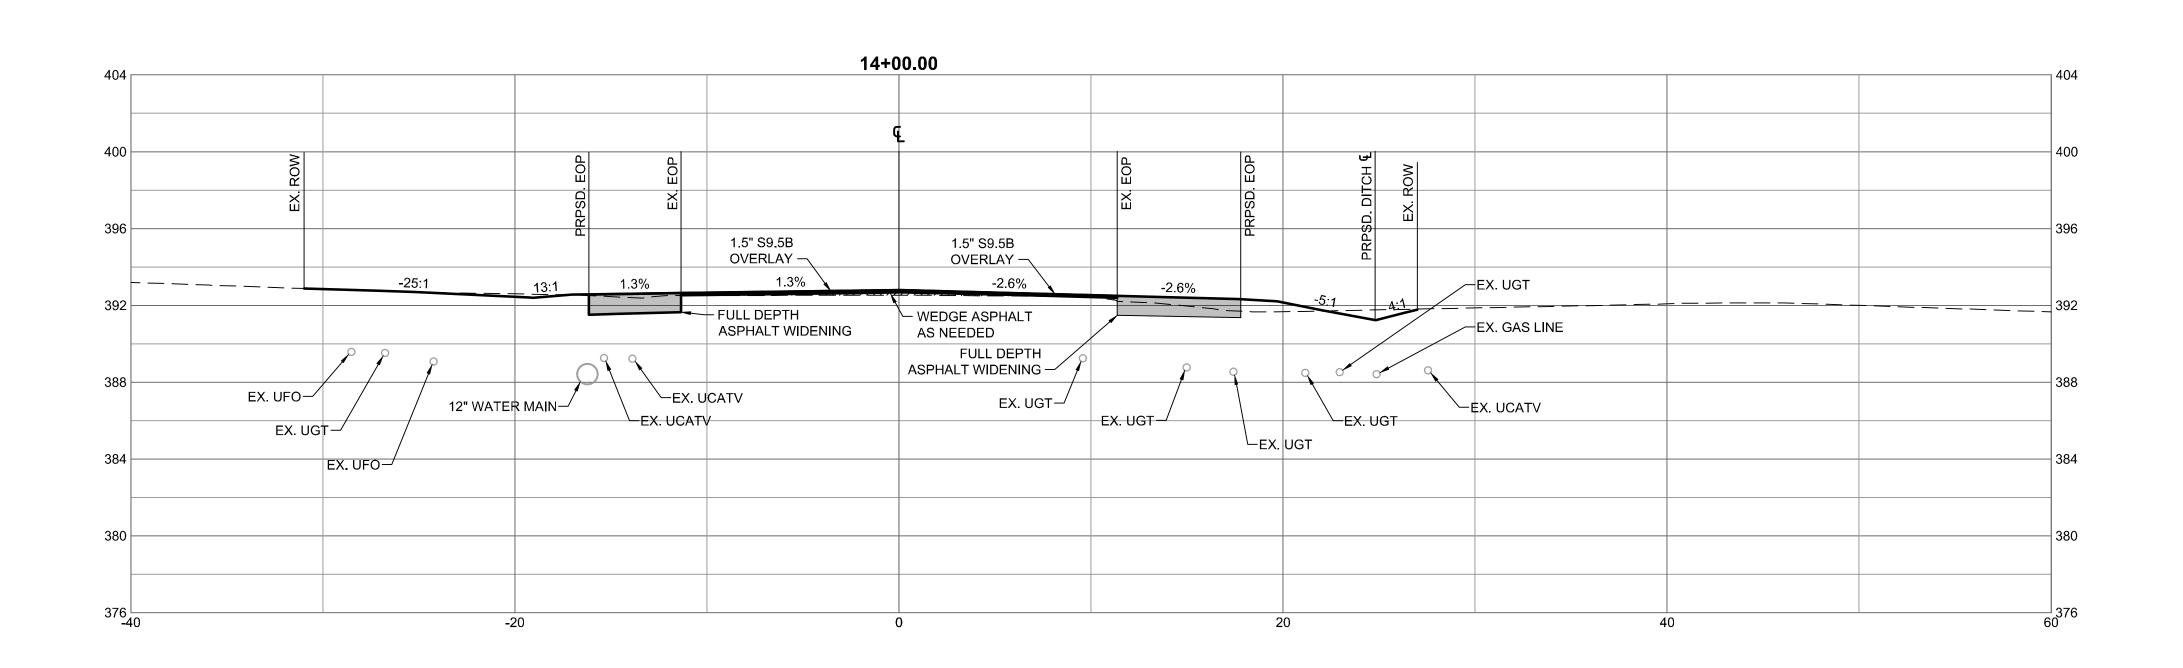

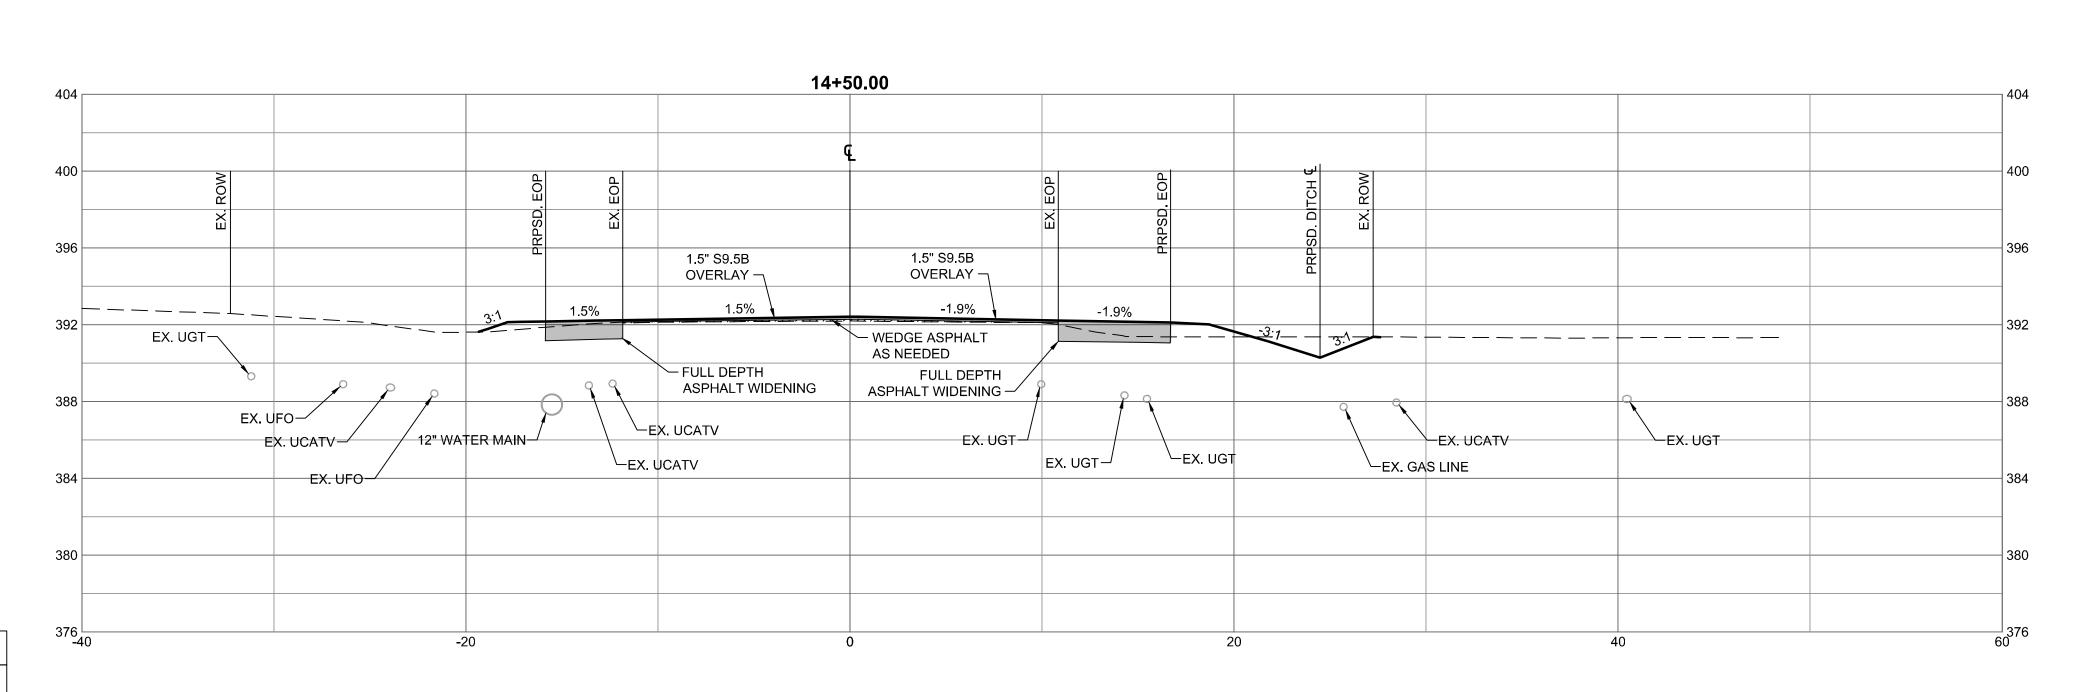

DETAIL SHOWING METHOD OF WEDGING

NOTE: MILL OR OVERLAY EXISTING PAVEMENT AS NECESSARY TO ACHIEVE REQUIRED CROSS SLOPE PER CROSS SECTIONS AND SUPERELEVATION TRANSITIONS, BUILD UP WITH ASPHALT CONCRETE INTERMEDIATE TYPE I19.0c AT VARIABLE DEPTH DEPENDING ON EXISTING CIRCUMSTANCES. REFER TO NCDOT ROAD DESIGN MANUAL FOR MINIMUM PAVEMENT

LIFTS AND WEDGING REQUIREMENTS.

	PAVEMENT SCHEDULE
C1	PROP. APPROX. 1.5" ASPHALT CONCRETE SURFACE COURSE, TYPE S9.5C.
W	PROP. VAR. DEPTH ASPHALT CONCRETE SURFACE COURSE, TYPE S9.5C.
U	EXISTING PAVEMENT



SECTION SCALE


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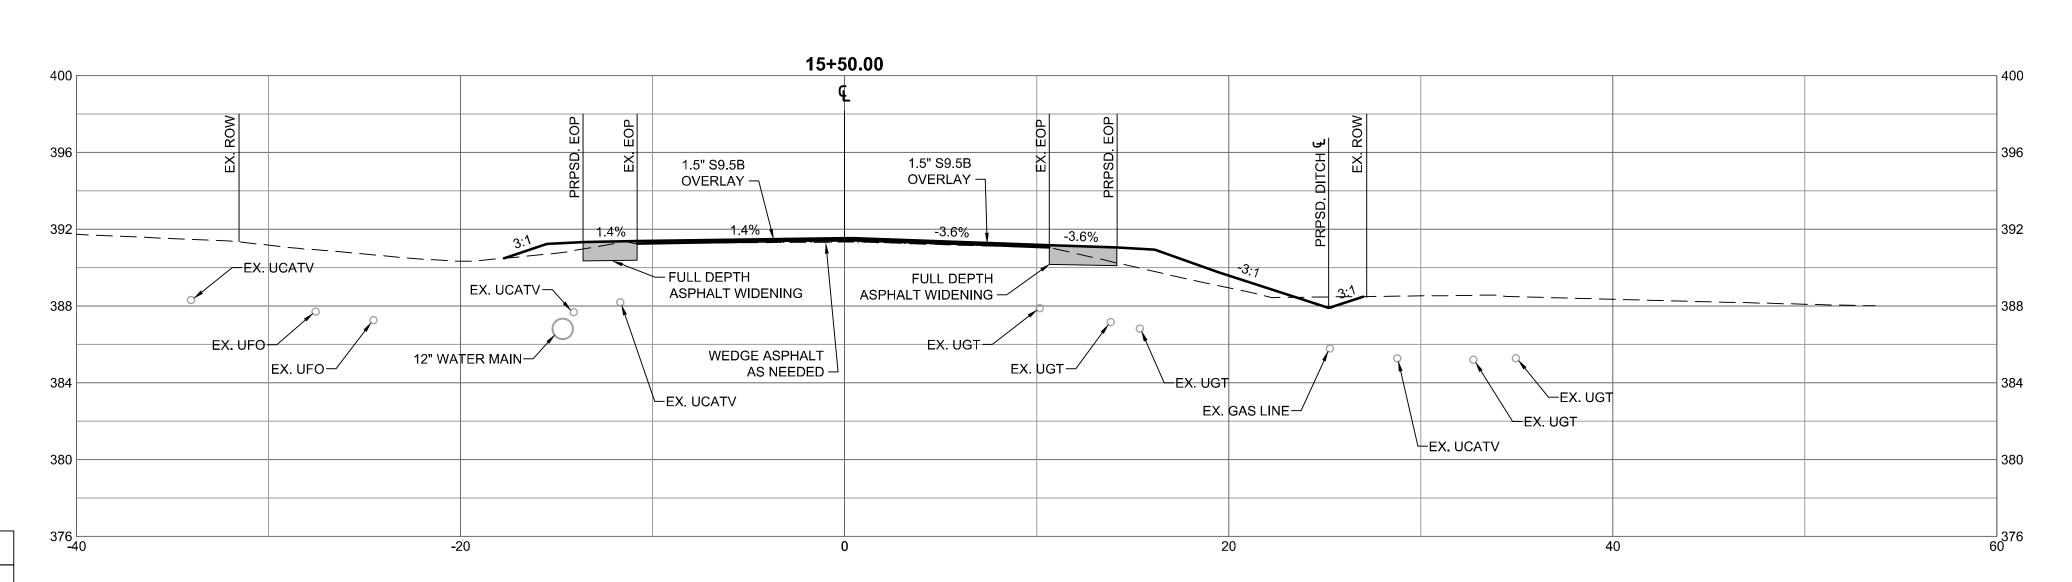
DRAWN BY L. BARNES DESIGNED BY

G. FRANK G. FRANK SCALE

CHECKED BY AS SHOWN

*54832* SHEET NO. C7.6




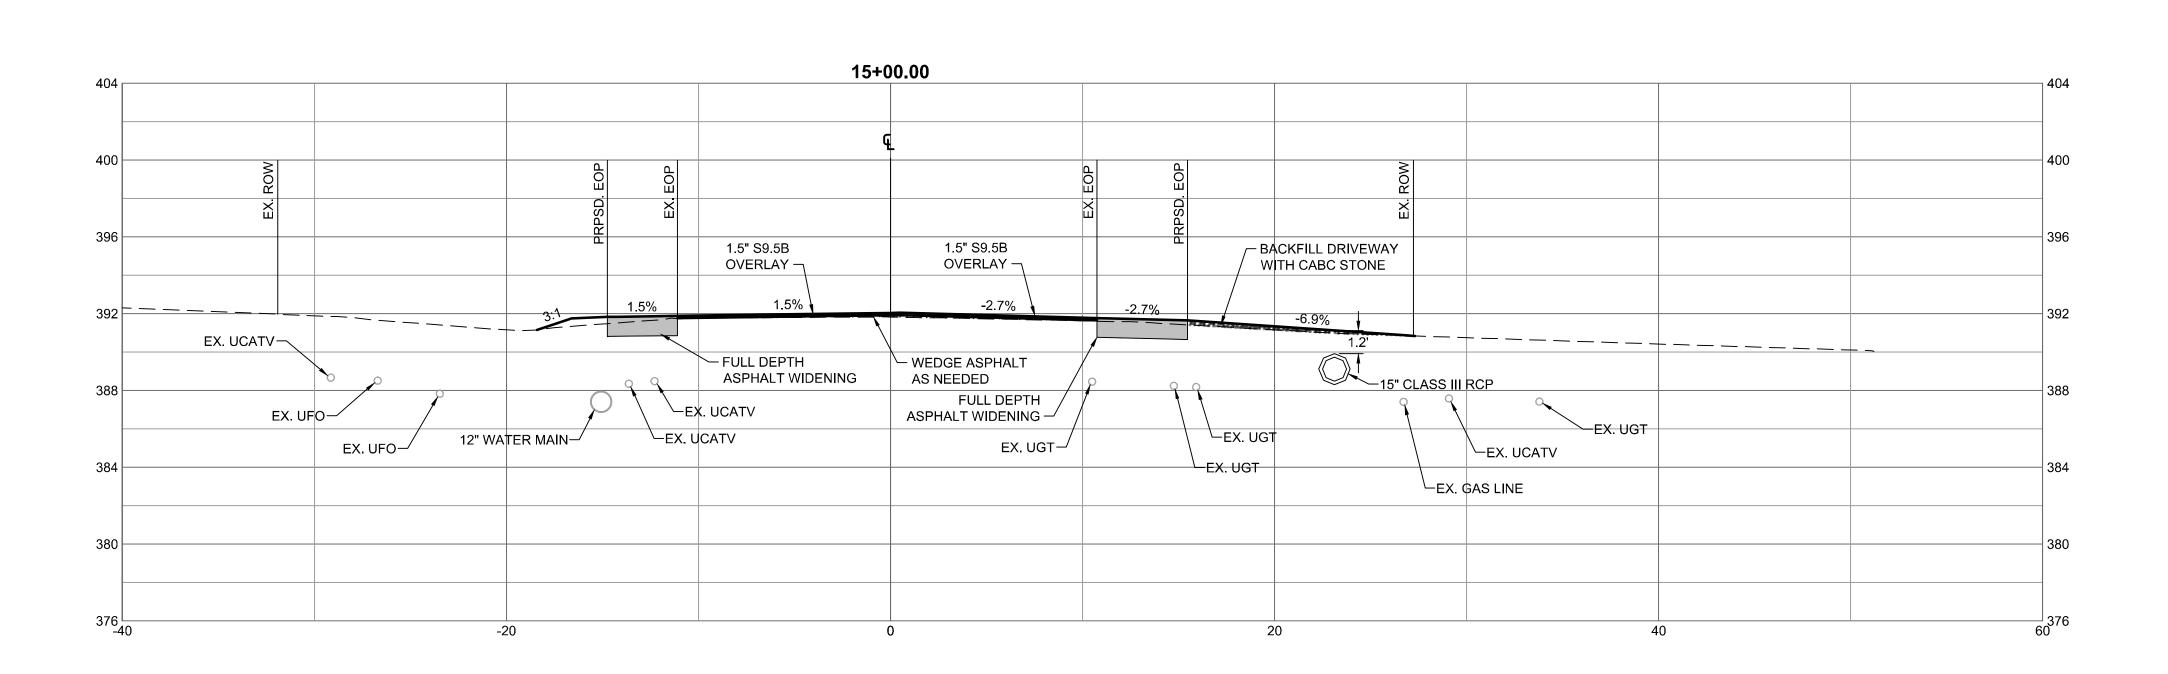

DETAIL SHOWING METHOD OF WEDGING

NOTE: MILL OR OVERLAY EXISTING PAVEMENT AS NECESSARY TO ACHIEVE REQUIRED CROSS SLOPE PER CROSS SECTIONS AND SUPERELEVATION TRANSITIONS, BUILD UP WITH ASPHALT CONCRETE INTERMEDIATE TYPE I19.0c AT VARIABLE DEPTH DEPENDING ON EXISTING CIRCUMSTANCES. REFER TO NCDOT ROAD DESIGN MANUAL FOR MINIMUM PAVEMENT LIFTS AND WEDGING REQUIREMENTS.

PAVEMENT SCHEDULE		
C1	PROP. APPROX. 1.5" ASPHALT CONCRETE SURFACE COURSE, TYPE S9.5C.	
W	PROP. VAR. DEPTH ASPHALT CONCRETE SURFACE COURSE, TYPE S9.5C.	
U	EXISTING PAVEMENT	

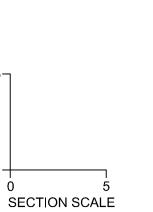

RALEIGH OFFICE	5410 Trinity Road, Suite 102   Raleigh, NC 27607	TEL 919.866.4951 FAX 919.833.8124 www.timmons.com	REVISION DESCRIPTION	O TOWN OF ROLESVILLE COMMENTS	) TOWN OF ROLESVILLE 2ND REVIEW COMMENTS
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DRAWN BY
L. BARNES
DESIGNED BY
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CHECKED BY
G. FRANK
SCALE
AS SHOWN


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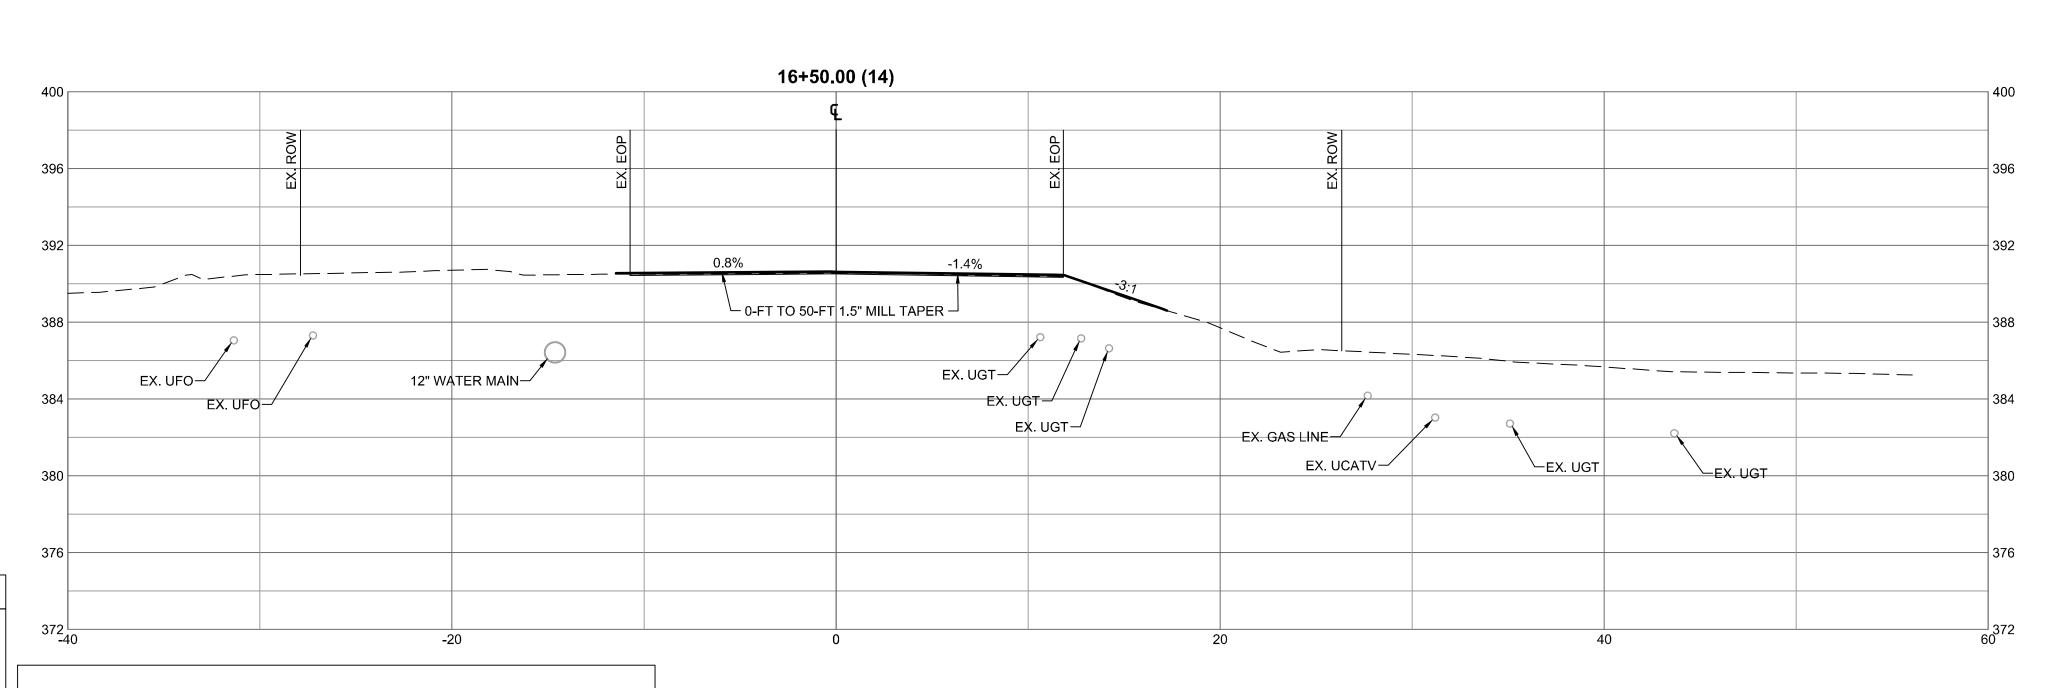
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JOB NO. *54832* SHEET NO. C7.7





DETAIL SHOWING METHOD OF WEDGING

NOTE: MILL OR OVERLAY EXISTING PAVEMENT AS NECESSARY TO ACHIEVE REQUIRED CROSS SLOPE PER CROSS SECTIONS AND SUPERELEVATION TRANSITIONS, BUILD UP WITH ASPHALT CONCRETE INTERMEDIATE TYPE I19.0c AT VARIABLE DEPTH DEPENDING ON EXISTING CIRCUMSTANCES. REFER TO NCDOT ROAD DESIGN MANUAL FOR MINIMUM PAVEMENT LIFTS AND WEDGING REQUIREMENTS.

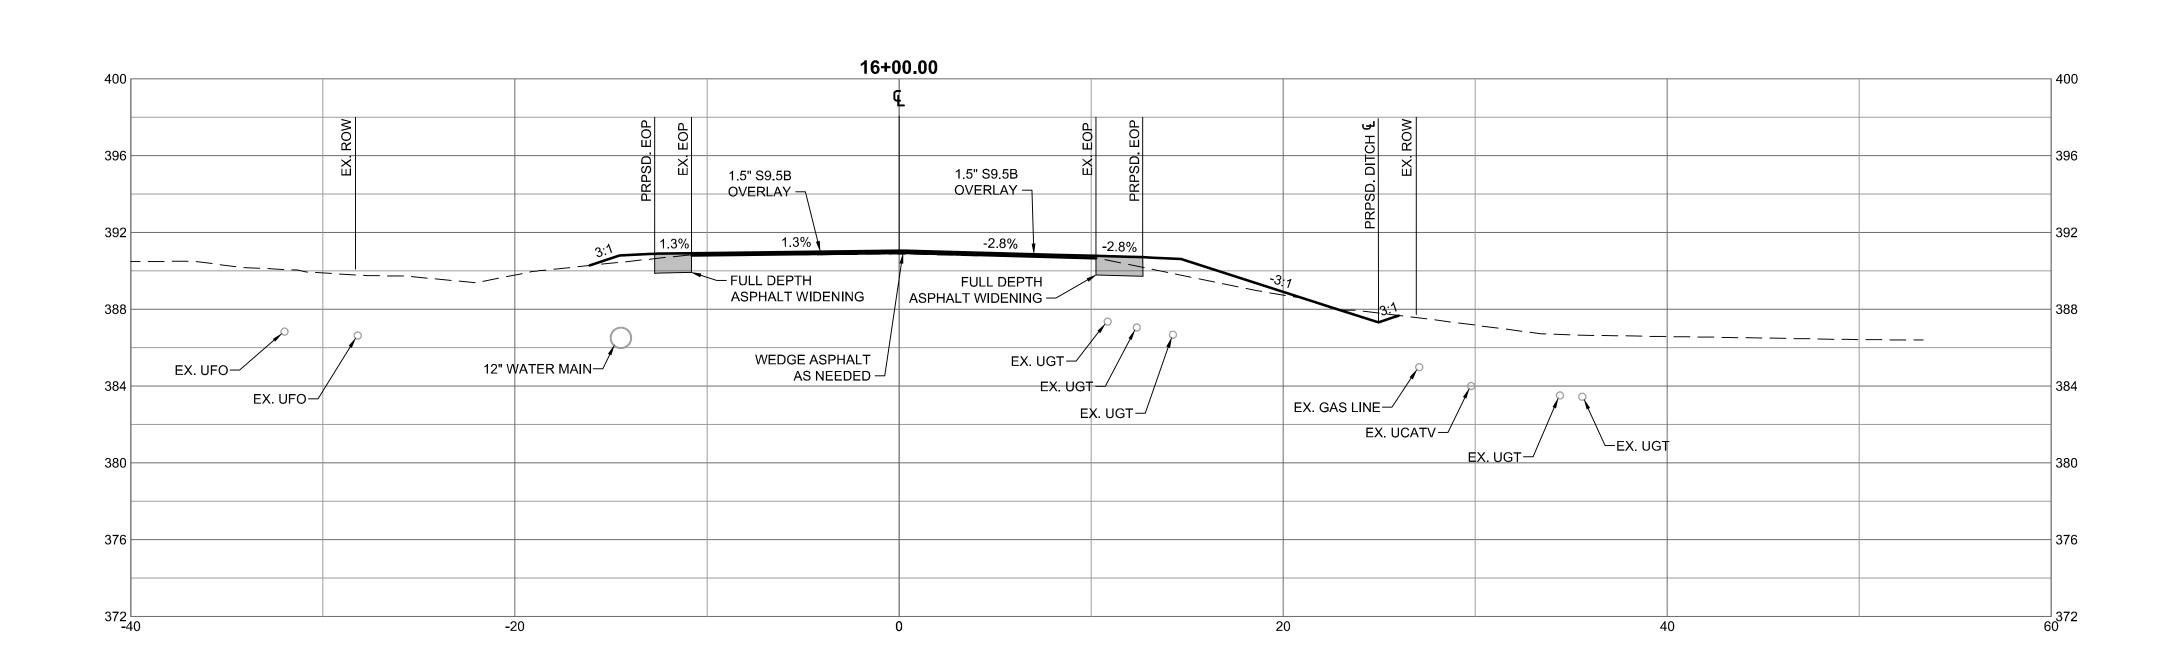PROP. APPROX. 1.5" ASPHALT CONCRETE SURFACE COURSE, TYPE S9.5C. PROP. VAR. DEPTH ASPHALT CONCRETE SURFACE COURSE, TYPE S9.5C.

PAVEMENT SCHEDULE

EXISTING PAVEMENT

SECTION SCALE


04/05/2023 DRAWN BY L. BARNES DESIGNED BY

G. FRANK CHECKED BY G. FRANK

SCALE

AS SHOWN

*54832* SHEET NO. C7.8

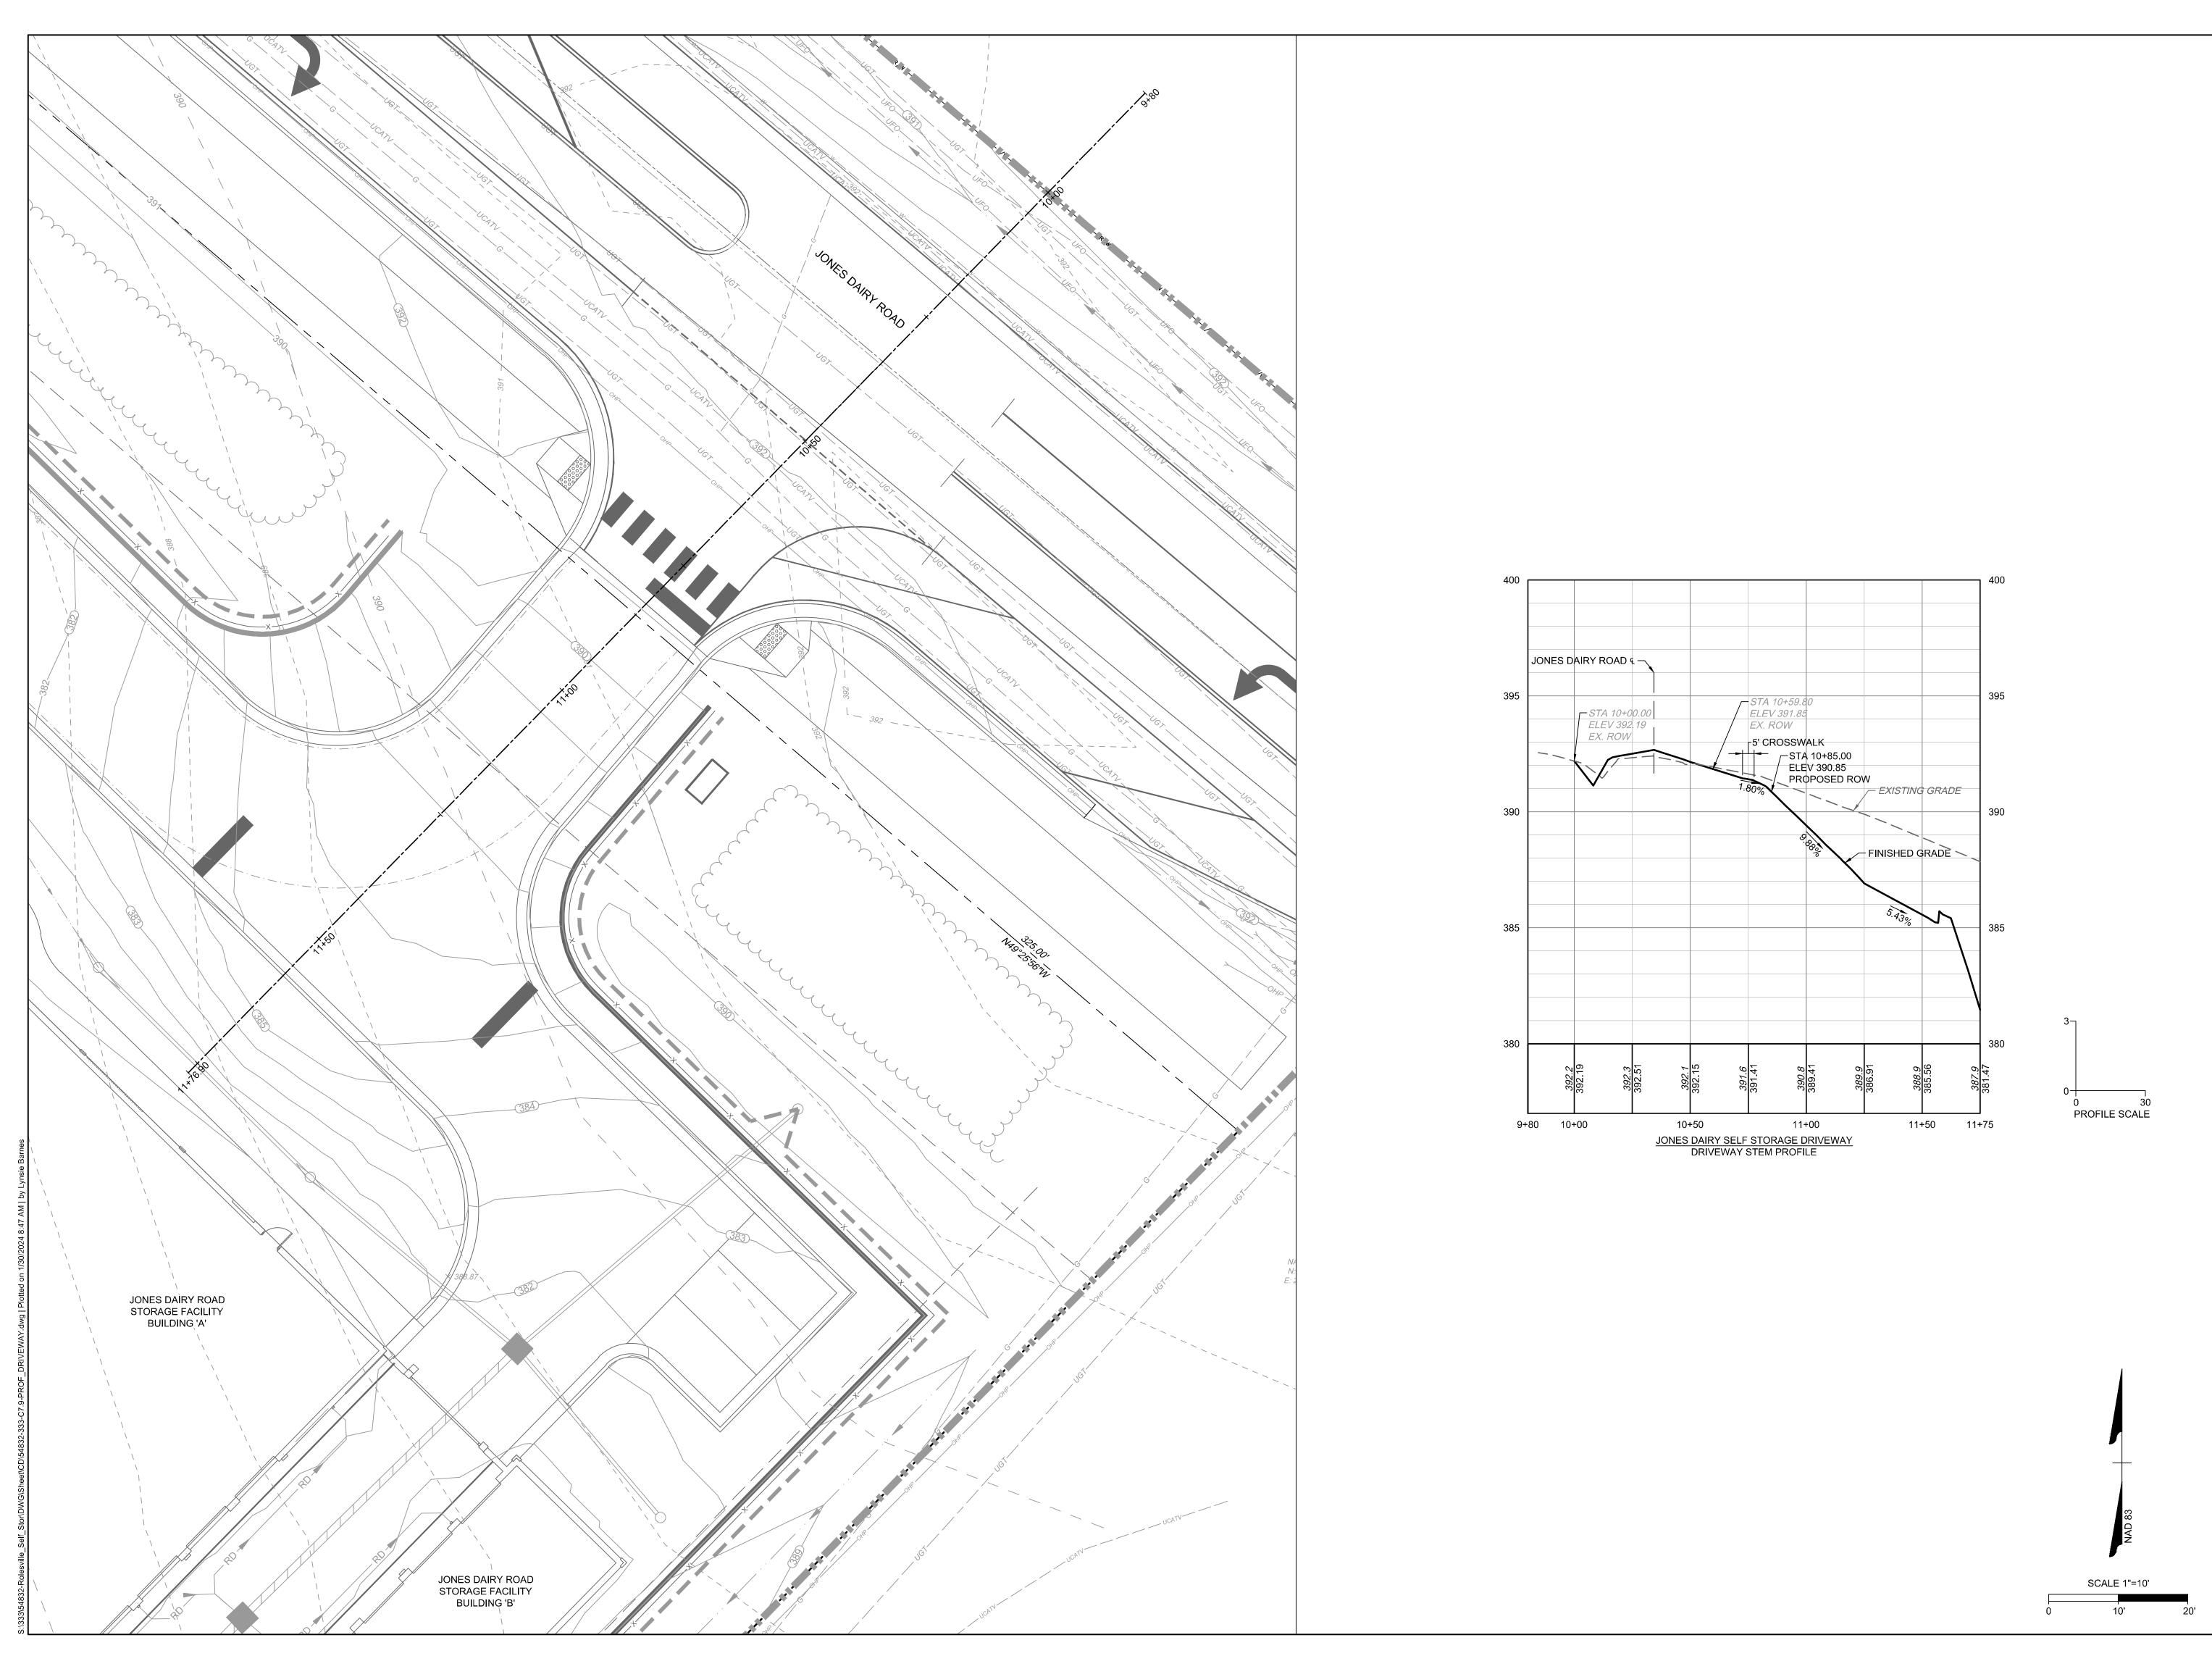



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CHECKED BY G. FRANK

AS SHOWN

JOB NO. *54832* SHEET NO. C7.9