
V3 rcvd 6-7-2024

PRESTLEIGH AT JONES DAIRY

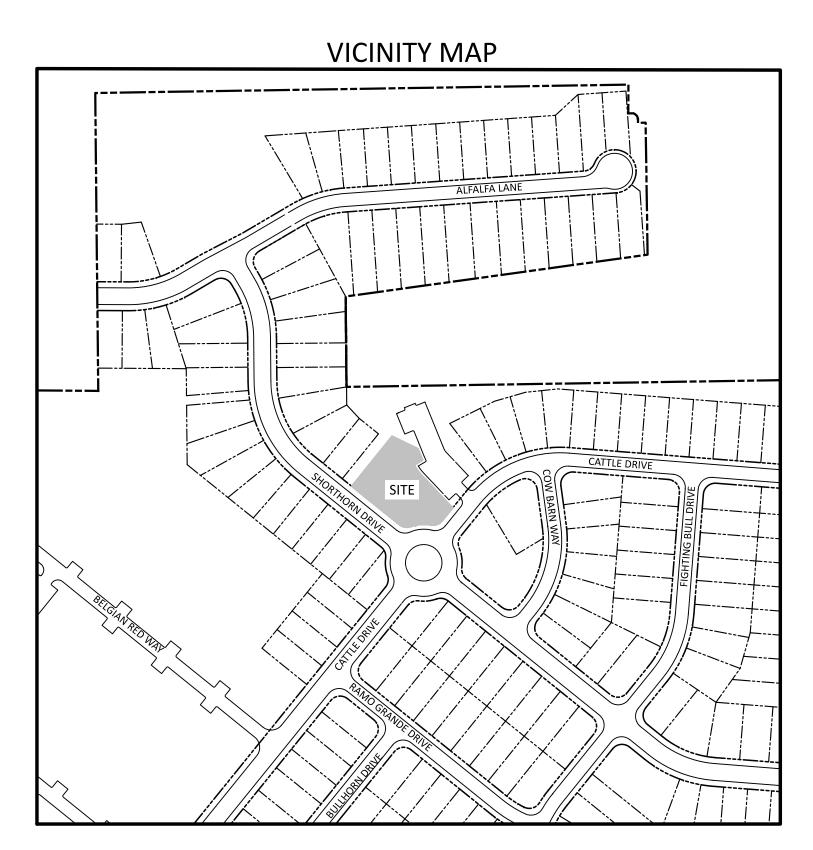

SCALE: 1" = 200'

SITE DEVELOPMENT PLAN **AMENITY CENTER ACTIVE OPEN SPACE #2** B.M. 2023, PG. 2190

1001 CATTLE DRIVE ROLESVILLE, NC PROJECT ID NO: SDP-24-02

FEBRUARY 29, 2024 REVISED: APRIL 29, 2024 REVISED: JUNE 7, 2024

OWNER/DEVELOPER

PRESERVE AT JONES DAIRY, LLC 10534 ARNOLD PALMER DRIVE RALEIGH, NC 27617 919-491-0761

PROPOSED SITE DATA - AMENITY CENTER			
LOT AREA	55,288 SF (1.27 AC)		
SETBACKS			
FRONT AND REAR:	25'		
SIDE:	5'		
CORNER:	10'		
DISTURBED AREA	27,589 SF (0.63 AC)		
BUILDING AREA	788 SF		
NUMBER OF STORIES	1 STORY		
IMPERVIOUS AREA	9,376 SF		
PROPOSED USE	AMENITY CENTER (POOL HOUSE AND POOL)		

SITE DATA - SUBDIVISION			
ZONING		R & PUD	
EXISTING SITE AREA		88.59 ACRES (3,859,005 SF)	
R/W DEDICATION		0.78 ACRES (34,140 SF) JONES DAIRY ROAD	
OTHER DEDICATIONS		0.15 ACRES (6,824 SF) AVERETTE ROAD SIDEWALK	
PROPOSED NET SITE	AREA	87.66 ACRES (3,818,041 SF)	
PROPOSED USE		SINGLE FAMILY AND TOWNHOME UNITS	
SINGLE FAMILY UNIT	ΓS	260 UNITS	
TOWNHOME UNITS		179 UNITS	
TOTALS UNITS		439 UNITS	
SINGLE FAMILY AREA (GROSS)		68.52 ACRES (2,984,678 SF)	
TOWNHOME AREA (GROSS)	20.07 ACRES (874,327 SF)	
DENSITY			
SINGLE FAMILY	260 UNIT	S/68.52 ACRES = 3.79 UNITS/ACRE	
TOWNHOME	179 UNITS/20.07 ACRES = 8.92 UNITS/ACRE		
CENTRAL	439 UNITS/88.59 ACRES = 4.96 UNITS/ACRE		

SHEET INDEX			
SHEET NO.	SHEET NAME	MOST CURRENT REVISION DATE	
C1.0	EXISTING CONDITIONS PLAN	06/07/2024	
C2.0	SITE PLAN	06/07/2024	
C3.0	UTILITY PLAN	06/07/2024	
C4.0	GRADING AND EROSION CONTROL PLAN	06/07/2024	
L1.0	LANDSCAPE PLAN	06/07/2024	
D1.0	SITE DETAILS	06/07/2024	
	PLANS BY OTHERS		
SHEET NO.	SHEET NAME	MOST CURRENT REVISION DATE	
A0.1	BATHHOUSE FLOORPLAN	2/29/2024	
A0.2	BATHHOUSE BUILDING ELEVATIONS	2/29/2024	

PRESERVE AT JONES DAIRY - CENTRAI

PARCEL PINS: 1759992822

1850906787 1769094682

STORMWATER MANAGEMENT CALCULATIONS PREVIOUSLY PROVIDED AS PART OF PRESERVE AT JONES DAIRY - CENTRAL

ALL CONSTRUCTION SHALL BE IN

ACCORDANCE WITH TOWN OF

THE PROJECT IS NOT LOCATED IN A WATERSUPPLY WATERSHED PROTECTION OVERLAY DISTRICT. THE PROJECT DOES NOT CONTAIN SPECIAL FLOOD HAZARD AREAS.



SDP-24-02 Prestleigh at Jones Dairy Amenity

Town of Rolesville Planning Department



The Nau Company Consulting Civil Engineers

PO Box 810 Rolesville, NC 27571 919-435-6395


THE PLANS KEPT ON FILE WITH THE CITY. THIS ELECTRONIC APPROVAL MAY NOT BE EDITED ONCE ISSUED.


ANY MODIFICATION TO THIS APPROVAL ONCE ISSUED WILL INVALIDATE THIS APPROVAL. CITY OF RALEIGH DEVELOPMENT APPROVAL RALEIGH WATER REVIEW OFFICER


CITY OF RALEIGH - PLANS AUTHORIZED FOR CONSTRUCTION ELECTRONIC APPROVAL: THIS APPROVAL IS BEING ISSUED ELECTRONICALLY. THIS APPROVAL IS VALID ONLY UPON THE SIGNATURE OF A CITY OF RALEIGH REVIEW OFFICER BELOW. THE CITY WILL RETAIN A COPY OF THE APPROVED PLANS. ANY WORK AUTHORIZED BY THIS APPROVAL MUST PROCEED IN ACCORDANCE WITH

TOWN OF ROLESVILLE PROJECT IDENTIFICATION # SDP-24-02

ROLESVILLE STANDARDS AND **NCBELS License P-0751** SPECIFICATIONS PRELIMINARY DRAWING - NOT RELEASED FOR CONSTRUCTION

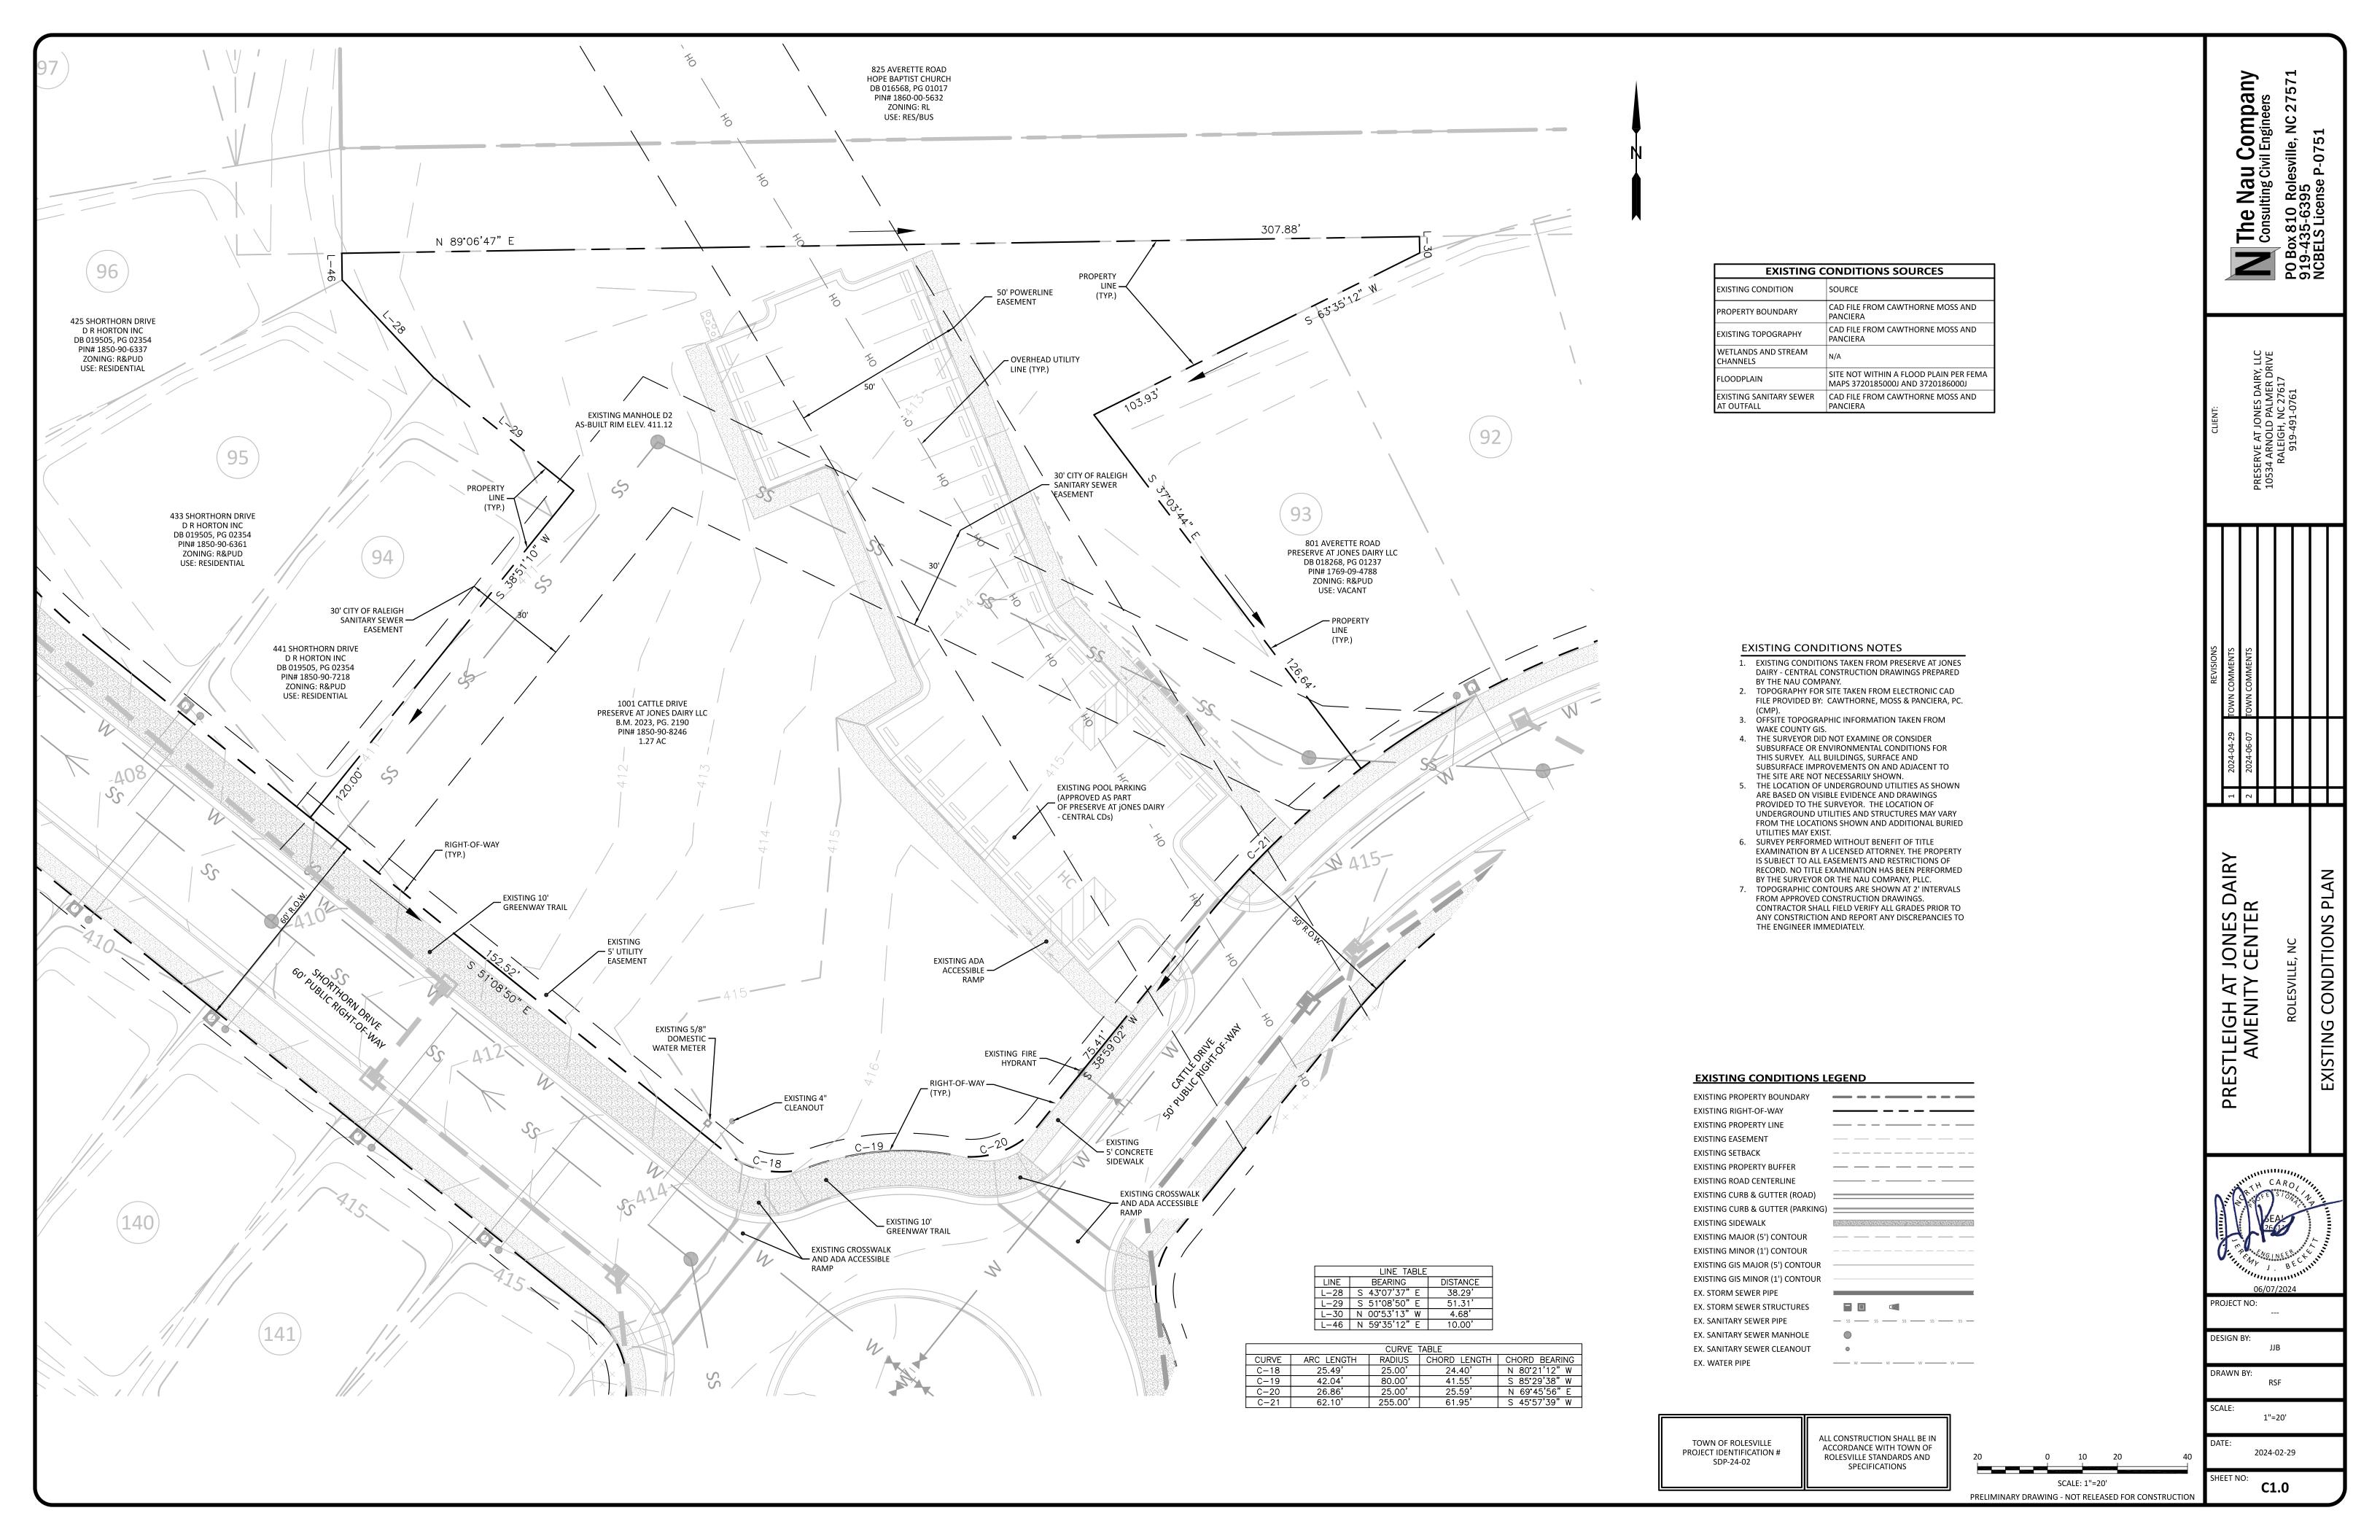

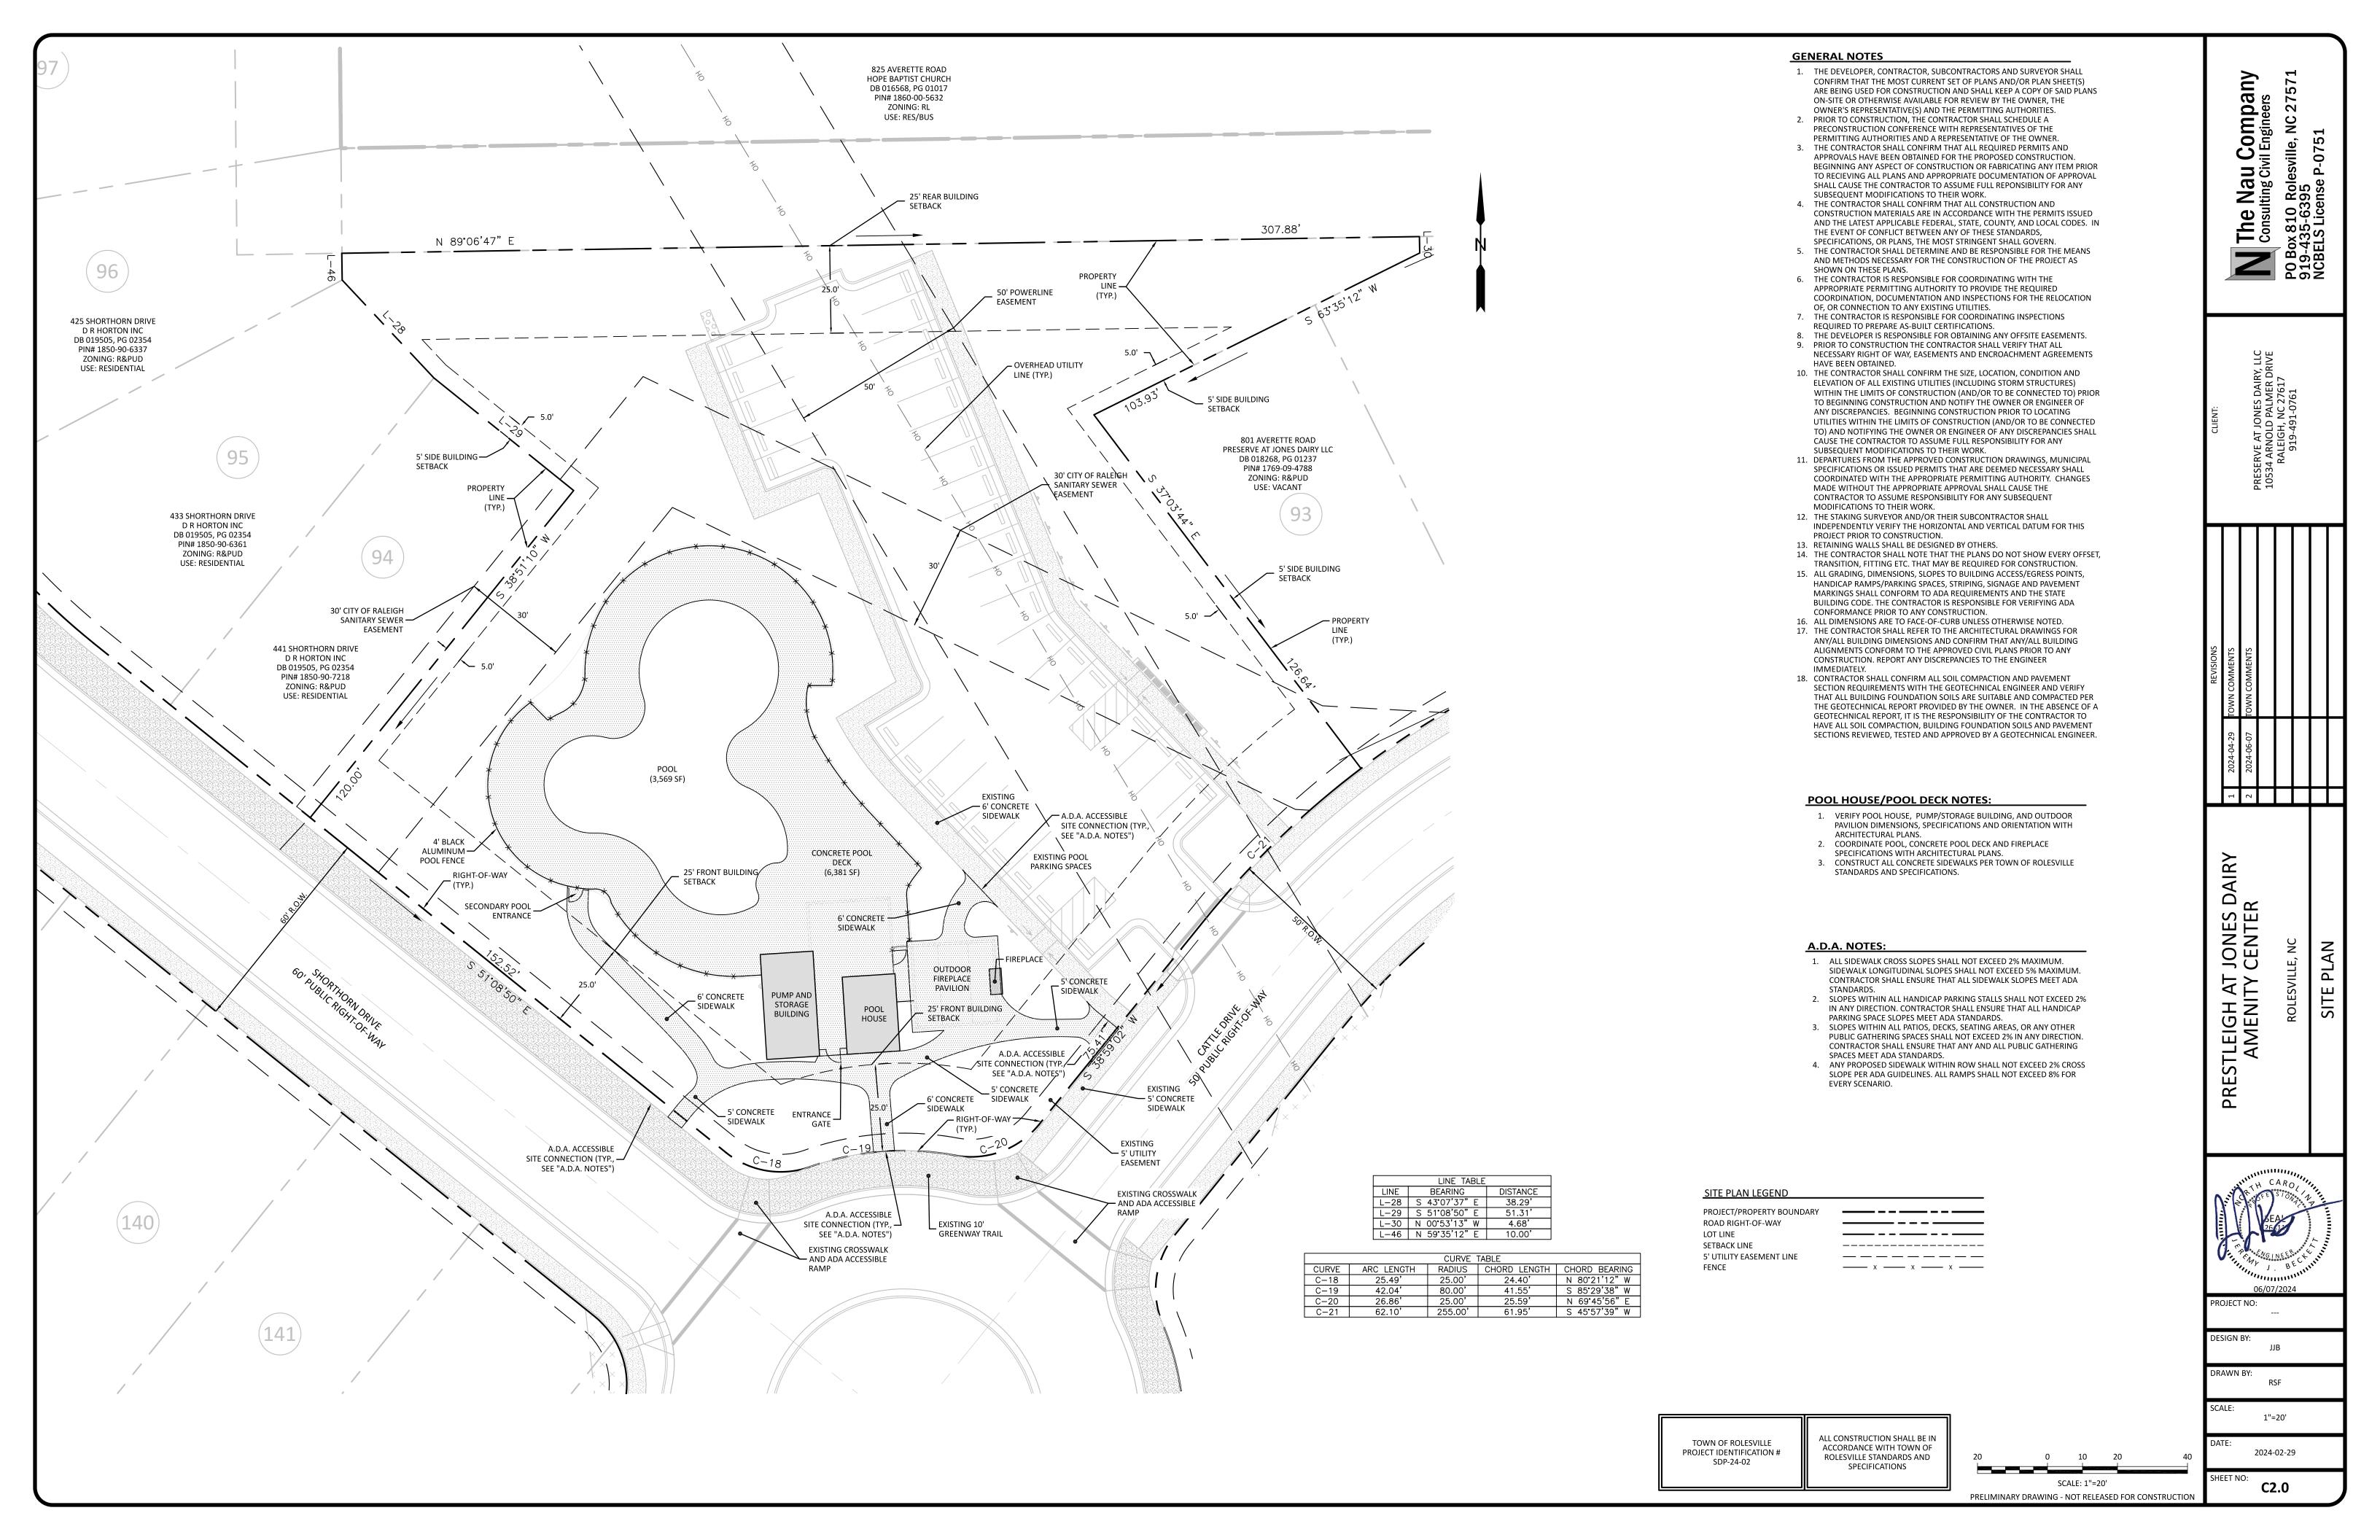

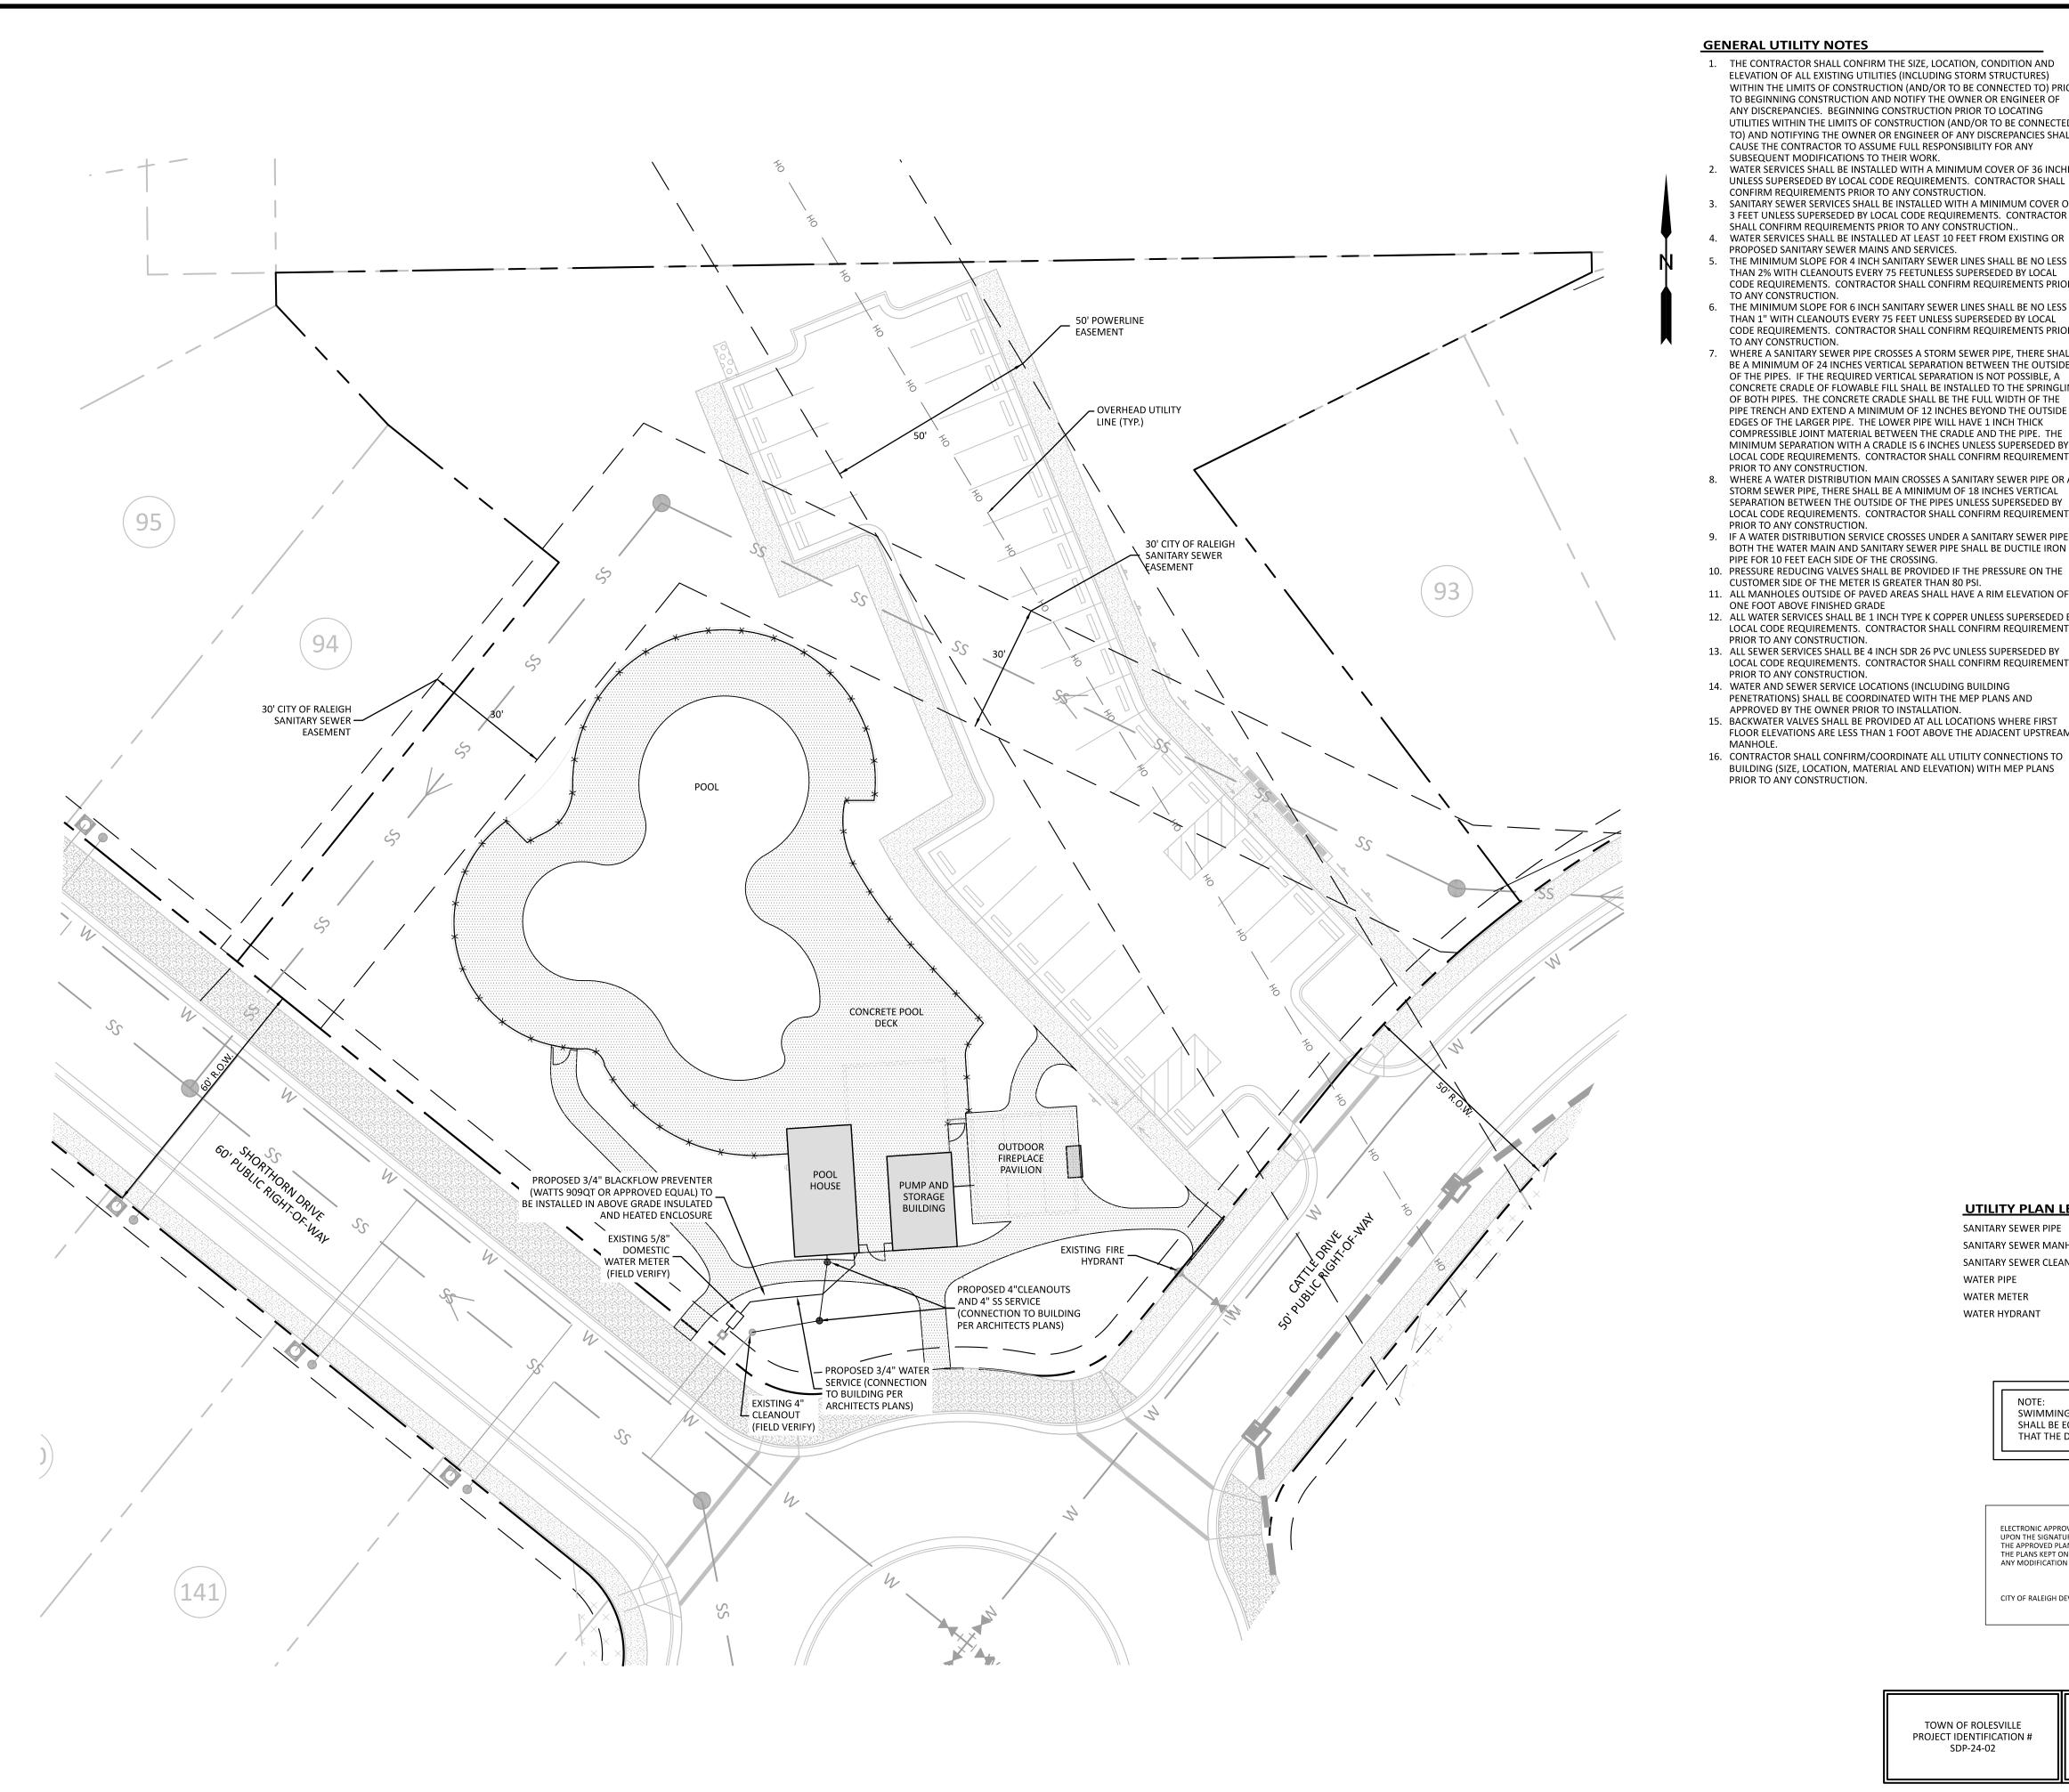

GENERAL UTILITY NOTES

- 1. THE CONTRACTOR SHALL CONFIRM THE SIZE, LOCATION, CONDITION AND ELEVATION OF ALL EXISTING UTILITIES (INCLUDING STORM STRUCTURES) WITHIN THE LIMITS OF CONSTRUCTION (AND/OR TO BE CONNECTED TO) PRIOR TO BEGINNING CONSTRUCTION AND NOTIFY THE OWNER OR ENGINEER OF ANY DISCREPANCIES. BEGINNING CONSTRUCTION PRIOR TO LOCATING
- UTILITIES WITHIN THE LIMITS OF CONSTRUCTION (AND/OR TO BE CONNECTED TO) AND NOTIFYING THE OWNER OR ENGINEER OF ANY DISCREPANCIES SHALL CAUSE THE CONTRACTOR TO ASSUME FULL RESPONSIBILITY FOR ANY SUBSEQUENT MODIFICATIONS TO THEIR WORK.
- WATER SERVICES SHALL BE INSTALLED WITH A MINIMUM COVER OF 36 INCHES UNLESS SUPERSEDED BY LOCAL CODE REQUIREMENTS. CONTRACTOR SHALL CONFIRM REQUIREMENTS PRIOR TO ANY CONSTRUCTION.
- SANITARY SEWER SERVICES SHALL BE INSTALLED WITH A MINIMUM COVER OF 3 FEET UNLESS SUPERSEDED BY LOCAL CODE REQUIREMENTS. CONTRACTOR SHALL CONFIRM REQUIREMENTS PRIOR TO ANY CONSTRUCTION..
- WATER SERVICES SHALL BE INSTALLED AT LEAST 10 FEET FROM EXISTING OR PROPOSED SANITARY SEWER MAINS AND SERVICES.
- THE MINIMUM SLOPE FOR 4 INCH SANITARY SEWER LINES SHALL BE NO LESS THAN 2% WITH CLEANOUTS EVERY 75 FEETUNLESS SUPERSEDED BY LOCAL CODE REQUIREMENTS. CONTRACTOR SHALL CONFIRM REQUIREMENTS PRIOR TO ANY CONSTRUCTION.
- THE MINIMUM SLOPE FOR 6 INCH SANITARY SEWER LINES SHALL BE NO LESS THAN 1" WITH CLEANOUTS EVERY 75 FEET UNLESS SUPERSEDED BY LOCAL CODE REQUIREMENTS. CONTRACTOR SHALL CONFIRM REQUIREMENTS PRIOR
- WHERE A SANITARY SEWER PIPE CROSSES A STORM SEWER PIPE, THERE SHALL BE A MINIMUM OF 24 INCHES VERTICAL SEPARATION BETWEEN THE OUTSIDE OF THE PIPES. IF THE REQUIRED VERTICAL SEPARATION IS NOT POSSIBLE, A CONCRETE CRADLE OF FLOWABLE FILL SHALL BE INSTALLED TO THE SPRINGLINE OF BOTH PIPES. THE CONCRETE CRADLE SHALL BE THE FULL WIDTH OF THE PIPE TRENCH AND EXTEND A MINIMUM OF 12 INCHES BEYOND THE OUTSIDE EDGES OF THE LARGER PIPE. THE LOWER PIPE WILL HAVE 1 INCH THICK COMPRESSIBLE JOINT MATERIAL BETWEEN THE CRADLE AND THE PIPE. THE MINIMUM SEPARATION WITH A CRADLE IS 6 INCHES UNLESS SUPERSEDED BY LOCAL CODE REQUIREMENTS. CONTRACTOR SHALL CONFIRM REQUIREMENTS PRIOR TO ANY CONSTRUCTION.
- 8. WHERE A WATER DISTRIBUTION MAIN CROSSES A SANITARY SEWER PIPE OR A STORM SEWER PIPE, THERE SHALL BE A MINIMUM OF 18 INCHES VERTICAL SEPARATION BETWEEN THE OUTSIDE OF THE PIPES UNLESS SUPERSEDED BY LOCAL CODE REQUIREMENTS. CONTRACTOR SHALL CONFIRM REQUIREMENTS PRIOR TO ANY CONSTRUCTION.
- 9. IF A WATER DISTRIBUTION SERVICE CROSSES UNDER A SANITARY SEWER PIPE BOTH THE WATER MAIN AND SANITARY SEWER PIPE SHALL BE DUCTILE IRON PIPE FOR 10 FEET EACH SIDE OF THE CROSSING.
- 10. PRESSURE REDUCING VALVES SHALL BE PROVIDED IF THE PRESSURE ON THE
- 11. ALL MANHOLES OUTSIDE OF PAVED AREAS SHALL HAVE A RIM ELEVATION OF ONE FOOT ABOVE FINISHED GRADE
- 12. ALL WATER SERVICES SHALL BE 1 INCH TYPE K COPPER UNLESS SUPERSEDED BY LOCAL CODE REQUIREMENTS. CONTRACTOR SHALL CONFIRM REQUIREMENTS
- 13. ALL SEWER SERVICES SHALL BE 4 INCH SDR 26 PVC UNLESS SUPERSEDED BY LOCAL CODE REQUIREMENTS. CONTRACTOR SHALL CONFIRM REQUIREMENTS PRIOR TO ANY CONSTRUCTION.
- 14. WATER AND SEWER SERVICE LOCATIONS (INCLUDING BUILDING PENETRATIONS) SHALL BE COORDINATED WITH THE MEP PLANS AND
- APPROVED BY THE OWNER PRIOR TO INSTALLATION. 15. BACKWATER VALVES SHALL BE PROVIDED AT ALL LOCATIONS WHERE FIRST FLOOR ELEVATIONS ARE LESS THAN 1 FOOT ABOVE THE ADJACENT UPSTREAM
- BUILDING (SIZE, LOCATION, MATERIAL AND ELEVATION) WITH MEP PLANS PRIOR TO ANY CONSTRUCTION.

- CITY OF RALEIGH STANDARD UTILITY NOTES:

 1. ALL MATERIALS & CONSTRUCTION METHODS SHALL BE IN ACCORDANCE WITH CITY OF RALEIGH DESIGN STANDARDS, DETAILS & SPECIFICATIONS (REFERENCE: CORPUD HANDBOOK, CURRENT EDITION)
- 2. UTILITY SEPARATION REQUIREMENTS: A) A DISTANCE OF 100' SHALL BE MAINTAINED BETWEEN SANITARY SEWER & ANY PRIVATE OR PUBLIC WATER SUPPLY SOURCE SUCH AS AN IMPOUNDED RESERVOIR USED AS A SOURCE OF DRINKING WATER. IF ADEQUATE LATERAL SEPARATION CANNOT BE ACHIEVED, FERROUS SANITARY SEWER PIPE SHALL BE
- SPECIFIED & INSTALLED TO WATERLINE SPECIFICATIONS. HOWEVER, THE MINIMUM SEPARATION SHALL NOT BE LESS THAN 25' FROM A PRIVATE WELL OR 50' FROM A PUBLIC WELL B) WHEN INSTALLING WATER &/OR SEWER MAINS, THE HORIZONTAL SEPARATION BETWEEN UTILITIES SHALL BE
- 10'. IF THIS SEPARATION CANNOT BE MAINTAINED DUE TO EXISTING CONDITIONS, THE VARIATION ALLOWED IS THE WATER MAIN IN A SEPARATE TRENCH WITH THE ELEVATION OF THE WATER MAIN AT LEAST 18" ABOVE THE TOP OF THE SEWER & MUST BE APPROVED BY THE PUBLIC UTILITIES DIRECTOR. ALL
- DISTANCES ARE MEASURED FROM OUTSIDE DIAMETER TO OUTSIDE DIAMETER C) WHERE IT IS IMPOSSIBLE TO OBTAIN PROPER SEPARATION, OR ANYTIME A SANITARY SEWER PASSES OVER A WATERMAIN, DIP MATERIALS OR STEEL ENCASEMENT EXTENDED 10' ON EACH SIDE OF CROSSING MUST BE SPECIFIED & INSTALLED TO WATERLINE SPECIFICATIONS
- D) 5.0' MINIMUM HORIZONTAL SEPARATION IS REQUIRED BETWEEN ALL SANITARY SEWER & STORM SEWER FACILITIES, UNLESS DIP MATERIAL IS SPECIFIED FOR SANITARY SEWER E) MAINTAIN 18" MIN. VERTICAL SEPARATION AT ALL WATERMAIN & RCP STORM DRAIN CROSSINGS; MAINTAIN
- 24" MIN. VERTICAL SEPARATION AT ALL SANITARY SEWER & RCP STORM DRAIN CROSSINGS. WHERE ADEQUATE SEPARATIONS CANNOT BE ACHIEVED, SPECIFY DIP MATERIALS & A CONCRETE CRADLE HAVING 6" MIN. CLEARANCE (PER CORPUD DETAILS W-41 & S-49) F) ALL OTHER UNDERGROUND UTILITIES SHALL CROSS WATER & SEWER FACILITIES WITH 18" MIN. VERTICAL
- SEPARATION REQUIRED 3. ANY NECESSARY FIELD REVISIONS ARE SUBJECT TO REVIEW & APPROVAL OF AN AMENDED PLAN &/OR
- PROFILE BY THE CITY OF RALEIGH PUBLIC UTILITIES DEPARTMENT PRIOR TO CONSTRUCTION 4. CONTRACTOR SHALL MAINTAIN CONTINUOUS WATER & SEWER SERVICE TO EXISTING RESIDENCES & BUSINESSES THROUGHOUT CONSTRUCTION OF PROJECT, ANY NECESSARY SERVICE INTERRUPTIONS SHALL
- BE PRECEDED BY A 24 HOUR ADVANCE NOTICE TO THE CITY OF RALEIGH PUBLIC UTILITIES DEPARTMENT 5. 3.0' MINIMUM COVER IS REQUIRED ON ALL WATER MAINS & SEWER FORCEMAINS. 4.0' MINIMUM COVER IS
- $6. \ \ IT IS THE DEVELOPER'S RESPONSIBILITY TO ABANDON OR REMOVE EXISTING WATER \& SEWER SERVICES NOT$ BEING USED IN REDEVELOPMENT OF A SITE UNLESS OTHERWISE DIRECTED BY THE CITY OF RALEIGH PUBLIC UTILITIES DEPARTMENT. THIS INCLUDES ABANDONING TAP AT MAIN & REMOVAL OF SERVICE FROM ROW
- OR EASEMENT PER CORPUD HANDBOOK PROCEDURE . INSTALL ¾" COPPER* WATER SERVICES WITH METERS LOCATED AT ROW OR WITHIN A 2'X2' WATERLINE EASEMENT IMMEDIATELY ADJACENT. NOTE: IT IS THE APPLICANT'S RESPONSIBILITY TO PROPERLY SIZE THE
- WATER SERVICE FOR EACH CONNECTION TO PROVIDE ADEQUATE FLOW & PRESSURE 8. INSTALL 4" PVC* SEWER SERVICES @ 1.0% MINIMUM GRADE WITH CLEANOUTS LOCATED AT ROW OR
- EASEMENT LINE & SPACED EVERY 75 LINEAR FEET MAXIMUM 9. PRESSURE REDUCING VALVES ARE REQUIRED ON ALL WATER SERVICES EXCEEDING 80 PSI; BACKWATER ALVES ARE REQUIRED ON ALL SANITARY SEWER SERVICES HAVING BUILDING DRAINS LOWER THAN 1.0'
- ABOVE THE NEXT UPSTREAM MANHOLE 10. ALL ENVIRONMENTAL PERMITS APPLICABLE TO THE PROJECT MUST BE OBTAINED FROM NCDWO. USACE &/OR FEMA FOR ANY RIPARIAN BUFFER, WETLAND &/OR FLOODPLAIN IMPACTS (RESPECTIVELY) PRIOR TO
- CONSTRUCTION. 11. CROSS-CONNECTION CONTROL PROTECTION DEVICES ARE REQUIRED BASED ON DEGREE OF HEALTH HAZARD INVOLVED AS LISTED IN APPENDIX-B OF THE RULES GOVERNING PUBLIC WATER SYSTEMS IN NORTH CAROLINA. THESE GUIDELINES ARE THE MINIMUM REQUIREMENTS. THE DEVICES SHALL MEET AMERICAN SOCIETY OF SANITARY ENGINEERING (ASSE) STANDARDS OR BE ON THE UNIVERSITY OF SOUTHERN CALIFORNIA APPROVAL LIST. THE DEVICES SHALL BE INSTALLED AND TESTED (BOTH INITIAL AND PERIODIC TESTING THEREAFTER) IN ACCORDANCE WITH THE MANUFACTURER'S RECOMMENDATIONS OR THE LOCAL

CROSS-CONNECTION CONTROL PROGRAM, WHICHEVER IS MORE STRINGENT. CONTACT JOANIE HARTLEY AT

(919) 996-5923 OR JOANIE.HARTLEY@RALEIGHNC.GOV FOR MORE INFORMATION

UTILITY PLAN LEGEND

WATER METER

WATER HYDRANT

SANITARY SEWER PIPE SANITARY SEWER MANHOLE SANITARY SEWER CLEANOUT WATER PIPE

THAT THE DISCHARGE RATE DOES NOT EXCEED 50 GPM.

SWIMMING POOL DISCHARGE TO THE SANITARY SEWER SYSTEM

SHALL BE EQUIPPED WITH A PUMP OR FLOW RESTRICTOR SO

CITY OF RALEIGH - PLANS AUTHORIZED FOR CONSTRUCTION ELECTRONIC APPROVAL: THIS APPROVAL IS BEING ISSUED ELECTRONICALLY. THIS APPROVAL IS VALID ONLY UPON THE SIGNATURE OF A CITY OF RALEIGH REVIEW OFFICER BELOW. THE CITY WILL RETAIN A COPY OF THE APPROVED PLANS. ANY WORK AUTHORIZED BY THIS APPROVAL MUST PROCEED IN ACCORDANCE WITH THE PLANS KEPT ON FILE WITH THE CITY. THIS ELECTRONIC APPROVAL MAY NOT BE EDITED ONCE ISSUED ANY MODIFICATION TO THIS APPROVAL ONCE ISSUED WILL INVALIDATE THIS APPROVAL CITY OF RALEIGH DEVELOPMENT APPROVAL RALEIGH WATER REVIEW OFFICER

TOWN OF ROLESVILLE PROJECT IDENTIFICATION # SDP-24-02

ALL CONSTRUCTION SHALL BE IN ACCORDANCE WITH TOWN OF ROLESVILLE STANDARDS AND SPECIFICATIONS

SCALE: 1"=20' PRELIMINARY DRAWING - NOT RELEASED FOR CONSTRUCTION

PRESTLEIGH AT JONES AMENITY CENTE

PLAN

Compai

au มัย Ci


The Consu


27


DESIGN BY:


DRAWN BY: RSF


2024-02-29 C3.0

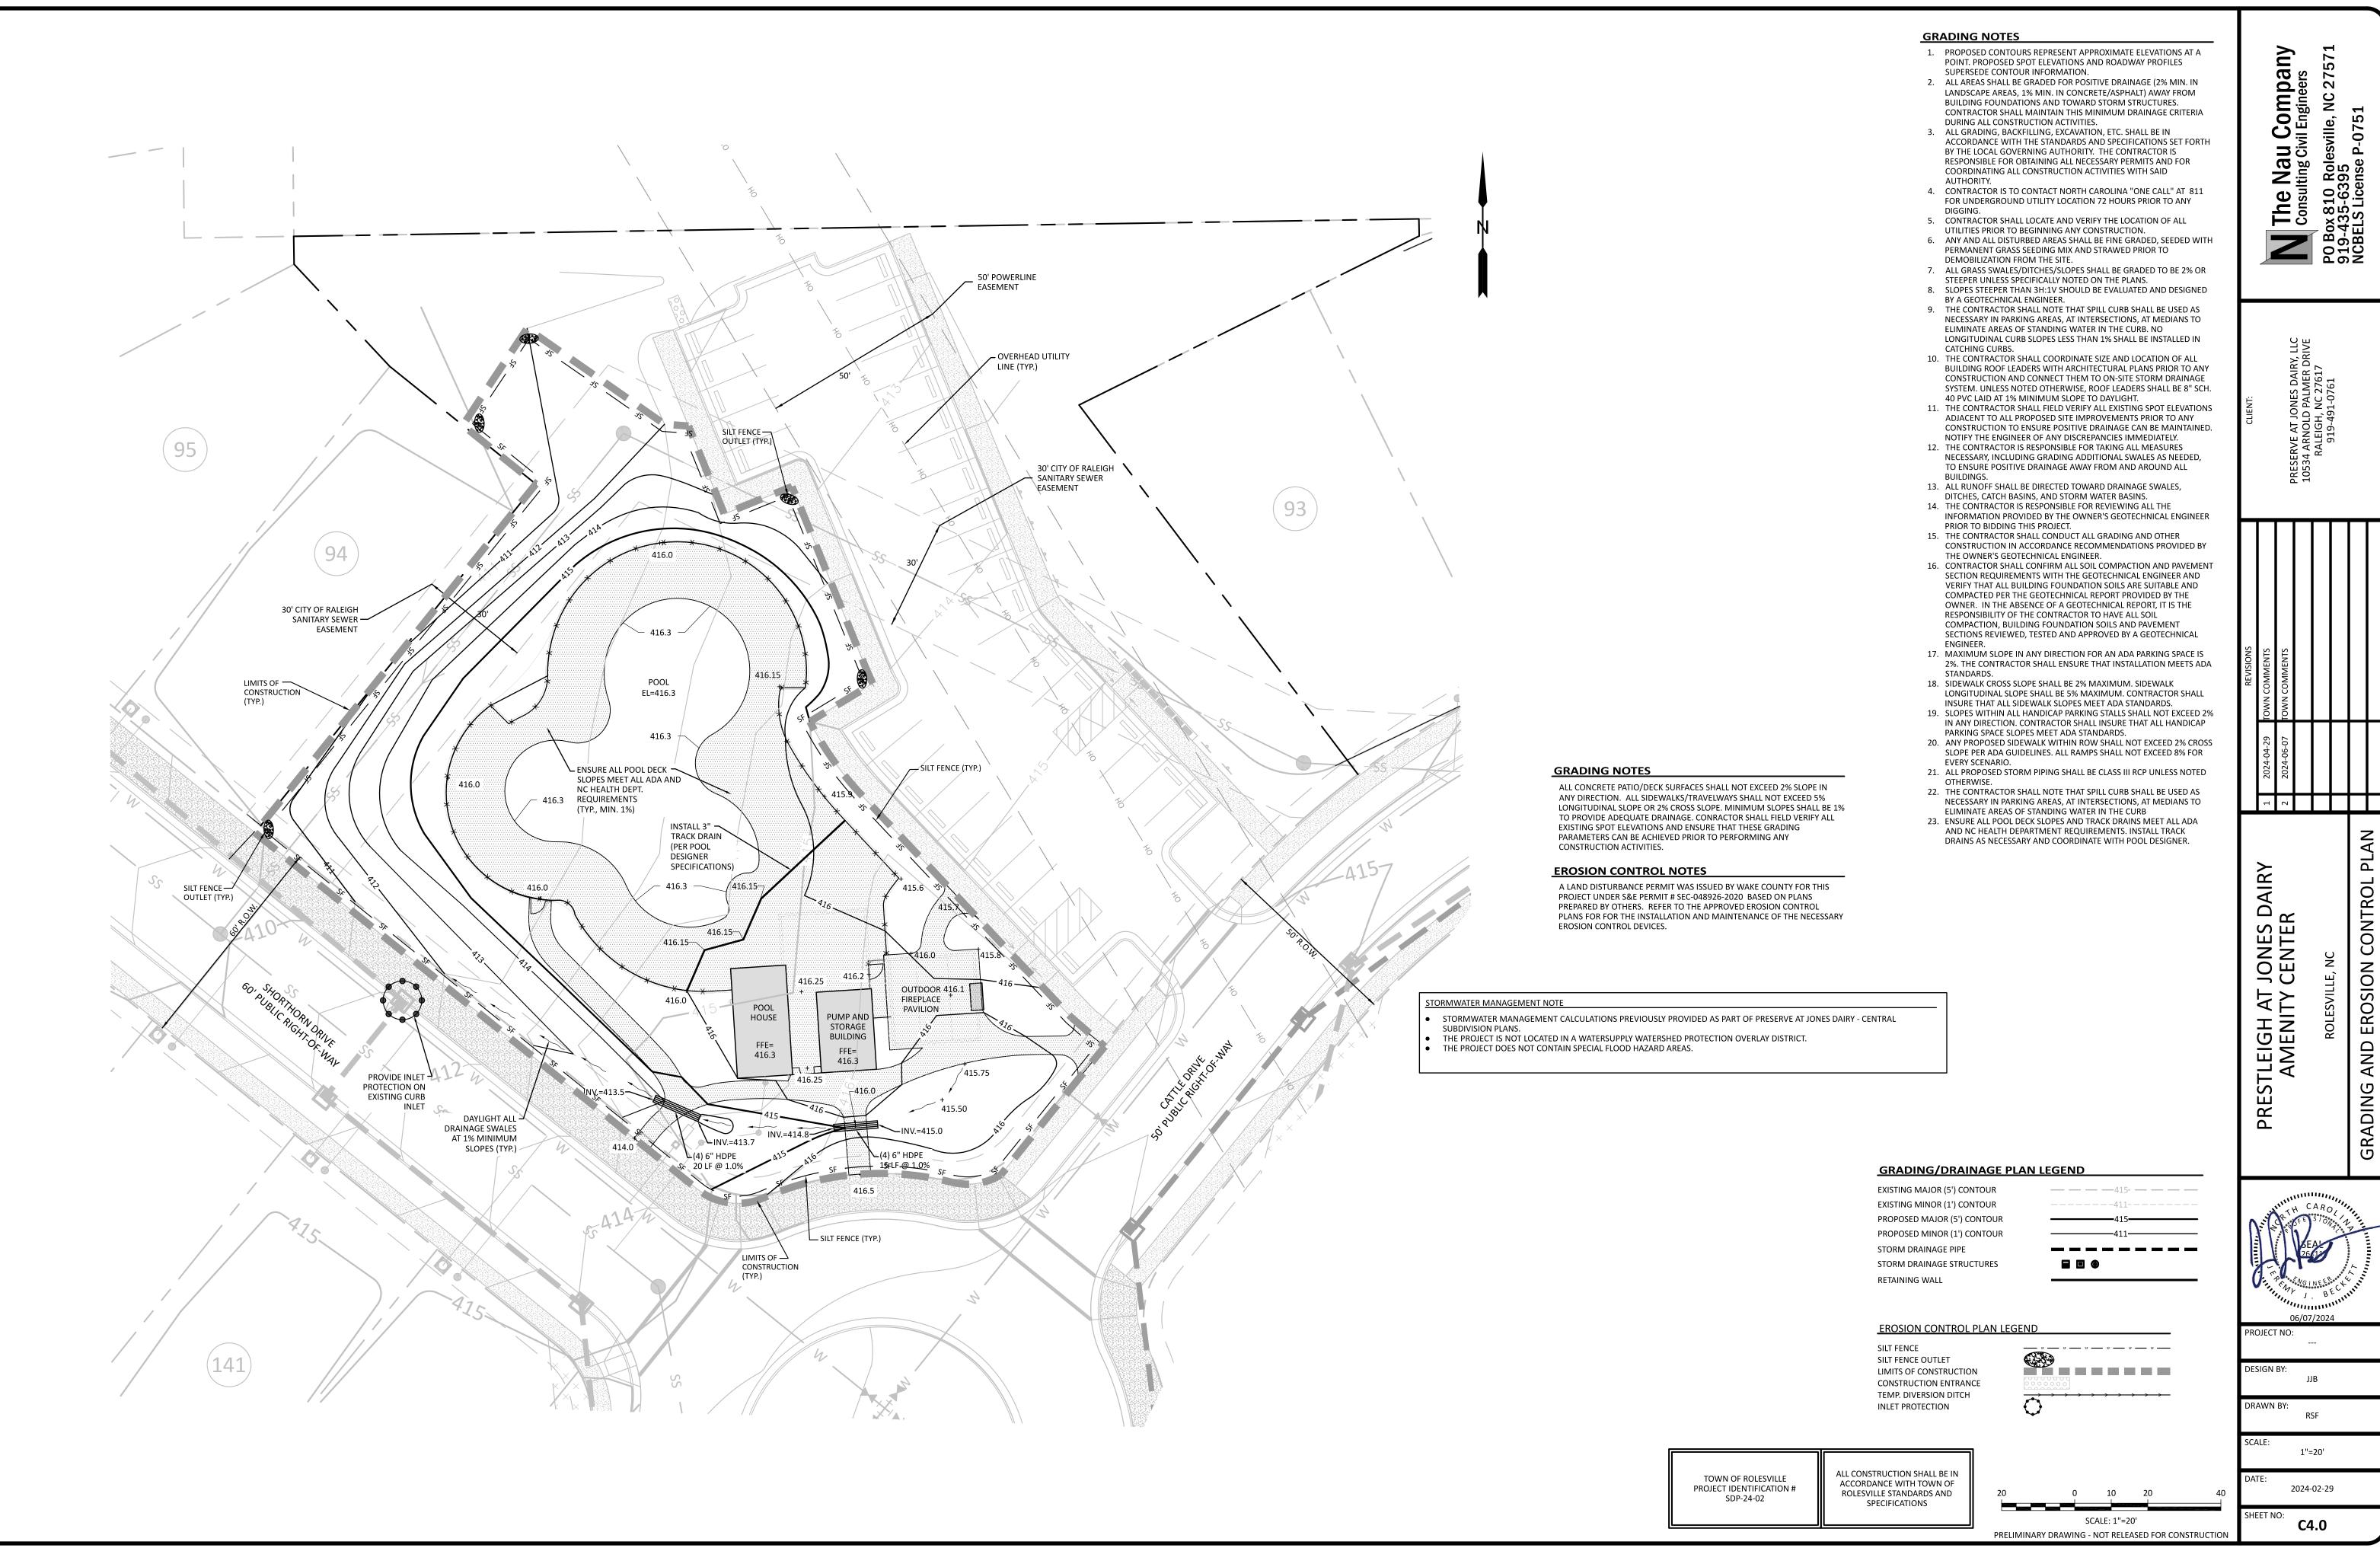


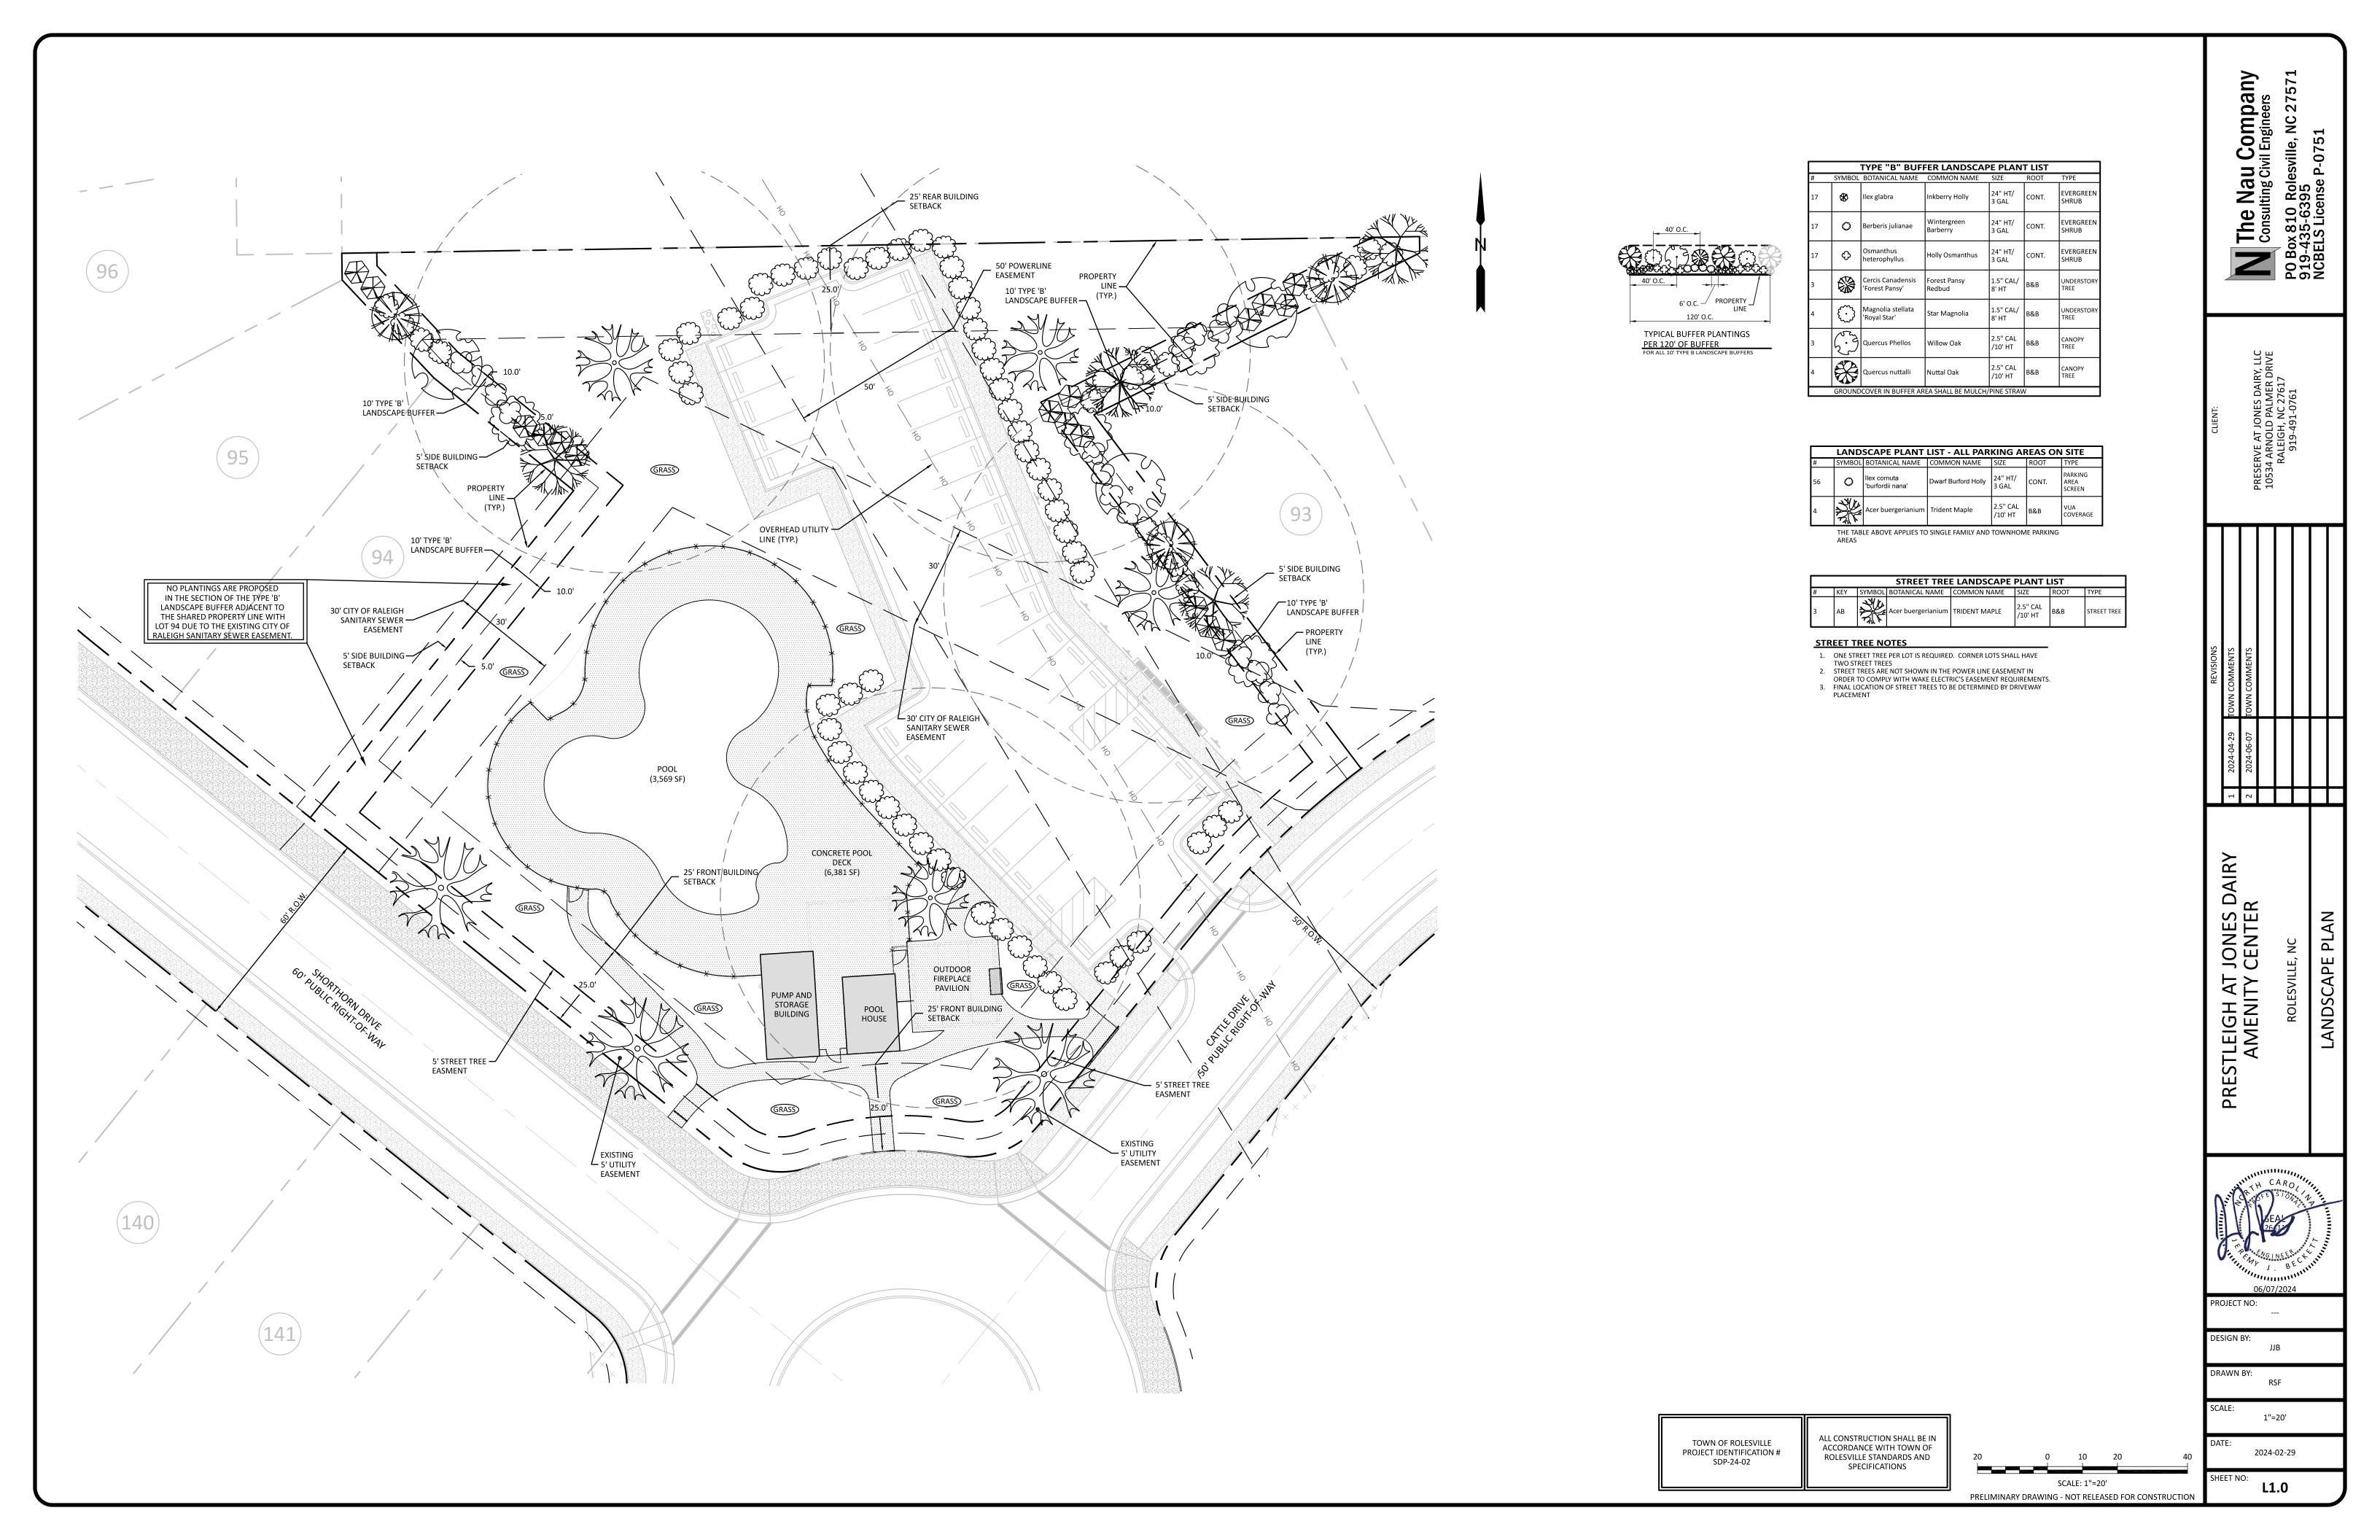


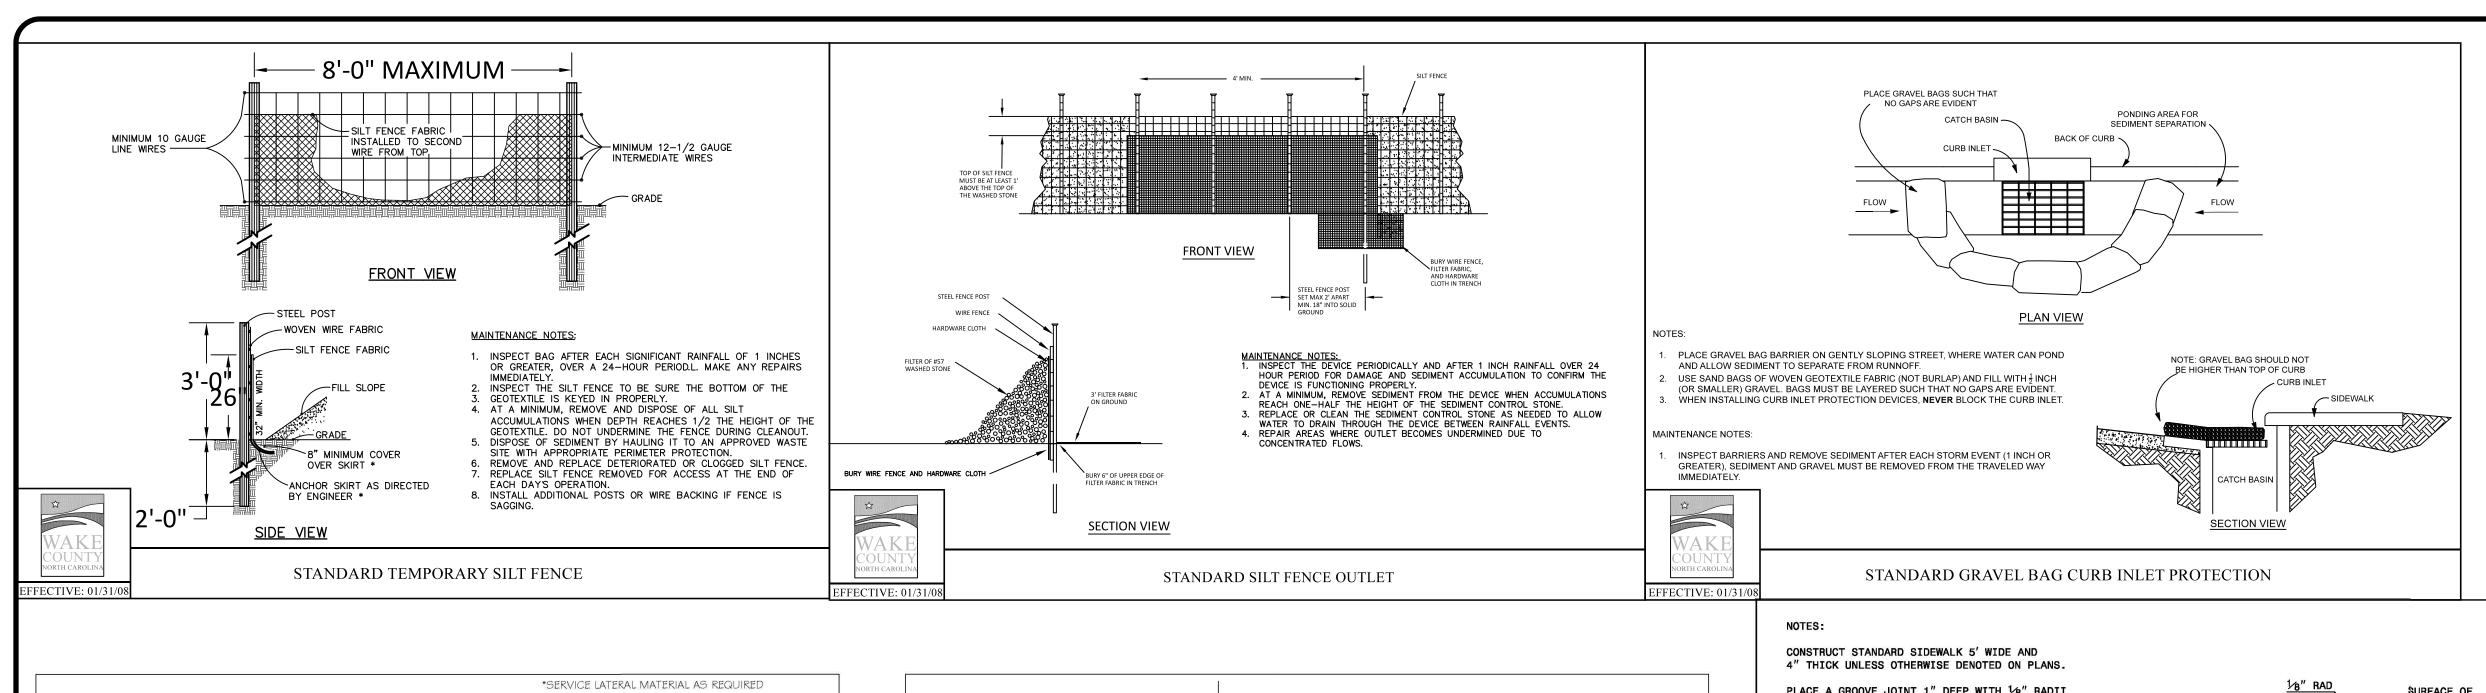

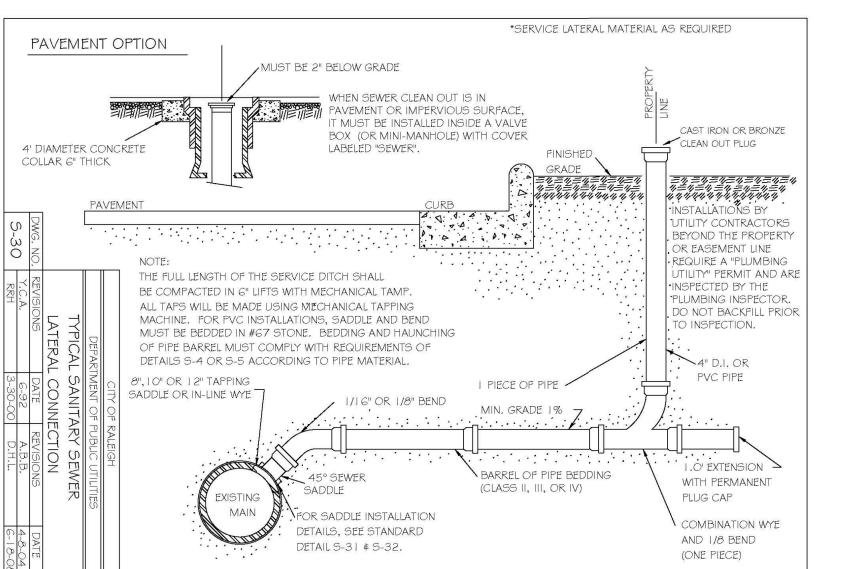

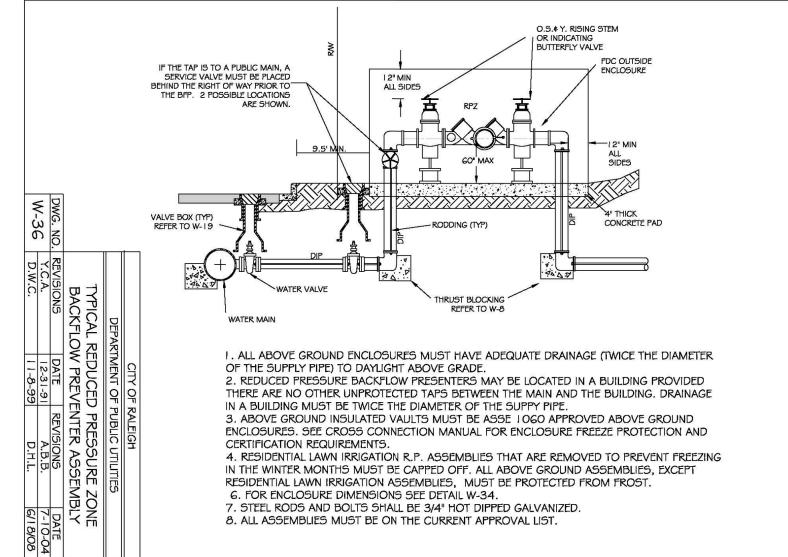

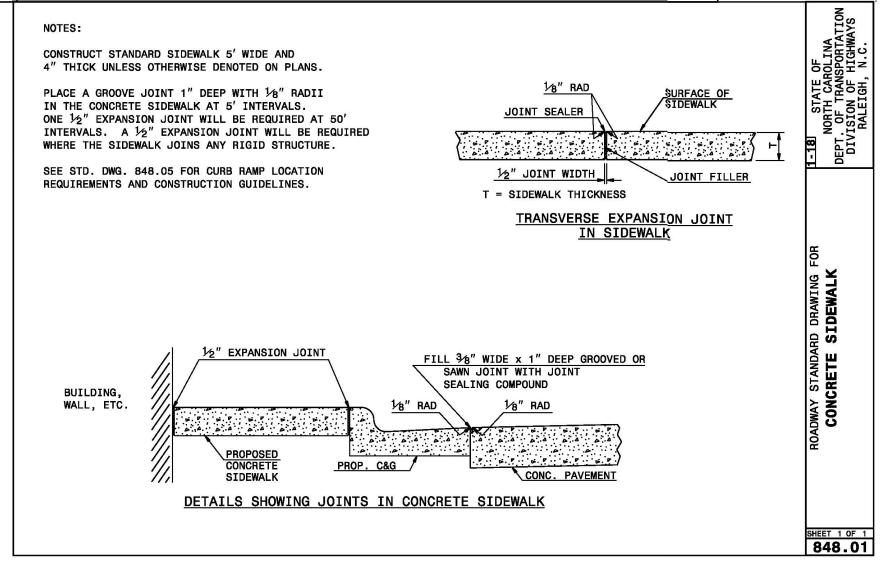

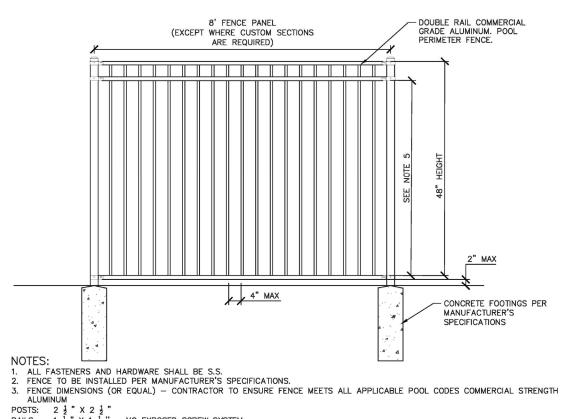

BOTTOM RAIL OR STRINGER AND THE NEXT HORIZONTAL RAIL OR STRINGER.

ALUMINUM

POSTS: 2½ " X 2½ "

RAILS: 1½ " X 1½ " — NO EXPOSED SCREW SYSTEM

PICKETS: ½ " X ¾ " W/ 3 ½ "SPACING


COLOR: SATIN BLACK, SHOP APPLIED POWDER COAT


4. CONFIRM POOL FENCE MEETS LOCAL CODE CRITERIA


5. FOR POOL FENCING, THE HORIZONTAL SPACE BETWEEN VERTICAL MEMBERS SHALL NOT EXCEED 4 INCHES; WHERE THE HORIZONTAL

SPACE BETWEEN VERTICAL MEMBERS EXCEEDS 1—3/4 INCHES THERE SHALL BE AT LEAST 30 INCHES BETWEEN ANY HORIZONTAL

POTTAND BAIL OR STRINGER AND THE NEYT HORIZONTAL RAIL OR STRINGER POOL FENCE AND GATE

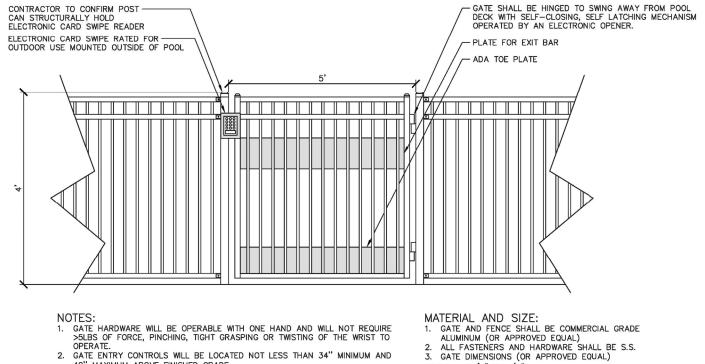

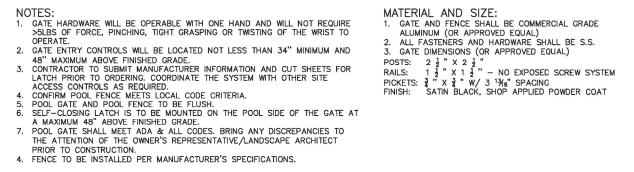

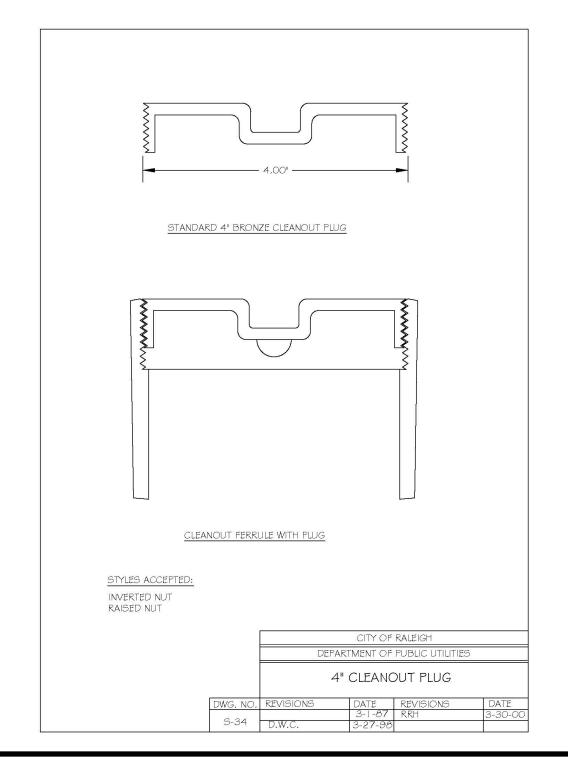

TOWN OF ROLESVILLE PROJECT IDENTIFICATION # SDP-24-02

ALL CONSTRUCTION SHALL BE IN ACCORDANCE WITH TOWN OF ROLESVILLE STANDARDS AND SPECIFICATIONS

2024-02-29 PRELIMINARY DRAWING - NOT RELEASED FOR CONSTRUCTION

pa

Comp

Nau Iting Civ

The

DAII DETAILS

JONES PRESTLEIGH AT J AMENITY (

SITE

PROJECT NO:


DESIGN BY: JJB DRAWN BY:

RSF SCALE: NTS







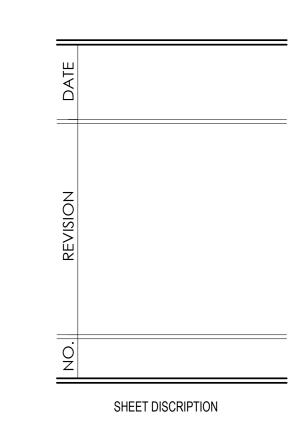

PLANNING FLOOR PLANS

PROJECT #: 2024XXX

DATE ISSUED: 02/29/2024

DRAWING BY: JGM


CHECKED BY: DSC

PRESTLEIGH AMENITY
DR HORTON
BATHHOUSE & POOL
ROLESVILLE, NC



66' - 0"

24' - 0"

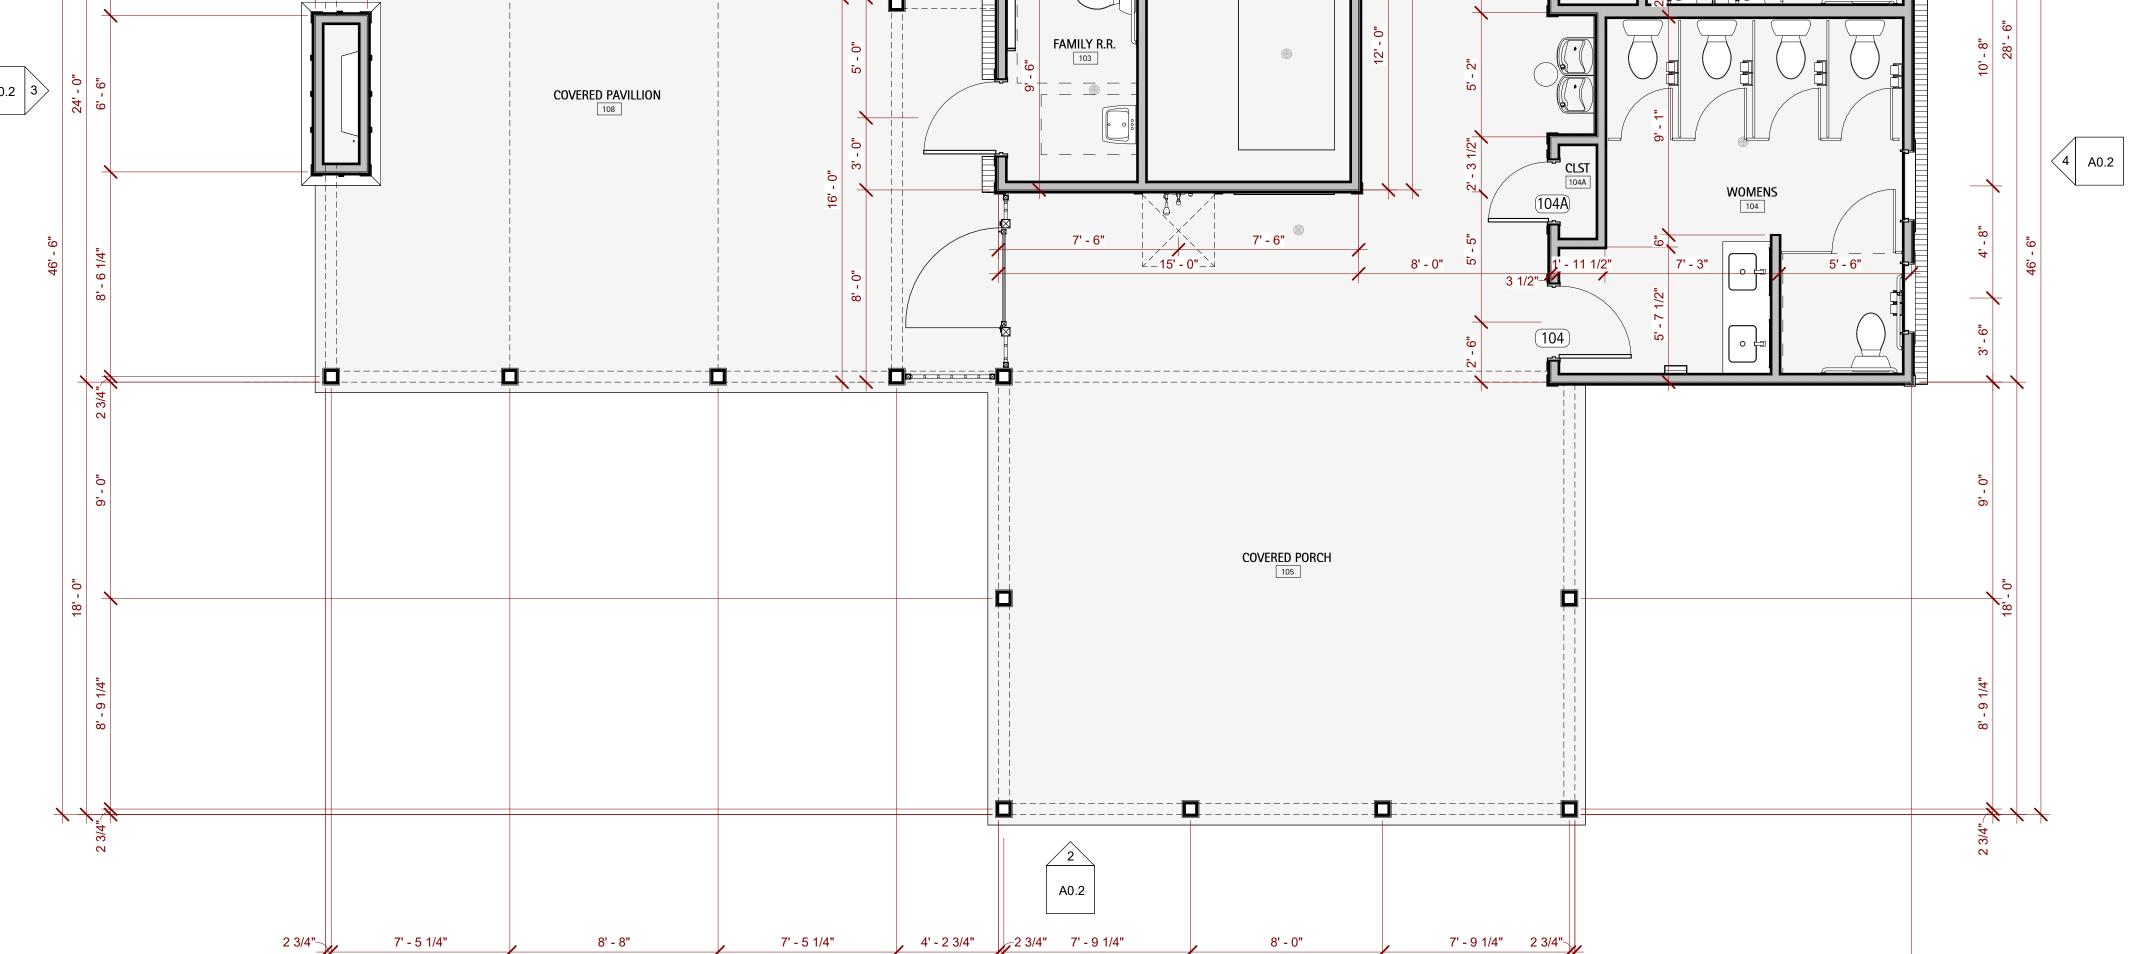

66' - 0"

4' - 6"

15' - 0"

6' - 0"

4' - 6"

8' - 10 1/2" — 🖂

PUMP ROOM

8' - 0"

15' - 0"

6' - 0"

14' - 0"

4' - 6"

4' - 6"

24' - 0"


8' - 8"

21' - 9 3/4"

Copyright D CLUGSTON, INC. 2022 - Unless otherwise indicated, all Materials, Ideas & Design on these pages are copyrighted by D. Clugston Inc. All rights reserved. No part of these pages, either text or image may be used for any other third parties is strictly prohibited without prior written permission, in any form or by any means, electronic, modification, storage in retrieval system or retransmission, in any form or by any means, electronic, modification, storage in retrieval system or retransmission, in any form or by any means, electronic, modification, storage in retrieval system or retransmission, in any form or by any means, electronic, modification, storage in retrieval system or retransmission, in any form or by any means, electronic, modification, storage in retrieval system or retransmission, in any form or by any means, electronic, modification, storage in retrieval system or retransmission, in any form or by any means, electronic, modification, storage in retrieval system or retransmission, in any form or by any means, electronic, modification, storage in retrieval system or retransmission, in any form or by any means, electronic, modification, storage in retrieval system or retransmission, in any form or by any means, electronic, modification, storage in retrieval system or retransmission, in any form or by any means, electronic, modification, storage in retrieval system or retransmission, in any form or by any means, electronic, modification, storage in retrieval system or retransmission, in any form or by any means, electronic, modification, storage in retrieval system or retransmission, in any form or by any means, electronic, modification, storage in retrieval system or retransmission and electronic system or retrieval system or retrieva


7' - 5 1/4"

7' - 5 1/4"

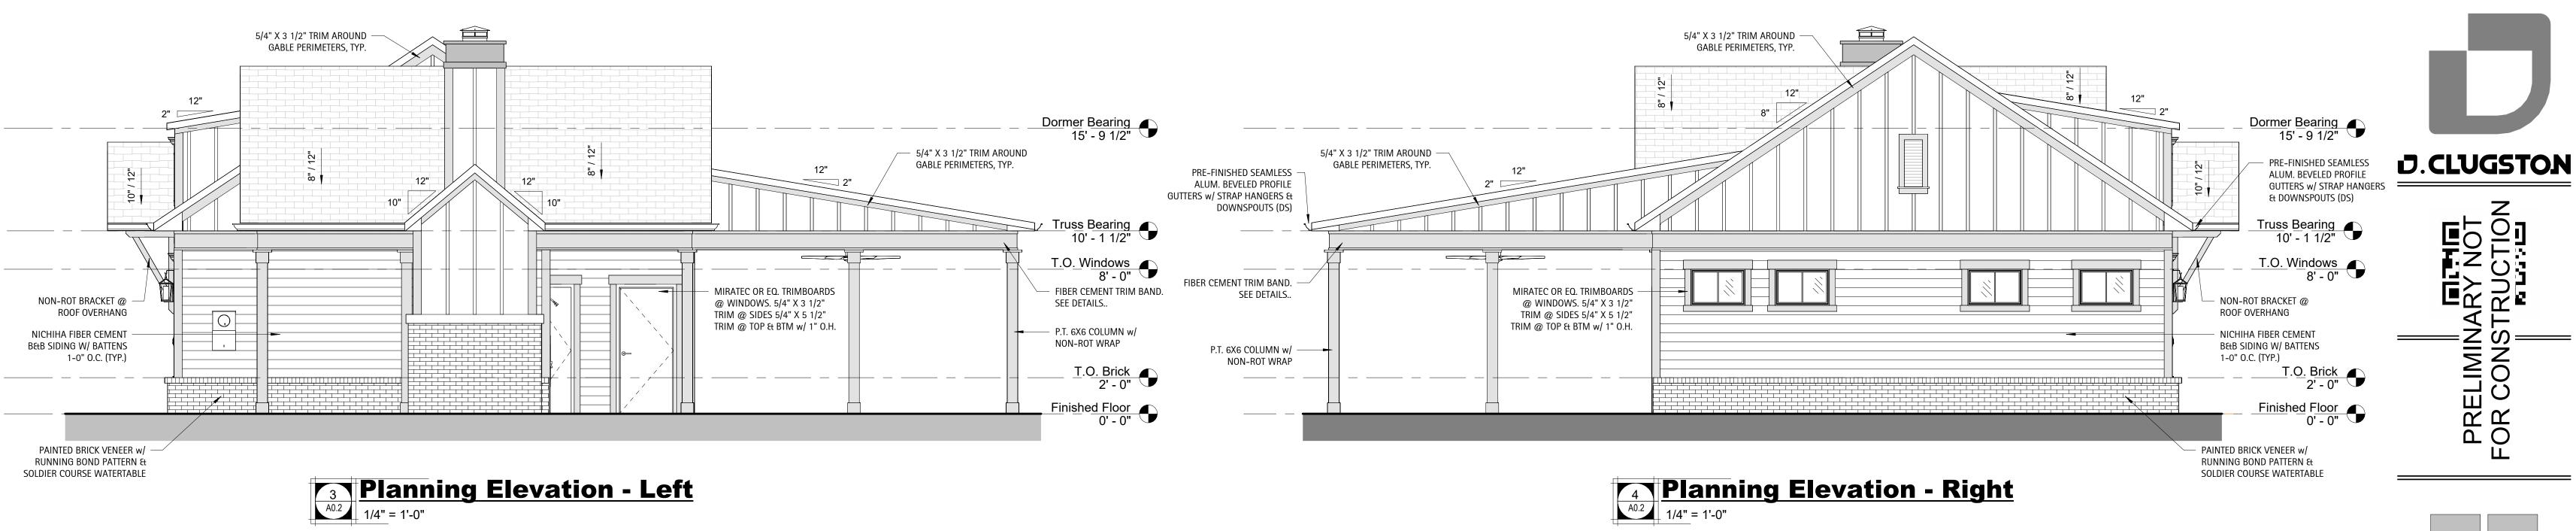

Copyright D CLUGSTON, INC. 2022 - Unless otherwise indicated, all Materials, Ideas & Design on these pages are copyrighted by D. Clugston Inc. All rights reserved. No part of these pages, either text or image may be used for any other third parties is strictly prohibited without prior written permission, in any form or by any means, electronic, modification, storage in retrieval system or retransmission, in any form or by any means, electronic, mechanical, or otherwise, for reasons other than intended use on the specific project, nor can this project be assigned to any other third parties is strictly prohibited without prior written permission from the Lead Designer or Architect.



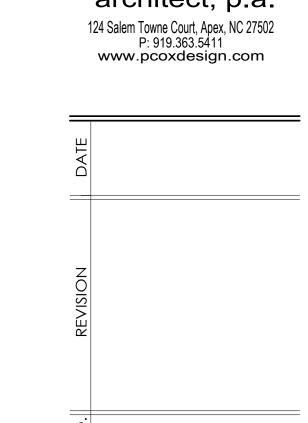

SHEET DISCRIPTION PLANNING **ELEVATIONS**

PROJECT #: 2024XXX DATE ISSUED: 02/29/2024 DRAWING BY: CHECKED BY: DSC

PRESTLEIGH AMENITY DR HORTON & P00L ROLESVILLE, **BATHHOUSE**

MATERIAL LEGEND

HORIZONTAL SIDING COLOR: STERLING WHITE BENJAMIN MOORE: 1591

BOARD & BATTEN SIDING COLOR: STERLING WHITE BENJAMIN MOORE: 1591

EXTERIOR TRIM COLOR: STERLING WHITE BENJAMIN MOORE: 1591

<u>COLUMNS</u> COLOR: STERLING WHITE BENJAMIN MOORE: 1591

BRICK VENEER COLOR: CORTEZ BY

GENERAL SHALE

ROOFING SHINGLES

COLOR: CHARCOAL



ROOFING STANDING SEAM COLOR: BLACK MBCI - 200 SERIES



RIDGE VENT