V2 - SDP-24-06

ROLESVILLE CROSSING


1801 ROLESVILLE RD ROLESVILLE, NC 27587

AMENITY CENTER (OS 1006 & OS 1007) CONSTRUCTION DRAWINGS

PROJECT NUMBER: LEN2026 SDP-24-06

DATE: JULY 1, 2024

SITE DATA DEVELOPER: 1100 PERIMETER PARK DRIVE, SUITE 112 MORRISVILLE, NC 27560 HEARTHSTONE INC 23975 PARK SORRENTO STE 220 CALABASAS CA 91302 1767-48-3143; 1767-58-6083 PIN NUMBERS (ENTIRE SITE): WATERSHED: BUFFALOE CREEK RIVER BASIN: TOTAL PROJECT AREA: 90.65 AC AFTER R/W DEDICATION PROJECT LAND AREA: AMENITY AREA (OS 1006): 21,215 SF PARKING LOT (OS 1007): 22,523 SF TOTAL AMENITY SITE: 43,738 SF / 1.00 AC EXISTING ZONING: PROPOSED ZONING: CURRENT USE RESIDENTIAL/AMENITY & PARKING PROPOSED USE: RESIDENTIAL/AMENITY & PARKING CURRENT IMPERVIOUS: 16,463 SF - PARKING LOT & MAIL KIOSK (APPROVED UNDER SEPARATE COVER CD 21-08) PROPOSED IMPERVIOUS: 11,164 SF - CLUBHOUSE & POOL PARKING DATA: REQUIRED FOR MAIL KIOSK: 7 ADDITIONAL VISITOR SPOTS PROVIDED: 34 TOTAL PARKING SPACE PROVIDED: 40 (APPROVED UNDER SEPARATE COVER CD-21-08) TREE COVERAGE: BUILDING HEIGHT: ONE STORY 21'-6" BUILDING AREA: 1,958 SF 1 DU/AC

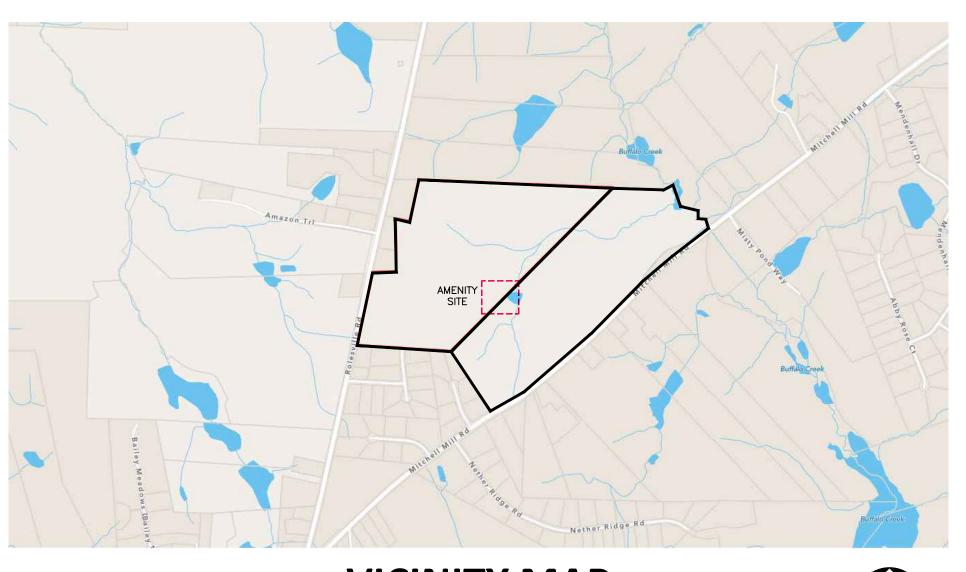

VICINITY MAP



SHEET INDEX

C1.01

C2.00

C3.00

C4.00

C8.00

C8.01

L5.00

L5.01

L6.00

COVER SHEET

CONTROL PLAN

SITE DETAILS

OVERALL SUBDIVISION PLAN

AMENITY HARDSCAPE PLAN

AMENITY UTILITY PLAN

SITE AND UTILITY DETAILS

AMENITY LANDSCAPE PLAN

AMENITY LIGHTING PLAN

LANDSCAPE NOTES AND DETAILS

AMENITY EXISTING CONDITION

AMENITY GRADING, DRAINAGE, AND EROSION

MCADAMS The John R. McAdams Company, Inc. 621 Hillsborough Street Suite 500

Raleigh, NC 27603 phone 919. 361. 5000 fax 919. 361. 2269 license number: C-0293, C-187

www.mcadamsco.com

CONTACT


JACK RITCHIE ritchie@mcadamsco.com

PHONE: 404.642.6153

CLIENT

LENNAR
1100 PERIMETER PARK DRIVE, SUITE 112
MORRISVILLE, NC 27560
ERIC BLOCHER
eric.blocher@lennar.com



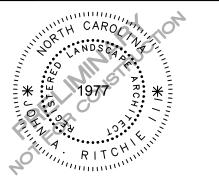

REVISIONS

NO. DATE

1 09.03.2024 REVISED PER TOWN COMMENTS

CONSTRUCTION
DRAWINGS
DRAWINGS FOR:

ROLESVILLE CROSSING AMENITY CENTER ROLESVILLE, NC 27587 PROJECT NUMBER: LEN23026





McAdams

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phone 919. 361. 5000 fax 919. 361. 2269 license number: C-0293, C-187

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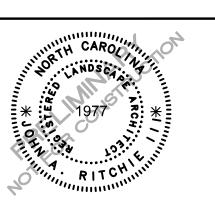
CLIENT

LENNAR

1100 PERIMETER PARK DRIVE, SUITE 112 MORRISVILLE, NC 27560



OLESVILLE CROSSING
AMENITY CENTER
CONSTRUCTION DRAWINGS
1801 ROLESVILLE RD
ROLESVILLE NC 27587



REVISIONS

NO. DATE

1 09.03.2024 REVISED PER TOWN COMMENTS

PLAN INFORMATION

PROJECT NO. LEN23026

FILENAME LEN23026-HS1

CHECKED BY JAR

DRAWN BY SMA

SCALE 1" = 100'


DATE
SHEET


PRELIMINARY DRAWING - NOT RELEASED FOR CONSTRUCTION

OVERALL SUBDIVISION PLAN

07.01.2024

C1.00

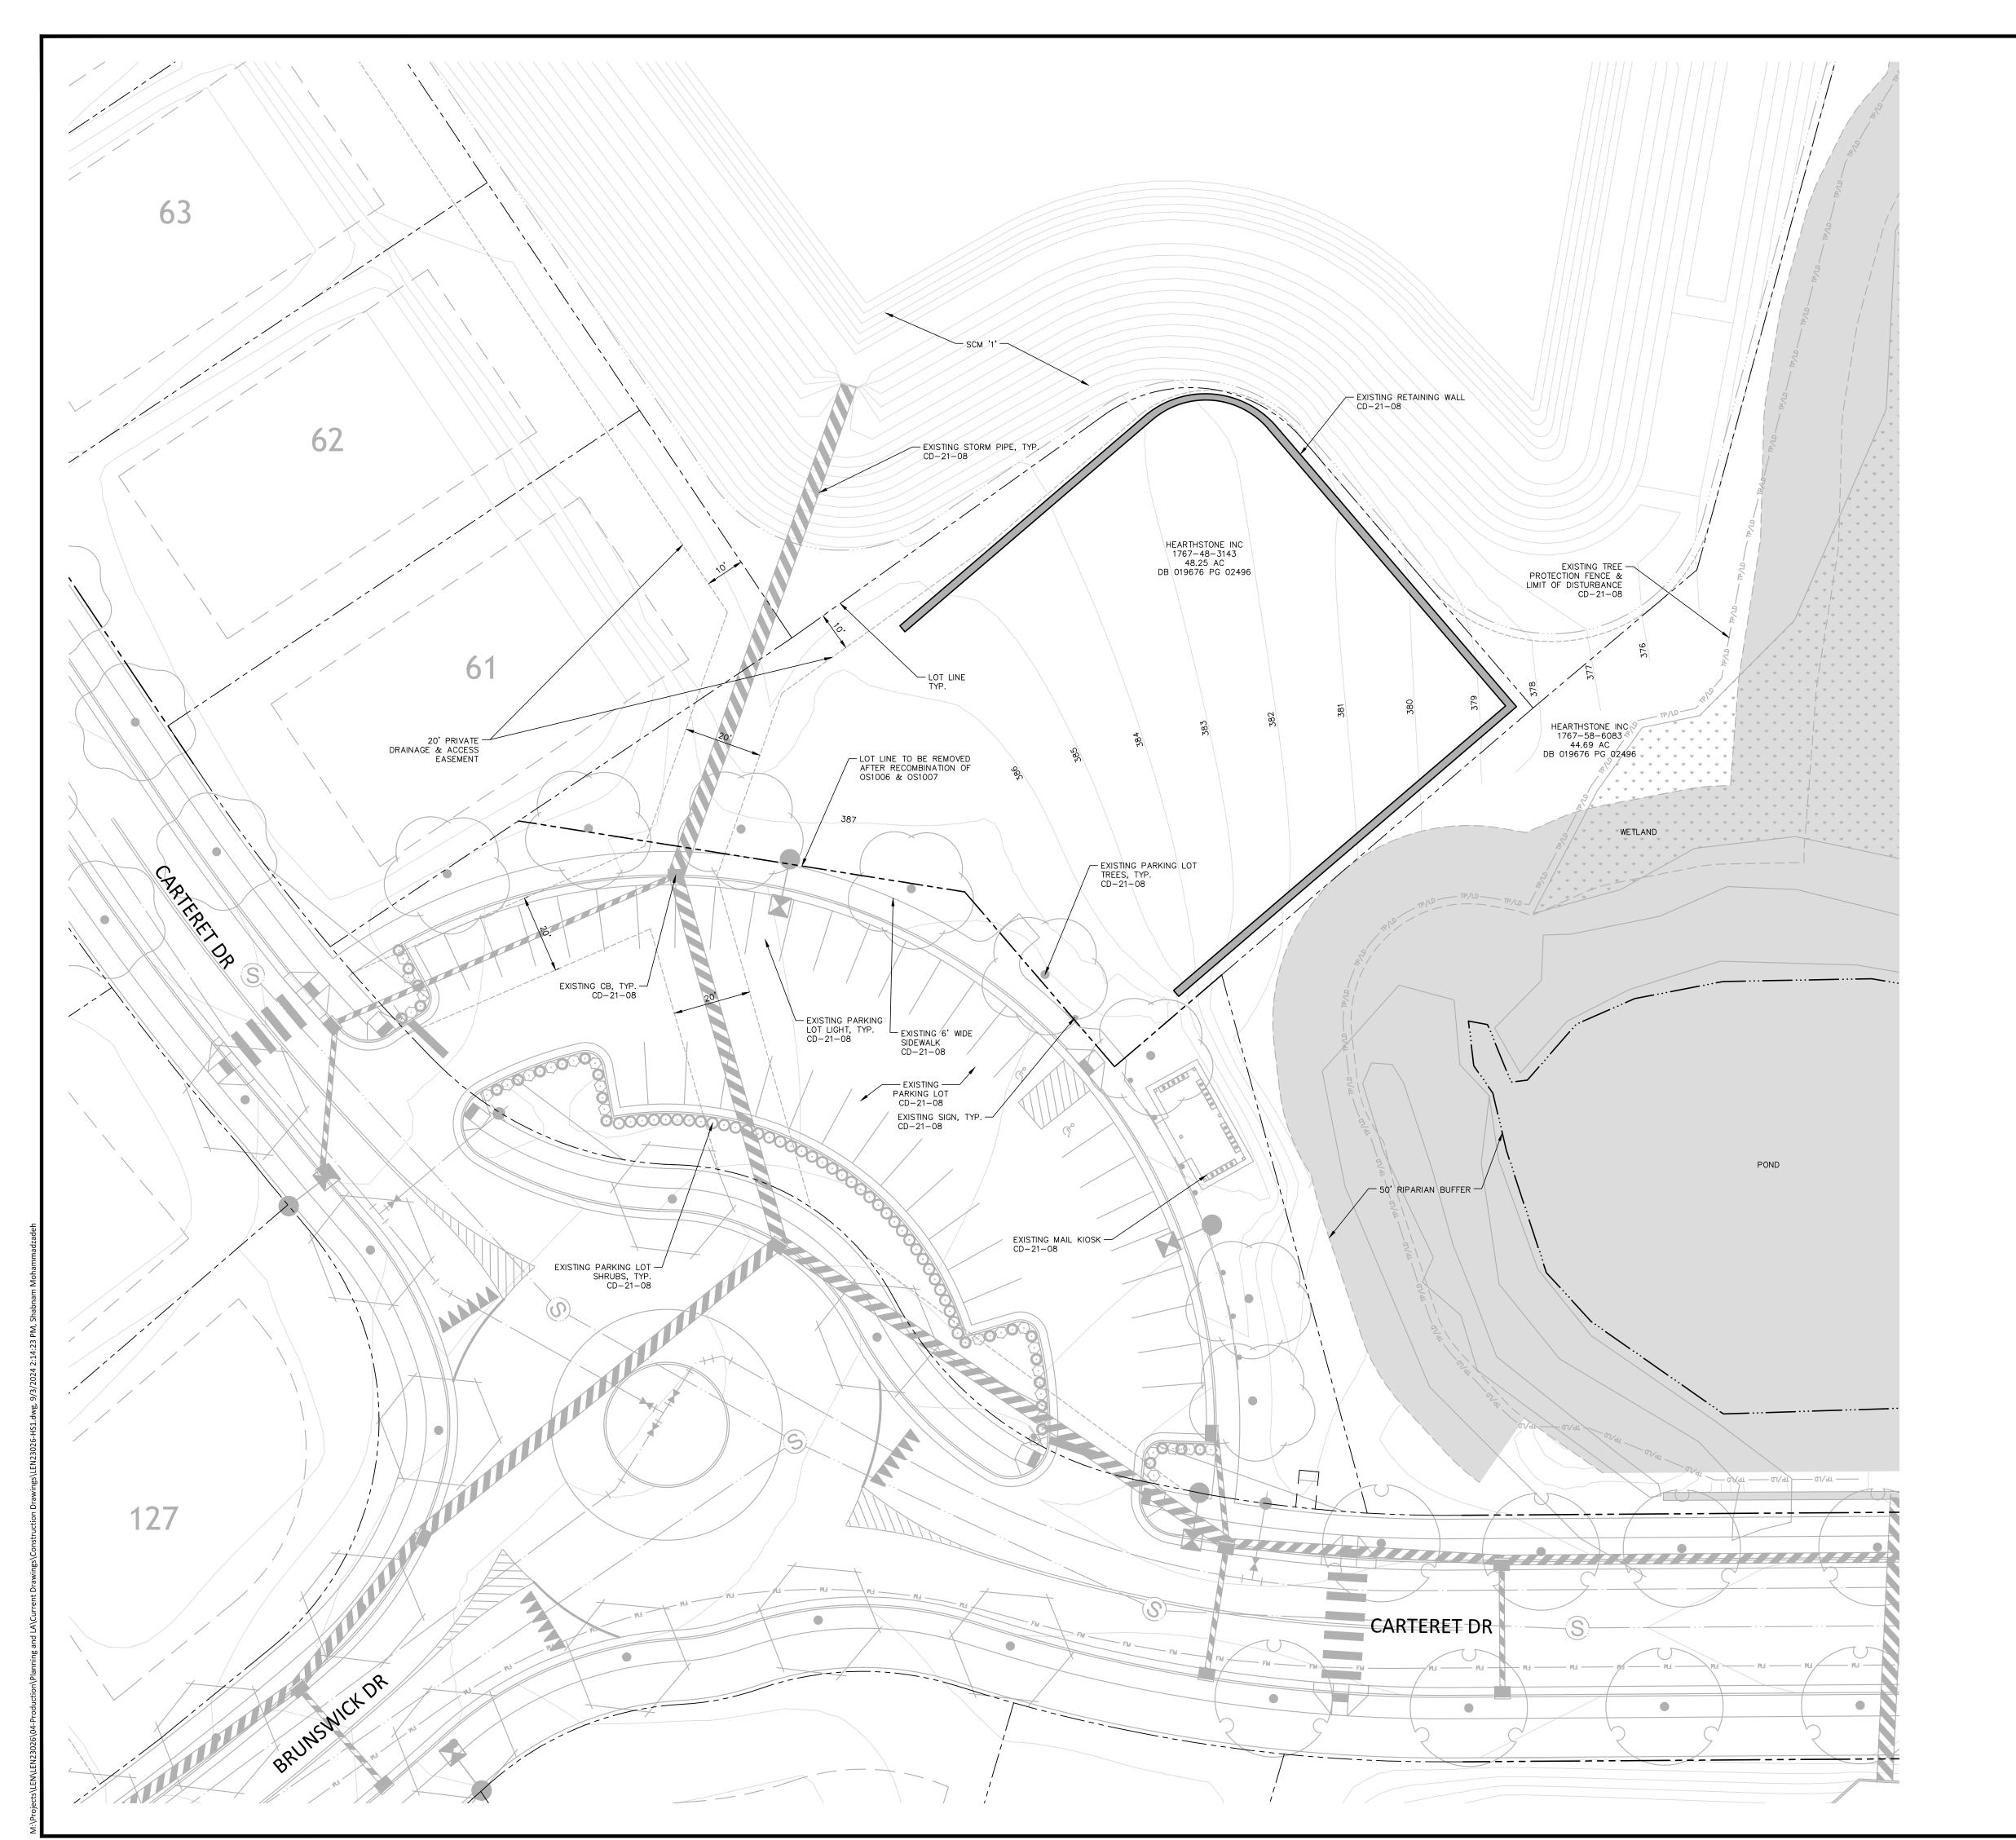

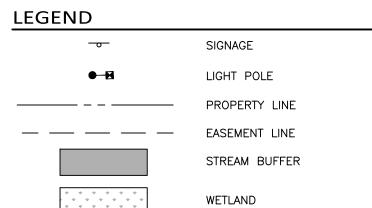



McAdam

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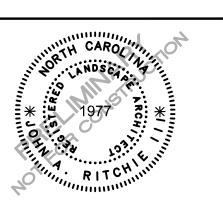
CLIENT

LENNAR

1100 PERIMETER PARK DRIVE, SUITE 112 MORRISVILLE, NC 27560



OLESVILLE CROSSING AMENITY CENTER ONSTRUCTION DRAWINGS 1801 ROLESVILLE RD ROLESVILLE, NC 27587



REVISIONS

NO. DATE

1 09.03.2024 REVISED PER TOWN COMMENTS

PLAN INFORMATION


PROJECT NO. LEN23026
FILENAME LEN23026-HS1
CHECKED BY JAR
DRAWN BY SMA
SCALE 1" = 20'

DATE 07.01.2024 **SHEET**

AMENITY EXISTING CONDITION

C1.01

SDP-24-06 PRELIMINARY DRAWING - NOT RELEASED FOR CONSTRUCTION

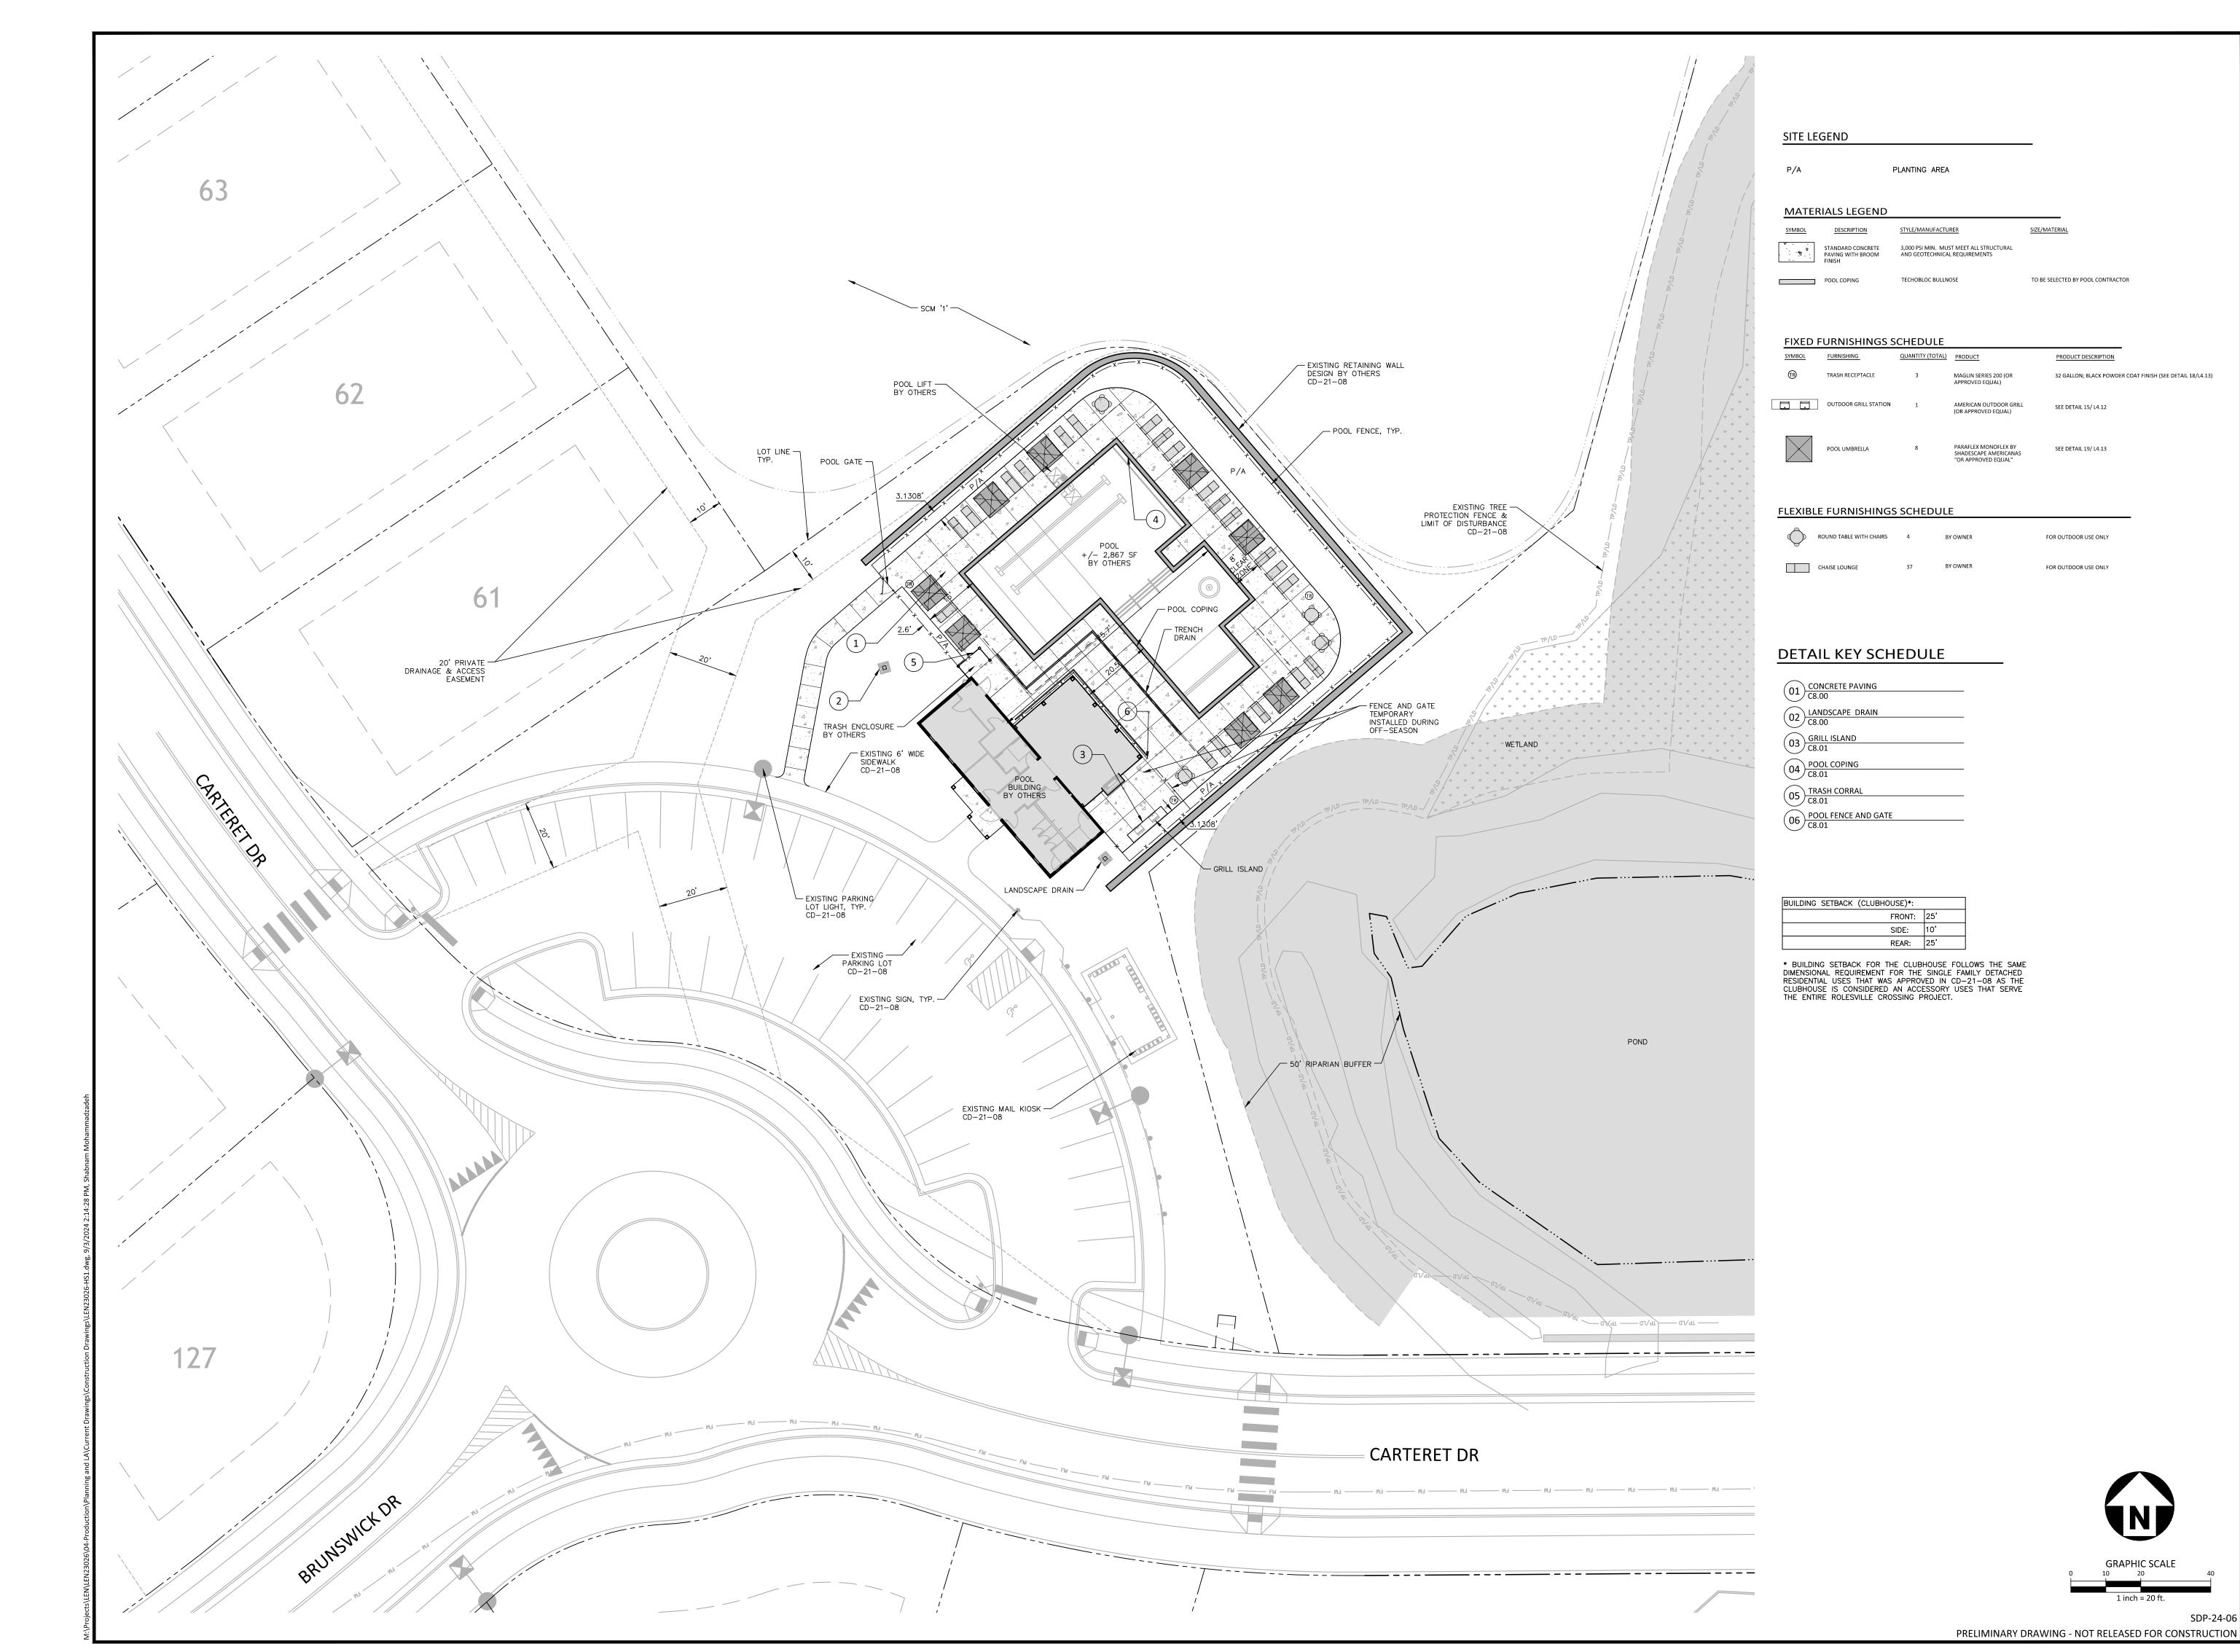



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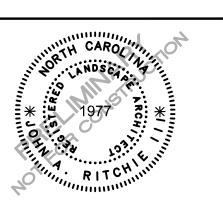
CLIENT

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OLESVILLE CROSSING
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ONSTRUCTION DRAWINGS
1801 ROLESVILLE RD
ROLESVILLE, NC 27587



REVISIONS

NO. DATE

1 09.03.2024 REVISED PER TOWN COMMENTS

PLAN INFORMATION

PROJECT NO. LEN23026

FILENAME LEN23026-HS1

CHECKED BY JAR

DRAWN BY SMA

SCALE 1" = 20'


SCALE 1" = 20'

DATE 07.01.2024

SHEET

AMENITY HARDSCAPE PLAN

C2.00

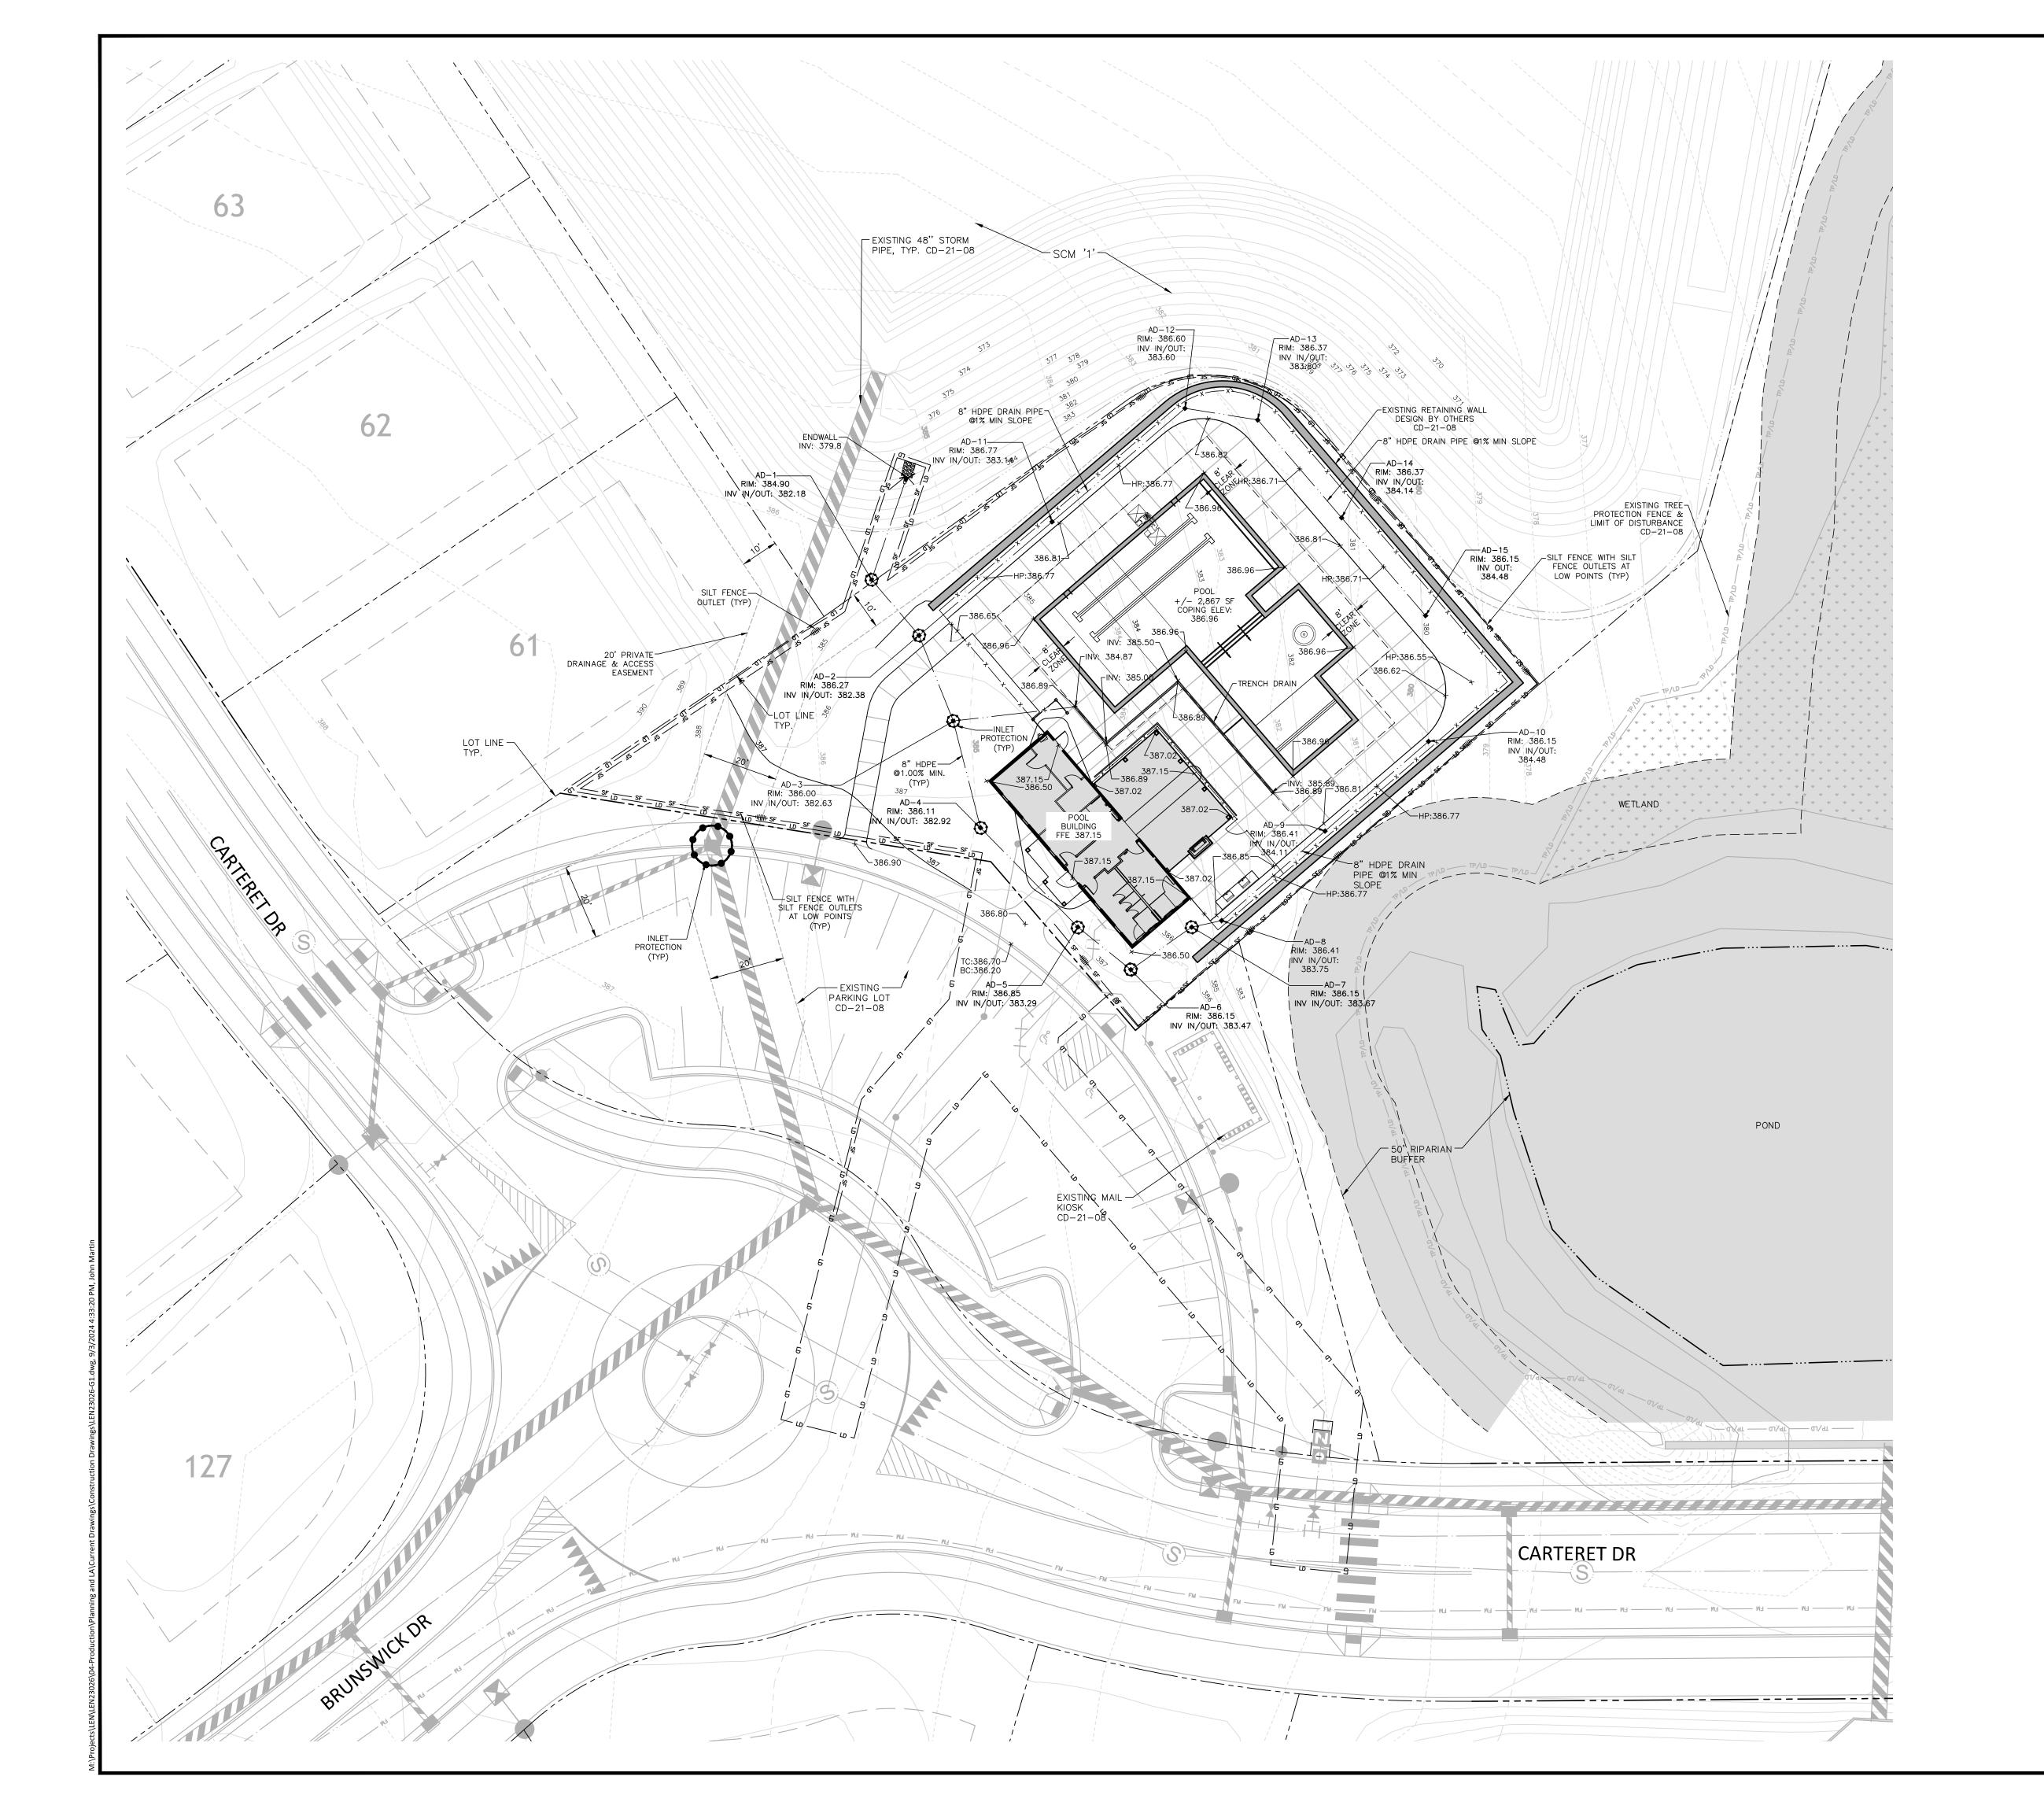

GRADING AND EROSION CONTROL LEGEND

FLARED END SECTION DROP INLET STORM SERVICE INLET

TOP & BOTTOM CURB ELEVATIONS

TW=386.50 — TOP OF WALL ELEVATION
BW=381.00 — BOTTOM OF WALL ELEVATION
(NOTE: BOTTOM OF WALL IS GROUND ELEVATION NOT WALL FOUNDATION)

+ 250.60 SPOT ELEVATION STORM DRAINAGE ----- STORM SERVICE LINE

-----LD ------ LIMITS OF DISTURBANCE — SF —— SF — SILT FENCE WOODED AREA 382 PROPOSED MINOR CONTOUR MASS GRADING MINOR CONTOUR

MASS GRADING MAJOR CONTOUR ---- EASEMENT LINE SILT FENCE OUTLET

INLET PROTECTION INLET PROTECTION FOR EXISTING STRUCTURES

— SF — SF — SILT FENCE

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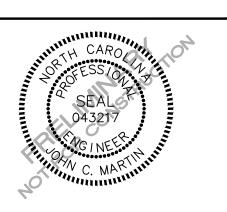
CLIENT

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SSING



REVISIONS

NO. DATE

1 09.03.2024 REVISED PER TOWN COMMENTS

PLAN INFORMATION

PROJECT NO. LEN23026 FILENAME CHECKED BY

DRAWN BY SCALE DATE 07.01.2024


SHEET

AMENITY GRADING, DRAINAGE, AND EROSION CONTROL PLAN

PRELIMINARY DRAWING - NOT RELEASED FOR CONSTRUCTION

ALL CONSTRUCTION SHALL BE IN ACCORDANCE WITH THE CURRENT

TOWN OF ROLESVILLE ENGINEERING AND CONSTRUCTION STANDARDS.

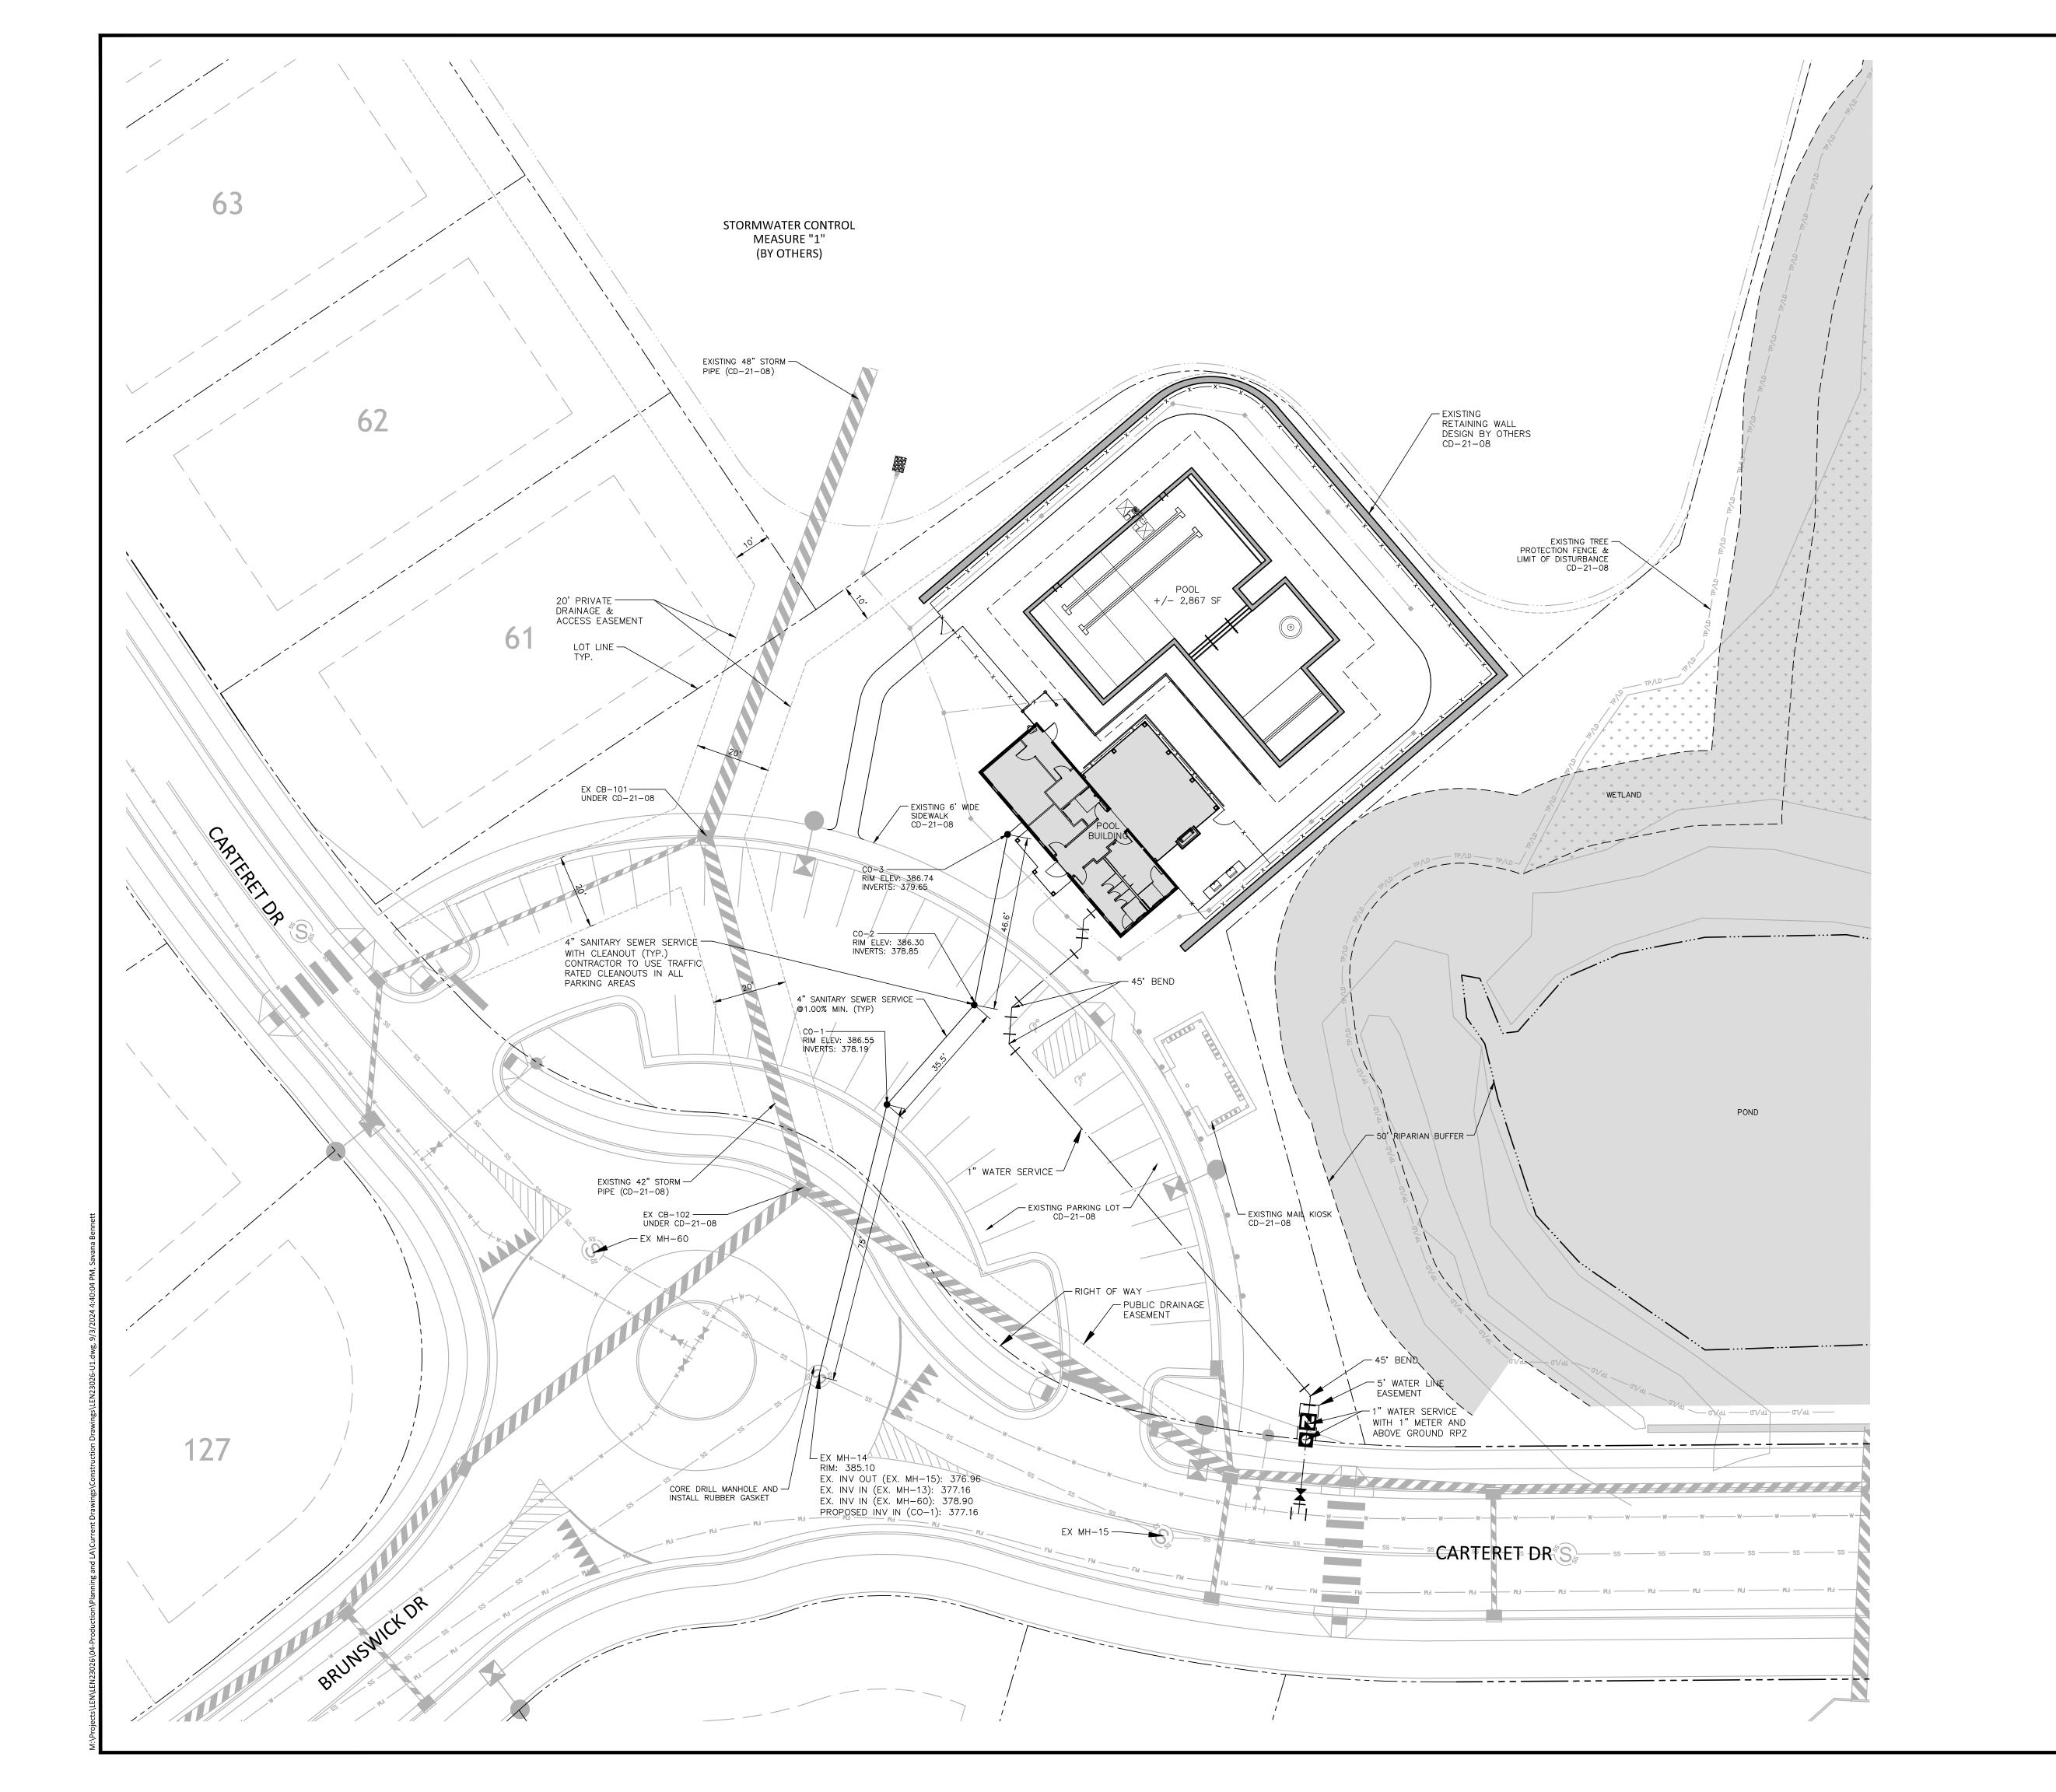

UTILITY LEGEND WATER METER WATER VALVE BACKFLOW PREVENTER SANITARY SEWER MANHOLE SEWER CLEAN-OUT SEWER FLOW DIRECTION ------ WATER SERVICE LINE

---- EASEMENT LINE

SEWER SERVICE LINE



The John R. McAdams Company, Inc. 621 Hillsborough Street Suite 500 Raleigh, NC 27603


phone 919. 361. 5000 fax 919. 361. 2269 license number: C-0293, C-187

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CLIENT

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REVISIONS

NO. DATE

1 09.03.2024 REVISED PER TOWN COMMENTS

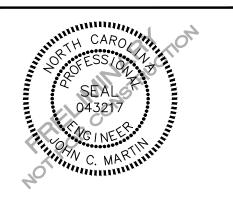PLAN INFORMATION

PROJECT NO. LEN23026 LEN23026-U1 FILENAME CHECKED BY DRAWN BY

SCALE 1" = 20' DATE 07.01.2024


SHEET **AMENITY UTILITY PLAN**

C4.00


PRELIMINARY DRAWING - NOT RELEASED FOR CONSTRUCTION

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TOWN OF ROLESVILLE ENGINEERING AND CONSTRUCTION STANDARDS.

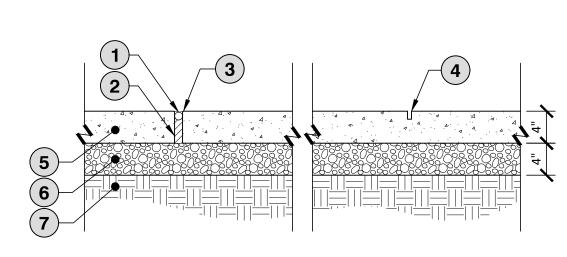

- (1) BACKER ROD (STRAIGHT JOINTS ONLY)
- (2) SEAL PREFORMED FIBER EXPANSION JOINT WITH COLORED JOINT SEALANT/CAULK. COLOR SHALL MATCH ADJACENT CONCRETE AND BE APPROVED BY OWNER'S REPRESENTATIVE
- (3) TOOLED EDGE (1/8" RADIUS)
- (4) SCORE JOINT (TYP) SAW CUT MINIMUM 1/4 DEPTH OF PAVEMENT
- (5) ADJACENT PAVING OR VERTICAL SURFACE
- (6) COMPACTED BASE COURSE MEETING STRUCTURAL AND GEOTECHNICAL REQUIREMENTS
- (7) COMPACTED SUBGRADE MEETING GEOTECHNICAL AND STRUCTURAL REQUIREMENTS

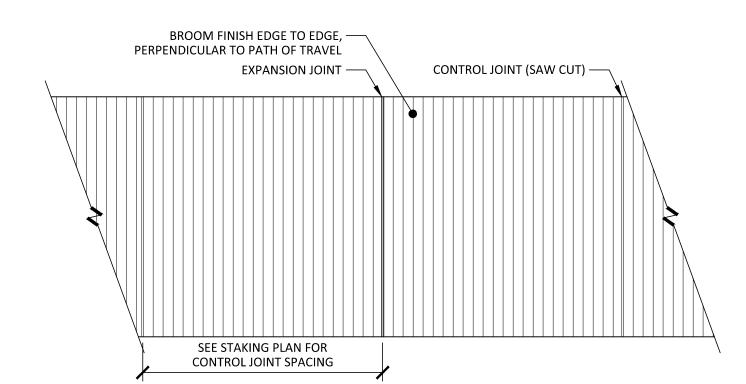

NOTES:


- 1. EXPANSION JOINTS SHALL BE INSTALLED WHERE CONCRETE PAVEMENT ABUTS ALL VERTICAL SURFACES INCLUDING BUT NOT LIMITED TO ALL BUILDINGS, STRUCTURES, STAIRS, CURBS, COLUMNS, WALLS, LIGHT POLES, ETC.
- 2. WHERE WALK ABUTS RIGID STRUCTURE, JOINT SHALL BE WATERTIGHT.
- 3. PROVIDE EXPANSION JOINTS @ 30' O.C. MAX UNLESS OTHERWISE SHOWN/ REQUIRED. (SEE MATERIALS & STAKING PLAN)
- 4. CONTROL JOINT SPACING SHALL BE EQUAL TO SIDEWALK WIDTH BUT IN NO INSTANCE EXCEED 6' SEE MATERIALS & STAKING PLAN FOR ALL OTHER
- 5. SAW CUT TO A MIN. 1/4 DEPTH OF PAVEMENT. CONTRACTOR TO CLOSELY COORDINATE LOCATIONS AND DESIGNS PRIOR TO AND DURING CONSTRUCTION.
- 6. ALL CONCRETE SHALL BE 3,000 PSI UNLESS


JOINT SPACING

OTHERWISE REQUIRED BY PROJECT SPECIFICATIONS.

- 7. CONCRETE AND BASE DEPTH TO BE VERIFIED BY GEOTECHNICAL ENGINEER. DEPTHS MAY BE MODIFIED TO MEET ALL LOADING REQUIREMENTS.
- 8. REFER TO STRUCTURAL FOR CONCRETE REINFORCEMENT.
- 9. REFER TO DETAILED LAYOUT PLAN FOR SIDEWALK LOCATIONS, TYPES AND WIDTHS.
- 10. REFER TO DETAILED LAYOUT PLAN FOR SPECIFIC JOINT LOCATIONS AND SPACING.
- 11. USE THIS DETAIL FOR TYPICAL JOINT SPACING WHEN NO SPECIFIC JOINT SPACING IS INDICATED ON PLANS.
- 12. MAXIMUM SIDEWALK CROSS-SLOPE IS 2%.


O1 TYPICAL CONCRETE SIDEWALK SCALE: 1" = 1'-0"

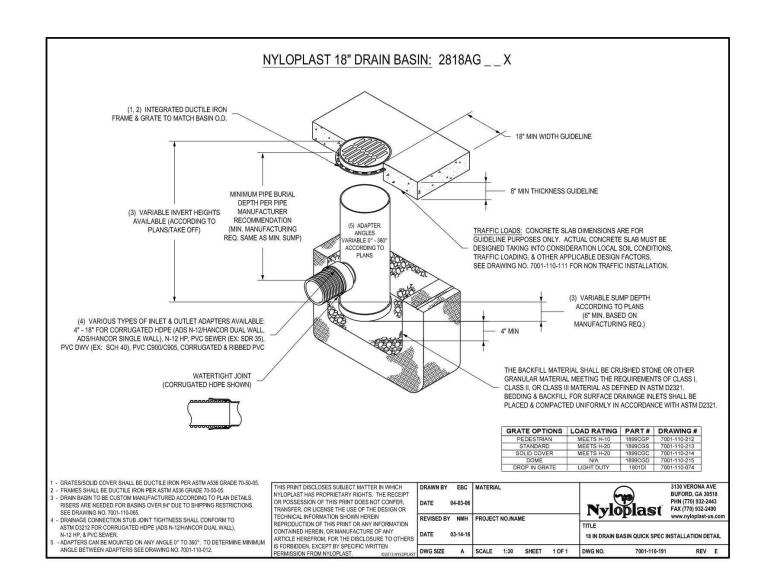


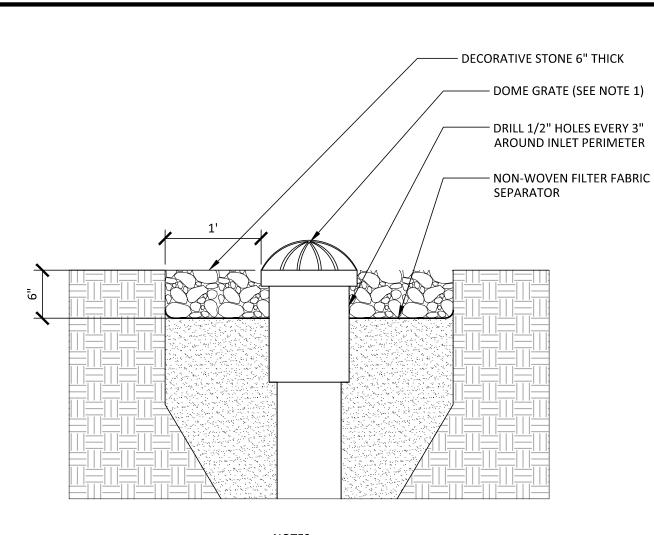

1. SEE MATERIAL & PLANTING SCHEDULE FOR GRATE INFO 2. FOLLOW MANUFACTURERS GUIDELINES FOR MATERIAL REQUIREMENTS AND INSTALLATION METHODS. 3. SEE GRADING PLAN FOR ALL GRATE AND PIPE SIZES

02 LANDSCAPE DRAIN INLET WITH DOME GRATE SCALE: 1" = 1'-0"

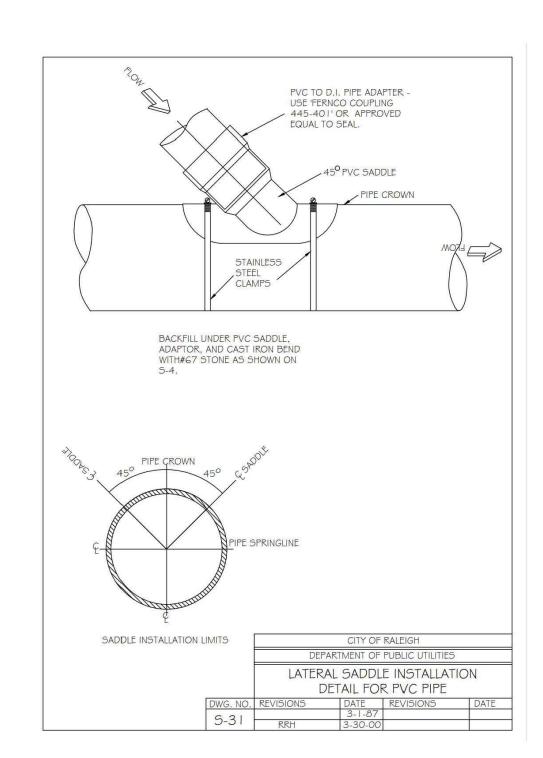


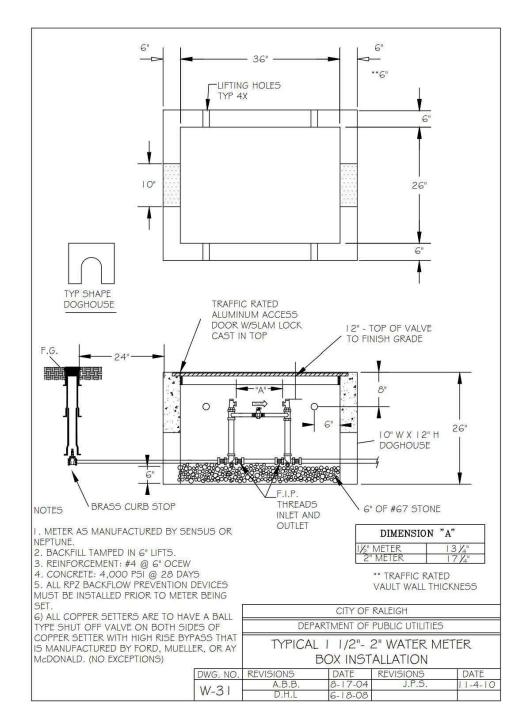



Section 2721 **Engineered Surface Drainage Products** PVC surface drainage inlets shall include the drain basin type as indicated on the contract drawing and referenced within the contract specifications. The ductile iron grates for each of these fittings are to be considered an integral part of the surface drainage inlet and shall be furnished by the same manufacturer. The surface drainage inlets shall be as manufactured by Nyloplast a division of Advanced Drainage Systems, Inc., or prior approved equal. The drain basins required for this contract shall be manufactured from PVC pipe stock, utilizing a thermoforming process to reform the pipe stock to the specified configuration. The drainage pipe connection stubs shall be manufactured from PVC pipe stock and formed to provide a watertight connection with the specified pipe system. This joint tightness shall conform to ASTM D3212 for joints for drain and sewer plastic pipe using flexible elastomeric seals. The flexible elastomeric seals shall conform to ASTM F477. The pipe bell spigot shall be joined to the main body of the drain basin or catch basin. The raw material used to manufacture the pipe stock that is used to manufacture the main body and pipe stubs of the surface drainage inlets shall conform to ASTM D1784 cell class 12454. The grates and frames furnished for all surface drainage inlets shall be ductile iron for sizes 8", 10", 12", 15", 18", 24" and 30" and shall be made specifically for each basin so as to provide a round bottom flange that closely matches the diameter of the surface drainage inlet. Grates for drain basins shall be capable of supporting various wheel loads as specified by Nyloplast, 12" and 15" square grates will be hinged to the frame using pins. Ductile iron used in the manufacture of the castings shall conform to <u>ASTM A536 grade 70-50-05</u>. Grates and covers shall be provided painted black. The specified PVC surface drainage inlet shall be installed using conventional flexible pipe backfill materials and procedures. The backfill material shall be crushed stone or other granular material meeting the requirements of class 1, class 2, or class 3 material as defined in ASTM D2321. Bedding and backfill for surface drainage inlets shall be well placed and compacted uniformly in accordance with ASTM D2321. The drain basin body will be cut at the time of the final grade. No brick, stone or concrete block will be required to set the grate to the final grade height. For load rated installations, a concrete slab shall be poured under and around the grate and frame. The concrete slab must be designed taking into consideration local soil conditions, traffic loading, and other applicable design factors. For other installation considerations such as migration of fines, ground water, and soft foundations refer to ASTM D2321 guidelines.


THIS PRINT DISCLOSES SUBJECT MATTER IN WHICH DRAWN BY CJA MATERIA


NYLOPLAST HAS PROPRIETARY RIGHTER IN WHILE IN WHILE IN THE RECEIPT OR POSSESSION OF THIS PRINT DOES NOT CONFER, TRANSED OR LOCALISE THE LIFE OF THE DESIGN OF

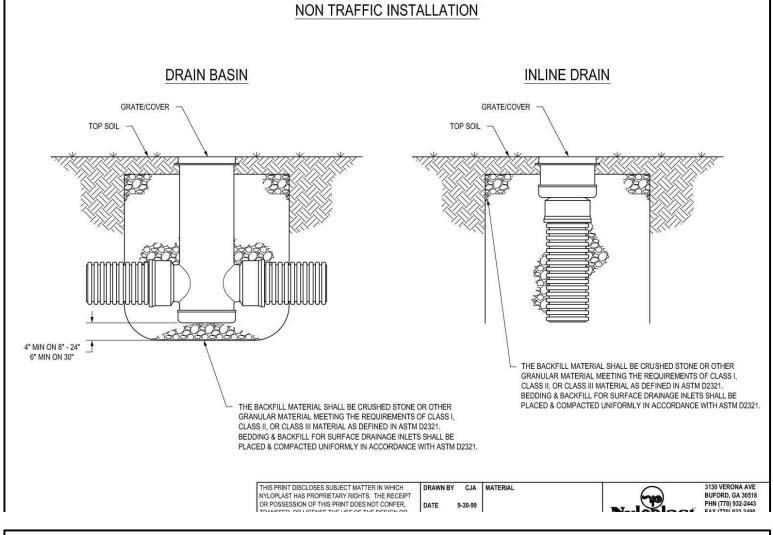


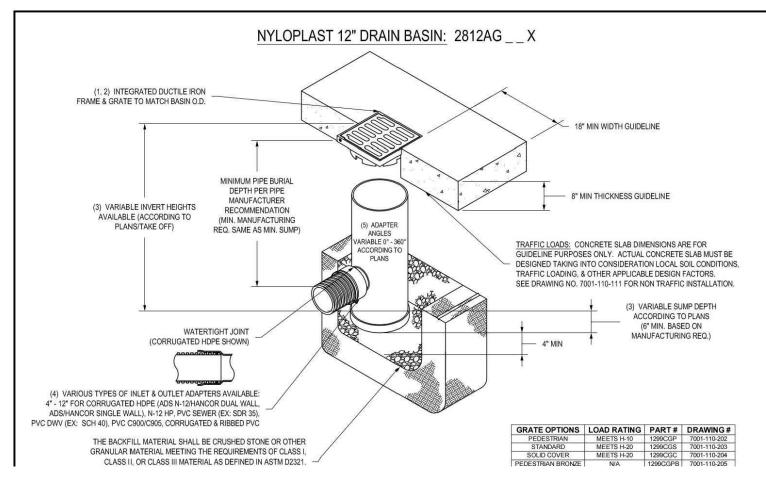

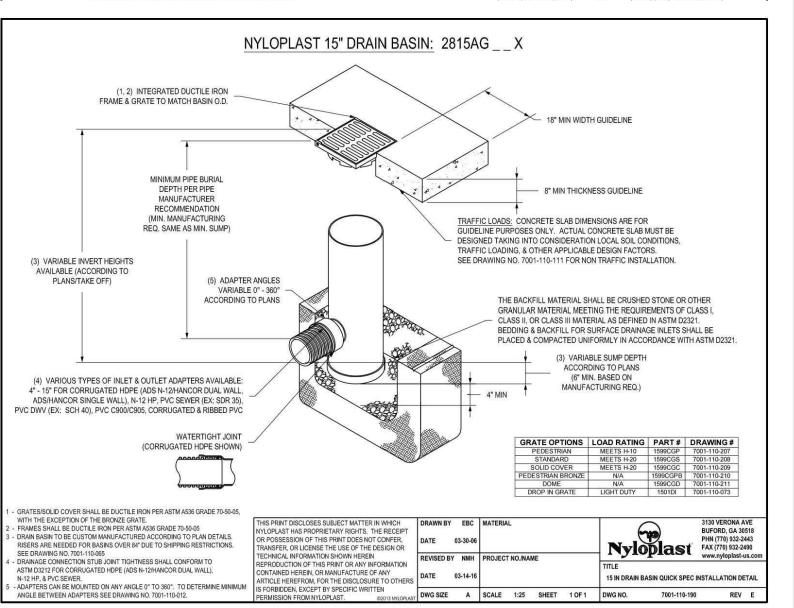

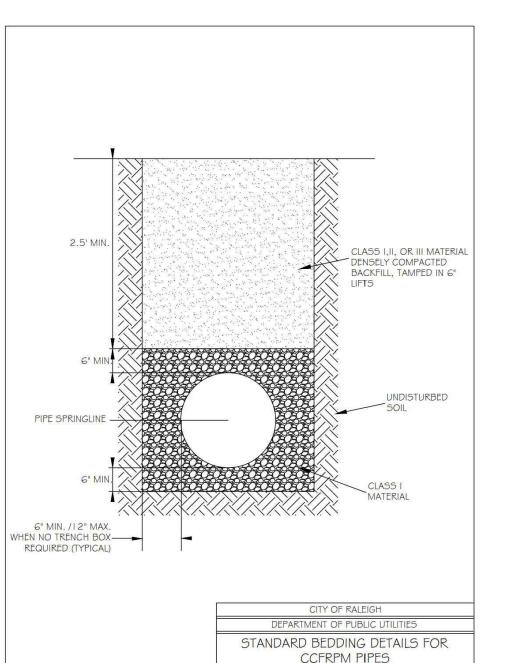

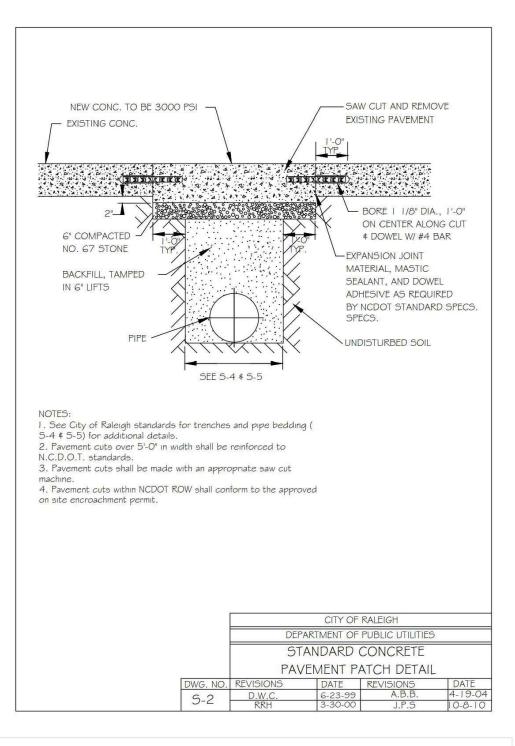

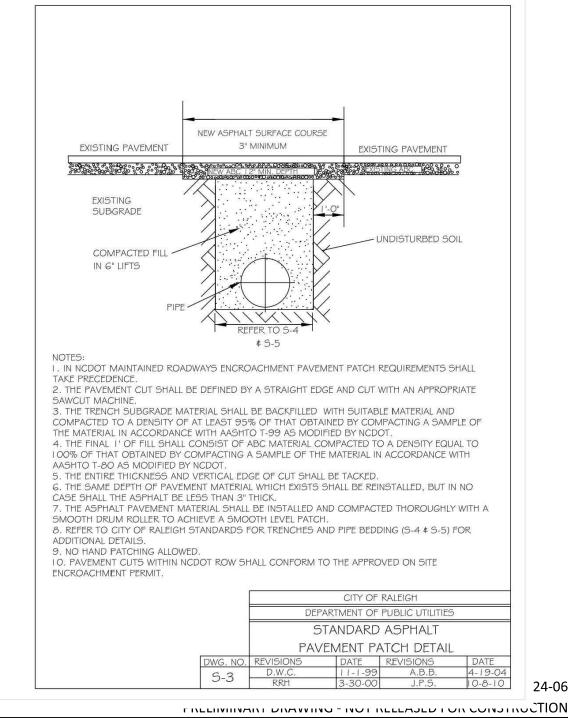



The John R. McAdams Company, Inc. 621 Hillsborough Street Suite 500 Raleigh, NC 27603

phone 919. 361. 5000 fax 919. 361. 2269 license number: C-0293, C-187

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CLIENT


LENNAR

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REVISIONS

NO. DATE


1 09.03.2024 REVISED PER TOWN COMMENTS

PLAN INFORMATION

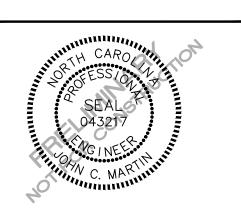
PROJECT NO. LEN23026 FILENAME LEN23026-D1 CHECKED BY JAR DRAWN BY **SCALE** AS SHOWN 07.01.2024

SHEET


SITE AND UTILITY DETAILS

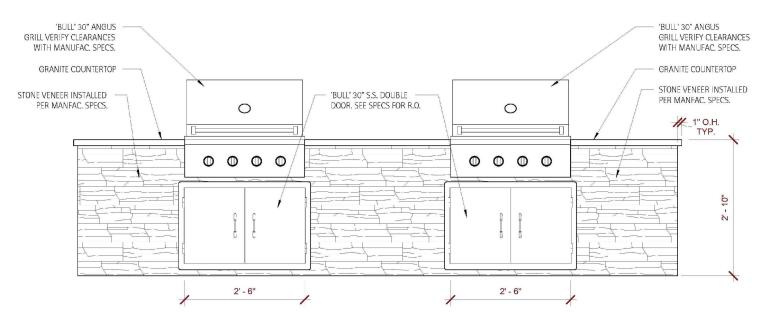


GRILL FRONT ELEVATION

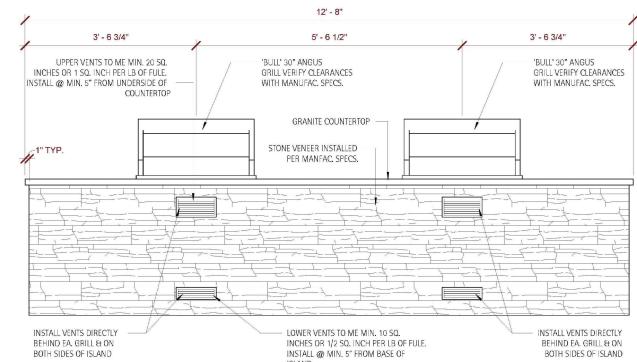


GRILL REAR ELEVATION

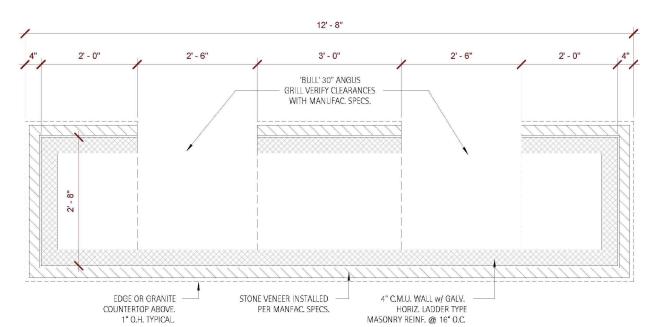


GRILL ISLAND PLAN VIEW

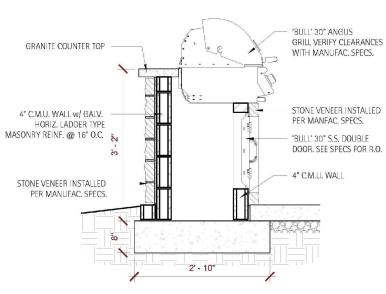


GRILL ISLAND SCALE: 1/2"=1'-0"

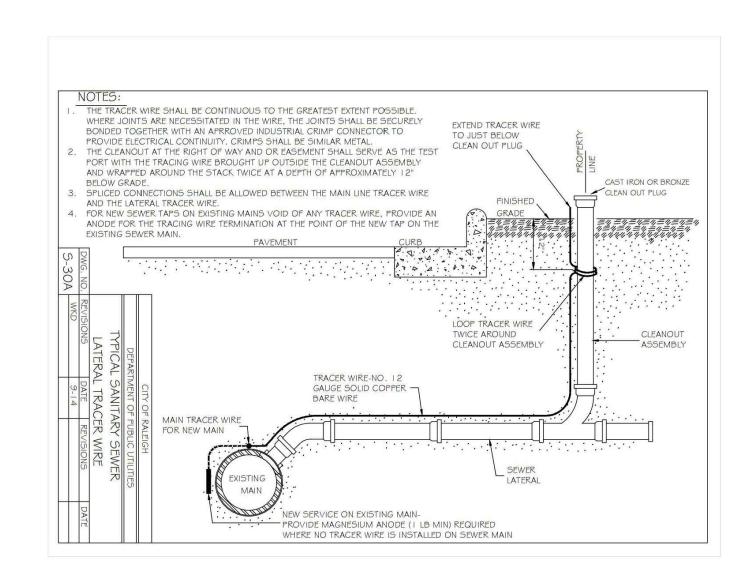


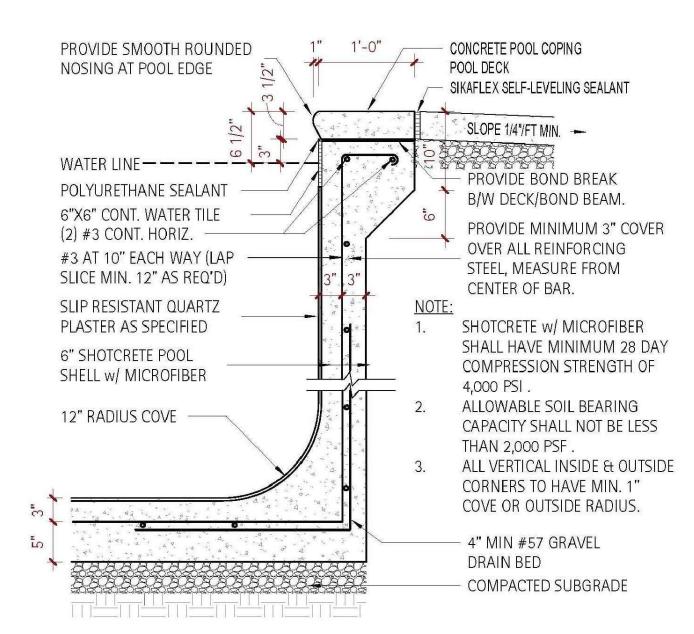

POOL COPING SCALE: 1"=1'-0"

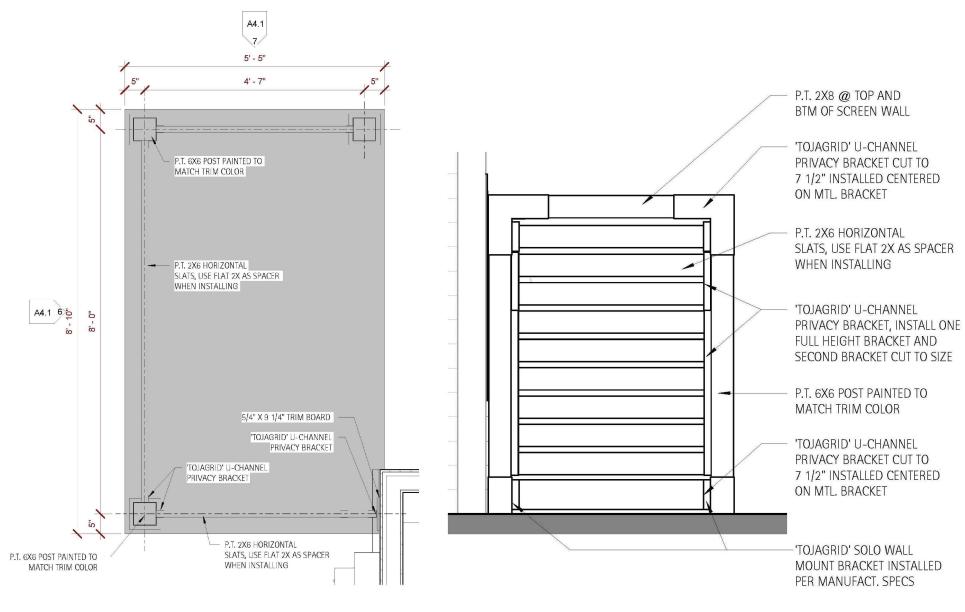


TRASH CORRAL SIDE ELEVATION CORRAL FLOOR PLAN

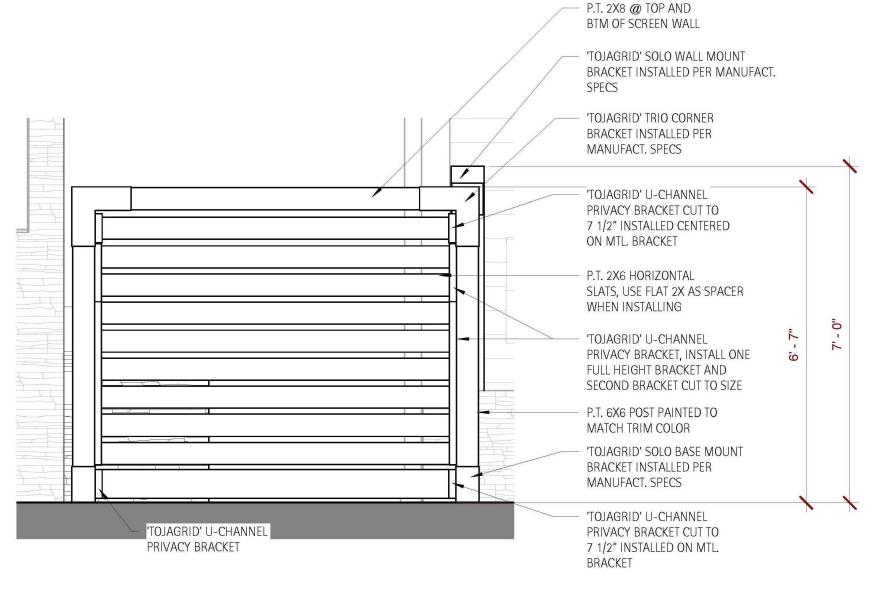

TRASH CORRAL FRONT ELEVATION


TRASH CORRAL


SCALE: 1/2"=1'-0"

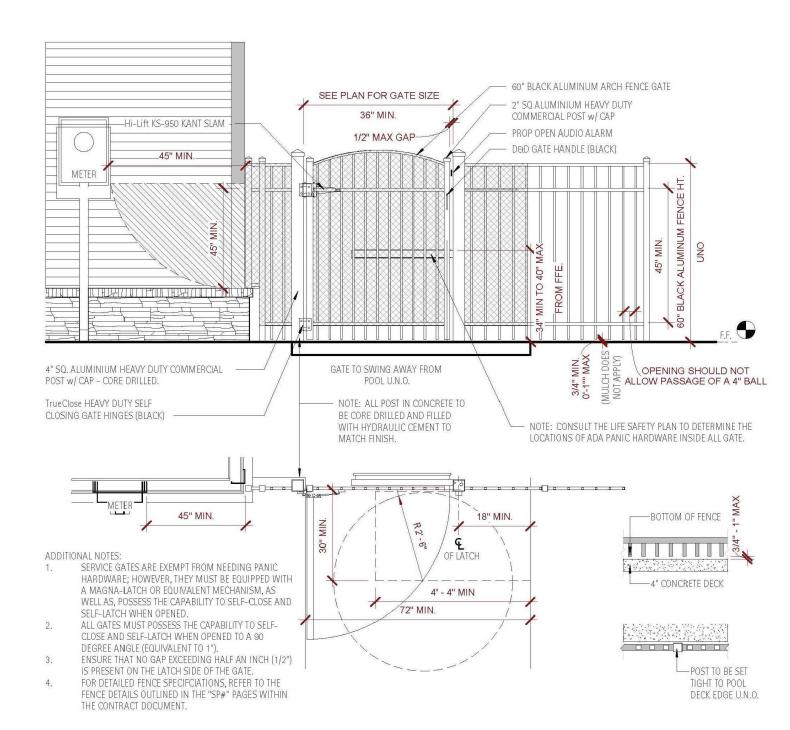

06 POOL FENCE AND GATE SCALE: 1/2"=1'-0"

1. DETAILS FROM OTHERS, FOR REFERENCE ONLY.

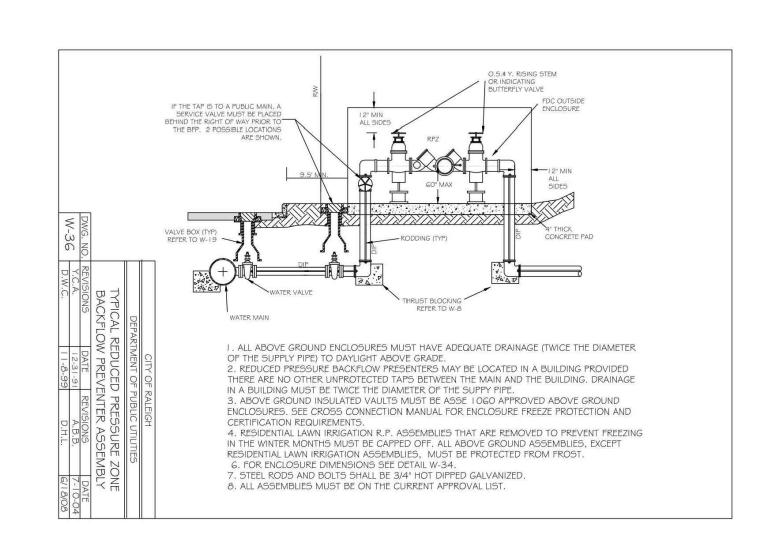

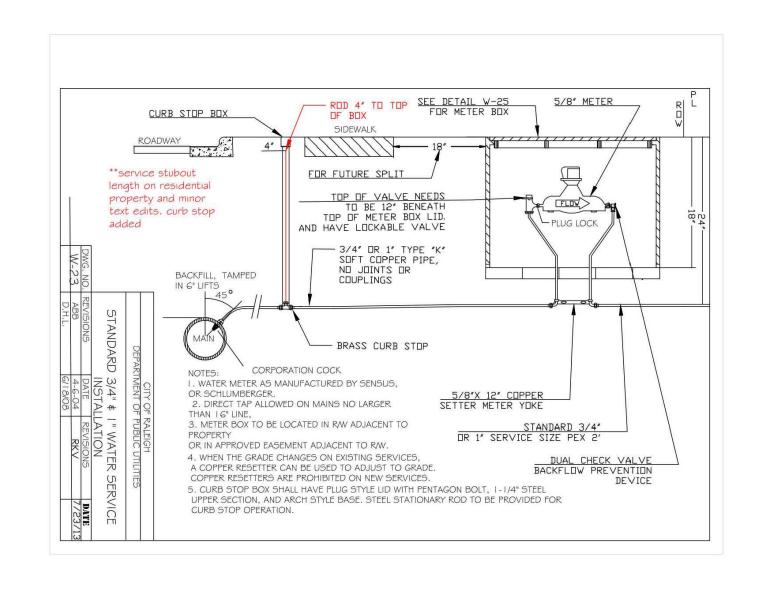



The John R. McAdams Company, Inc

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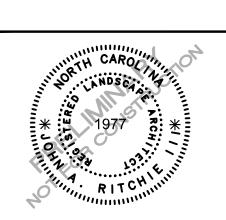
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CLIENT

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SSING



REVISIONS


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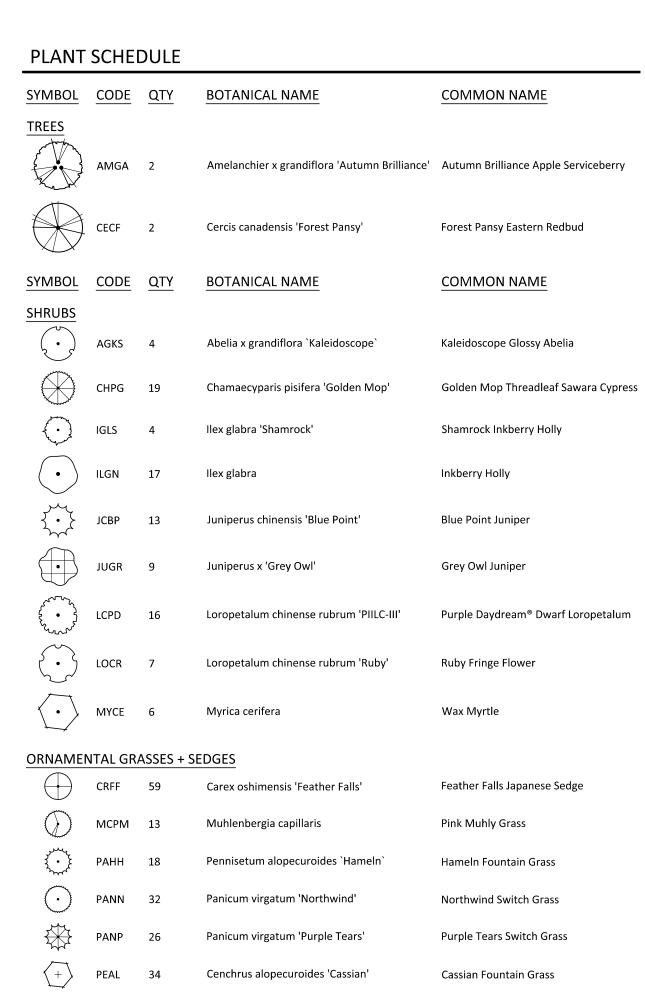
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PLAN INFORMATION

PROJECT NO. LEN23026 FILENAME LEN23026-D1 CHECKED BY JAR DRAWN BY SCALE AS SHOWN DATE 07.01.2024

SHEET SITE DETAILS



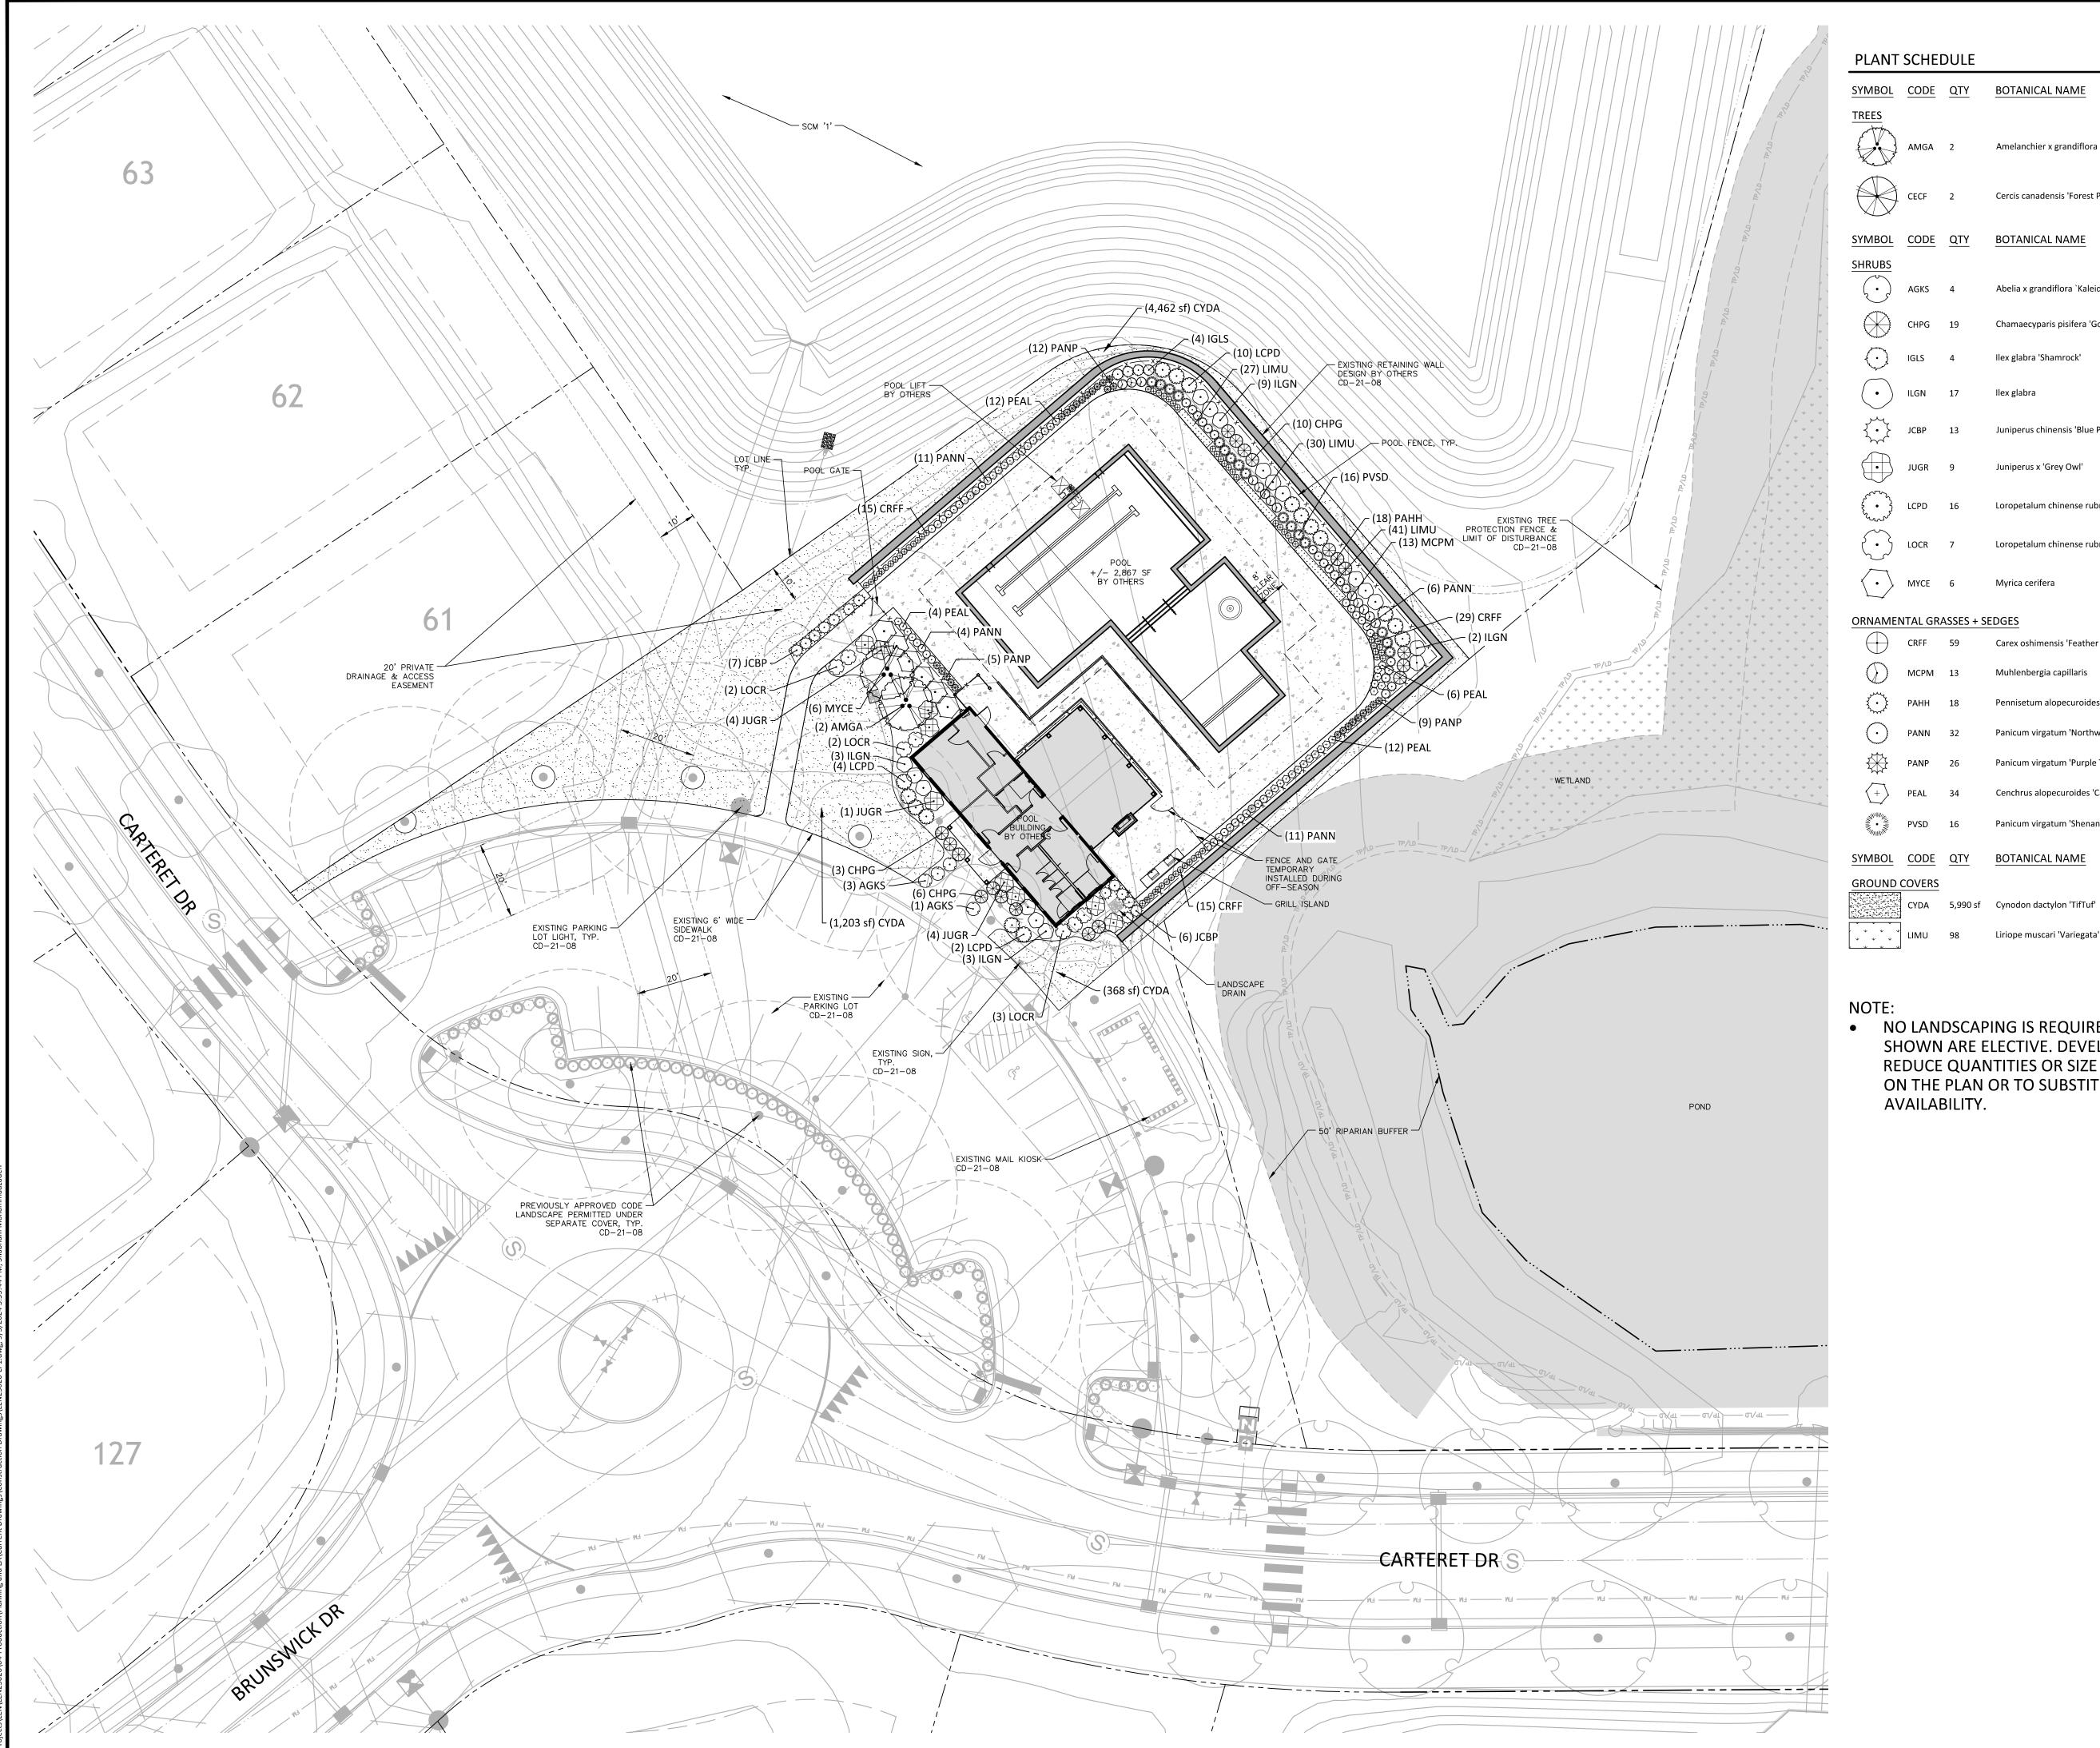

 NO LANDSCAPING IS REQUIRED PER LDO. ALL PLANTINGS SHOWN ARE ELECTIVE. DEVELOPER RESERVES THE RIGHT TO REDUCE QUANTITIES OR SIZE OF PLANT MATERIALS DEPICTED ON THE PLAN OR TO SUBSTITUTE SPECIFIC SPECIES BASED ON AVAILABILITY.

Panicum virgatum 'Shenandoah'

BOTANICAL NAME


Liriope muscari 'Variegata'

Shenandoah Switch Grass

COMMON NAME

Bermuda 'TifTuf'

Variegated Lilyturf

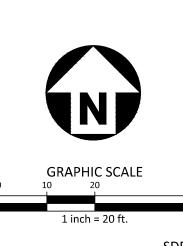

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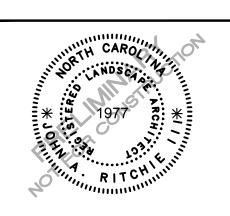
CLIENT

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MORRISVILLE, NC 27560

LENNAR®

SSING



REVISIONS

NO. DATE


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PLAN INFORMATION


PROJECT NO. LEN23026 FILENAME CHECKED BY DRAWN BY SCALE DATE 07.01.2024

SHEET **AMENITY LANDSCAPE**


PLAN

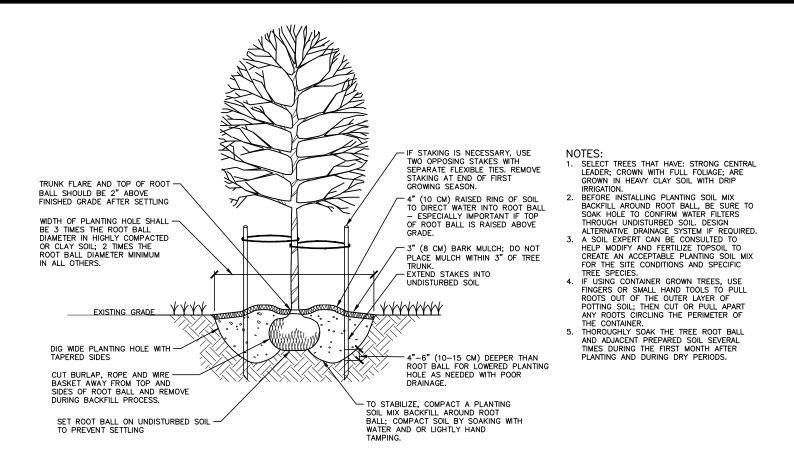


1 TREE INSTALLATION

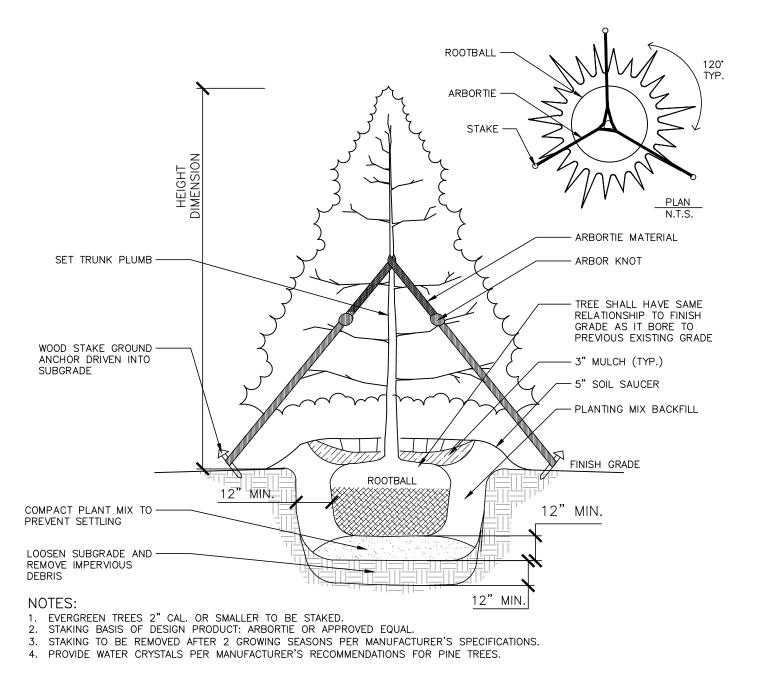


02 EVERGREEN TREE INSTALLATION SCALE: NTS

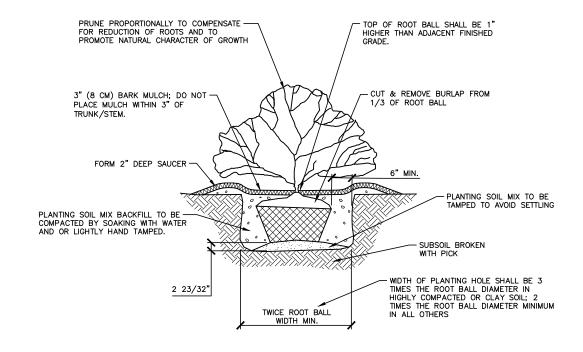

12 SHRUB INSTALLATION

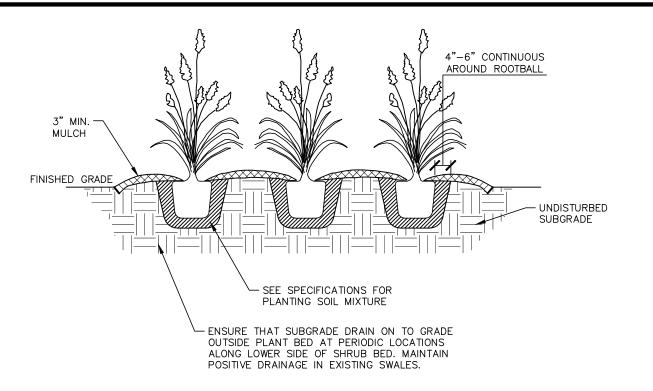

ORNAMENTAL GRASS PLANTING SCALE: NTS

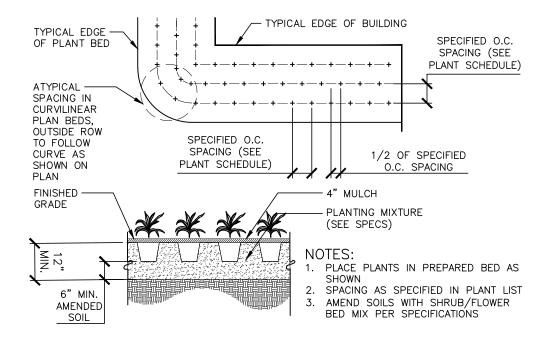

O5 GROUNDCOVER PLANTING SCALE: NTS

PLANT SCHEDULE						
SYMBOL	CODE	<u>QTY</u>	BOTANICAL NAME	COMMON NAME	CAL	HEIGHT
TREES						
	AMGA	2	Amelanchier x grandiflora 'Autumn Brilliance'	Autumn Brilliance Apple Serviceberry	-	8` min
	CECF	2	Cercis canadensis 'Forest Pansy'	Forest Pansy Eastern Redbud	2" min	8` min
SYMBOL	CODE	QTY	BOTANICAL NAME	COMMON NAME	CONT	HEIGHT
SHRUBS						
$\left(\begin{array}{c} \cdot \\ \cdot \end{array}\right)$	AGKS	4	Abelia x grandiflora `Kaleidoscope`	Kaleidoscope Glossy Abelia	#3	12" min
	CHPG	19	Chamaecyparis pisifera 'Golden Mop'	Golden Mop Threadleaf Sawara Cypress	#3	15" min
\bigcirc	IGLS	4	llex glabra 'Shamrock'	Shamrock Inkberry Holly	5 gal	24" min
•	ILGN	17	llex glabra	Inkberry Holly	#3	18" min
\.\\\\\\\\\\\\\\\\\\\\\\\\\\\\\\\\\\\\	JCBP	13	Juniperus chinensis 'Blue Point'	Blue Point Juniper	-	48" - 60"
	JUGR	9	Juniperus x 'Grey Owl'	Grey Owl Juniper	#5	18" min
	LCPD	16	Loropetalum chinense rubrum 'PIILC-III'	Purple Daydream® Dwarf Loropetalum	3 gal	12" min
	LOCR	7	Loropetalum chinense rubrum 'Ruby'	Ruby Fringe Flower	#3	15" min
•	MYCE	6	Myrica cerifera	Wax Myrtle	#10	36" min
ORNAMENTAL GRASSES + SEDGES						
	CRFF	59	Carex oshimensis 'Feather Falls'	Feather Falls Japanese Sedge	3 gal	
\bigcirc	МСРМ	13	Muhlenbergia capillaris	Pink Muhly Grass	3 gal	
3.0	PAHH	18	Pennisetum alopecuroides 'Hameln'	Hameln Fountain Grass	3 gal	
\odot	PANN	32	Panicum virgatum 'Northwind'	Northwind Switch Grass	1 gal	
	PANP	26	Panicum virgatum 'Purple Tears'	Purple Tears Switch Grass	3 gal	
+	PEAL	34	Cenchrus alopecuroides 'Cassian'	Cassian Fountain Grass	1 gal	
	PVSD	16	Panicum virgatum 'Shenandoah'	Shenandoah Switch Grass	3 gal	
SYMBOL	CODE	QTY	BOTANICAL NAME	COMMON NAME	CONT	
GROUND COVERS						
	CYDA	5,990 sf	Cynodon dactylon 'TifTuf'	Bermuda 'TifTuf'	Sod	
\ \ \ \ \ \ \ \ \ \ \ \ \ \ \ \ \ \ \	LIMU	98	Liriope muscari 'Variegata'	Variegated Lilyturf	Seed	

GENERAL LANDSCAPE NOTES:

BEFORE BEGINNING DEMOLITION OR INSTALLATION.

- 1. ALL MATERIALS AND METHODS OF CONSTRUCTION SHALL BE IN ACCORDANCE WITH THE CITY OF ROLESVILLE AND THE STATE OF NORTH CAROLINA STANDARDS AND SPECIFICATIONS
- 2. CONTRACTOR IS RESPONSIBLE FOR THE SITE INSPECTION BEFORE LANDSCAPE CONSTRUCTION AND INSTALLATION IN ORDER TO BECOME FAMILIAR WITH THE EXISTING
- LANDSCAPE CONTRACTOR IS RESPONSIBLE FOR LOCATING ALL UNDERGROUND UTILITIES
- 4. CONTRACTOR SHALL NOTIFY LANDSCAPE ARCHITECT OF ANY DISCREPANCIES BETWEEN THE NOTES, SPECIFICATIONS, DRAWINGS OR SITE CONDITIONS FOR RESOLUTION PRIOR TO INSTALLATION
- 5. ANY DAMAGE TO UTILITIES SHALL BE REPAIRED AT THE CONTRACTOR'S EXPENSE.
- 6. THIS PLAN IS FOR PLANTING PURPOSES ONLY. FOR INFORMATION REGARDING BUILDINGS, GRADING, WALLS, ETC., REFER TO ARCHITECTURE, SITE AND GRADING PLANS.
- 7. VERIFICATION OF TOTAL PLANT QUANTITIES AS SHOWN IN THE PLANT SCHEDULE SHALL BE THE RESPONSIBILITY OF THE LANDSCAPE CONTRACTOR. ANY DISCREPANCIES SHALL BE BROUGHT TO THE ATTENTION OF THE LANDSCAPE ARCHITECT.
- 8. CONTRACTOR TO ENSURE PROPER STABILIZATION AND SEEDING OF THE SITE IN ACCORDANCE WITH APPLICABLE REGULATIONS.
- 9. LANDSCAPE MATERIAL SHALL BE WELL FORMED, VIGOROUS, GROWING SPECIMENS WITH GROWTH TYPICAL OF VARIETIES SPECIFIED AND SHALL BE FREE FROM DAMAGE, INSECTS AND DISEASES. MATERIAL SHALL EQUAL OR SURPASS #1 QUALITY AS DEFINED IN THE CURRENT ISSUE OF "AMERICAN STANDARD FOR NURSERY STOCK" AS PUBLISHED BY THE AMERICAN NURSERY & LANDSCAPE ASSOCIATION.
- 10. ALL PLANT MATERIAL IS TO BE CAREFULLY HANDLED BY THE ROOT BALL, NOT THE TRUNK, BRANCHES AND/OR FOLIAGE OF THE PLANT. MISHANDLED PLANT MATERIAL MAY BE REJECTED BY THE LANDSCAPE ARCHITECT.
- 11. ALL PLANT MATERIAL IS TO BE WELL ROOTED, NOT ROOT BOUND, SUCH THAT THE ROOT BALL REMAINS INTACT THROUGHOUT THE PLANTING PROCESS. DEFICIENT PLANT MATERIAL
- 12. ALL PLANTS TO BE A MINIMUM OF WHAT IS SPECIFIED IN THE PLANT SCHEDULE. ANY CHANGES OR SUBSTITUTIONS SHALL BE APPROVED BY THE LANDSCAPE ARCHITECT AND GOVERNING JURISDICTION PRIOR TO ANY HOLE BEING DUG.
- 13. CONTRACTOR TO COORDINATE WITH OWNER'S REPRESENTATIVE AND LANDSCAPE
 ARCHITECT TO ESTABLISH THE EXTENTS OF MULCH/SEED/SOD IF NOT SPECIFICALLY SHOWN
 ON PLANS
- 14. CONTRACTOR SHALL PROVIDE POSITIVE DRAINAGE IN ALL PLANTING AREAS.

MAY BE REJECTED BY THE LANDSCAPE ARCHITECT OR OWNER.

15. PROPOSED TREES TO BE PLANTED A MINIMUM 10 FEET FROM ANY LIGHT POLE AS MEASURED FROM TRUNK OF THE TREE TO THE POLE.

OR OTHER EXTRANEOUS MATERIAL.

SOIL PROFILES

- PROPOSED TREES TO BE PLANTED A MINIMUM 5 FEET FROM ANY FIRE HYDRANT AS MEASURED FROM TRUNK OF THE TREE TO THE HYDRANT.
- 17. CONTRACTOR SHALL COMPLETE SOIL TEST IN ALL PLANTING AREAS TO DETERMINE SOIL AMENDMENT REQUIREMENTS UNLESS WAIVED BY OWNER'S REPRESENTATIVE.
- CONTRACTOR SHALL ADJUST PH AND FERTILITY BASED UPON THE SOIL TEST RESULTS.

 18. TOPSOIL SHALL BE FREE OF MATERIAL LARGER THAN 1.0 INCH IN DIAMETER OR LENGTH AND SHALL NOT CONTAIN SLAG, CINDERS, STONES, LUMPS OF SOIL, STICKS, ROOTS, TRASH,
- 19. LOOSEN SUBGRADE / SURFACE SOIL TO A MINIMUM DEPTH OF 6 INCHES. APPLY SOIL AMENDMENTS AND FERTILIZERS AS REQUIRED BY THE SOIL TEST RESULTS TO ACHIEVE A HEALTHY GROWING MEDIA AND MIX THOROUGHLY INTO TOP 4 INCHES OF SOIL. SPREAD PLANTING SOIL MIX TO A DEPTH OF 6 INCHES BUT NOT LESS THAN REQUIRED TO MEET FINISH GRADES AFTER NATURAL SETTLEMENT. DO NOT SPREAD IF PLANTING SOIL OR SUBGRADE IS FROZEN, MUDDY, OR EXCESSIVELY WET.
- 20. IF IMPORTED TOPSOIL IS REQUIRED, THE SUBGRADE SHALL BE SCARIFIED OR TILLED TO A DEPTH OF AT LEAST 6 INCHES PRIOR TO INSTALLATION OF IMPORTED TOPSOIL. FOLLOWING INSTALLATION OF IMPORTED TOPSOIL, THE TOPSOIL SHALL BE TILLED TO INTEGRATE THE
- 21. PLANT MATERIALS ARE TO BE GUARANTEED FOR A PERIOD OF 12 MONTHS. PLANT MATERIALS WHICH REMAIN UNHEALTHY WILL BE REPLACED BY THE LANDSCAPE CONTRACTOR BEFORE THE EXPIRATION OF THE GUARANTEE PERIOD OR IMMEDIATELY IF SO DIRECTED BY THE OWNER'S REPRESENTATIVE OR LANDSCAPE ARCHITECT.
- 22. ALL TREE PLANTINGS SHALL BE MULCHED TO A DEPTH OF 3 INCHES, AND WITH A MINIMUM 3 FOOT RADIUS FROM BASE OF TREE OR TO DRIPLINE. MULCH SHALL BE FREE OF TRASH AND MAINTAINED WEED FREE. MULCH SHALL NOT COVER THE ROOT FLARE. CONFIRM MULCH SPECIFICATIONS WITH OWNER'S REPRESENTATIVE OR LANDSCAPE ARCHITECT.
- 23. DO NOT PRUNE TREES AND SHRUBS BEFORE DELIVERY. PROTECT BARK, BRANCHES, AND ROOT SYSTEMS FROM SUN SCALD, DRYING, SWEATING, WHIPPING, AND OTHER HANDLING AND TYING DAMAGE. DO NOT BEND OR BIND-TIE TREES OR SHRUBS IN SUCH A MANNER AS TO DESTROY THEIR NATURAL SHAPE. PROVIDE PROTECTIVE COVERING OF EXTERIOR PLANTS DURING DELIVERY. DO NOT DROP EXTERIOR PLANTS DURING DELIVERY AND HANDLING.
- 24. DELIVER EXTERIOR PLANTS AFTER PREPARATIONS FOR PLANTING HAVE BEEN COMPLETED AND INSTALL IMMEDIATELY. IMMEDIATELY AFTER UNLOADING, STAND THE TREES UP TO REDUCE THE RISK OF SUN SCALD. PROPERLY STAGED TREES ARE STANDING, UNTIED AND SPACED. UNLESS IMMEDIATELY INSTALLED, SET EXTERIOR PLANTS AND TREES IN SHADE, PROTECT FROM WEATHER AND MECHANICAL DAMAGE, AND KEEP ROOTS MOIST.
- 25. SEE LANDSCAPE DETAILS FOR TREE STAKING REQUIREMENTS.
- 26. EXCAVATE EDGES OF ALL PLANTING BEDS TO 2 INCH DEPTH TO FORM A NEAT AND CRISP
- 27. CONTRACTOR SHALL REMOVE DEBRIS AND FINE GRADE ALL PLANTING AREAS PRIOR TO
- 28. REMOVE GUY WIRES AND STAKES AT END OF WARRANTY PERIOD OR ESTABLISHMENT.
- 29. FINISH GRADING: GRADE PLANTING AREAS TO A SMOOTH, UNIFORM SURFACE PLANE WITH LOOSE, UNIFORMLY FINE TEXTURE. GRADE TO WITHIN PLUS OR MINUS 1/2 INCH OF FINISH ELEVATION. ROLL AND RAKE, REMOVE RIDGES, AND FILL DEPRESSIONS TO MEET FINISH GRADES. LIMIT FINISHED GRADING TO AREAS THAT CAN BE PLANTED IN THE IMMEDIATE



McAdams

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The John R. McAdams Company, Inc.

phone 919. 361. 5000 fax 919. 361. 2269 license number: C-0293, C-187

www.mcadamsco.com


CLIENT

LENNAR 1100 PERIMETER PARK DRIVE, SUITE 112

MORRISVILLE, NC 27560



ROLESVILLE CROSSING AMENITY CENTER CONSTRUCTION DRAWINGS 1801 ROLESVILLE RD ROLESVILLE, NC 27587

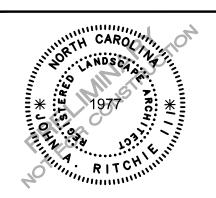

REVISIONS

NO. DATE

1 09.03.2024 REVISED PER TOWN COMMENTS


PLAN INFORMATION

PROJECT NO. LEN23026
FILENAME LEN23026-LP1
CHECKED BY JAR
DRAWN BY SMA
SCALE AS SHOWN
DATE 07.01.2024

SHEET

LANDSCAPE NOTES AND DETAILS

L5.01

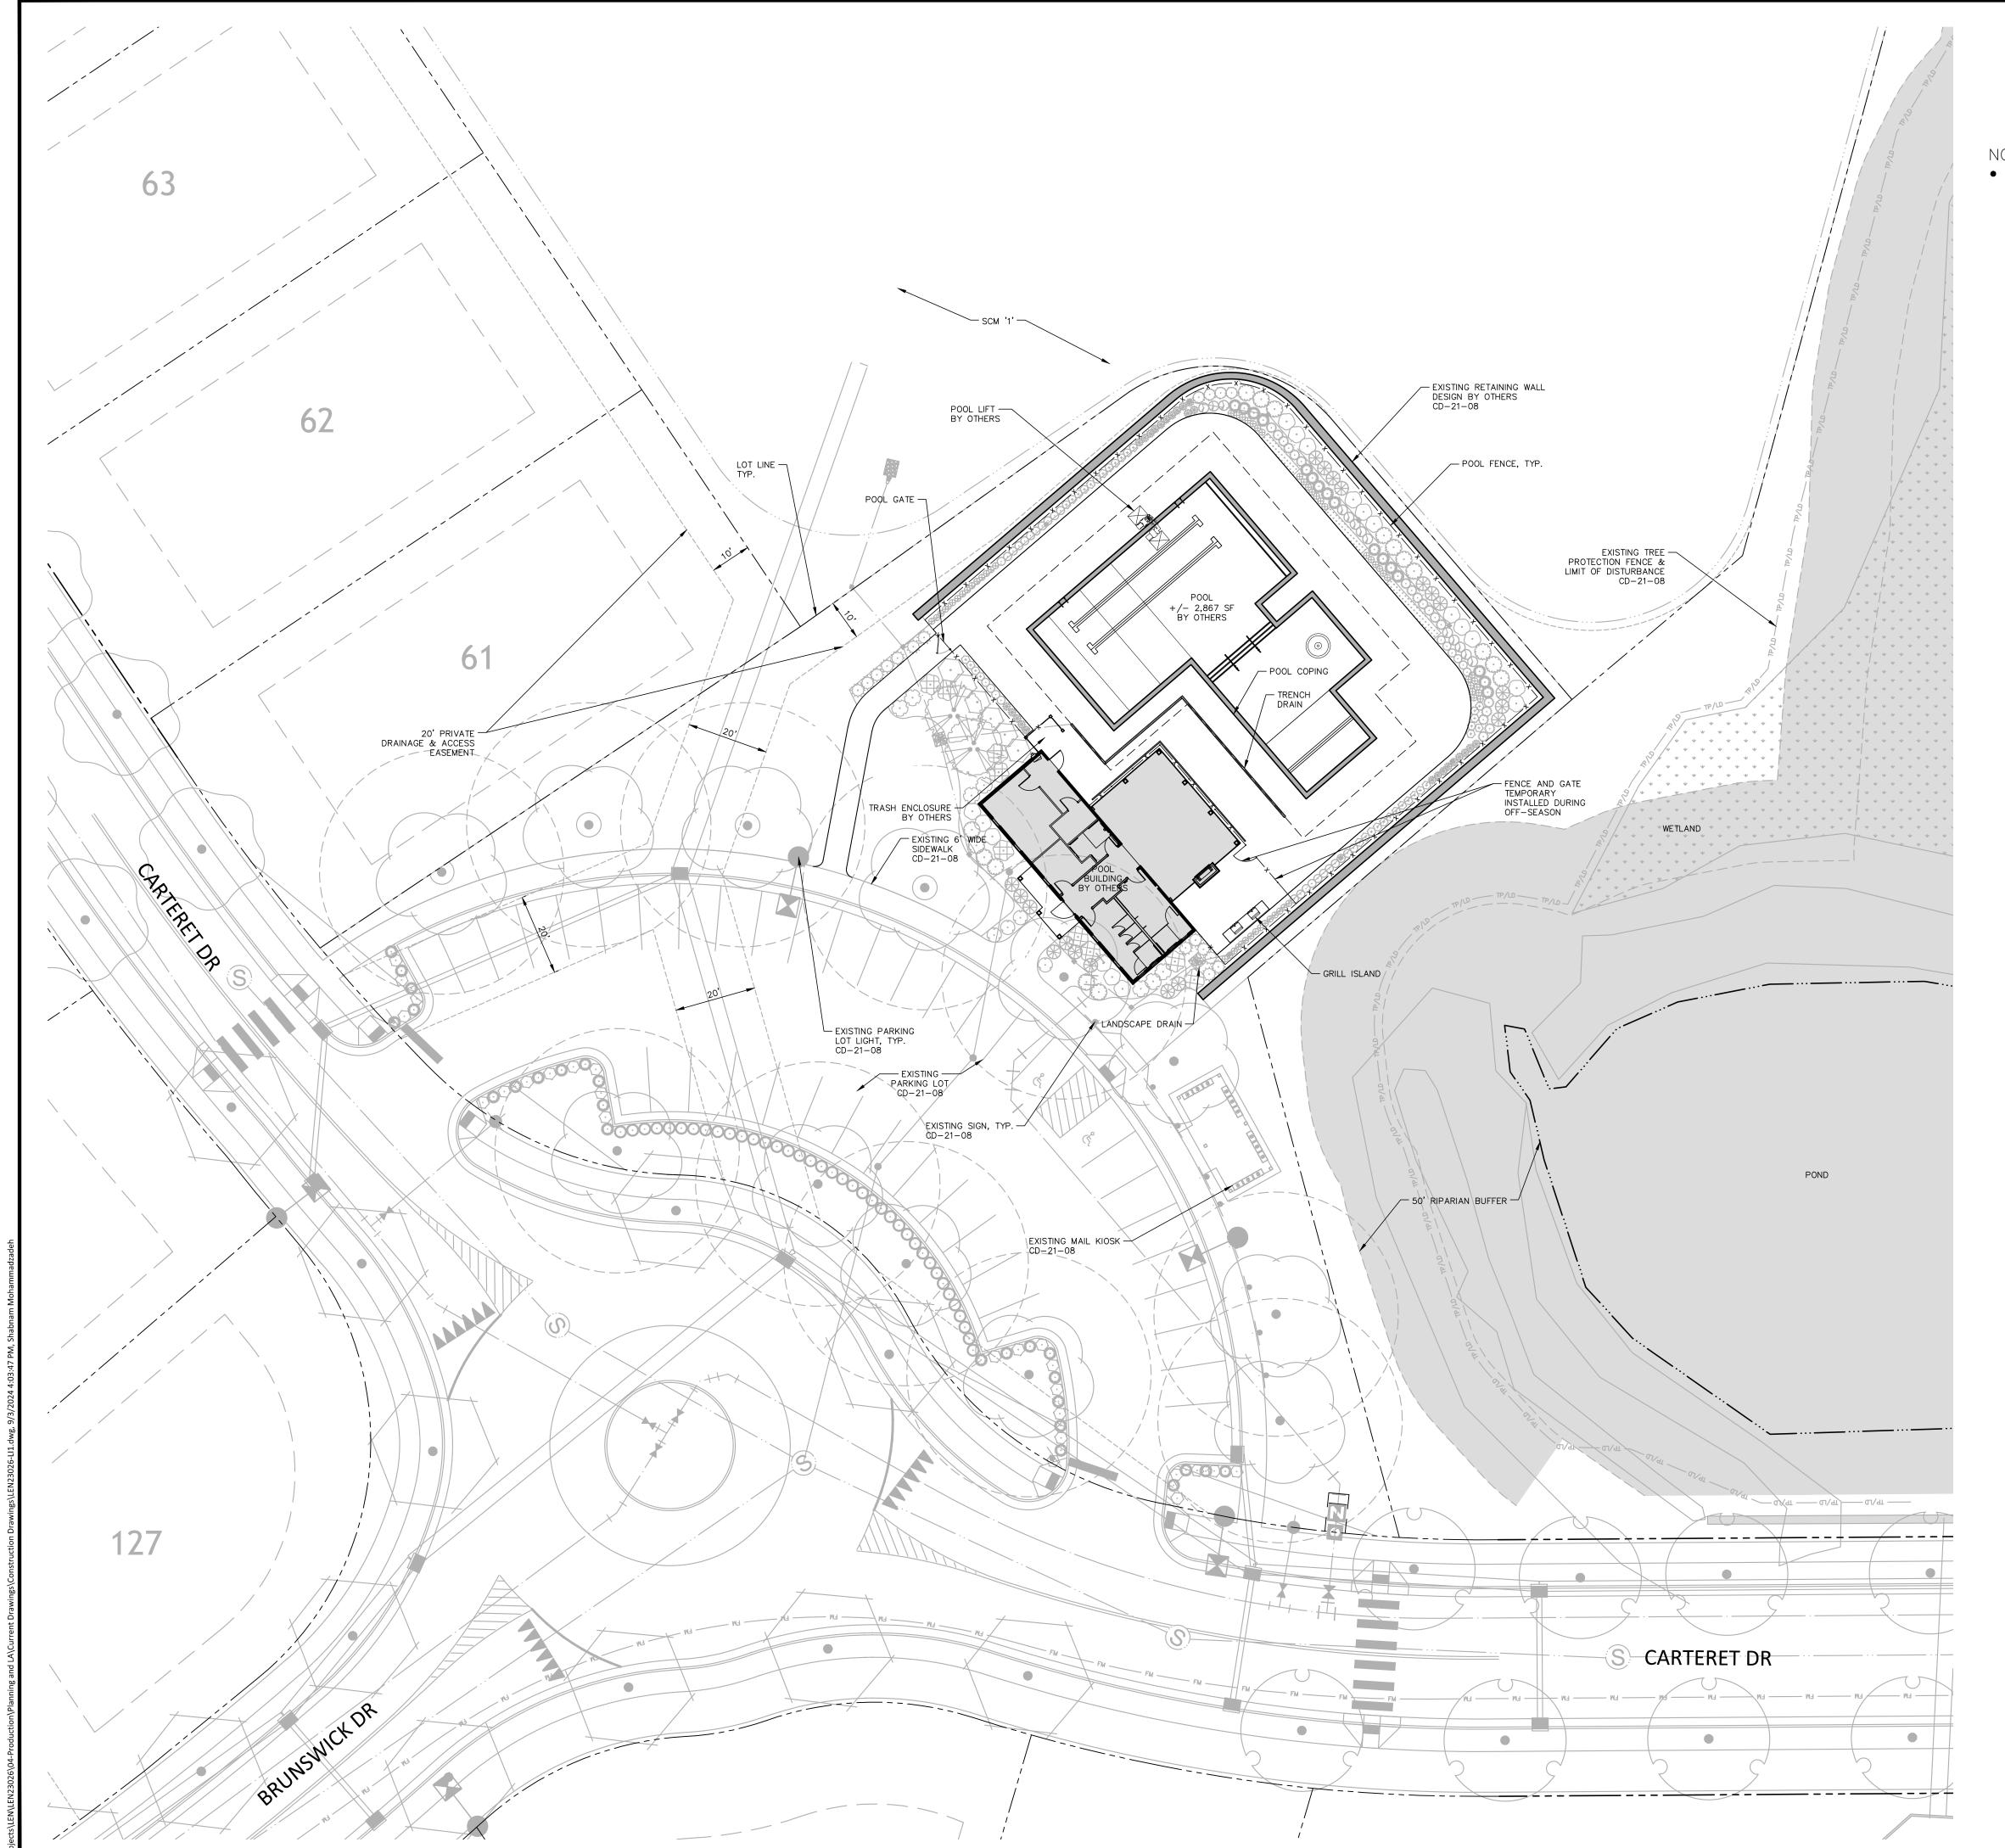



• NO LIGHTING IS PROPOSED FOR THE AMENITY SITE OTHER THAN THE APPROVED PARKING LOT LIGHTS UNDER CD-21-08. THE CLUBHOUSE AND POOL IS NOT INTENDED FOR NIGHT TIME USE.



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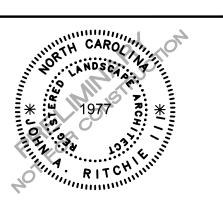
CLIENT

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1100 PERIMETER PARK DRIVE, SUITE 112 MORRISVILLE, NC 27560



AMENITY CENTER STRUCTION DRAWINGS 1801 ROLESVILLE RD



REVISIONS

NO DATE

1 09.03.2024 REVISED PER TOWN COMMENTS

PLAN INFORMATION

PROJECT NO. LEN23026
FILENAME LEN23026-LI1
CHECKED BY JAR
DRAWN BY SMA
SCALE 1" = 20'
DATE 07.01.2024

SHEET

AMENITY LIGHTING PLAN

L6.00

PRELIMINARY DRAWING - NOT RELEASED FOR CONSTRUCTION