

STATE OF NORTH CAROLINA DEPARTMENT OF TRANSPORTATION

J. R. "JOEY" HOPKINS ROY COOPER GOVERNOR SECRETARY

July 15, 2020

COUNTY: Wake

SUBJECT: Application for Driveway Entrance onto US 401 Business

Permit Number D051-092-24-00038

S&S Java Enterprise-Rolesville, LLC 13 Lafoy Drive Clayton, NC 27527

Dear Sir or Madam,

Attached for your file is a copy of the Driveway Permit which you requested.

This permit is approved with the understanding the applicant is responsible for the proper construction of the above drive in accordance with the permit application, approved plans and the attached Standard and Special Provisions.

APPROVAL FOR ACCESS ONLY / ENCROACHMENT AGREEMENT REQUIRED A PERFORMANCE AND INDEMNITY BOND IN THE VALUE OF \$33,000.00 IS **REQUIRED**

Should you have any questions, please contact our office, at (919) 814-6115.

Sincerely,

Daniel T. Boulware, P.E. District Engineer

DTB/TRE Attachment

cc: Mr. B. H. Jones, P. E., Division Engineer

Town of Rolesville

Mailing Address: NC DEPARTMENT OF TRANSPORTATION DIVISION 5 – DISTRICT 1 1575 MAIL SERVICE CENTER RALEIGH, NC 27699-1575

Telephone: (919) 814-6115 Fax: (919) 715-5778

Customer Service: 1-877-368-4968

Location: 4009 DISTRICT DRIVE RALEIGH, NC 27607

Website: www.ncdot.gov

Driveway Permit Special Provisions

- 1. NCDOT reserves the right to further restrict this access at the expense of the encroaching party if/when accident history exists, operational issues occur, the execution and/or operation of said permit is found to be a hazard to the general public, or at the discretion of the District Engineer.
- 2. An executed copy of the agreement, provisions and approved plans shall be present at the construction site at all times. If safety or traffic conditions warrant such an action, NCDOT reserves the right to further limit, restrict or suspend operations within the right of way.
- 3. Current and future state projects take precedence over this driveway.
- 4. Notify Town of Rolesville prior to beginning work.
- 5. Traffic shall be maintained at all times.

All lanes of traffic are to be open during the hours of 7:00 A.M. to 9:00 A.M. and from 4:00 P.M. to 7:00 P.M. Monday through Friday, during any time of inclement weather, or as directed by the District Engineer. If the location of work calls for a rolling roadblock on Interstates and divided highway US routes, the restriction is to work only on Sunday from 1:00 A.M. to 10:00 A.M, and only after explicit approval by the District Engineer.

Any violation of these hours will result in ceasing any further construction by the Encroaching Party or their contractor. Nighttime and weekend operations will NOT be allowed unless written approval is received from the District Engineer.

If nighttime or weekend work is allowed or required, all signs must be retro-reflective, and a work zone lighting plan must be submitted for approval prior to construction. Two-way traffic shall be maintained at all times unless designated by the District Engineer. Traffic shall not be rerouted or detoured without the prior written approval from the District Engineer.

If the construction is within 1000 feet of a school location or on a designated bus route, the construction shall be coordinated with the school start and end times to avoid traffic delays.

Work requiring lane or shoulder closures shall not be performed on both sides of the road simultaneously within the same area. Any work requiring equipment or personnel within 5 feet of the edge of any travel lane of an undivided facility and within 10 feet of the edge of any travel lane of a divided facility shall require a lane closure with appropriate tapers per current NCDOT Roadway Standard Drawings or MANUAL ON UNIFORM TRAFFIC CONTROL DEVICES.

Sidewalk closures shall be installed as necessary. Pedestrian traffic shall be detoured around these closures and shall be signed appropriately and in accordance with The American with Disabilities Act Accessibility Guidelines. The encroaching party must adhere to the guidelines for accommodating pedestrians in encroachment work zones as described in the NCDOT Pedestrian Work Zone Accommodations Training found at

https://www.youtube.com/watch?v=AOuYa5IW3dg&feature=youtube. Refer to the Standard Provisions to determine when all lane closures are prohibited around public holidays.

6. Sight distance shall be free and clear of any debris, foliage and/or earth material for a minimum distance of 350' on US 401 (Main Street). Vegetation removal and/or grading may be necessary to achieve the required sight distance. If the sight distance requirement is not achieved, NCDOT reserves the right to deny/close/restrict this/these accesses.

D051-092-24-00038 Page 2 of 11

- 7. A \$33,000.00 Performance and Indemnity Bond shall be executed and posted with the District Office at 4009 District Drive, Raleigh, North Carolina 27607, prior to beginning any work on the Right of Way. When the required roadway improvements have been completed, and upon written request by the Permittee to the District Office. If all work is found to be satisfactory, the bond will be released.
- 8. Approval is for the following driveway accesses as shown on the attached plans received in the District Office:
 - 1.) One right-in/left-in driveway from US 401 Business (Main Street), located approximately 250 feet northeast of the intersection with Old Rogers Road as shown on the attached plans. Left-turn consideration will be provided by the existing two-way center turn-lane.
 - 2.) One right-out only driveway onto US 401 Business (Main Street) approximately 200 feet northeast of the intersection with Rogers Road as shown on the attached plans.
- 9. The roadway improvements, as shown on the plans, shall be constructed under encroachment agreement E051-092-24-00779.
- 10. Pavement widening, storm drainage, curb and gutter, and other roadway improvements associated with the proposed driveway entrance/entrances shall be constructed under an approved Encroachment Agreement which shall be obtained prior to commencement of driveway construction.
- 11. Approval of the driveway permit does not constitute review and approval of streets for NCDOT maintenance. If addition of streets to the state system is desired, plans for review and a petition for addition shall be submitted to the District Engineer's office. For further information, contact Mr. Daniel Boulware, P.E., District Engineer, at (919) 814-6115.
- 12. Any further subdivision of this lot will require review and approval from the District Engineer's Office. Roadway improvements may be required at that time based on District Office Review.
- 13. All disturbed areas are to be fully restored to current NCDOT minimum roadway standards or as directed by the Division Engineer or their representative. Disturbed areas within NCDOT Right-of-Way include, but not limited to, any excavation areas, pavement removal, drainage or other features.

D051-092-24-00038 Page 3 of 11

Driveway Permit Standard Provisions

- 1. This agreement only covers work within NCDOT Right-of-Way. The encroacher is responsible for verifying all right of way. NCDOT does not guarantee the right of way on this road. If the right of way was not obtained by the fee simple method, it is the responsibility of the encroacher to obtain permission from the underlying property owner/owners. NCDOT shall not be held responsible for any claim for damages brought about by any property owner by reason of this installation.
- Please note that approval of the permit does not constitute review or approval of utilities by NCDOT. Plans and a completed agreement shall be submitted to the District Engineer's office for review and approval.
- 3. NCDOT reserves the right to further restrict this access at the expense of the encroaching party if/when accident history exists, operational issues occur, the execution and/or operation of said permit is found to be a hazard to the general public, or at the discretion of the District Engineer.
- 4. An executed copy of this agreement, provisions, and approved plans, as well as all other permits currently approved by NCDOT for this site, shall be present at the construction site at all times. If safety or traffic conditions warrant such an action, NCDOT reserves the right to further limit, restrict or suspend operations within the right of way, or at the discretion of the District Engineer.
- 5. No lane closures shall be permitted between the hours of 6:00 AM to 9:00 AM and 4:00 PM to 7:00 PM, Monday through Friday unless otherwise specified in the Special Provisions of this agreement.
- 6. All materials and construction shall be in accordance with NCDOT standards and specifications, including but not limited to, the NCDOT Standard Specifications for Roads and Structures 2024, the NCDOT Roadway Standards Drawings, and NCDOT Policies and Procedures for Accommodating Utilities on Highway Rights of Way.
- 7. The Encroacher shall notify the public, including all adjacent property owners and businesses, a minimum of 2 weeks prior to beginning work.
- 8. The Encroaching party or their contractor shall provide three (3) business days advance phone call at (919) 814-6115 to the District Engineer's office. Failure to provide notification prior to beginning construction is subject to the Division Engineer's discretion to cease construction activity for this agreement. NCDOT reserves the right to cease any construction or maintenance work associated with this installation by the encroaching party until the construction or maintenance meets the satisfaction of the Division Engineer or their representative.
- 9. Retaining walls or other vertical structures shall not be permitted inside NCDOT right of way.
- 10. It shall be the responsibility of the encroaching party to determine the location of utilities within the project area. NCGS § 87-115 through § 87-130 of the Underground Utility Safety and Damage Prevention Act requires underground utilities to be located by calling 811 prior to construction. The encroaching party shall be responsible for notifying other utility owners and providing protection and safeguards to prevent damage or interruption to existing facilities and maintain access to them. The encroaching party shall be responsible for making arrangements to adjust or relocate any utilities that conflict with the proposed work.
- 11. This approval and associated plans and supporting documents shall not be interpreted to allow any design change or change in the intent of the design by the Owner, Design Engineer, or any of their representatives. Any revisions or changes to these approved plans or intent for construction must be obtained in writing from the District Engineer's office or their representative prior to construction or during construction if an issue arises during construction to warrant changes.

D051-092-24-00038 Page 4 of 11

- 12. All Right of Way and easements necessary for construction and maintenance shall be dedicated to NCDOT with proof of dedication furnished to the District Engineer prior to beginning work.
- 13. Encroaching party shall be responsible for obtaining all necessary permanent and/or temporary construction, drainage, utility, and/or sight distance easements.
- 14. This agreement does not authorize installations within nor encroachment onto railroad rights of way. Permits for installations within railroad right of way must be obtained from the railroad and are the responsibility of the encroaching party.
- 15. At the end of each working day, equipment shall be parked outside of the clear recovery zone in order to avoid any obstruction to the travelling public. This clear recovery zone is measure from the edge of the nearest travel lane.

Ingress and egress shall be maintained to all businesses and dwellings at all times.

No lane closures shall be permitted between the hours of 6:00 AM to 9:00 AM and 4:00 PM to 7:00 PM, Monday through Friday unless otherwise specified in the Special Provisions of this agreement.

No parking or material storage shall be allowed along the shoulders of any NCDOT roadways.

The encroacher shall provide traffic control devices, lane closures, road closures, positive protection and/or any other warning or positive protection devices necessary for the safety of road users during construction and any subsequent maintenance. This shall be performed in conformance with the latest NCDOT Roadway Standard Drawings and Standard Specifications for Roads and Structures and Amendments or Supplements thereto. When there is no guidance provided in the Roadway Standard Drawings or Specifications, comply with the Manual on Uniform Traffic Control Devices for Streets and Highways and Amendments or Supplements thereto. No work shall be performed in the Right of Way unless this requirement is satisfied. NCDOT reserves the right to require a written traffic control plan for project operations.

Sidewalk closures shall be installed as necessary. Pedestrian traffic shall be detoured around these closures and shall be signed appropriately and in accordance with The American with Disabilities Act Accessibility Guidelines.

Two-way traffic shall be maintained at all times.

Work shall not be performed on both sides of the road simultaneously within the same area.

D051-092-24-00038 Page 5 of 11

16. WORK ZONE TRAFFIC CONTROL QUALIFICATIONS AND TRAINING PROGRAM

All personnel performing any activity inside the highway right of way are required to be familiar with the NCDOT Maintenance / Utility Traffic Control Guidelines (MUTCG). No specific training course or test is required for qualification in the Maintenance / Utility Traffic Control Guidelines (MUTCG).

All flagging, spotting, or operating Automated Flagger Assist Devices (AFAD) inside the highway right of way requires qualified and trained Work Zone Flaggers. Training for this certification is provided by NCDOT approved training resources and by private entities that have been preapproved to train themselves.

All personnel involved with the installation of Work Zone Traffic Control devices inside the highway right of way are required to be qualified and trained Work Zone Installers. Training for this certification is provided by NCDOT approved training resources and by private entities that have been pre-approved to train themselves.

All personnel in charge of overseeing work zone Temporary Traffic Control operations and installations inside the highway right of way are required to be qualified and trained Work Zone Supervisors. Training for this certification is provided by NCDOT approved training resources and by private entities that have been pre-approved to train themselves. For questions and/or additional information regarding this training program please refer to

For questions and/or additional information regarding this training program please refer to https://connect.ncdot.gov/projects/WZTC/Pages/Training.aspx or call the NCDOT Work Zone Traffic Control Section (919) 814-5000.

The party of the second part shall employ traffic control measures that are in accordance with the prevailing federal, state, local, and NCDOT policies, standards, and procedures. These policies, standards, and procedures include, but are not limited to the following:

Manual on Uniform Traffic Control Devices (MUTCD) – North Carolina has adopted the MUTCD to provide basic principles and guidelines for traffic control device design, application, installation, and maintenance. North Carolina uses the MUTCD as a minimum requirement where higher supplemental standards specific to North Carolina are not established. Use fundamental principles and best practices of MUTCD (Part 6, Temporary Traffic Control).

NCDOT Maintenance / Utility Traffic Control Guidelines – This document enhances the fundamental principles and best practices established in MUTCD Part 6, Temporary Traffic Control, incorporating NCDOT-specific standards and details. It also covers important safety knowledge for a wide range of work zone job responsibilities.

If the Traffic Control Supervisor determines that portable concrete barrier (PCB) is required to shield a hazard within the clear zone, then PCB shall be designed and sealed by a licensed North Carolina Professional Engineer. PCB plans and design calculations shall be submitted to the District Engineer for review and approval prior to installation.

Ingress and egress shall be maintained to all businesses and dwellings affected by the project. Special attention shall be paid to police, EMS and fire stations, fire hydrants, secondary schools, and hospitals.

- 17. Excavated areas adjacent to pavement having more than a 2 inch drop shall be made safe with a 6:1 or flatter slope and shall be designated by appropriate delineation during periods of construction inactivity, including, but not limited to, night and weekend hours.
- 18. Current and future state projects take precedence over this agreement.

D051-092-24-00038 Page 6 of 11

- 19. No access to the job site, parking or material storage shall be allowed along or from the Control of Access Roadway.
- 20. The installation within the Control of Access fence shall not adversely affect the design, construction, maintenance, stability, traffic safety or operation of the controlled access highway, and the utility must be serviced without access from the through-traffic roadways or ramps.
- 21. The resetting of the Control of Access fence shall be in accordance with the applicable NCDOT standard and as directed by the Division Engineer or their representative.
- 22. The encroaching party shall comply with all applicable local, state and federal environmental regulations, and shall obtain all necessary state and federal environmental permits, including but not limited to, those related to sediment control, storm water, wetland, streams, endangered species, and historical sites.
- 23. All earth areas disturbed shall be regraded and reseeded in accordance with NCDOT Standards and Specifications.
- 24. All proposed landscaping and plantings located within the NCDOT right of way shall be approved by the Division Roadside Environmental Engineer at (919) 816-9290.
 - In the event these plants require relocation or removal for highway construction, reconstruction, or maintenance of safety, such removal or relocation will be done immediately by the permittee upon notification by the NCDOT entirely at the expense of the permittee.
- 25. Existing drainage patterns shall be maintained at all times throughout the proposed construction. The encroacher shall keep the roadway clean of dirt and debris at all times throughout the duration of the project.
- 26. The applicant is responsible for complying with the Neuse and Tar-Pamlico Riparian Buffer Rule as regulated by the NCDWQ. The Rule regulates activity within a 50-foot buffer along perennial streams, intermittent streams and ponds.
- 27. All erosion control devices and measures shall be constructed, installed, maintained, and removed by the Encroacher in accordance with all applicable Federal, State, and Local laws, regulations, ordinances, and policies. All earth areas shall be regraded and seeded in accordance with NCDOT Standards Specifications for Roads and Structures.

D051-092-24-00038 Page 7 of 11

28. All erosion control devices and measures shall be constructed, installed, maintained, and removed by the Encroacher in accordance with all applicable Federal, State, and Local laws, regulations, ordinances, and policies. Permanent vegetation shall be established on all disturbed areas in accordance with the recommendations of the Division Roadside Environmental Engineer. All areas disturbed (shoulders, ditches, removed accesses, etc.) shall be graded and seeded in accordance with the latest NCDOT Standards Specifications for Roads and Structures and within 15 calendar days with an approved NCDOT seed mixture (all lawn type areas shall be maintained and reseeded as such). Seeding rates per acre shall be applied according to the Division Roadside Environmental Engineer. Any plant or vegetation in the NCDOT planted sites that is destroyed or damaged as a result of this agreement shall be replaced with plants of like kind or similar shape.

No trees within NCDOT right of way shall be cut without authorization from the Division Roadside Environmental Engineer. An inventory of trees measuring greater than 4 caliper inches (measured 6" above the ground) is required when trees within C/A right of way will be impacted by the project installation. Mitigation is required and will be determined by the Division Roadside Environmental Engineer's Office.

The applicant is responsible for identifying project impacts to waters of the United States (wetlands, intermittent streams, perennial streams and ponds) located within the NCDOT right-of-way. The discharge of dredged or fill material into waters of the United States requires authorization from the United States Army Corps of Engineers (USACE) and certification from the North Carolina Division of Water Quality (NCDWQ). The applicant is required to obtain pertinent permits or certification from these regulatory agencies if construction of the project impacts waters of the United States within the NCDOT right-of-way. The applicant is responsible for complying with any river or stream Riparian Buffer Rule as regulated by the NCDWQ. The Rule regulates activity within a 50-foot buffer along perennial streams, intermittent streams and ponds. Additional information can be obtained by contacting the NCDWQ or the USACE.

The contractor shall perform all monitoring and record keeping and any required maintenance of erosion and sediment control measures to maintain compliance with stormwater regulations.

- 29. Any existing driveways, pavement, sidewalk, curb and gutter or drainage structures that are damaged during construction shall be repaired to their original condition.
- 30. All temporary and final pavement markings, reflective pavement markings and signage are the responsibility of the Encroacher. All final pavement markings shall be thermoplastic. Any pavement markings that are damaged or obliterated shall be restored at no cost to the department
- 31. All traffic control, asphalt mixes, structures, construction, workmanship and construction methods, and materials shall be in compliance with the most-recent versions of the following resources: ASTM Standards, Manual on Uniform Traffic Control Devices, NCDOT Utilities Accommodations Manual, NCDOT Standard Specifications for Roads and Structures, NCDOT Roadway Standard Drawings, NCDOT Asphalt Quality Management System manual, and the approved plans.
- 32. Prior approval for any blasting must be obtained from the District Engineer or their representative.
- 33. Guardrail shall be installed where warranted and in accordance with the guidelines shown in the 2024 Highway Design Branch Roadway Standard Drawings.

Guardrail removed or damaged during construction shall be replaced or repaired to their original condition at no cost to NCDOT.

D051-092-24-00038 Page 8 of 11

- 34. All material to a depth of 8 inches below the finished surface of the subgrade shall be compacted to a density equal to at least 100% of that obtained by compacting a sample of the material in accordance with AASHTO T99 as modified by the Department. The subgrade shall be compacted at a moisture content which is approximately that required to produce the maximum density indicated by the above test method. The contractor shall dry or add moisture to the subgrade when required to provide a uniformly compacted and acceptable subgrade. The option to backfill any trenches with dirt or either #57 stone or #78 stone with consolidation with a plate tamp and without a conventional density test may be pursued with the written consent of the District Engineer. If this option is exercised, then roadway ABC stone and asphalt repair as required will also be specified by the District Engineer.
- 35. All excavations inside the theoretical 1:1 slope from the existing edge of pavement to the bottom of the nearest excavation wall should be made in accordance with the following conditions. Traffic should be moved to a travel lane outside the limits of a theoretical one-to-one slope from the bottom of the nearest trench wall to the pavement surface. Active excavation shoring, such as sheet piling, shall be installed. The design of the shoring shall include the effects of traffic loads. The shoring system shall be designed and sealed by an engineer registered in North Carolina. Trench boxes shall not be accepted as shoring. The trench backfill material should meet the Statewide Borrow Criteria.
- 36. Trenching, bore pits and/or other excavations shall not be left open or unsafe overnight. The Contractor shall comply with all OSHA requirements and provide a competent person on site to supervise excavation at all times.
- 37. Excavated material shall not be placed on the roadway at any time.
- 38. Any pavement damaged because of settlement of the pavement or damaged by equipment used to perform work, shall be re-surfaced to the satisfaction of the District Engineer. This may include the removal of pavement and a 50' mechanical overlay. All pavement work and pavement markings (temporary and final) are the responsibility of the Encroaching Party.
- 39. When paving beyond utility installation is involved, a Roadway certification report sealed by a Professional Engineer shall be submitted to the District Engineer's office indicating the following:
 - Pavement thickness by type
 - Pavement density, core and/or test locations
 - Base thickness
 - · Base density
 - Subgrade density

Test frequency and method shall be in conformance with the NCDOT Materials and Tests Manual. Test must be performed by a Certified Technician including name and Certification number on report.

D051-092-24-00038 Page 9 of 11

- 40. Pavement cuts shall be repaired the same day the cuts are made unless an asphalt patch cannot be accomplished the same day due to material availability or time restrictions. When the asphalt patch is not feasible, the following apply:
 - a. The pavement cut shall be filled to the surface with ABC stone or Flowable Fill per NCDOT's Standards and Specifications.
 - b. Once the cut is filled, a minimum ¾-inch steel plate shall be placed and pinned to prevent moving. Plates shall be designed large enough to span a minimum of 1-foot on all sides on the pavement cut.
 - c. When flowable fill is used, it shall cure for 24 hours prior to any asphalt material placement. Flowable fill bleed water shall not be present during paving operations. Paving shall not cause damage (shoving, distortion, pumping, etc.) to the flowable fill.
 - d. Install and leave "BUMP AHEAD" signs according to MUTCD until the steel plate has been removed. Once the flowable fill has cured, remove the steel plate, and mill/fill according to the directions of the District Engineer.
 - e. All pavement cuts must be sealed with NCDOT approved sealant to prevent future pavement separation or cracking.
- 41. Roadway certification reports sealed by a Professional Engineer shall be submitted to the North Carolina Department of Transportation at 4009 District Drive, Raleigh, North Carolina, indicating the following:
 - * Pavement thickness by type
 - * Pavement density, core and/or test locations
 - * Base thickness
 - * Base density
- 42. "Potholing" (or "daylighting") pavement cores to expose existing utilities shall be made with a circular minimum 6" to maximum 18" diameter "test" hole to a maximum depth of 12 inches. Pavement core locations shall not be placed in the wheel path whenever possible. Vacuum excavation shall be utilized to expose underground utilities below pavement subgrade. Displaced dirt and rock debris must be suctioned away from the excavation area through a large hose to a vacuum truck and disposed by the encroaching party. Avoid using mechanized equipment in the proximity of all exposed underground utility lines. Pavement cores shall be repaired within the same working day. The pavement core shall be retained and evaluated for reuse to fill the core hole.
- 43. The paving of this roadway shall be in accordance with the latest version of NCDOT Standard Specifications, Sections 610, 1012 and 1020. The Contractor shall follow all procedures of the latest Quality Management System (QMS) Asphalt Manual for asphalt pavement Maintenance Version (see https://connect.ncdot.gov/resources/Materials/MaterialsResources/Forms/Default.aspx) to find the most recent version. The Contractor must adhere to all testing requirements and quality control requirements specified. The Contractor shall contact the NCDOT Division QA Supervisor prior to producing plant mix and make the Supervisor aware that the mix is being produced for a future NCDOT road. Contact the District Engineer to determine the NCDOT Division QA Supervisor. Only NCDOT approved mix designs will be acceptable. A Quality Control Plan shall be submitted (as Directed by the District Engineer) to the District Engineer's Office prior to asphalt production utilizing form QMS-MV1. Failing mixes and/or densities are subject to penalties including monetary payments or removal and replacement. To minimize traffic queuing in construction areas, the possibility of traffic detours may be considered when working on high traffic routes even if traffic control is used. The District Engineer may require traffic detours.
- 44. The encroaching party shall notify the District Engineer or their representative immediately in the event any drainage structure is blocked, disturbed or damaged. All drainage structures disturbed, damaged or blocked shall be restored to its original condition as directed by the District Engineer or their representative.

D051-092-24-00038 Page 10 of 11

- 45. Excavation within 1000 feet of a signalized intersection will require notification by the encroaching party to the Division Traffic Engineer at telephone number (919) 536-4000 no less than one week prior to beginning work. All traffic signal or detection cables must be located prior to excavation. Cost to replace or repair NCDOT signs, signals, pavement markings or associated equipment and facilities shall be the responsibility of the encroaching party.
- 46. Approval may be rescinded upon failure to follow any of the provisions in this permit and may be considered a violation of the agreement.
- 47. All Traffic signs moved shall be reinstalled as soon as possible to meet NCDOT specifications.
- 48. No commercial advertising shall be allowed within NCDOT Right of Way.
- 49. The Encroaching Party and/or their Contractor shall comply with all OSHA requirements. If OSHA visits the work area associated with this project, the District Office shall be notified by the encroaching party immediately if any violations are cited.
- 50. Right of Way monuments disturbed during construction shall be referenced by a registered Land Surveyor and reset after construction.
- 51. If the approved method of construction is unsuccessful and other means are required, prior approval must be obtained through the District Engineer before construction may continue.
- 52. Any guardrail removed or damaged during construction shall be replaced or repaired to its original condition, meeting current NCDOT standards or as directed by the Division Engineer or their representative.
- 53. All Traffic signs moved during construction shall be reinstalled as soon as possible to the satisfaction of the Division Traffic Engineer or their representative.
- 54. A minimum of 5 feet clearance is required for utility installations beneath or near drainage pipes, headwalls, and a minimum of two-foot clearance below the flowline of streams. If directional drilling, a minimum ten-foot clearance distance is required from drainage structures and a minimum of 5 feet below flowline of streams.
 - At points where the utility is placed under existing storm drainage, the trench will be backfilled with excavatable flowable fill up to the outside diameter of the existing pipe.
- 55. Prior to beginning work, it is the requirement of the Encroaching Party to contact the appropriate Utility Companies involved and make arrangements to adjust or relocate any utilities that conflict with the proposed work.
- 56. All driveways disturbed during construction shall be returned to a state comparable with the condition of the driveways prior to construction.

D051-092-24-00038 Page 11 of 11

APPLI	CATION IDENTIFICATI	ON	N.C. DEPARTMENT OF TRANS	PORTATION	
dveway	Date of Application		STREET AND DRIVEWAY A	CCESS	
Permit No.	Application		PERMIT APPLICATION	N	
County: Wake	cooter's Rolesville				
Development Name: 30		CATION OF PROP	ERTY:		
Route/Road: S Main S					
Exact Distance 400' &	500' Miles	NSEW			
From the Intersection of F	Route No. US 401 (5 Make		Old Rogers Rd Toward Rog	gers Rd	
Property Will Be Used Fo	Fire Residential /Subdivision	Commercial Edu	ucational Facilities TND Emergency Sen	rvices 🔲 Other	
Topeny.	<u> </u>	AGREEMENT			
1, the undersigned pro	oparty owner, request ac		to construct driveway(s) or street(s) or	on public right-	
of-way at the above k I agree to construct a Street and Driveway	ocation. nd maintain drivewav(s)	or street entrance(s)	in absolute conformance with the cur ed by the North Carolina Department	rent "Policy on	
. I some that the driver	way(s) or sineal(s) will be	constructed as show	right-of-way other than those approvent on the attached plans. include any approach tapers, storage		
 I agree that that driveway(s) or street(s) as used in this agreement include any approach tapers, storage lanes or speed change lanes as deemed necessary. I agree that if any future improvements to the roadway become necessary, the portion of driveway(s) or street(s) located on public right-of-way will be considered the property of the North Carolina Department of Transportation, and I will not be entitled to reimbursement or have any claim for present expenditures for driveway or street construction. 					
specified by the Poli I agree to pay a \$50	icy on Street and Drivewa construction inspection fo	av Access to North C	or street(s) is not completed within the arolina Highways". yable to NCDOT. This fee will be rein		
the public teaual	and maintain the driveway		afe manner so as not to interfere with		
I agree to provide during and following construction proper signs, algual lights, flaggers and other warning devices for the protection of traffic in conformance with the current "Manual on Uniform Traffic Control Devices for Streets and Highways" and Amendments or Supplements thereto. Information as to the above rules and regulations may be obtained from the District Engineer.					
I agree to Indemnify for damage that may	and save harmless the N	onstruction.	ment of Transportation from all damage		
I agree that the North	h Carolina Department of	l Transportation will a sy right-of-way limits.	ssume no responsibility for any dama in carrying out its construction.		
econterellos sessones	ed on the State Highway:	system.	mt specified by the Division of Highwa		
The granting of this permit is subject to the regulatory powers of the NC Department of Transportation as provided by law and as set forth in the N.C. Policy on Driveways and shall not be construed as a contract access point. I agree that the entire cost of constructing and maintaining an approved private street or driveway access connection					
and conditions of this	e cost of constructing and s permit will be borne by	d maintaining an appo the property owner, t	roved privete street or driveway acce: he applicant, and their grantees, succ	essors, and	
assignees. • I AGREE TO NOTIF COMPLETED.	Y THE DISTRICT ENGIN	NEER WHEN THE PI	ROPOSED WORK BEGINS AND W	ien it is	
2004-07 NOTE S	ubmit Four Copies of Applica	tion to Local District Eng 61-03419	ineer, N.C. Department of Transportation	TEB 65-04rev	

SIG	NATURES OF APPLICA	NT	· · · · · ·	
PROPERTY OWNER (APPLICANT) Rolesville, LLC SIGNATURE ADDRESS 11016 Rushmoré Drivé, Suite 160 Charlotte, NC 26277-4450 Phone No.	NAME SIGNATURE ADDRESS 919-868-4472	Brandon Funda 11501 Joh Red ough	Allen Co	,040)
AUTHORIZED AGENT COMPANY 888 Java Enterprises - Rolesville, LLC SIGNATURE ADDRESS 13 Lefov Drive Clayton, NC 27527 Phone No.	NAME SIGNATURE ADDRESS P19-428-7670 APPROVALS	Society of Joulem & Laton	Souther to Josephine De 27:	land Said
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APPLICATION APPROVED BY LOCAL GOVERNMENTAL AI	4	Dinctor	2 - / -	2024
APPLICATION APPROVED BY NCDOT	TITLE		DAYE	
INSPECTION BY NCDOT				
SIONATURE COMMENTS:	TITLE		DATE	
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SCOOTER'S ROLESVILLE

306 SOUTH MAIN STREET ROLESVILLE, NC 27571

A DEVELOPMENT BY: S&S JAVA ENTERPRISES

PROJECT NO.: SDP-23-09 DATE: OCTOBER 31, 2023

RALEIGH (APEX) (APEX) (APEX) (AO) (GARNER) (AO) (GARNER) (AO) (\$ \$
PROJECT LOCATION MAP	VICINITY MAP
SCALE: NOT TO SCALE	SCALE: 1" = 500'

PROJECT OWNERS & CONSULTANTS

OWNER
ROLESVILLE, LLC
11016 RUSHMORE DRIVE, SUITE 160
CHARLOTTE, NORTH CAROLINA 28277
CONTACT: MARLANE KLINTWORTH
PHONE: (919) 868-4472

EMAIL: mvkcommercial@gmail.com

EMAIL: b2driver@earthlink.net

PHONE: (919) 653-2927

DEVELOPER S&S JAVA ENTERPRISES - ROLESVILLE, LLC 13 LAFOY DRIVE CLAYTON, NORTH CAROLINA 27527 CONTACT: ROBERT SOUTHERLAND PHONE: (919) 426-7670

CIVIL ENGINEER KIMLEY-HORN AND ASSOCIATES, INC. 421 FAYETTEVILLE ST., SUITE 600 RALEIGH, NORTH CAROLINA 27601 CONTACT: CHRIS BOSTIC, P.E.

EMAIL: chris.bostic@kimley-horn.com

LANDSCAPE ARCHITECT 421 FAYETTEVILLE ST., SUITE 600 RALEIGH, NORTH CAROLINA 27601 CONTACT: ADAM FULLERTON, MLA, ASLA PHONE: (919) 653-2937 EMAIL: adam.fullerton@kimley-horn.com

SURVEYOR CMP PROFESSIONAL LAND SURVEYORS, PC 333 S. WHITE ST WAKE FOREST, NORTH CAROLINA 27587 CONTACT: MICHAEL A. MOSS, PLS PHONE: (919) 556-3148 EMAIL: mike@cmppls.com

L2.1 E3.1 A1.5 A2.0 A2.1 A2.2

SITE PERMITTING APPROVA

Sheet List Table

Sheet Number

C0.0

C0.1

C2.0

C3.0

C4.0

C4.1

C4.2

C5.0

C5.1

C5.2

C5.3

C8.0

C8.1

C9.0

C9.1

C10.0

C11.0

C11.1

L1.0

L2.0

Sheet Title

COVER SHEET

GENERAL NOTES

SITE PLAN

UTILITY PLAN

MECHANICAL PLAN

SEPTIC TANK DETAILS

SITE DETAILS

SITE DETAILS

STORM DETAILS

STORM DETAILS

WATER DETAILS

WATER DETAILS

LANDSCAPE PLAN

LANDSCAPE DETAILS

LANDSCAPE NOTES

EXTERIOR ELEVATIONS

EXTERIOR ELEVATIONS

Water and Sewer Permits (If applicable)

The City of Raleigh consents to the connection and extension of the City's **Public Sewer System** as shown on this plan. The material and Construction methods used for this project shall conform to the standards and specifications of the City's Public Utilities Handbook. City of Raleigh Public Utilities Department Permit #

The City of Raleigh consents to the connection and extension of the City's **Public Water System** as shown on this plan. The material and Construction methods used for this project shall conform to the standards and specifications of the City's Public Utilities Handbook. City of Raleigh Public Utilities Department Permit #

The City of Raleigh consents to the connection to its public sewer system and extension of the private sewer collection system as shown on this plan. The material and constructions methods used for this project shall conform to the standards and specifications of the City's Public Utilities Handbook.

City of Raleigh Public Utilities Department Permit #

CITY OF RALEIGH - PLANS AUTHORIZED FOR CONSTRUCTION

Electronic Approval: This approval is being issued electronically. This approval is valid only upon the signature of a City of Raleigh Review Officer below. The City will retain a copy of the approved plans. Any work authorized by this approval must proceed in accordance with the plans kept on file with the City. This electronic approval may not be edited once issued. Any modification to this approval once issued will invalidate this approval.

City of Raleigh Development Approva

Raleigh Water Review Officer

DISTURBED AREA: 0.70 AC

EROSION CONTROL, STORMWATER AND FLOODPLAIN MANAGEMENT **APPROVED**

EROSION CONTROL
S- 121946-2024 STORMWATER MGMT.


S-121938-2024 FLOOD STUDY \square S-

ENVIRONMENTAL CONSULTANT SIGNATURE

SURVEY NOTE:
EXISTING TOPOGRAPHICAL INFORMATION IS BASED ON A TOPOGRAPHIC SURVEY OBTAINED ON 02/23/2023 BY CMP PROFESSIONAL LAND SURVEYORS, 333 S. WHITE STREET, WAKE FOREST, NC, 27588, PHONE: (919) 556-3148. CONTRACTOR SHALL BE RESPONSIBLE FOR VERIFYING ALL EXISTING INFORMATION, DEPICTED OR NOT, PRIOR TO CONSTRUCTION AND REPORT POTENTIAL CONFLICTS TO OWNER AND ENGINEER.

Know what's below. Call before you dig.

EXISTING CONDITIONS & DEMOLITION PLAN GRADING AND DRAINAGE PLAN **EROSION CONTROL PLAN - PHASE 1 EROSION CONTROL PLAN - PHASE 2 EROSION CONTROL DETAILS EROSION CONTROL DETAILS** SANITARY SEWER DETAILS **EXTERIOR SITE PHOTOMETRIC PLAN** TRASH ENCLOSURE PLAN **EXTERIOR COLOR ELEVATIONS**

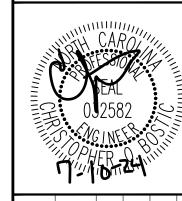

Kimley

SHEET NUMBER C0.0

SDP-23-09

144 SF CURRENT IMPERVIOUS: PROPOSED IMPERVIOUS: 18,700 SF PARKING: MIN. REQUIRED: (2.5 SPACES/1,000 SF) X 700 SF = 2.5 SPACES MAX. ALLOWED: (10 SPACES/1,000 SF) X 700 SF = 7 SPACES PROVIDED: 7 SPACES REQUIRED: 1 SPACE ACCESSIBLE PARKING: PROVIDED: 1 SPACE LOADING SPACES: REQUIRED: 1 SPACE PROVIDED: 1 SPACE BICYCLE PARKING: MIN. REQUIRED: (1 SPACE/5,000 SF) = 1 SPACES PROVIDED: 2 SPACES OPEN SPACE: REQUIRED: TOTAL REQUIRED: $0.70 \text{ AC } \times 5\% = 0.035 \text{ AC } (1,525 \text{ SF})$ ACTIVE OPEN SPACE REQUIRED: $0.035 \text{ AC } \times 50\% = 0.018 \text{ AC } (784 \text{ SF})$ PROVIDED: ACTIVE OPEN SPACE PROVIDED: 0.031 AC (1,358 SF) PASSIVE OPEN SPACE PROVIDED: 0.050 AC (2,192 SF)

TOTAL OPEN SPACE PROVIDED:

0.081 AC (3,550 SF)

SEE SHEET L1.0

SITE DATA TABLE

1759806076

FRONT: 20'

REAR: 35'

COMMERCIAL

NEUSE

VACANT

SANFORD CREEK

GENERAL COMMERCIAL (GC)

30' STREETSCAPE BUFFER

25' TYPE 3 PERIMETER BUFFER (REAR)

0.70 AC

TOTAL SITE AREA:

EXISTING ZONING:

PROPERTY SETBACKS:

TREE COVERAGE DATA:

BUILDING SQUARE FOOTAGE: 700 SF (APPROX.)

BUILDING HEIGHT:

BUFFERS:

WATERSHED:

RIVER BASIN:

CURRENT USE:

PROPOSED USE:

GENERAL NOTES:

- WORK IN THIS PROJECT SHALL CONFORM TO THESE PLANS, THE LATEST EDITIONS OF THE NORTH CAROLINA DEPARTMENT OF TRANSPORTATION (NCDOT) ROAD AND BRIDGE SPECIFICATIONS, THE NCDOT ROAD AND BRIDGE STANDARDS, THE NORTH CAROLINA EROSION AND SEDIMENT CONTROL HANDBOOK, THE NORTH CAROLINA EROSION AND SEDIMENT CONTROL REGULATIONS, THE ROLESVILLE DESIGN AND CONSTRUCTION STANDARDS AND SPECIFICATIONS, THE FINAL GEOTECHNICAL REPORT, AND GENERAL DESIGN STANDARDS. IN THE EVENT OF CONFLICT BETWEEN ANY OF THESE STANDARDS, SPECIFICATIONS, OR PLANS, THE MOST STRINGENT SHALL GOVERN. ALL UTILITIES TO BE DEDICATED TO THE CITY OF RALEIGH MUNICIPAL WATER AND/OR SANITARY SEWER SYSTEM SHALL BE CONSTRUCTED AND TESTED TO CONFORM TO STATE OF NORTH CAROLINA/STATE BOARD OF HEALTH WATERWORKS AND/OR SEWAGE REGULATIONS AND THE CITY OF RALEIGH DESIGN AND CONSTRUCTION STANDARDS AND SPECIFICATIONS
- 2. THE TERM "CONTRACTOR" AS REFERENCED HERE-IN SHALL ALSO INCLUDE THE SUBCONTRACTOR OR PRINCIPAL TRADE CONTRACTOR, UNDER CONTRACT TO THE GENERAL CONTRACTOR TO PROVIDE LABOR, MATERIALS, AND/OR SERVICES TO THE PROJECT.
- . THE CONTRACTOR SHALL BE SOLELY RESPONSIBLE FOR ALL JOBSITE SAFETY, INCLUDING BUT NOT LIMITED TO TRENCH SAFETY, DURING ALL PHASES OF CONSTRUCTION.
- 4. THE LOCATION AND SIZE OF EXISTING UTILITIES AS SHOWN IS APPROXIMATE ONLY. THE CONTRACTOR IS RESPONSIBLE FOR HORIZONTALLY AND VERTICALLY LOCATING AND PROTECTING ALL PUBLIC OR PRIVATE UTILITIES (SHOWN OR NOT SHOWN) WHICH LIE IN OR ADJACENT TO THE CONSTRUCTION SITE. AT LEAST 48 HOURS PRIOR TO ANY DEMOLITION, GRADING, OR CONSTRUCTION ACTIVITY, THE CONTRACTOR SHALL NOTIFY THE NORTH CAROLINA 811 UTILITIES LOCATION SERVICE (NC811) AT 1-800-632-4949 FOR PROPER IDENTIFICATION OF EXISTING UTILITIES WITHIN THE SITE.
- THE CONTRACTOR SHALL SALVAGE AND PROTECT ALL EXISTING POWER POLES, SIGNS, MANHOLES, TELEPHONE RISERS, WATER VALVES, ETC. DURING ALL CONSTRUCTION PHASES. THE CONTRACTOR SHALL REPAIR, AT HIS OWN EXPENSE, ANY EXISTING UTILITIES DAMAGED DURING CONSTRUCTION.
- 6. TRAFFIC CONTROL WITHIN ALL VEHICULAR AREAS IS THE RESPONSIBILITY OF THE CONTRACTOR, SHALL BE IN CONFORMANCE WITH THE "MANUAL OF UNIFORM TRAFFIC CONTROL DEVICES," AND AS FURTHER DIRECTED BY CITY AND STATE INSPECTORS.
- ANY DISCREPANCIES FOUND BETWEEN THE DRAWINGS, SPECIFICATIONS, AND SITE CONDITIONS OR ANY INCONSISTENCIES OR AMBIGUITIES IN DRAWINGS OR SPECIFICATIONS SHALL BE IMMEDIATELY REPORTED TO THE ENGINEER, IN WRITING, WHO SHALL PROMPTLY ADDRESS SUCH INCONSISTENCIES OR AMBIGUITIES. WORK DONE BY THE CONTRACTOR AFTER HIS DISCOVERY OF SUCH DISCREPANCIES, INCONSISTENCIES, OR AMBIGUITIES SHALL BE DONE AT THE CONTRACTOR'S RISK.
- CONSTRUCTION STAKEOUT FOR THIS PROJECT SHALL BE PER A DIGITAL (CAD) FILE PROVIDED BY THE ENGINEER THE CONTRACTOR SHALL NOTIFY THE LEAD ARCHITECT IMMEDIATELY OF ANY DISCREPANCIES FOUND BETWEEN THE DIGITAL FILE AND THE CRITICAL STAKING DIMENSIONS SHOWN ON THIS PLAN. ANY MODIFICATIONS MADE BY OTHERS TO THE DIGITAL FILE PROVIDED BY THE ENGINEER SHALL RENDER IT VOID.
- 9. A PRE-CONSTRUCTION CONFERENCE SHALL BE HELD PRIOR TO THE START OF CONSTRUCTION. THE CONTRACTOR SHALL ARRANGE THE MEETING WITH THE ROLESVILLE ENGINEERING DIVISION AND THE OWNER.
- 10. CONTRACTOR IS RESPONSIBLE FOR VERIFYING OR OBTAINING ALL REQUIRED PERMITS AND APPROVALS PRIOR TO COMMENCING CONSTRUCTION.
- 11. THE FRAMES AND COVERS OF ALL EXISTING AND PROPOSED DRAINAGE, SANITARY SEWER, WATER MAIN, GAS, AND WIRE UTILITY STRUCTURES SHALL BE ADJUSTED TO MATCH PROPOSED FINISHED ELEVATIONS AND SLOPES.
- 12. ROADWAYS AND BUILDINGS MUST BE CAPABLE OF SUPPORTING FIRE APPARATUS DURING CONSTRUCTION.
- 13. EXISTING INFORMATION SHOWN TAKEN FROM A TOPOGRAPHIC SURVEY DATED FEBRUARY 23, 2023 AND PROVIDED BY CMP PROFESSIONAL LAND SURVEYORS C-1525, 333 S. WHITE STREET, P.O. BOX 1253, WAKE FOREST, N.C.
- 14. ALL CONSTRUCTION SHALL BE IN ACCORDANCE WITH THE NC DOT AND ROLESVILLE STANDARDS, SPECIFICATIONS, & DETAILS IF APPLICABLE.

GRADING

27588, PHONE: (919) 556-3148.

- 1. OBTAIN AND POST THE WAKE COUNTY LAND DISTURBANCE PERMIT ONSITE PRIOR TO COMMENCING WORK ON SITE.
- 2. REFER TO FINAL CONSTRUCTION PLANS FOR CLEARING LIMITS AND TEMPORARY EROSION CONTROL DEVICES TO BE INSTALLED PRIOR TO COMMENCING CONSTRUCTION.
- 3. CONTRACTOR SHALL ADHERE TO THE LIMITS OF TREE PROTECTION FENCE.
- 4. EROSION AND SEDIMENT CONTROL MEASURES SHALL BE MAINTAINED CONTINUOUSLY, RELOCATED WHEN AND AS NECESSARY, AND SHALL BE CHECKED AFTER EVERY RAINFALL. SEEDED AREAS SHALL BE CHECKED REGULARLY AND SHALL BE WATERED, FERTILIZED, RESEEDED, AND MULCHED AS NECESSARY TO OBTAIN A DENSE STAND OF
- 5. ALL AREAS SHALL BE GRADED FOR POSITIVE DRAINAGE, AND AS SHOWN ON THESE PLANS. THE CONTRACTOR SHALL MAINTAIN ADEQUATE SITE DRAINAGE DURING ALL PHASES OF CONSTRUCTION. THE CONTRACTOR SHALL USE SILT FENCES (OR OTHER METHODS APPROVED BY THE ENGINEER, WAKE COUNTY, AND NCDENR). AS REQUIRED TO PREVENT SILT AND CONSTRUCTION DEBRIS FROM FLOWING ONTO ADJACENT PROPERTIES. CONTRACTOR SHALL COMPLY WITH ALL APPLICABLE FEDERAL, STATE, OR LOCAL EROSION, CONSERVATION, AND SILTATION ORDINANCES. CONTRACTOR SHALL REMOVE ALL TEMPORARY FROSION CONTROL DEVICES LIPON COMPLETION OF PERMANENT DRAINAGE FACILITIES AND THE ESTABLISHMENT OF A STAND OF GRASS OR OTHER GROWTH TO PREVENT EROSION.
- 6. THE CONTRACTOR SHALL CLEAR AND GRUB THE SITE AND PLACE, COMPACT, AND MOISTURE CONDITION ALL FILL PER THE PROJECT GEOTECHNICAL ENGINEER'S SPECIFICATIONS AND REPORT. THE FILL MATERIAL TO BE USED SHALL BE APPROVED BY THE CERTIFIED MATERIAL TESTING AGENCY PRIOR TO PLACEMENT.
- GRADING CONTRACTOR SHALL COORDINATE WITH THE UTILITY COMPANIES FOR ANY REQUIRED UTILITY ADJUSTMENTS
- AND/OR RELOCATIONS. ALL MATERIALS USED FOR BACKFILL SHALL BE FREE OF WOOD, ROOTS, ROCKS, BOULDERS, OR ANY OTHER NON-COMPATIBLE SOIL TYPE MATERIAL. UNSATISFACTORY MATERIALS ALSO INCLUDE MAN-MADE FILLS AND
- 9. MATERIALS USED TO CONSTRUCT EMBANKMENTS FOR ANY PURPOSE, BACKFILL AROUND DRAINAGE STRUCTURES, OR IN UTILITY TRENCHES FOR ANY OTHER DEPRESSION REQUIRING FILL OR BACKFILL SHALL BE COMPACTED TO 95% OF MAXIMUM DENSITY AS DETERMINED BY THE STANDARD PROCTOR TEST AS SET OUT IN ASTM STANDARD D-698. THE CONTRACTOR SHALL, PRIOR TO ANY OPERATIONS INVOLVING FILLING OR BACKFILLING, SUBMIT THE RESULTS OF THE PROCTOR TEST TOGETHER WITH A CERTIFICATION THAT THE SOIL TESTED IS REPRESENTATIVE OF THE MATERIALS TO BE USED ON THE PROJECT. TESTS SHALL BE CONDUCTED BY A CERTIFIED MATERIALS TESTING LABORATORY AND THE CERTIFICATIONS MADE BY A LICENSED PROFESSIONAL ENGINEER REPRESENTING THE
- 10. ALL DEMOLITION, DEBRIS, AND OTHER EXCESS MATERIAL SHALL BE HAULED OFF-SITE AND LEGALLY DISPOSED OF AT THE CONTRACTOR'S EXPENSE.
- 11. NO TREE WITHIN THE TREE PROTECTION AREA SHALL BE REMOVED OR DAMAGED.
- 12. THE TREE PROTECTION FENCE SHALL BE MAINTAINED ON THE SITE UNTIL ALL SITE WORK IS COMPLETED AND THE FINAL SITE INSPECTION PRIOR TO THE PROJECT ACCEPTANCE IS SCHEDULED. FENCING SHALL BE REMOVED PRIOR TO FINAL SITE INSPECTION FOR THE CO.
- 13. REFERENCE GEOTECHNICAL REPORT FOR PAVING SUB GRADE INFORMATION.

REFUSE DEBRIS DERIVED FROM ANY SOURCE.

- 14. ALL SPOT GRADE ELEVATIONS IN CURB AND GUTTER REPRESENT GUTTER FLOWLINE ELEVATION AT FACE OF CURB UNLESS OTHERWISE NOTED (ADD 6" FOR TOP OF CURB).
- 15. PROPOSED CONTOURS AND GUTTER GRADIENTS ARE APPROXIMATE. PROPOSED SPOT ELEVATIONS AND ROADWAY PROFILES/SUPERELEVATIONS ARE TO BE USED IN CASE OF DISCREPANCY.
- 16. REFER TO SITE PLAN AND FINAL PLAT FOR HORIZONTAL DIMENSIONS.
- 17. WHERE FILL IS TO BE PLACED ON EXISTING SLOPES STEEPER THAN 4:1, CONTRACTOR SHALL EXCAVATE BENCHES WITH A MAXIMUM DEPTH OF 3'.
- 18. THE CONTRACTOR SHALL COORDINATE WITH THE GEOTECHNICAL ENGINEER FOR APPROPRIATE SLOPE STABILIZATION ON ALL SLOPES STEEPER THAN 3:1.
- 19. CONTRACTOR SHALL OBTAIN ALL PERMITS REQUIRED FOR BLASTING ROCK IF BLAST ROCK IS ENCOUNTERED. CONTRACTOR SHALL BE SOLELY RESPONSIBLE FOR COMPLYING WITH ALL BLASTING AND SAFETY REQUIREMENTS.
- 20. SILT FENCE SHALL BE PLACED AROUND ALL TEMPORARY SOIL STOCKPILES A MINIMUM OF 3' FROM TOE OF SLOPE.
- 21. VERTICAL DATUM IS BASED ON NAVD 88.

Sanitary sewer

- 1. SANITARY SEWER SERVICES SHALL BE SCHEDULE 40 PVC.
- 2. CLEANOUT SYMBOLS SHOWN ON THESE PLANS REPRESENT LOCATION OF SURFACE ACCESS POINT. CONTRACTOR SHALL LOCATE WYE APPROPRIATELY BASED ON PIPE DEPTH.
- 3. SANITARY SEWER CLEAN-OUTS LOCATED IN PAVEMENT AREAS SHALL BE HEAVY-DUTY TRAFFIC BEARING CASTINGS.

- 1. WATERLINES, LARGER THAN 2" SHALL BE DUCTILE IRON PIPE MEETING THE REQUIREMENTS OF ANSI-AWWA C151 PRESSURE CLASS 350. WATERLINES 3/4" TO 2" SHALL BE TYPE "K" SOFT COPPER.
- 2. ALL UNDERGROUND UTILITIES AND FIRE HYDRANTS MUST BE FUNCTIONALLY APPROVED PRIOR TO STRUCTURAL
- 3. NATIONAL STANDARD THREADS SHALL BE INSTALLED ON FIRE HYDRANTS.
- 4. ALL FIRE HYDRANTS AND FDC CONNECTIONS TO HAVE STORZ TYPE CONNECTION PER CITY OF RALEIGH FIRE DEPARTMENT STANDARDS.

BACKFLOW PREVENTION:

- THERE SHALL BE NO TAPS, PIPING BRANCHES, UNAPPROVED BYPASS PIPING, HYDRANTS, FIRE DEPARTMENT CONNECTION POINTS OR OTHER WATER-USING APPURTENANCES CONNECTED TO THE SUPPLY LINE BETWEEN ANY WATER METER AND ITS REQUIRED BACKFLOW PREVENTER.
- 2. EACH BACKFLOW PREVENTER ASSEMBLY IS REQUIRED TO BE TESTED BY AN APPROVED CERTIFIED TESTER PRIOR TO PLACING THE WATER SYSTEM INTO SERVICE. CONTRACTOR SHALL PERFORM TESTING IN ACCORDANCE WITH THE CITY OF RALEIGH ENGINEERING DEPARTMENT.

CONSTRUCTION NOTES

EASEMENTS ON THE JOB SITE AT ALL TIMES.

- 1. THE CONTRACTOR SHALL CONDUCT THE WORK IN A SAFE MANNER AND WITH A MINIMUM AMOUNT OF INCONVENIENCE TO TRAFFIC.
- 2. THE CONTRACTOR SHALL BE RESPONSIBLE FOR ALL TRAFFIC CONTROL AND SHALL ADHERE TO THE PROVISIONS OF THE MUTCD (MOST CURRENT EDITION).
- 3. PRIOR TO CONSTRUCTION BEGINNING, ALL SIGNAGE AND TRAFFIC CONTROL SHALL BE IN PLACE.
- 4. THE CONTRACTOR SHALL HAVE A COMPLETE SET OF CONTRACT DOCUMENTS AS WELL AS ALL APPROVALS AND
- 5. THE CONTRACTOR SHALL REPAIR ALL DRIVEWAYS, DRIVEWAY PIPES, CURB AND GUTTER, SIDEWALKS AND STREET TO EXISTING CONDITION OR BETTER.

PAVING/CURBING

- WHERE PROPOSED CURB AND GUTTER TIES TO EXISTING CURB OR CURB AND GUTTER, A TRANSITION OF 10' SHALL BE MADE TO CONFORM TO THE EXISTING HEIGHTS AND SHAPES.
- 2. BEFORE ANY EARTHWORK IS DONE. THE CONTRACTOR SHALL STAKE OUT AND MARK THE LIMITS OF PAVEMENT AND OTHER ITEMS ESTABLISHED IN THE PLANS. THE CONTRACTOR SHALL PROVIDE ALL NECESSARY ENGINEERING AND SURVEYING FOR LINE AND GRADE CONTROL POINTS RELATED TO EARTHWORK.
- 3. ALL PAVEMENT SUB GRADES (EVEN WHEN ROCK IS ENCOUNTERED) SHALL BE SCARIFIED TO A DEPTH OF 8 INCHES AND COMPACTED TO A MINIMUM DENSITY OF 98 PERCENT OF ASTM D-698 DENSITY AT OPTIMUM MOISTURE CONTENT UNLESS OTHERWISE SHOWN IN THE CONSTRUCTION DOCUMENTS OR AS DIRECTED BY THE CERTIFIED MATERIALS TESTING AGENT. FILL SHALL BE PLACED AND COMPACTED IN MAXIMUM 8" LIFTS.
- 4. CONTRACTOR SHALL FURNISH AND INSTALL ALL PAVEMENT MARKINGS AND MISCELLANEOUS STRIPING AS SHOWN ON THE PLANS. ALL ROADWAY PAVEMENT MARKINGS SHALL BE THERMOPLASTIC AND ADHERE TO NCDOT STANDARDS.
- 5. THE CONTRACTOR SHALL CLEAR AND GRUB THE SITE AND PLACE, COMPACT, AND MOISTURE CONDITION ALL FILL PER THE PROJECT GEOTECHNICAL ENGINEER'S SPECIFICATIONS. THE FILL MATERIAL TO BE USED SHALL BE APPROVED BY THE GEOTECHNICAL ENGINEER PRIOR TO PLACEMENT.
- 6. ALL CURB JOINTS SHALL EXTEND THROUGH THE CURB. MINIMUM LENGTH OF OFFSET JOINTS AT RADIUS POINTS IS 1.5 FEET. ALL JOINTS SHALL BE SEALED WITH JOINT SEALANT.
- TESTING OF MATERIALS REQUIRED FOR THE CONSTRUCTION OF THE PAVING IMPROVEMENTS SHALL BE PERFORMED BY AN APPROVED AGENCY FOR TESTING MATERIALS. THE TESTING LABORATORY AND THE PAYMENT OF SUCH TESTING SERVICES SHALL BE MADE BY THE OWNER. IT SHALL BE THE CONTRACTOR'S RESPONSIBILITY THAT THE CERTIFIED MATERIAL TESTING AGENT HAS PERFORMED THE WORK AND THAT THE WORK CONSTRUCTED DOES MEET THE REQUIREMENTS OF THE CITY'S SPECIFICATIONS AND/OR THE PROJECT SPECIFICATIONS, WHICHEVER IS MORE
- 8. ALL SIGNS, PAVEMENT MARKINGS, AND OTHER TRAFFIC CONTROL DEVICES ON PUBLIC STREETS SHALL CONFORM TO MUTCD, NCDOT, AND ROLESVILLE STANDARDS.

STORM DRAINAGE

- 1. THE CONTRACTOR SHALL VERIFY AND COORDINATE ALL DIMENSIONS SHOWN, INCLUDING THE HORIZONTAL AND VERTICAL LOCATION OF CURB INLETS AND GRATE INLETS AND ALL UTILITIES CROSSING THE STORM SEWER.
- 2. THE SITE UTILITY CONTRACTOR SHALL PROVIDE ALL MATERIALS AND APPURTENANCES NECESSARY FOR COMPLETE INSTALLATION OF THE STORM SEWER.
- THE ROLESVILLE INSPECTOR SHALL INSPECT ALL "PUBLIC" CONSTRUCTION. THE CONTRACTOR'S PRICE SHALL INCLUDE ALL INSPECTION FEES.
- 4. ALL RCP STORM SEWER MAINS AND LATERALS SHALL BE MINIMUM CLASS III REINFORCED CONCRETE PIPE.
- 5. ALL PVC PIPE USED IN DRAINAGE SYSTEM SHALL BE MINIMUM SDR-35 OR APPROVED EQUAL.
- 6. ALL PVC TO RCP CONNECTIONS SHALL BE CONSTRUCTED WITH CONCRETE COLLARS.
- 7. THE LOCATIONS OF STORM SEWER STRUCTURES SHOWN ON THESE PLANS (AND PROVIDED IN ASSOCIATED CAD FILES) ARE APPROXIMATE. THE CONTRACTOR SHALL STAKE ALL CURB INLET STRUCTURES SUCH THAT INLET TOPS ALIGN HORIZONTALLY WITH PROPOSED CURB LOCATIONS (PER DETAIL, IF PROVIDED). WHERE PROPOSED STORM SEWERS TIE TO EXISTING STRUCTURES, PIPES, ETC., THE CONTRACTOR SHALL FIELD ADJUST PROPOSED STORM SEWERS TO MATCH THE LOCATIONS OF THESE EXISTING FEATURES.
- 8. RIM ELEVATIONS FOR STORM CATCH BASINS ARE MEASURED TO THE GUTTER FLOW LINE.

TRAFFIC CONTROL NOTES

- 1. WITHIN THE SIGHT TRIANGLES AND SIGHT EASEMENTS SHOWN ON THESE PLANS, NO OBSTRUCTION SHALL BE LOCATED IN WHOLE OR PART BETWEEN (2) FEET AND (8) FEET IN HEIGHT ABOVE THE CURB LINE ELEVATION OR THE NEAREST TRAVELED WAY, IF NO CURBING EXISTS. OBSTRUCTIONS INCLUDE, BUT ARE NOT LIMITED TO, ANY BERM, FOLIAGE, FENCE, WALL, SIGN, PARKED VEHICLE OR OTHER OBJECT.
- 2. ALL CONSTRUCTION SHALL BE IN ACCORDANCE WITH ALL ROLESVILLE AND/OR N.C.D.O.T. STANDARDS AND
- 3. REFER TO MANUAL ON UNIFORM TRAFFIC CONTROL DEVICES (LATEST EDITION) FOR DETAILS OF STANDARD TRAFFIC CONTROL SIGNS AND STANDARDS.

SEEDBED PREPARATION

- 1. CHISEL COMPACTED AREAS AND SPREAD TOPSOIL THREE INCHES DEEP OVER ADVERSE SOIL CONDITIONS, IF
- 2. RIP THE ENTIRE AREA TO SIX INCHES DEEP.
- 3. REMOVE ALL LOOSE ROCK, ROOTS AND OTHER OBSTRUCTIONS, LEAVING SURFACE REASONABLY SMOOTH AND
- 4. APPLY AGRICULTURAL LIME, FERTILIZER AND SUPERPHOSPHATE UNIFORMLY AND MIX WITH SOIL (SEE MIXTURE BELOW).*
- 5. CONTINUE TILLAGE UNTIL A WELL-PULVERIZED, FIRM, REASONABLY UNIFORM SEEDBED IS PREPARED FOUR TO SIX INCHES DEEP.
- 6. SEED ON A FRESHLY PREPARED SEEDBED AND COVER SEED LIGHTLY WITH SEEDING EQUIPMENT OR CULTIPACK AFTER SEEDING.
- 7. MULCH IMMEDIATELY AFTER SEEDING AND ANCHOR MULCH.
- 8. INSPECT ALL SEEDED AREAS AND MAKE NECESSARY REPAIRS OR RESEEDINGS WITHIN THE PLANTING SEASON, IF POSSIBLE. IF STAND SHOULD BE MORE THAN 60% DAMAGED, RE-ESTABLISH FOLLOWING THE ORIGINAL LIME, FERTILIZER AND SEEDING RATES.
- 9. CONSULT S&EC ENVIRONMENTAL ENGINEERS ON MAINTENANCE TREATMENT AND FERTILIZATION AFTER PERMANENT COVER IS ESTABLISHED.
- 10. *AGRICULTURAL LIMESTONE 2 TONS/ ACRES (3 TONS/ACRE IN CLAY SOILS) FERTILIZER 1,000 LBS. / ACRE -10-10-10 SUPERPHOSPHATE- 500 LBS> / ACRE -20% ANALYSIS MULCH -2 TONS / ACRE - SMALL GRAIN STRAW ANOTHER - ASPHALT EMULSION @ 300 GALS./ ACRE

PLANTING RATE

25 LBS/ACRE

) GROW OVER 12" IN HEIGHT BEFORE

SEEDING SCHEDULE

(NOV 1 - MAR 1)

LANDSCAPE PLAN FOR FINAL SEEDING.

AUG 15 - NOV 1 NOV 1 - MAR 1	TALL FESCUE TALL FESCUE & ABRUZZI RYE	300 LBS/ACRE 300 LBS/ACRE 25 LBS/ACRE
MAR 1 - APR 15 APR 15 - JUN 30 JUL 1 - AUG 15	TALL FESCUE HULLED COMMON BERMUDAGRASS TALL FESCUE AND ***BROWNTOP MILLET ***OR SORGHUM-SUDAN HYBRIDS	300 LBS/ACRE 25 LBS/ACRE 120 LBS/ACRE 35 LBS/ACRE 30 LBS/ACRE
SLOPES (3	3:1 TO 2:1)	
MAR 1 - JUN 1 (MAR 1 - APR 15) (MAR 1 - JUN 30) (MAR 1 - JUN 30)	SERICEA LESPEDEZA (SCARIFIED) AND ADD TALL FESCUE OR ADD WEEPING LOVEGRASS OR ADD HULLED COMMON BERMUDAGRASS	50 LBS/ACRE 120 LBS/ACRE 10 LBS/ACRE 25 LBS/ACRE
JUN 1 - SEP 1	***TALL FESCUE AND ***BROWNTOP MILLET	120 LBS/ACRE 35 LBS/ACRE
SEP 1 - MAR 1	***OR SORGHUM-SUDAN HYBRIDS SERICEA LESPEDEZA (UNHULLED- UNSCARIFED) AND TALL FESCUE	30 LBS/ACRE

SHOULDERS, SIDE DITCHES, SLOPES (MAX 3:1)

CONSULT CONSERVATION ENGINEER OR SOIL CONSERVATION SERVICE FOR ADDITIONAL INFORMATION CONCERNING OTHER ALTERNATIVES FOR VEGETATION OF DENUDED AREAS THE ABOVE VEGETATION RATES ARE THOSE WHICH DO WELL UNDER LOCAL CONDITIONS; OTHER SEEDING RATE COMBINATIONS ARE POSSIBLE

ADD ABRUZZI RYE

MOWING, OTHERWISE FESCUE MAY BE SHADED OUT. *NOTE: THIS SEEDING SCHEDULE IS FOR EROSION AND SEDIMENT CONTROL ONLY. SEE

***TEMPORARY - RESEED ACCORDING TO OPTIMUM SEASON FOR DESIRED PERMANENT

THE CONTRACTOR SHALL PROVIDE GROUND COVER ON DESIGNATED AREAS AND SLOPES GREATER THAN 3:1 WITHIN 7 DAYS FOLLOWING COMPLETION OF ANY PHASE OF GRADING CONTRACTOR SHALL PROVIDE GROUND COVER IN 14 DAYS ON ALL OTHER AREAS FOLLOWING COMPLETION OF ANY PHASE OF GRADING. PERMANENT GROUND COVER FOR ALL DISTURBED AREAS SHALL BE PROVIDED WITHIN 15 WORKING DAYS OR 90 CALENDAR

NURSE CROP: WHEN SEEDING BERMUDA GRASS SEED CONTRACTOR SHALL ADD 25 LB/AC OF ANNUAL RYE GRASS AS NURSE CROP UNTIL PERMANENT ESTABLISHMENT OF BERMUDA GRASS

DAYS (WHICHEVER IS SHORTER) FOLLOWING COMPLETION OF CONSTRUCTION.

REQUIRED PRIOR TO PROJECT COMPLETION AND ACCEPTANCE.

- 1. UNLESS OTHERWISE INDICATED, ALL VEGETATIVE AND STRUCTURAL EROSION AND SEDIMENT CONTROL MEASURES SHALL BE CONSTRUCTED AND MAINTAINED IN ACCORDANCE WITH THE MINIMUM STANDARDS AND SPECIFICATIONS OF THE NORTH CAROLINA EROSION AND SEDIMENT CONTROL HANDBOOK.
- 2. THE CONTRACTOR SHALL INSTALL AND MAINTAIN THROUGHOUT THE PROJECT CONSTRUCTION ALL EROSION CONTROL MEASURES SHOWN WITHIN THESE PLANS IN ACCORDANCE WITH APPLICABLE NORTH CAROLINA DEPARTMENT OF ENVIRONMENTAL QUALITY (NCDEQ) AND WAKE COUNTY EROSION AND SEDIMENT CONTROL
- 3. ALL CONSTRUCTION WORK SHALL BE IN COMPLIANCE WITH REGULATIONS OF THE NATIONAL POLLUTANT
- 4. ALL EROSION AND SEDIMENT CONTROL MEASURES ARE TO BE PLACED PRIOR TO CLEARING AND/OR LAND DISTURBANCE.
- 5. A COPY OF THE APPROVED EROSION AND SEDIMENT CONTROL PLAN AND PERMIT SHALL BE MAINTAINED ON THE
- 6. THE CONTRACTOR SHALL DILIGENTLY AND CONTINUOUSLY MAINTAIN ALL EROSION CONTROL DEVICES AND STRUCTURES TO MINIMIZE EROSION. THE CONTRACTOR SHALL MAINTAIN CLOSE CONTACT WITH THE NCDENR EROSION CONTROL INSPECTOR SO THAT PERIODIC INSPECTIONS CAN BE PERFORMED AT APPROPRIATE STAGES
- 7. APPROVAL OF THIS PLAN IS NOT AN AUTHORIZATION TO GRADE ADJACENT PROPERTIES. WHEN FIELD CONDITIONS WARRANT OFF-SITE GRADING, PERMISSION MUST BE OBTAINED FROM THE AFFECTED PROPERTY OWNERS. CONTACT PROJECT ENGINEER AND PROJECT EROSION CONTROL INSPECTOR TO ENSURE ADDITIONAL EROSION CONTROL MEASURES ARE INSTALLED PRIOR TO OFF-SITE GRADING.
- 8. PRIOR TO COMMENCING LAND DISTURBING ACTIVITIES IN AREAS OTHER THAN INDICATED ON THESE PLANS (INCLUDING, BUT NOT LIMITED TO OFF-SITE BORROW OR WASTE AREAS, STAGING OR STORAGE AREAS), THE CONTRACTOR SHALL PREPARE AND SUBMIT A SUPPLEMENTARY EROSION CONTROL PLAN TO THE OWNER FOR REVIEW AND TO THE WAKE COUNTY FOR APPROVAL. CONTRACTOR SHALL PAY ALL FEES REQUIRED AND SHALL INSTALL NECESSARY MEASURES AT NO SEPARATE PAYMENT. THE CONTRACTOR SHALL PROVIDE THE OWNER
- 9. EROSION AND SEDIMENT CONTROL MEASURES SHALL BE MAINTAINED CONTINUOUSLY, RELOCATED WHEN AND AS NECESSARY, AND SHALL BE CHECKED AFTER EVERY RAINFALL. SEEDED AREAS SHALL BE CHECKED REGULARLY AND SHALL BE WATERED, FERTILIZED, RESEEDED AND MULCHED AS NECESSARY TO OBTAIN A DENSE STAND OF
- STABILIZED SHALL BE TOP SOILED AND SEEDED, TEMPORARILY OR PERMANENTLY IN ACCORDANCE WITH THE
- 11. CONTRACTOR TO ENSURE THAT SEDIMENT LADEN RUNOFF DOES NOT LEAVE SITE LIMITS OR ENTER PROTECTED
- 12. ROLLED EROSION CONTROL PRODUCTS (RECP'S) SHOULD BE USED TO AID PERMANENT VEGETATED STABILIZATION WHEN MULCH CANNOT BE ADEQUATELY TACKED AND WHERE IMMEDIATE GROUND COVER IS REQUIRED TO
- 13. ALL TEMPORARY EROSION AND SEDIMENT CONTROL MEASURES SHALL BE REMOVED WITHIN 21 DAYS AFTER FINAL SITE STABILIZATION OR AFTER THE TEMPORARY MEASURES ARE NO LONGER NEEDED. TRAPPED SEDIMENT AND THE DISTURBED SOIL AREAS RESULTING FROM THE DISPOSITION OF TEMPORARY MEASURES SHALL BE
- 14. WHERE SEDIMENT IS TRANSPORTED ONTO A PAVED OR PUBLIC ROAD SURFACE, THE ROAD SURFACE SHALL BE CLEANED THOROUGHLY AT THE END OF EACH DAY. SEDIMENT SHALL BE REMOVED FROM THE ROADS BY SHOVELING OR SWEEPING AND TRANSPORTED TO A SEDIMENT CONTROL DISPOSAL AREA. STREET WASHING SHALL BE ALLOWED ONLY AFTER SEDIMENT IS REMOVED IN THIS MANNER.
- 15. WHEN A CRUSHED STONE CONSTRUCTION ENTRANCE HAS BEEN COVERED WITH SOIL OR HAS BEEN PUSHED INTO THE SOIL BY CONSTRUCTION TRAFFIC, IT SHALL BE REPLACED WITH A DEPTH OF STONE EQUAL TO THAT OF THE ORIGINAL APPLICATION.
- AND ALL CONSTRUCTION ACCESS LOCATIONS INTO NON-PAVED AREAS. TWO TO THREE INCH STONE SHALL BE USED FOR THE TEMPORARY GRAVEL CONSTRUCTION ENTRANCE.
- IMMEDIATELY REPLACED AND THE INLET CLEANED. FLUSHING IS NOT AN ACCEPTABLE METHOD OF CLEANING. TRAPPING MEASURES. THE APPLICANT IS RESPONSIBLE FOR THE TEMPORARY PROTECTION AND PERMANENT
- 19. SEDIMENT BASINS AND TRAPS, PERIMETER DIKES, SEDIMENT BARRIERS AND OTHER MEASURES INTENDED TO TRAP SEDIMENT SHALL BE CONSTRUCTED AS A FIRST STEP IN ANY LAND-DISTURBING ACTIVITY AND SHALL BE MADE
- 20. ALL DISTURBED AREAS ARE TO DRAIN TO APPROVED SEDIMENT CONTROL MEASURES AT ALL TIMES DURING LAND
- DISTURBING ACTIVITIES AND DURING SITE DEVELOPMENT UNTIL FINAL STABILIZATION IS ACHIEVED. 21. DURING DEWATERING OPERATIONS, WATER SHALL BE PUMPED INTO AN APPROVED FILTERING DEVICE PRIOR TO
- 22. THE CONTRACTOR SHALL INSPECT ALL EROSION CONTROL MEASURES PERIODICALLY AND AFTER EACH RUNOFF-PRODUCING EVENT. ANY NECESSARY REPAIRS OR CLEANUP TO MAINTAIN THE EFFECTIVENESS OF THE EROSION CONTROL DEVICES SHALL BE MADE IMMEDIATELY.
- 23. ALL TEMPORARY EROSION CONTROL MEASURES SHALL BE REMOVED BY CONTRACTOR ONCE STABILIZATION OR A SUFFICIENT GROUND COVER HAS BEEN ESTABLISHED OR AS DIRECTED BY THE ENGINEER. WAKE COUNTY
- 24. STABILIZATION MEASURES SHALL BE APPLIED TO STRUCTURES SUCH AS DAMS, DIKES AND DIVERSIONS
- 25. ADDITIONAL EROSION CONTROL MEASURES MAY BE REQUIRED DEPENDING UPON FIELD CONDITIONS.
- 26. LIMITS OF GRADING SHOWN ON THE PLAN ARE MAXIMUM LIMITS FOR EROSION CONTROL PURPOSES ONLY. SURVEYOR TO DETERMINE ACTUAL LIMIT.
- 28. GRADING MORE THAN 12,000 SF WITHOUT AN APPROVED EROSION CONTROL PLAN IS A VIOLATION OF THE WAKE

- *NOT ALL ABBREVIATIONS MAY BE USED FOR THIS PROJECT
- CB CATCH BASIN
- YI YARD INLET CO - CLEAN OUT

TYP. – TYPICAL

- FES FLARED-END-SECTION
- PVC POLYVINYL CHLORIDE RCP - REINFORCED CONCRETE PIPE

EXISTING TOPOGRAPHICAL INFORMATION IS BASED ON A TOPOGRAPHIC SURVEY OBTAINED ON 02/23/2023 BY CMP PROFESSIONAL LAND SURVEYORS. 333 S. WHITE STREET. WAKE FOREST, NC, 27588, PHONE: (919) 556-3148. CONTRACTOR SHALL BE RESPONSIBLE FOR VERIFYING ALL EXISTING INFORMATION, DEPICTED OR NOT PRIOR TO CONSTRUCTION AND REPORT



EROSION CONTROL NOTES

DISCHARGE ELIMINATION SYSTEM (NPDES) STORM WATER GENERAL PERMIT.

SITE AT ALL TIMES.

OF CONSTRUCTION.

AND THE ENGINEER A COPY OF THE AMENDED PERMIT.

10. STABILIZATION IS THE BEST FORM OF EROSION CONTROL. ALL DISTURBED AREAS WHICH ARE NOT OTHERWISE NORTH CAROLINA SEDIMENT CONTROL REGULATIONS. PERMANENT SEEDING AND GRASS ESTABLISHMENT IS

AREAS. ANY SEDIMENT DEPOSITED BEYOND DISTURBED AREA WITHIN SITE LIMITS SHALL BE REMOVED.

OF SLOPES 2:1 OR GREATER AND WITH MORE THAN 10' OF VERTICAL RELIEF. RECP'S SHOULD ALSO BE USED PREVENT EROSION DAMAGE.

PERMANENTLY STABILIZED TO PREVENT FURTHER EROSION AND SEDIMENTATION.

16. TEMPORARY CONSTRUCTION ENTRANCES SHALL BE REQUIRED AT ALL CONSTRUCTION STAGING AREA ENTRANCES

17. ALL DRAINAGE INLETS SHALL BE PROTECTED FROM SILTATION. INEFFECTIVE PROTECTION DEVICES SHALL BE

18. DURING CONSTRUCTION OF THE PROJECT, SOIL STOCKPILES SHALL BE STABILIZED OR PROTECTED WITH SEDIMENT STABILIZATION OF ALL SOIL STOCKPILES ON SITE AS WELL AS SOIL INTENTIONALLY TRANSPORTED FROM THE

FUNCTIONAL BEFORE UPSLOPE LAND DISTURBANCE TAKES PLACE.

DISCHARGE TO RECEIVING OUTLET.

INSPECTOR'S FINAL APPROVAL IS REQUIRED.

IMMEDIATELY AFTER INSTALLATION.

27. ANY GRADING BEYOND THE DENUDED LIMITS SHOWN ON THE PLAN IS A VIOLATION OF THE WAKE COUNTY EROSION CONTROL ORDINANCE, AND IS SUBJECT TO A FINE.

COUNTY EROSION CONTROL ORDINANCE AND IS SUBJECT TO A FINE.

ABBREVIATIONS

DI - DROP INLET EX — EXISTING

JB - JUNCTION BOX LOD - LIMITS OF DISTURBANCE

POTENTIAL CONFLICTS TO OWNER AND ENGINEER.

SDP-23-09


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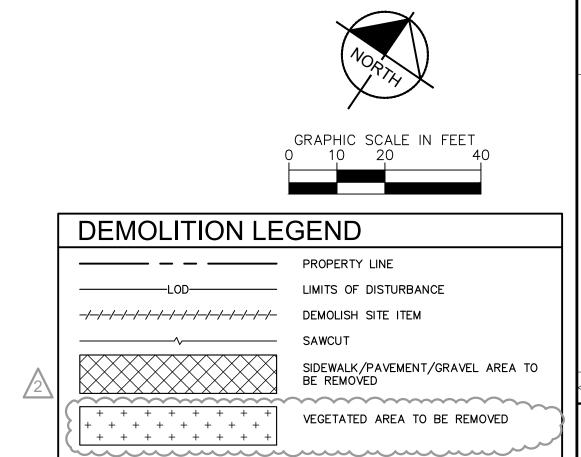
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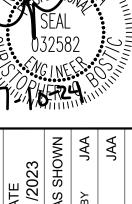
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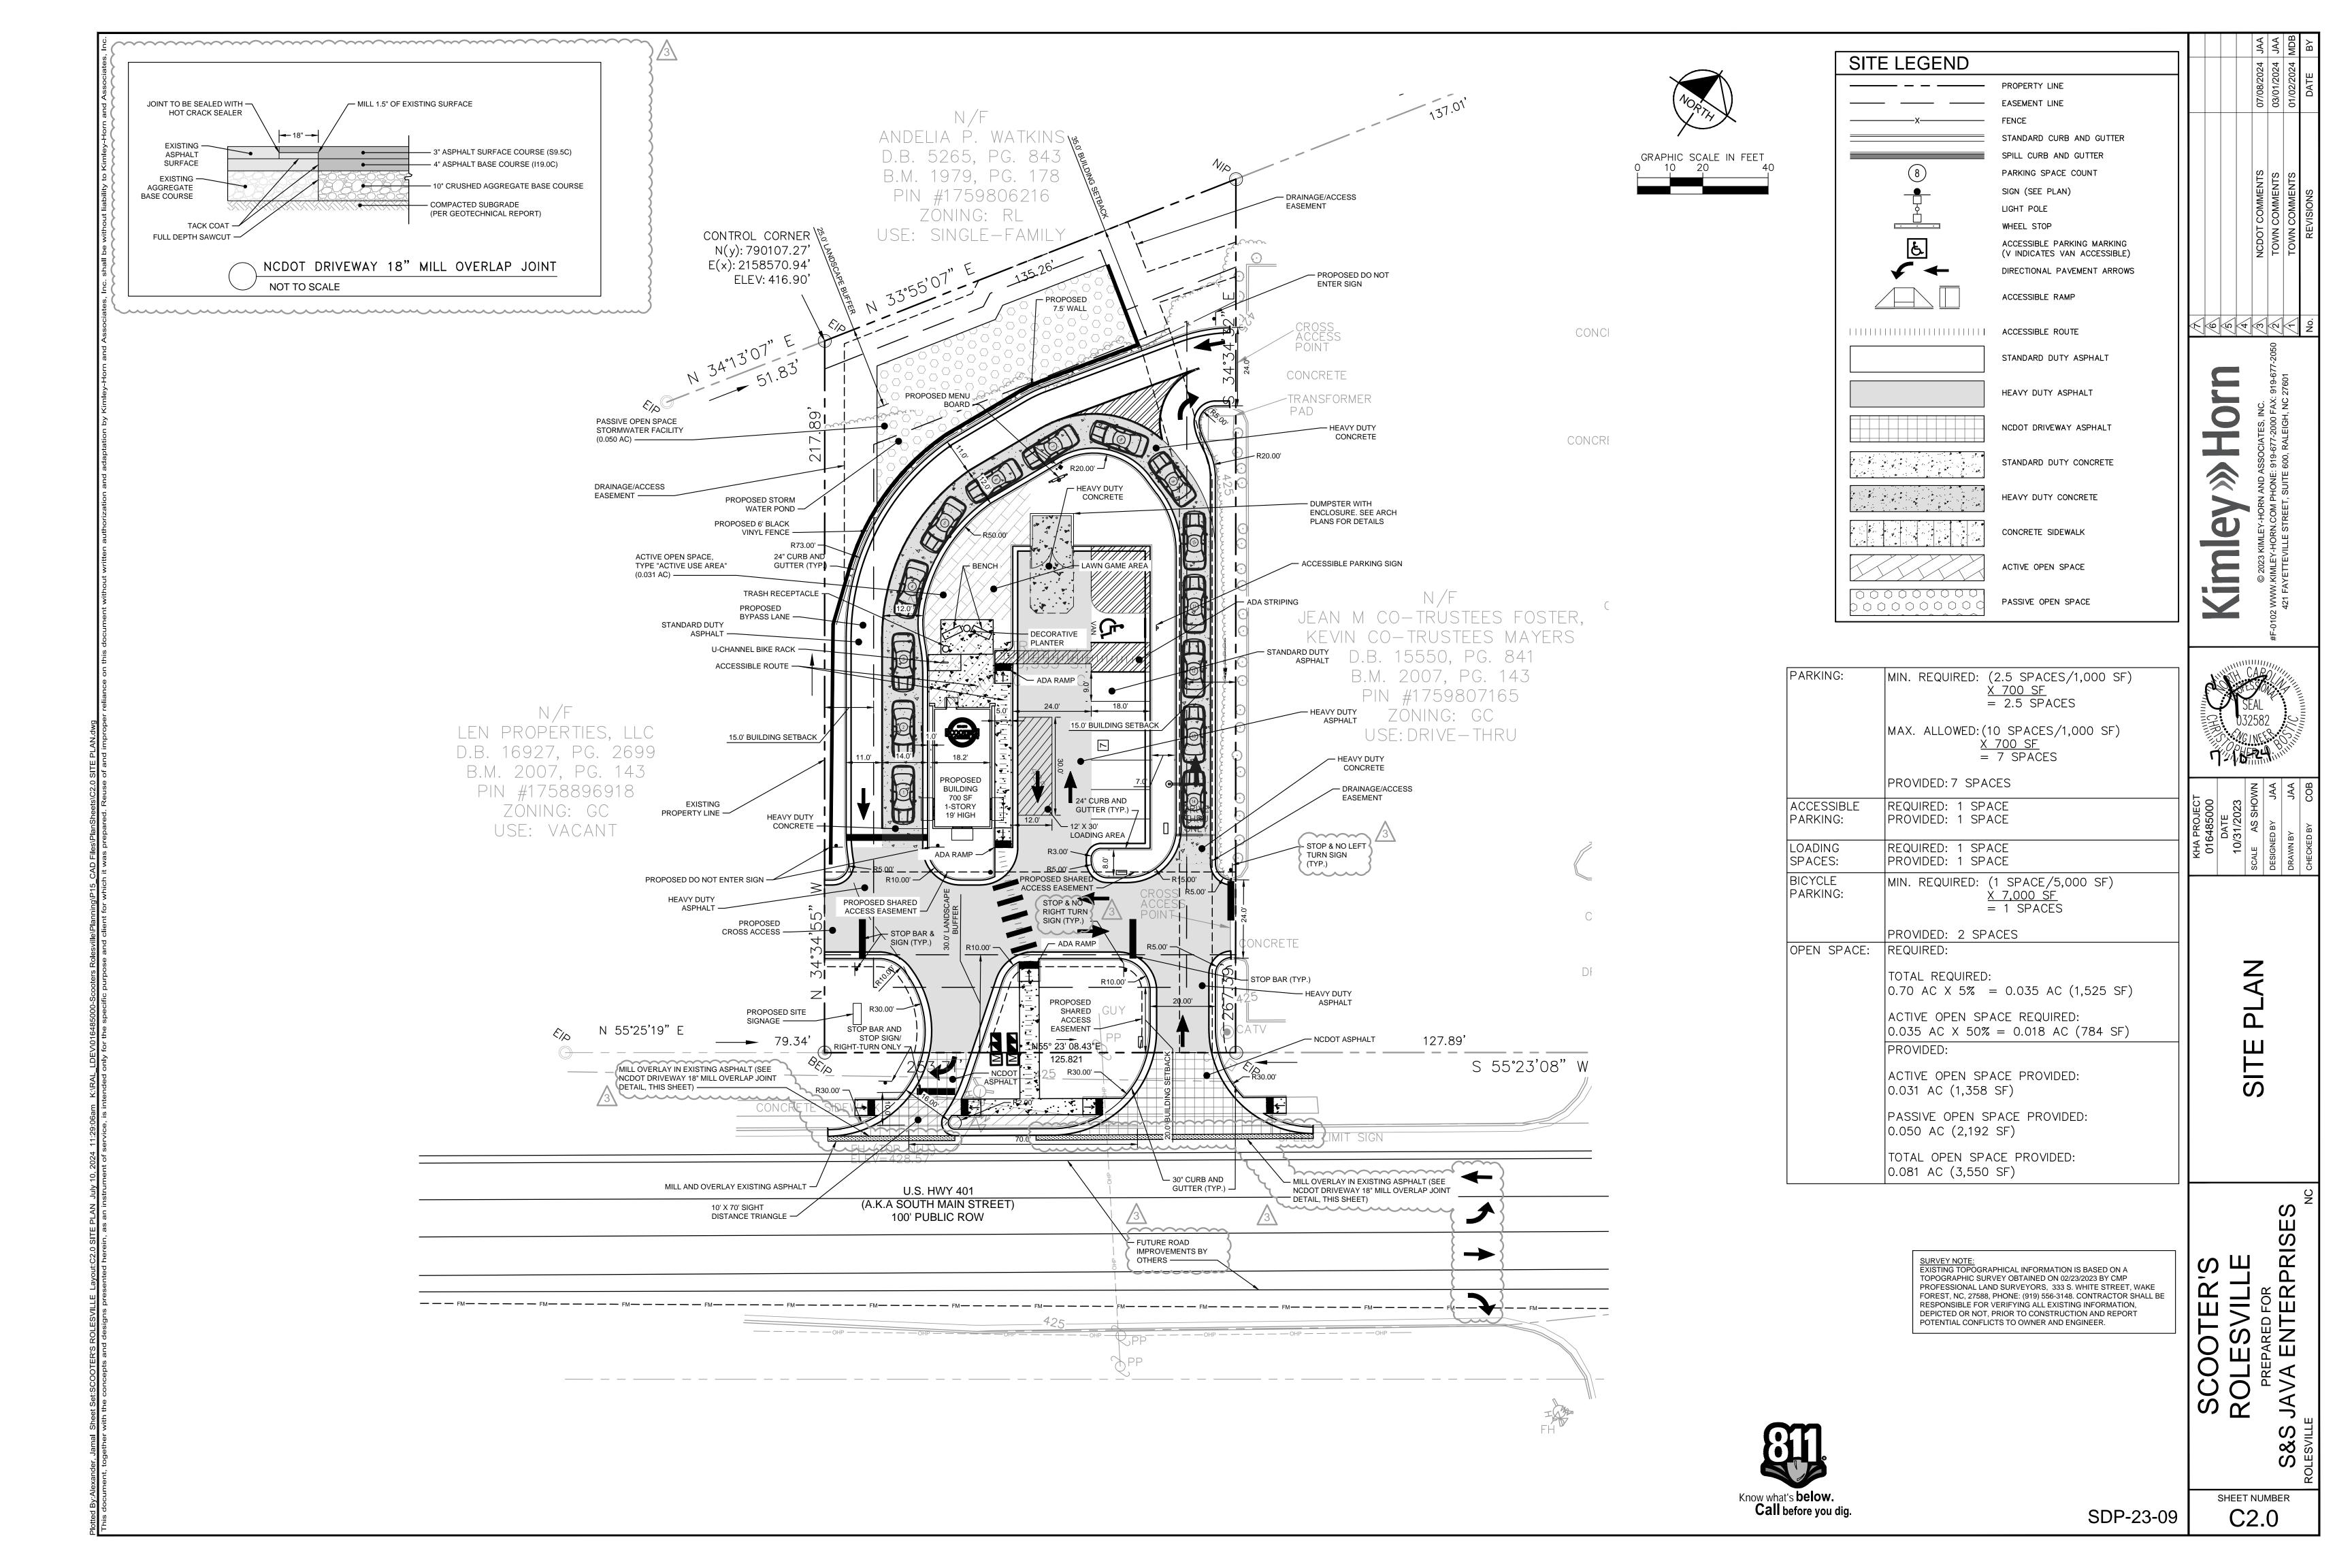



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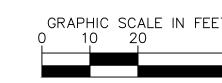
FOREST, NC, 27588, PHONE: (919) 556-3148. CONTRACTOR SHALL BE RESPONSIBLE FOR VERIFYING ALL EXISTING INFORMATION, DEPICTED OR NOT, PRIOR TO CONSTRUCTION AND REPORT

POTENTIAL CONFLICTS TO OWNER AND ENGINEER.





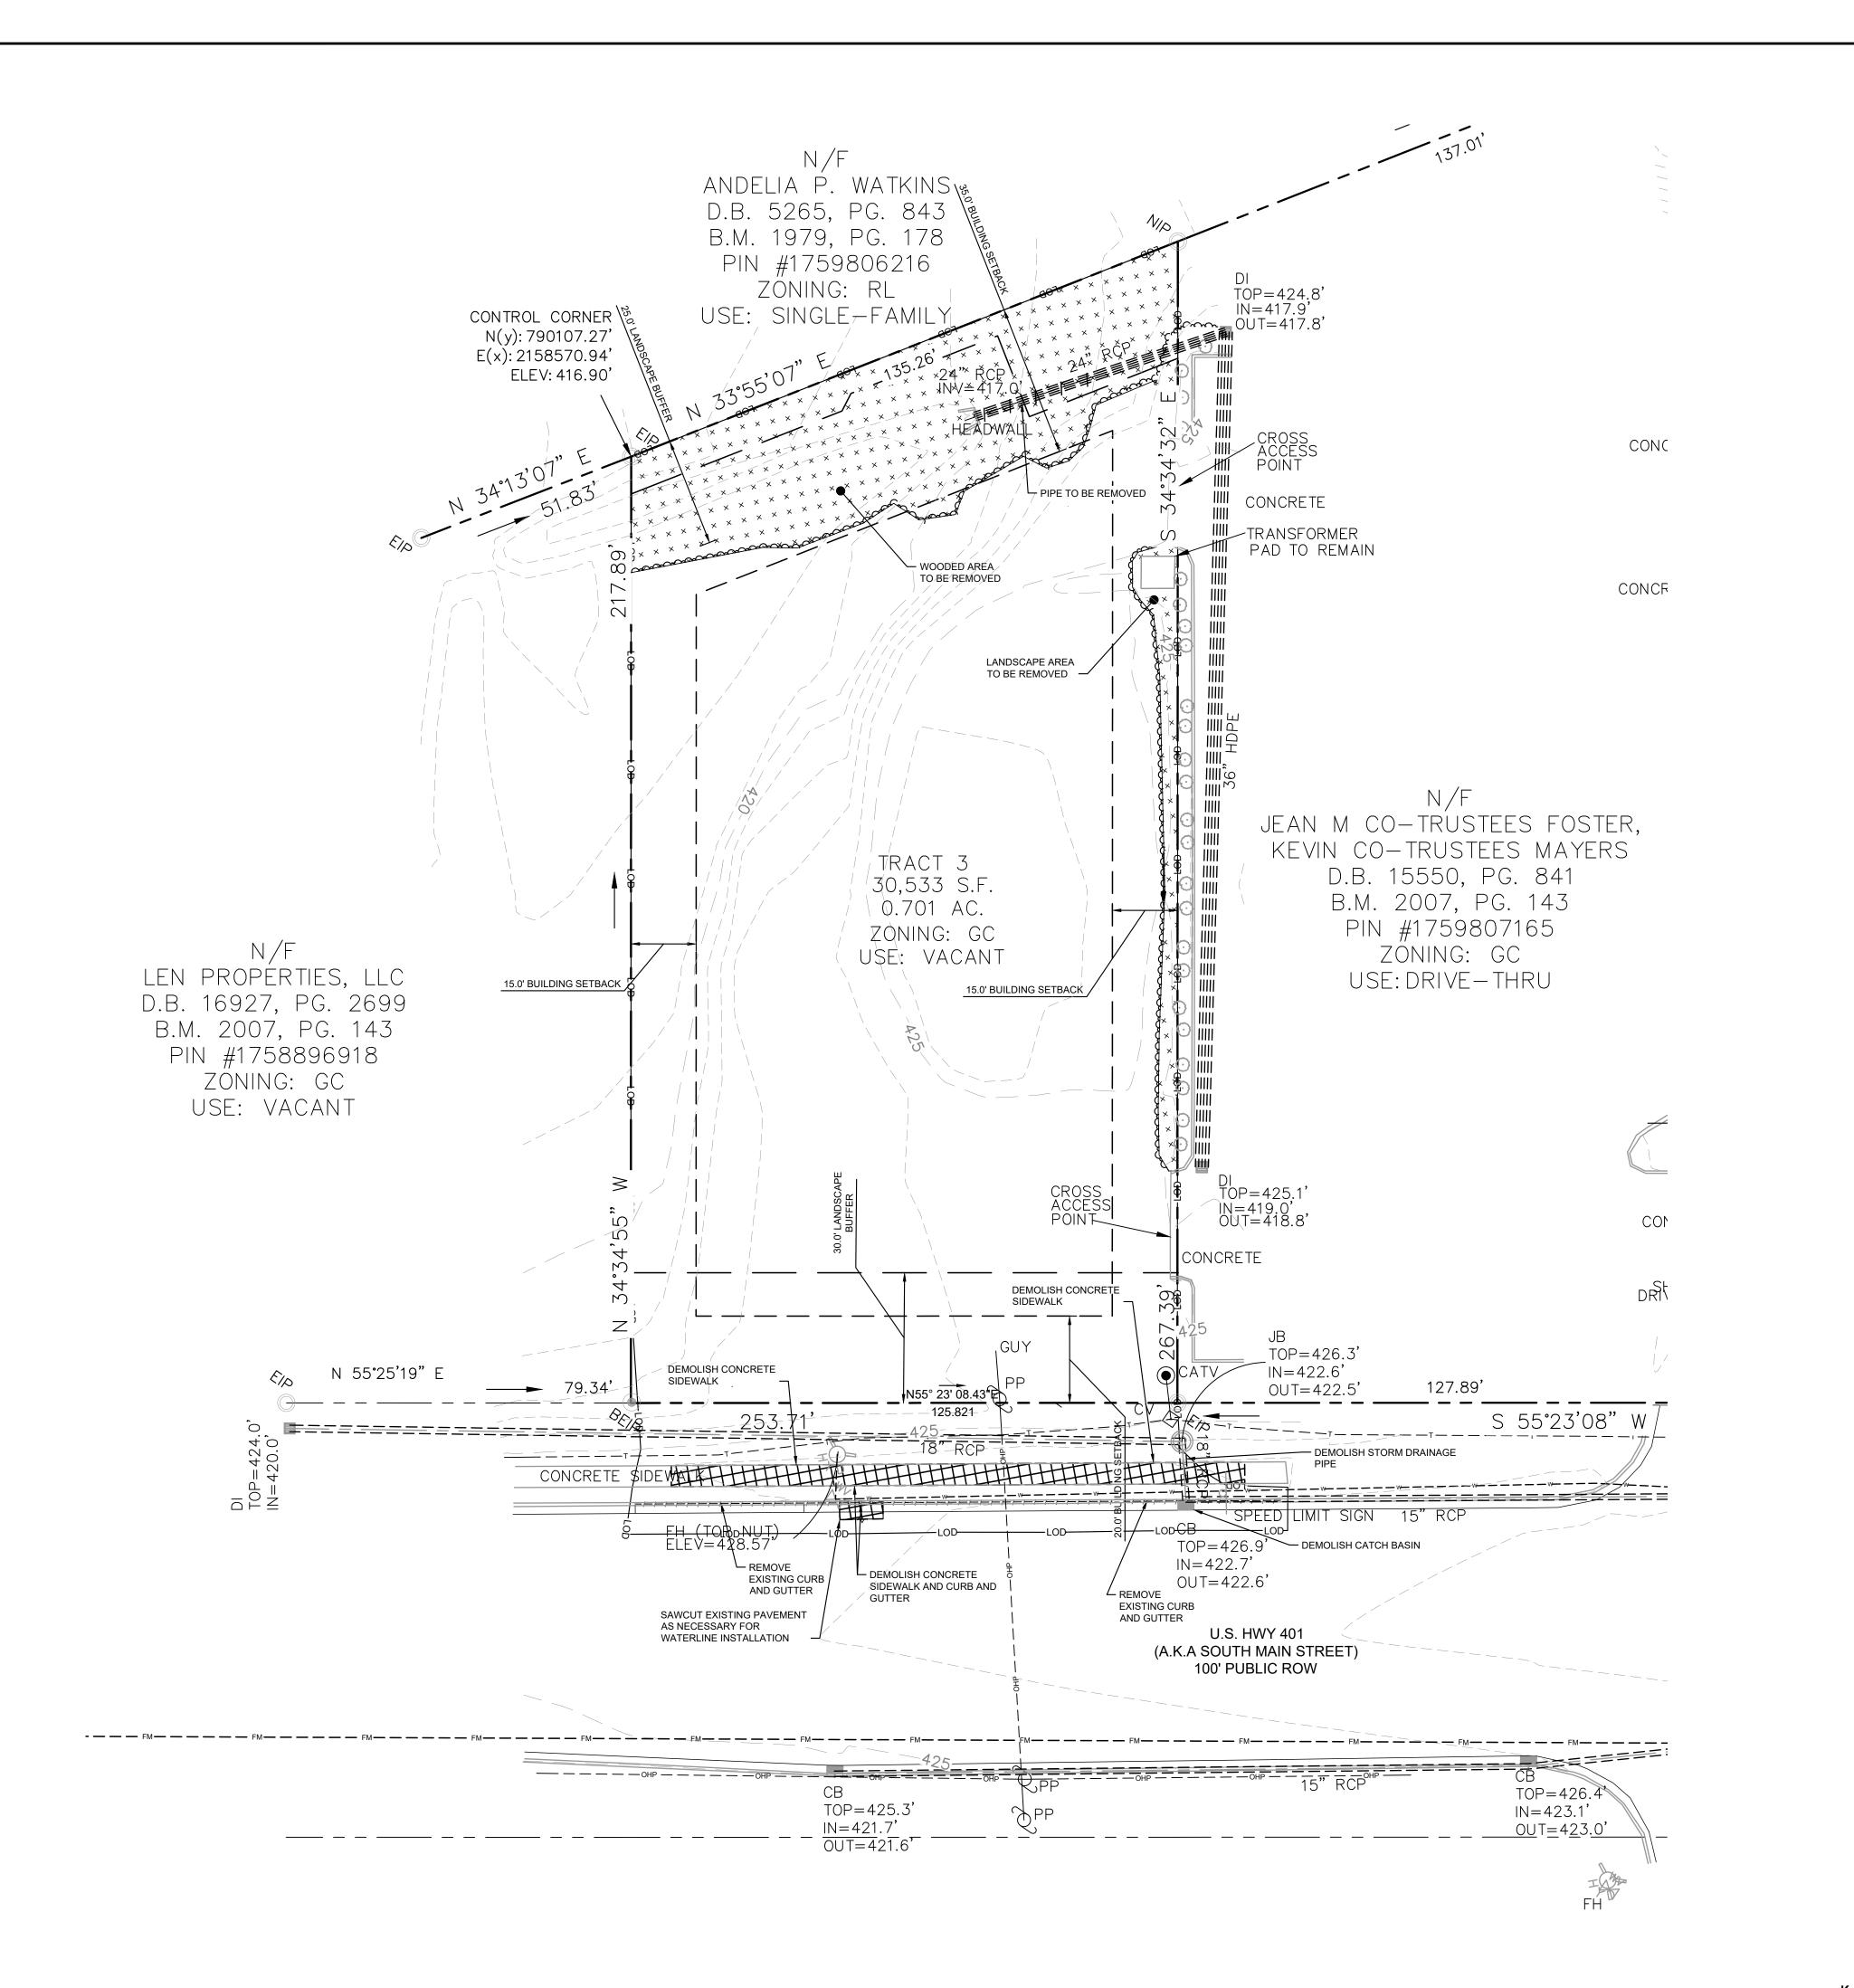

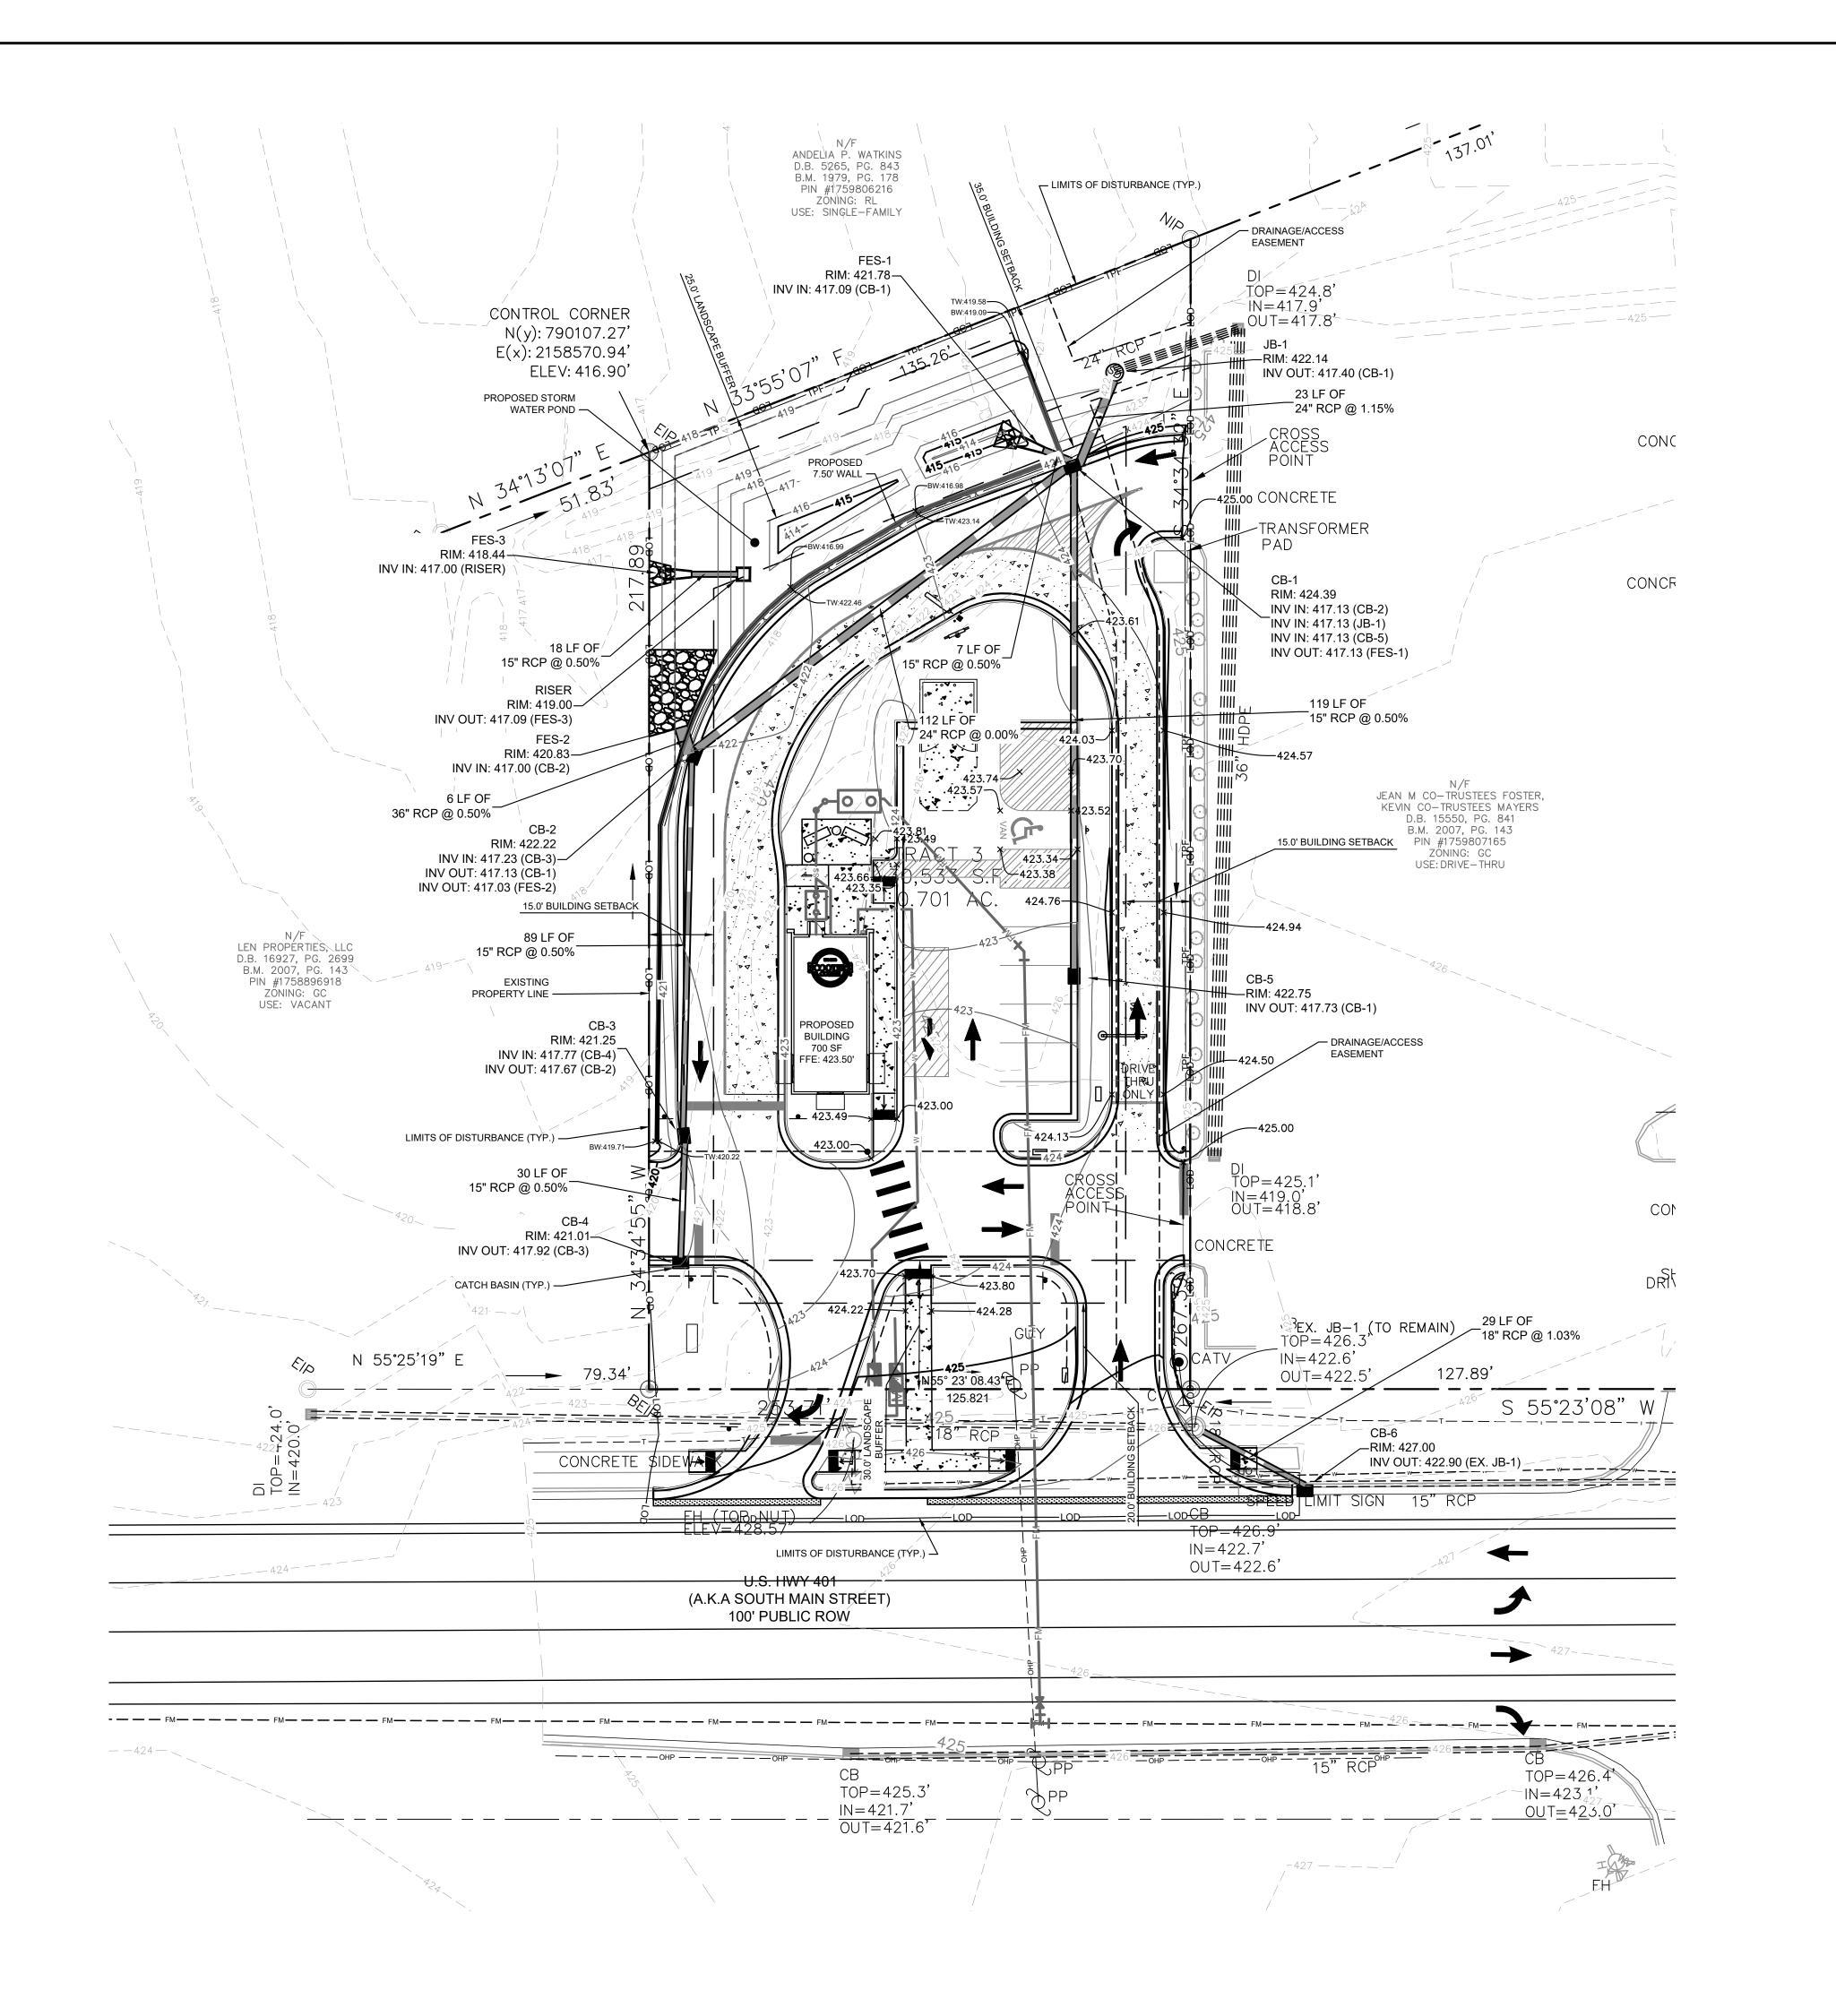

GRADING AND [DRAINAGE LEGEND
	PROPERTY LINE
TCE	TEMPORARY CONSTRUCTION EASEMENT
	STORM DRAIN (≥ 12 INCH)
SD	STORM DRAIN (< 12 INCH)
RD	ROOF DRAIN
UD	UNDER DRAIN
=======================================	CURB AND GUTTER
	SPILL CURB AND GUTTER
CL	CLEARING LIMITS
— — — — — 805— — — — —	EXISTING CONTOUR
805——	PROPOSED CONTOUR
826.00	SPOT ELEVATION
	CATCH BASIN (CB)
SD	MANHOLE (SDMH)
•	CLEANOUT (SDCO)
	DROP INLET (DI)
	AREA DRAIN (AD)
	CONTROL STRUCTURE (CS)
	FLARED END SECTION (FES)
	CONCRETE HEADWALL (HW)
	RIP-RAP APRON
~~ ~	FLOW ARROW
TW	TOP OF WALL (GRADE ELEV.)
BW	BOTTOM OF WALL (GRADE ELEV.)
TP	TOP OF PAVEMENT (GRADE ELEV.)
TC	TOP OF CURB (GRADE ELEV.)
TC/TP	FLUSH CURB (GRADE ELEV.)

WT

WATER TIGHT JOINTS (WT)

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POTENTIAL CONFLICTS TO OWNER AND ENGINEER.

SEAL 032582

F 6 6 4 6 0 4

DATE
10/31/2023
SCALE AS SHOWN
DESIGNED BY JAA
DRAWN BY JAA


ADING AND INAGE PLAN

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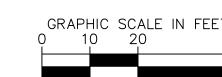
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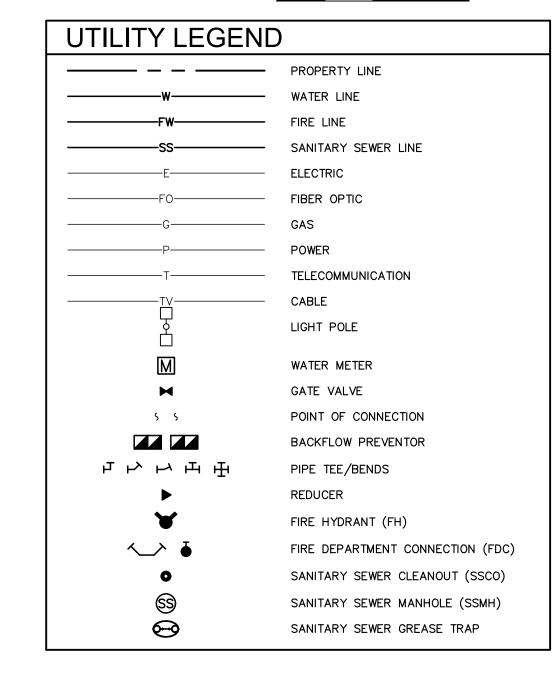
SHEET NUMBER
C3.0

Know what's below.
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SITE PERMITTING APPROVAL

Water and Sewer Permits (If applicable)

The City of Raleigh consents to the connection and extension of the City's Public Sewer System as shown on this plan. The material and Construction methods used for this project shall conform to the standards and specifications of the City's Public Utilities Handbook. City of Raleigh Public Utilities Department Permit #

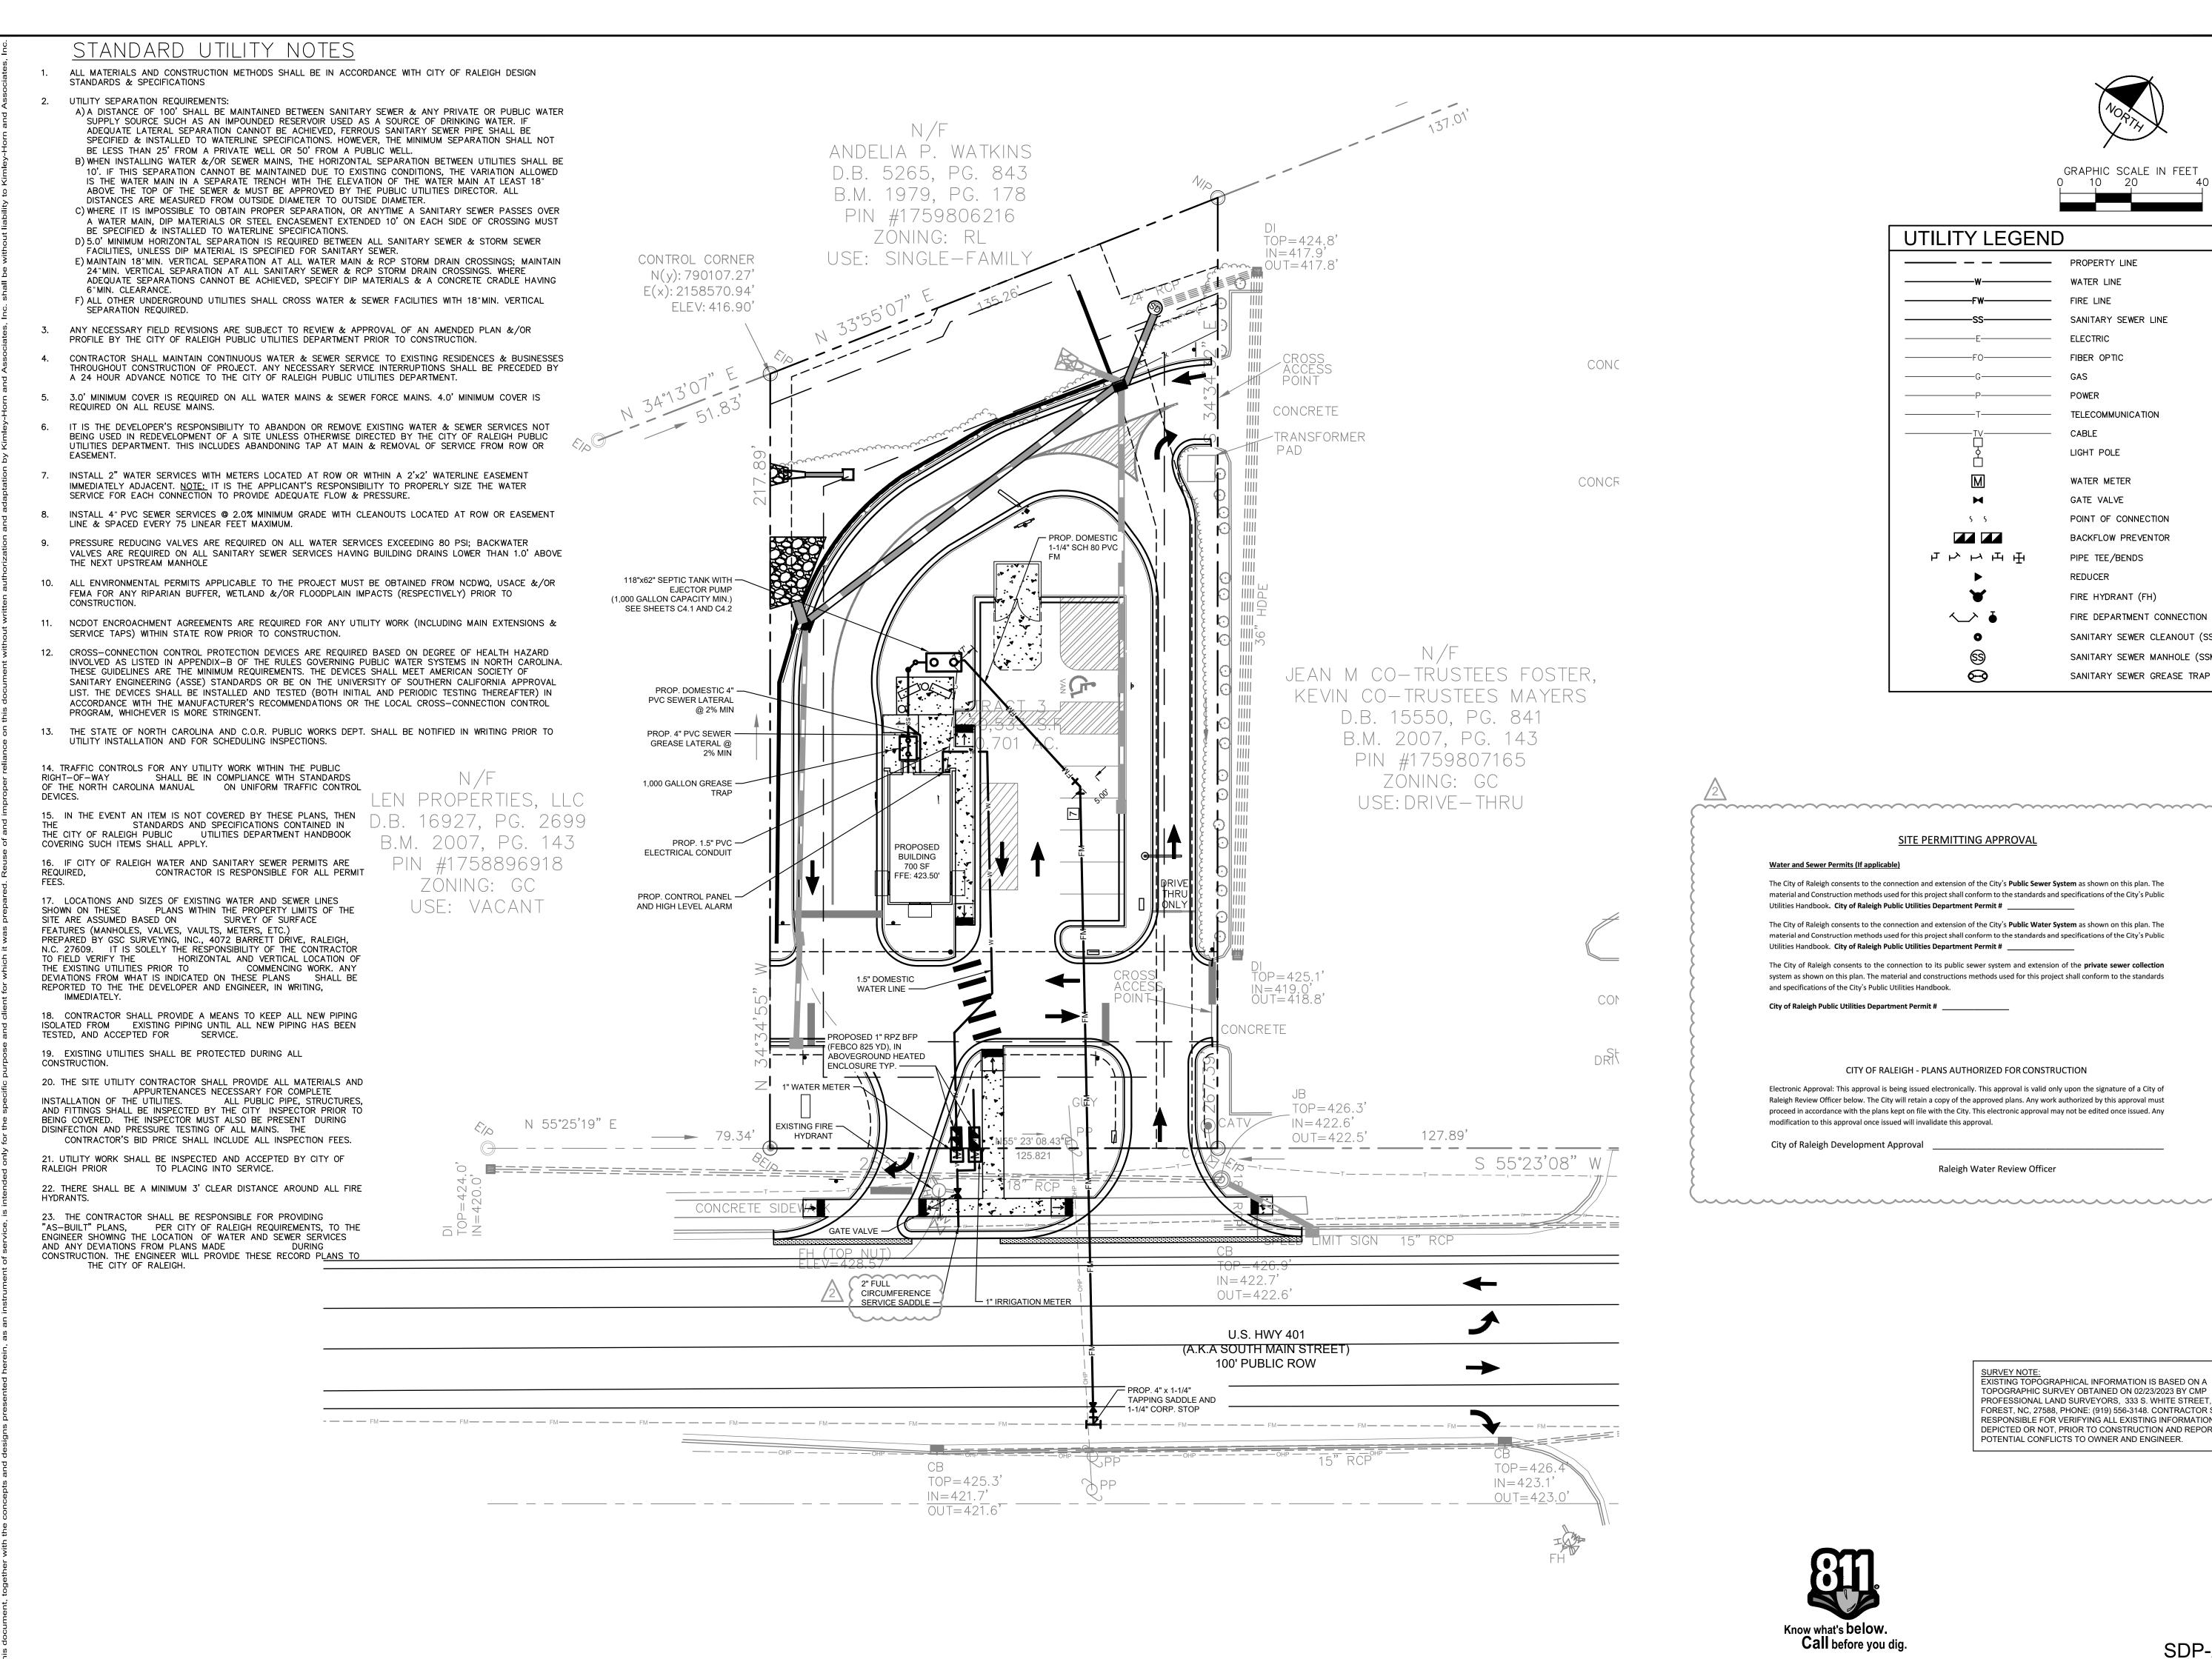The City of Raleigh consents to the connection and extension of the City's Public Water System as shown on this plan. The material and Construction methods used for this project shall conform to the standards and specifications of the City's Public Utilities Handbook. City of Raleigh Public Utilities Department Permit #

The City of Raleigh consents to the connection to its public sewer system and extension of the **private sewer collection** system as shown on this plan. The material and constructions methods used for this project shall conform to the standards and specifications of the City's Public Utilities Handbook.

City of Raleigh Public Utilities Department Permit #

CITY OF RALEIGH - PLANS AUTHORIZED FOR CONSTRUCTION

Electronic Approval: This approval is being issued electronically. This approval is valid only upon the signature of a City of Raleigh Review Officer below. The City will retain a copy of the approved plans. Any work authorized by this approval must proceed in accordance with the plans kept on file with the City. This electronic approval may not be edited once issued. Any modification to this approval once issued will invalidate this approval.

City of Raleigh Development Approval

Raleigh Water Review Officer


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SHEET NUMBER C4.0

ONTROL	SEPTIC TANK GENERAL INFORMATION			
NS.	AVERAGE DAILY FLOW	306 GPD		
	TANK	1000 GAL ROTH TANK		
	TANK DIMENSIONS	118"x62"x52"		
	DISCHARGE PIPING	1.25"Ø SCH 80 PVC		
	CONTROL PANEL	ORENCO S1		
	HORSEPOWER	1 HP (NON-OVERLOADING OVER ENTIRE PUMP CURVE)		
	VOLTAGE/PHASE/CYCLES	240 V / 1 PHASE / 60 HZ		
	PUMP	ORENCO PF100511		
	PRIMARY LEVEL SENSING METHOD	FLOATS (3)		
	FLOAT SETTINGS	9", 12" (FROM TOP OF TANK)		
	FLOAT FUNCTIONS	HIGH LEVEL, ON/OFF		

Pump Curves




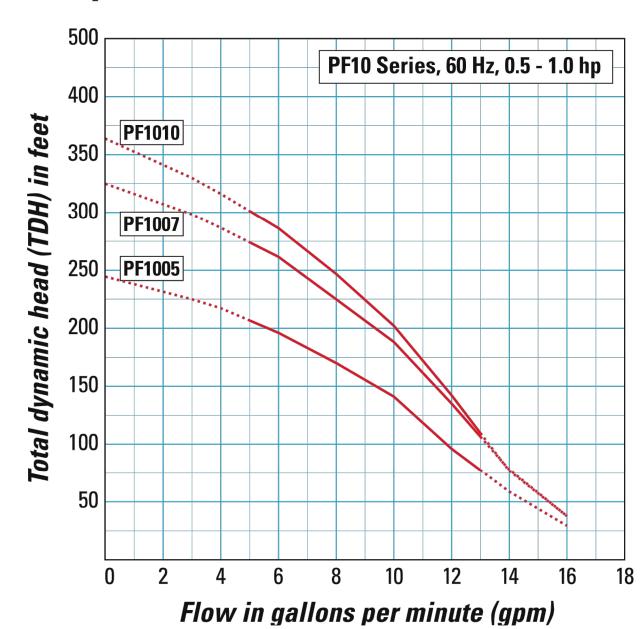


MECHANICAL

S&S

SHEET NUMBER C4.1

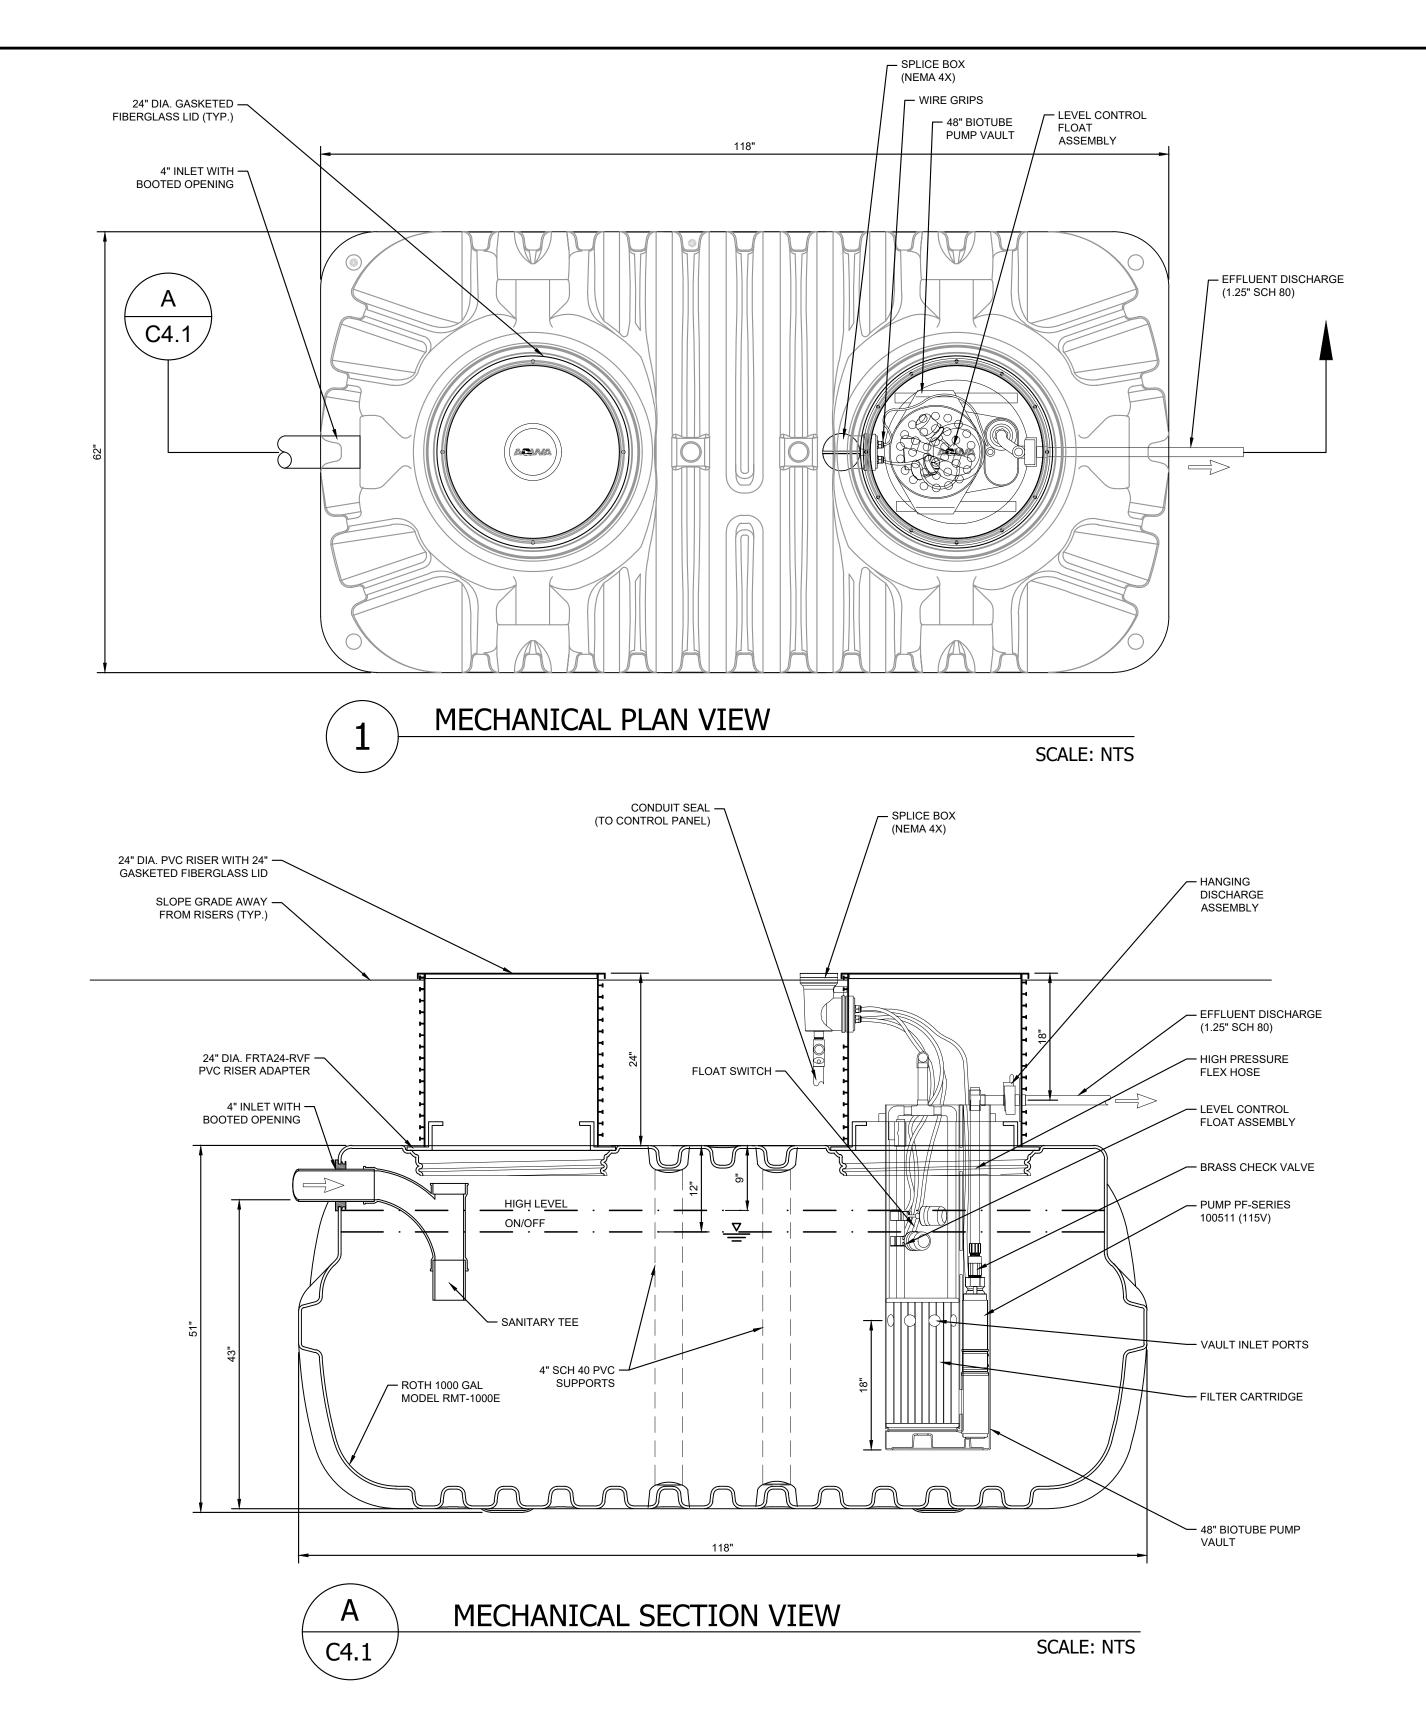

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WIDTH = 62" INLET PORT — OUTLET PORT LENGTH = 118"

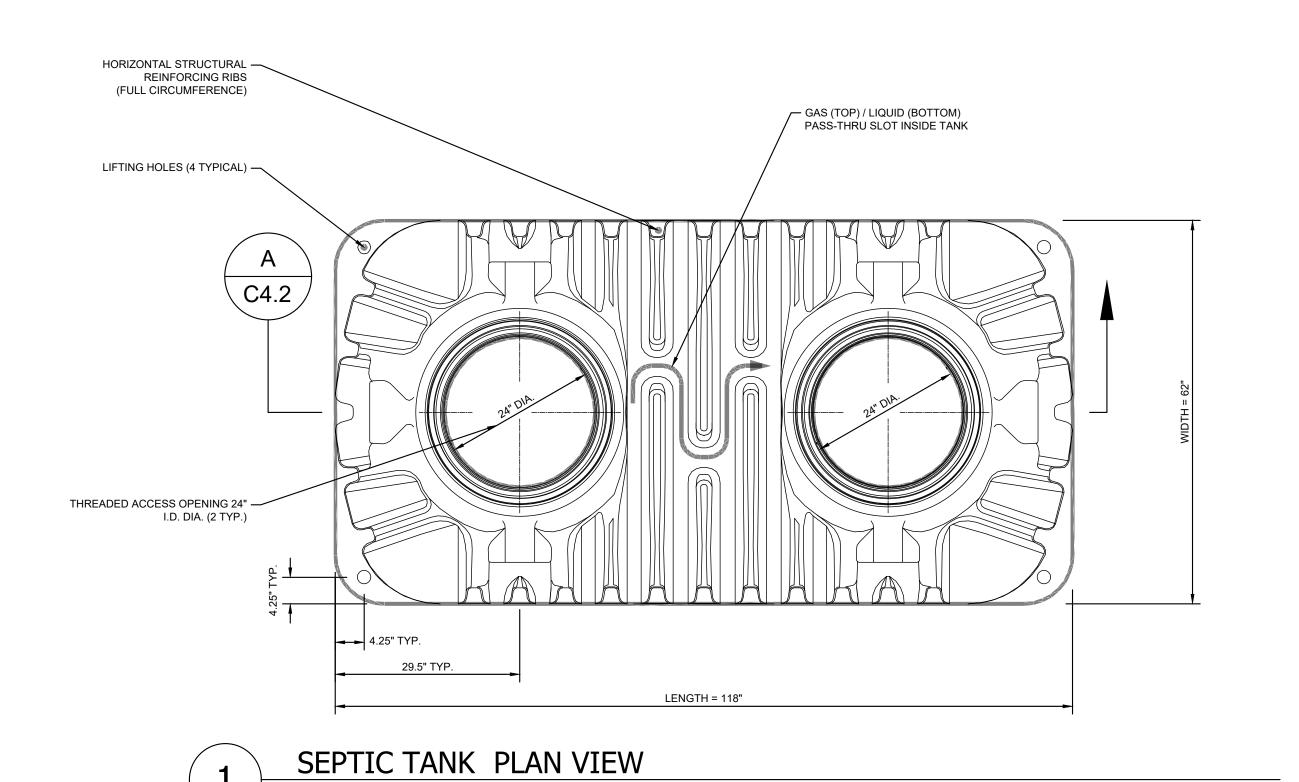SEPTIC TANK ELEVATION VIEW

SCALE: NTS

THREADED ACCESS THREADED ACCESS OPENING OPENING 24" I.D. DIA. 24" I.D. DIA. INV IN INV OUT 40" LIQUID LEVEL PARTITION WALL — HORIZONTAL STRUCTURAL — REINFORCING RIBS (FULL CIRCUMFERENCE) 2/3 TANK LENGTH 1/3 TANK LENGTH

SEPTIC TANK SECTION VIEW

A C4.2

SCALE: NTS

SCALE: NTS

SCOOTER'S
ROLESVILLE
PREPARED FOR
3 JAVA ENTERPRISES


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POTENTIAL CONFLICTS TO OWNER AND ENGINEER.

SEPTIC TANK DETAILS





Skimmer Basin 1 DESIGN INFORMATION TOTAL DRAINAGE AREA 0.70 AC 0.70 AC 5 MIN DESIGN STORM INTENSITY 8.06 IN/HR 1.97 CFS DESIGN CALCULATIONS SURFACE AREA REQUIRED 642 SF SURFACE AREA PROVIDED 1,260 CF 3.48 DAYS VOLUME PROVIDED 3,285 CF 10 FT EMBANKMENT WIDTH EMERGENCY SPILLWAY LENGTH 4.0 FT EMERGENCY SPILLWAY CAPACITY 2.1 CFS 2.00 IN 1.00 IN SKIMMER ORIFICE DIAMETER SKIMMER OUTLET ELEVATION 417.00 FT BASIN GEOMETRY AREA (SF) ELEV (F 1008 417.0 PRIMARY SPILLWAY ELEVATION: 2277 419.0

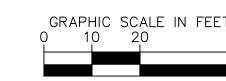3412 420.5

,	
EROSION CONTI	ROL LEGEND
	PROPERTY LINE
TCE	TEMPORARY CONSTRUCTION EASEMENT
CL	CLEARING LIMITS
SF	SILT FENCE
TPF	TREE PROTECTION FENCE
SF/TPF	COMBINATION TREE PROTECTION/ SILT FENCE
$\longrightarrow TD \longrightarrow TD \longrightarrow$	TEMPORARY DIVERSION DITCH
> TD(CW)	CLEAN WATER DIVERSION DITCH
X	SEDIMENT BASIN POROUS BAFFLES
$\longrightarrow \longrightarrow \longrightarrow$	PUMP DISCHARGE HOSE
—————805————	EXISTING CONTOUR
805	PROPOSED CONTOUR
	DRAINAGE AREA BOUNDARY
CE	CONSTRUCTION ENTRANCE
\boxtimes	SILT FENCE OUTLET
	CONCRETE WASHOUT STATION
	ROCK CHECK DAM
	INLET PROTECTION
	ROCK PIPE INLET PROTECTION
	SKIMMER
	TEMPORARY SLOPE DRAIN
	RIP-RAP OUTLET PROTECTION
	SILT BAG
	DESIGNATED AREAS TO BE STABILIZED WITHIN 7 DAYS
	TEMPORARY EROSION

CONTROL MATTING

PHASE 1 CONSTRUCTION SEQUENCE

- 1. THE FOLLOWING PHASE 1 CONSTRUCTION SEQUENCE IS FURNISHED AS A GENERAL GUIDE FOR PREPARATION OF A SEQUENCE OF CONSTRUCTION EVENTS.
- 2. SCHEDULE AN ON-SITE PRE-CONSTRUCTION CONFERENCE WITH WAKE COUNTY ENVIRONMENTAL CONSULTANT. OBTAIN A LAND-DISTURBING PERMIT
- 3. INSTALL GRAVEL CONSTRUCTION PAD, TEMPORARY DIVERSIONS, SILT FENCE, SEDIMENT BASINS OR OTHER MEASURES AS SHOWN ON THE APPROVED PLAN CLEAR ONLY AS NECESSARY TO INSTALL THESE DEVICES. SEED TEMPORARY DIVERSIONS, BERMS AND BASINS IMMEDIATELY AFTER CONSTRUCTION.
- 4. CALL ENVIRONMENTAL CONSULTANT FOR AN ON-SITE INSPECTION BY THE ENVIRONMENTAL CONSULTANT TO OBTAIN CERTIFICATE OF COMPLIANCE.
- 5. ONCE CERTIFICATE OF COMPLIANCE HAS BEEN OBTAINED, APPLY FOR NCDEQ eNOI ON
- NCDEQ WEBSITE. 6. UPON APPROVAL, CLEARING AND DEMOLITION MAY BEGIN. MAINTAIN ALL EROSION CONTROL MEASURES AS NECESSARY. EROSION CONTROL MEASURES SHALL BE RESTORED TO ORIGINAL DIMENSIONS WHEN SEDIMENT ACCUMULATES TO 50% OF DESIGN
- 7. INSTALL BYPASS STORM DRAINAGE AND RIPRAP OUTLET AS SHOWN.
- 8. INSTALL SKIMMER BASIN AND TEMPORARY DIVERSION DITCH. SEED, MAT, MULCH, AND ANCHOR DIVERSION DITCH AND BASIN IMMEDIATELY AFTER CONSTRUCTION AS
- 9. INSPECT AND REPAIR EROSION CONTROL MEASURES AFTER EVERY RAINFALL EVENT OF 1/2" OR GREATER OR EVERY SEVEN (7) CALENDAR DAYS.
- 10. SKIMMER BASIN SHALL BE CLEANED WHEN ONE-HALF FULL.
- 11. FOR PHASED EROSION CONTROL PLANS, CONTRACTOR SHALL MEET WITH EROSION CONTROL INSPECTOR PRIOR TO COMMENCING EACH PHASE OF EROSION CONTROL MEASURES. SEED AND MULCH DENUDED AREA WITHIN 15 CALENDAR DAYS AFTER ANY PHASE OF GRADING. MAINTAIN SOIL EROSION CONTROL MEASURES UNTIL PERMANENT GROUND COVER IS ESTABLISHED.
- 12. ALL EROSION CONTROL MEASURES SHALL BE CONSTRUCTED IN ACCORDANCE WITH THE NCDENR EROSION AND SEDIMENT CONTROL PLANNING AND DESIGN MANUAL, U.S. DEPARTMENT OF AGRICULTURE, AND WAKE COUNTY EROSION CONTROL ORDINANCE.
- 13. REFER TO SHEET CO.1 GENERAL NOTES FOR GENERAL EROSION CONTROL NOTES AND MAINTENANCE.

LIMITS OF DISTURBANCE: 0.70 AC

SURVEY NOTE: EXISTING TOPOGRAPHICAL INFORMATION IS BASED ON A TOPOGRAPHIC SURVEY OBTAINED ON 02/23/2023 BY CMP PROFESSIONAL LAND SURVEYORS, 333 S. WHITE STREET, WAKE FOREST, NC, 27588, PHONE: (919) 556-3148. CONTRACTOR SHALL BE RESPONSIBLE FOR VERIFYING ALL EXISTING INFORMATION, DEPICTED OR NOT, PRIOR TO CONSTRUCTION AND REPORT POTENTIAL CONFLICTS TO OWNER AND ENGINEER.



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SHEET NUMBER

. <u>CONSTRUCTION ENTRANCE:</u> INSPECT CONSTRUCTION ROADS AND PARKING AREAS PERIODICALLY FOR CONDITION OF SURFACE. TOP DRESS WITH NEW GRAVEL AS NEEDED. CHECK ROAD DITCHES AND OTHER SEEDED AREAS FOR EROSION AND SEDIMENTATION AFTER RUNOFF-PRODUCING RAINS, MAINTAIN ALL VEGETATION IN A HEALTHY, VIGOROUS CONDITION, SEDIMENT PRODUCING AREAS

INSPECT SEDIMENT FENCES AT LEAST ONCE A WEEK AND AFTER EACH RAINFALL. MAKE ANY REQUIRED REPAIRS IMMEDIATELY SHOULD THE FABRIC OF A SEDIMENT FENCE COLLAPSE. TEAR. DECOMPOSE. OR BECOME INEFFECTIVE. REPLACE IT IMMEDIATELY REMOVE SEDIMENT DEPOSITS AS NECESSARY TO PROVIDE ADEQUATE STORAGE VOLUME FOR THE NEXT RAIN AND TO REDUCE PRESSURE ON THE FENCE. TAKE CARE TO AVOID UNDERMINING THE FENCE DURING CLEANOUT. REMOVE ALL FENCING MATERIALS AND UNSTABLE SEDIMENT DEPOSITS AND BRING THE AREA TO GRADE AND STABILIZE IT AFTER THE CONTRIBUTING DRAINAGE AREA HAS BEEN PROPERLY STABILIZED.

INSPECT SEDIMENT FENCE GRAVEL OUTLETS AT LEAST ONCE A WEEK AND AFTER EACH RAINFALL. MAKE ANY REQUIRED REPAIRS IMMEDIATELY. REMOVE SEDIMENT DEPOSITS AS NECESSARY TO PROVIDE ADEQUATE STORAGE VOLUME FOR THE NEXT RAIN. ANY RIP RAP DISPLACED MUST BE REPLACED IMMEDIATELY.

SHOULD BE TREATED IMMEDIATELY.

INSPECT THE BARRIER OF AFTER EACH RAIN AND MAKE REPAIRS AS NEEDED. REMOVE SEDIMENT AS NECESSARY TO PROVIDE ADEQUATE STORAGE VOLUME FOR SUBSEQUENT RAINS, WHEN THE CONTRIBUTING DRAINAGE AREA HAS BEEN ADEQUATELY STABILIZED, REMOVE ALL MATERIALS AND ANY UNSTABLE SOIL, AND EITHER SALVAGE OR DISPOSE OF IT PROPERLY. BRING THE DISTURBED AREA TO PROPER GRADE, THEN SMOOTH AND COMPACT IT. APPROPRIATELY STABILIZE ALL BARE AREAS AROUND THE

-		
SITE AREA DESCRIPTION	STABILIZATION	TIME FRAME EXCEPTIONS
PERIMETER DIKES, SWALES, DITCHES, SLOPES	7 DAYS	NONE
HIGH QUALITY WATER (HQW) ZONES	7 DAYS	NONE
SLOPES STEEPER THAN 3:1	7 DAYS	IF SLOPES ARE 10' OR LESS IN LENGTH AND ARE NOT STEEPER THAN 2:1. 14 DAYS ARE ALLOWED.
SLOPES 3:1 OR FLATTER	14 DAYS	7 DAYS FOR SLOPES GREATER THAN 50' IN LENGTH
ALL OTHER AREAS WITH SLOPES FLATTER THAN 4:1	14 DAYS	NONE EXCEPT FOR PERIMETERS AND HQW


NPDES GROUND COVER REQUIREMENTS

SILT FENCES SHOWN ON PLANS ARE FOR REPRESENTATIVE PURPOSES, CONSTRUCT DIRECTLY ALONG THE CLEARING LIMITS WHERE APPLICABLE. SILT FENCE OUTLETS ARE TO BE PROVIDED ALONG ALL LOW POINTS OF SILT


FENCE AND AREAS WHERE RUNOFF MAY CONCENTRATE CAUSING DAMAGE TO SILT FENCE. CONTRACTOR TO INSTALL OUTLETS AS NECESSARY TO ENSURE SILT FENCE IS FULLY FUNCTIONAL THROUGHOUT THE DURATION OF CONSTRUCTION.


REFER TO GENERAL NOTES SHEET C0.1 FOR EROSION CONTROL, SEEDBED PREPARATION, AND SEEDING SCHEDULE NOTES FOR BOTH PHASES.

DISTURBED AREA: 0.70 AC

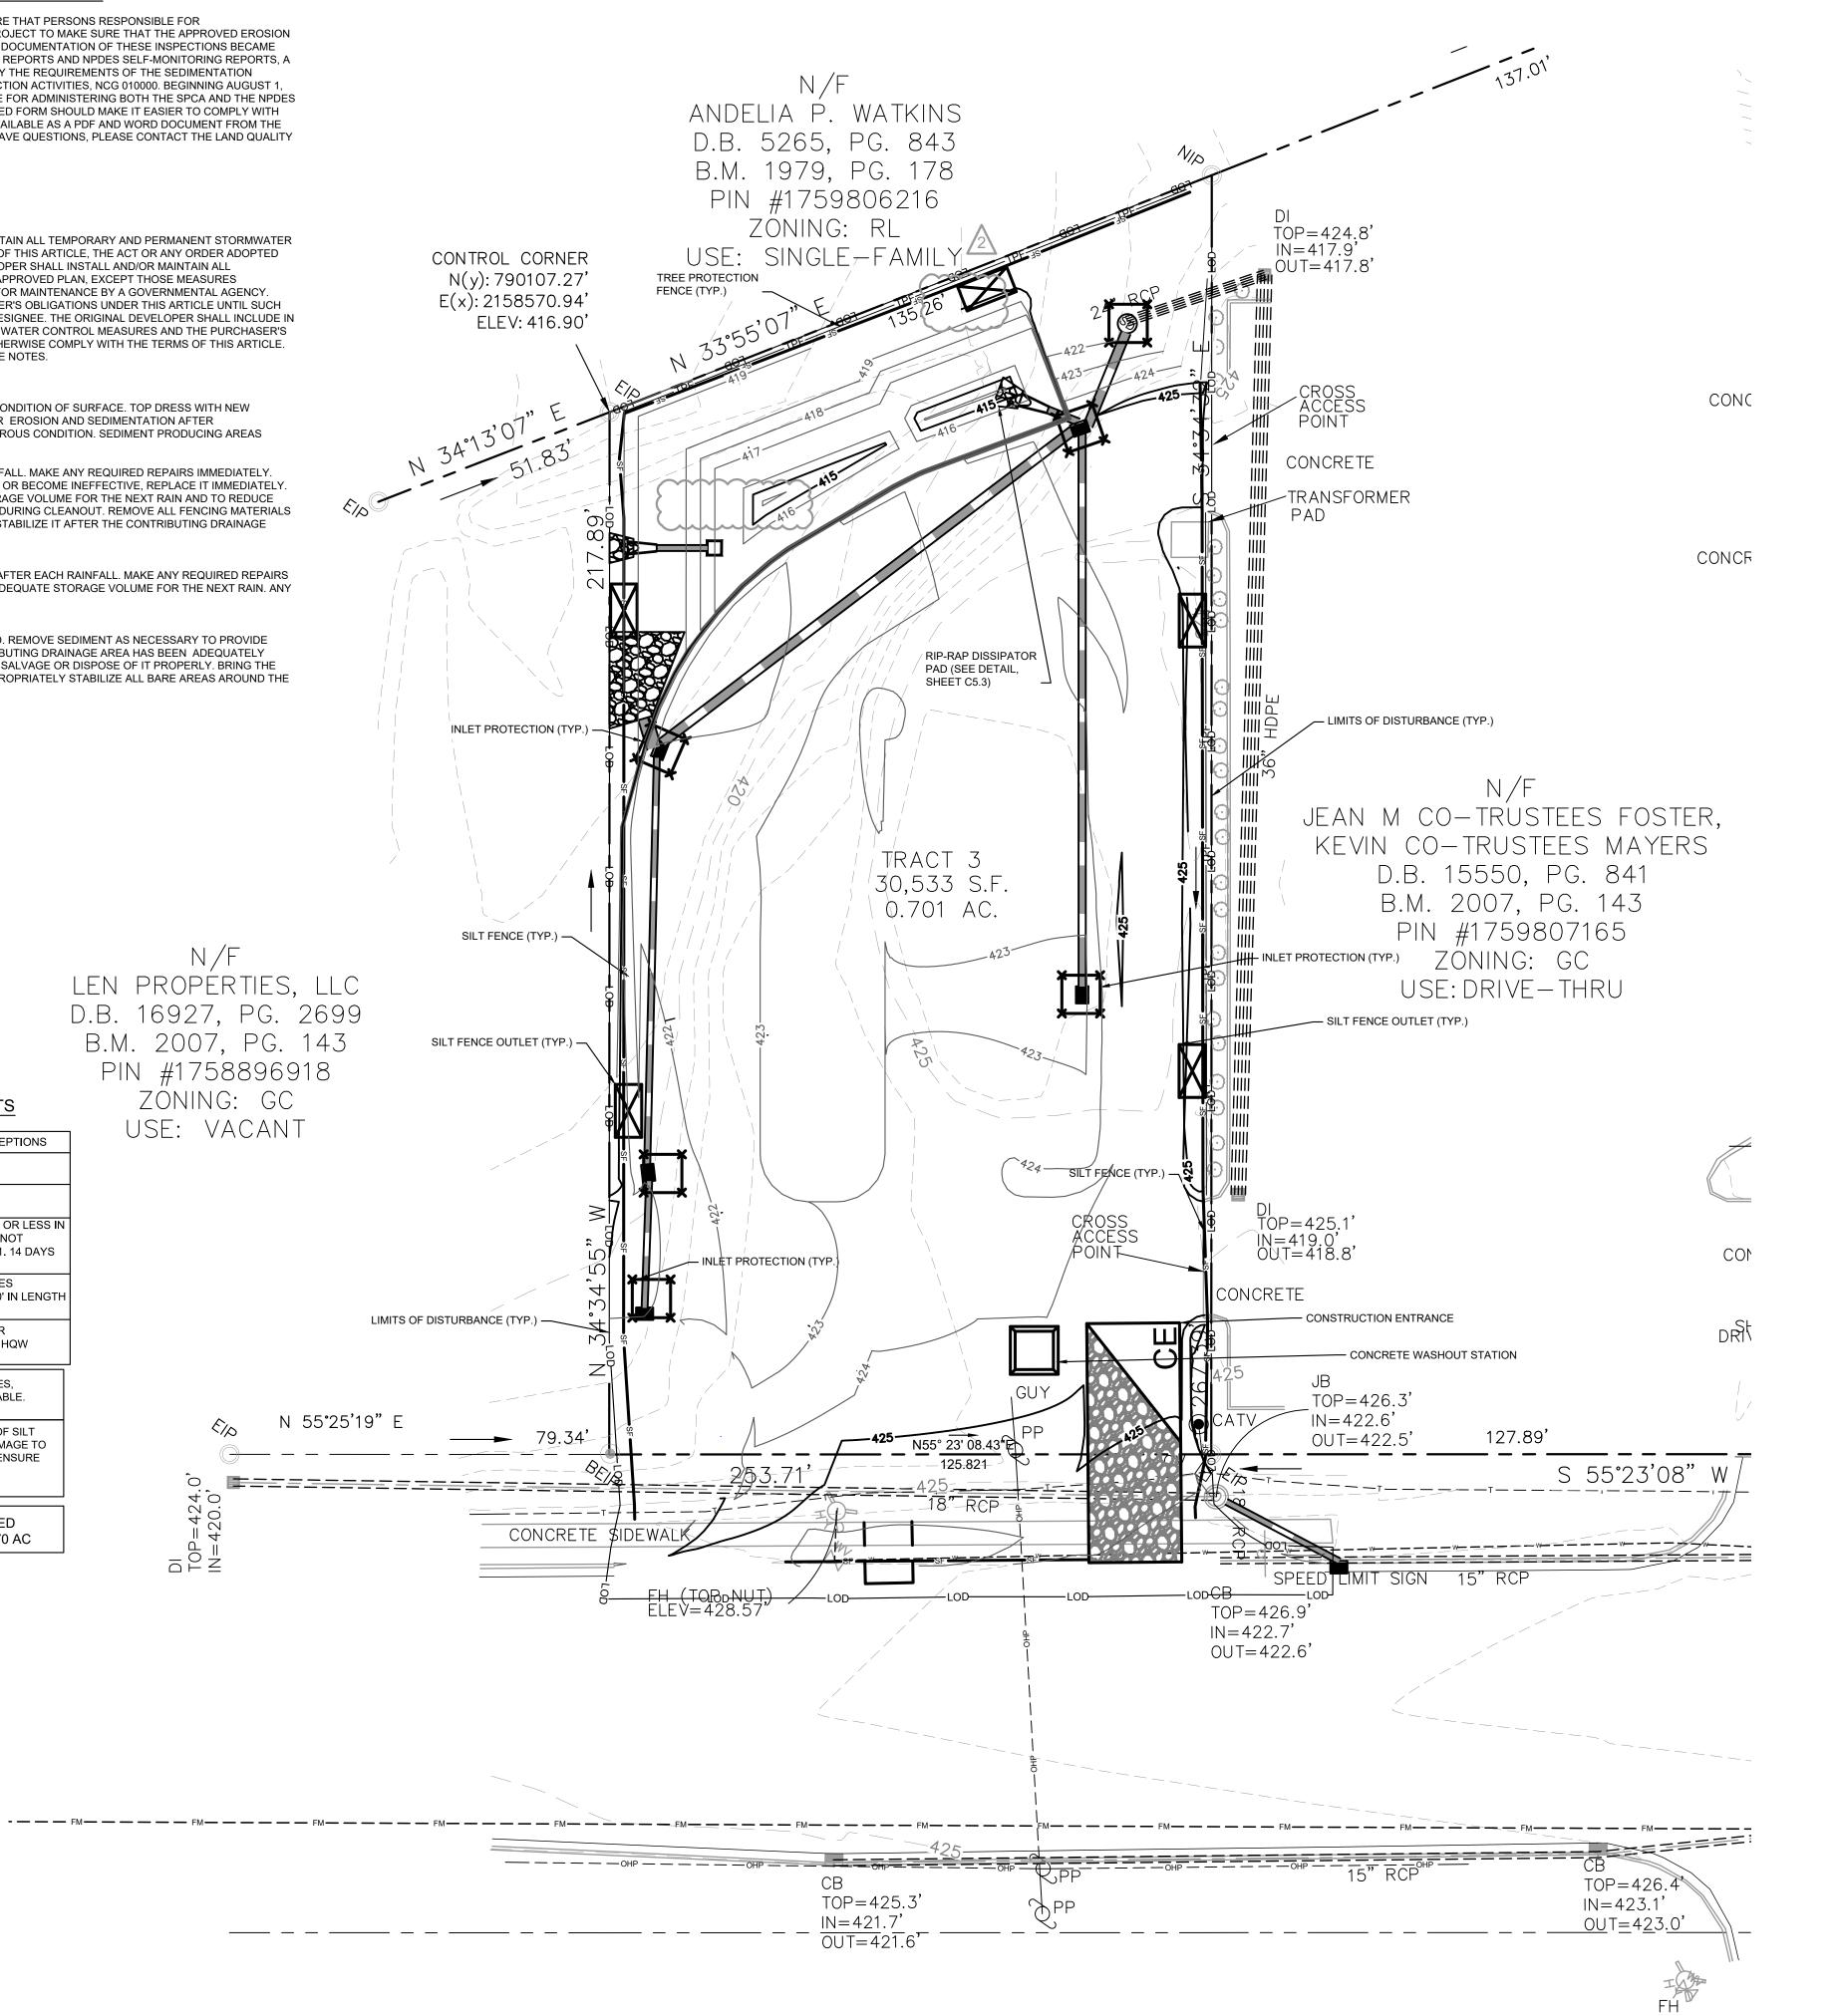



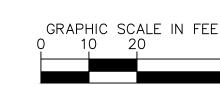

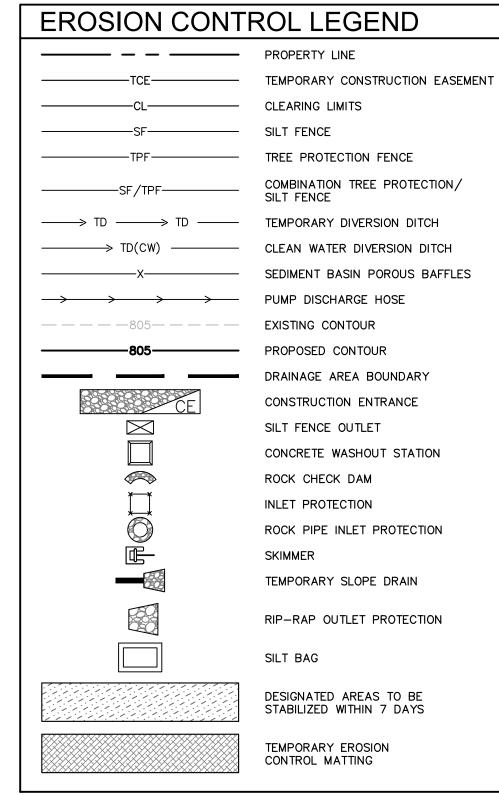

PHASE 2 CONSTRUCTION SEQUENCE

- 1. THE FOLLOWING PHASE 2 CONSTRUCTION SEQUENCE IS FURNISHED AS A GENERAL GUIDE FOR
- 2. BEGIN CLEARING AND GRUBBING. MAINTAIN DEVICES AS NEEDED. ROUGH GRADE SITE. EROSION CONTROL MEASURES SHALL BE RESTORED TO ORIGINAL DIMENSIONS WHEN SEDIMENT ACCUMULATES TO 50% OF DESIGN DEPTH. WHEN SEDIMENT BASIN DEWATERING IS REQUIRED, DEWATER USING PUMP AND FILTER BAG (SEE "STANDARD FILTER BAG FOR DEWATERING ACTIVITIES" DETAIL ON SHEET 5.4) PLACE PUMP ON BERM AND ATTACH FILTER BAG PER DETAIL CONSTRUCTION SPECIFICATIONS.
- 3. INSTALL STORM DRAINAGE AND PROTECT INLETS WITH BLOCK AND GRAVEL INLET CONTROLS, SEDIMENT TRAPS, OR OTHER APPROVED MEASURES AS SHOWN ON THE PLAN.
- 4. STABILIZE SITE AS AREAS ARE BROUGHT UP TO FINISH GRADE WITH VEGETATION. PAVING. DITCH LININGS, ETC. SEED AND MULCH DENUDED AREAS PER GROUND STABILIZATION TIME
- 5. PROVIDE GROUND COVER ON SLOPES GREATER THAN 3:1 WITHIN 7 DAYS FOLLOWING COMPLETION OF ANY PHASE OF GRADING. PROVIDE GROUND COVER TO ALL OTHER AREAS WITHIN 14 DAYS FOLLOWING COMPLETION OF ANY PHASE OF GRADING OR INACTIVITY.
- 6. INSPECT AND REPAIR EROSION CONTROL MEASURES AFTER EVERY RAINFALL EVENT OF 1/2" OR GREATER OR EVERY SEVEN (7) CALENDAR DAYS.
- 7. FOR ALL PHASED EROSION CONTROL PLANS, CONTRACTOR SHALL MEET WITH EROSION CONTROL INSPECTOR PRIOR TO COMMENCING EACH PHASE OF EROSION CONTROL MEASURES. SEED AND MULCH DENUDED AREA WITHIN 15 CALENDAR DAYS AFTER ANY PHASE OF GRADING. MAINTAIN SOIL EROSION CONTROL MEASURES UNTIL PERMANENT GROUND COVER IS ESTABLISHED.
- 8. ALL EROSION CONTROL MEASURES SHALL BE CONSTRUCTED IN ACCORDANCE WITH THE NCDENR EROSION AND SEDIMENT CONTROL PLANNING AND DESIGN MANUAL. U.S. DEPARTMENT OF AGRICULTURE, AND WAKE COUNTY EROSION CONTROL ORDINANCE.
- 9. REFER TO SHEET CO.1 GENERAL NOTES FOR GENERAL EROSION CONTROL NOTES AND

LIMITS OF DISTURBANCE: 0.70 AC

SURVEY NOTE:
EXISTING TOPOGRAPHICAL INFORMATION IS BASED ON A TOPOGRAPHIC SURVEY OBTAINED ON 02/23/2023 BY CMP PROFESSIONAL LAND SURVEYORS, 333 S. WHITE STREET, WAKE FOREST, NC, 27588, PHONE: (919) 556-3148. CONTRACTOR SHALL BE RESPONSIBLE FOR VERIFYING ALL EXISTING INFORMATION, DEPICTED OR NOT, PRIOR TO CONSTRUCTION AND REPORT POTENTIAL CONFLICTS TO OWNER AND ENGINEER.





SHEET NUMBER

SDP-23-09





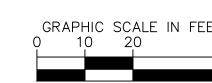

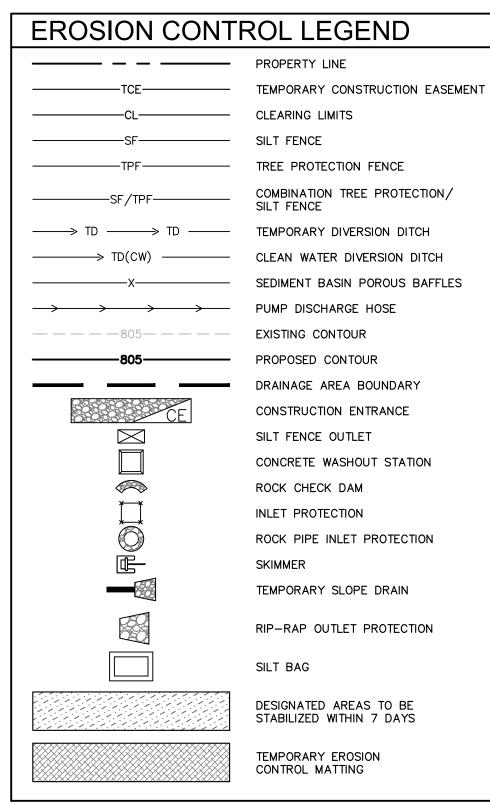

PHASE 2 CONSTRUCTION SEQUENCE:

- 1. THE FOLLOWING PHASE 2 CONSTRUCTION SEQUENCE IS FURNISHED AS A GENERAL GUIDE FOR
- PREPARATION OF A SEQUENCE OF CONSTRUCTION EVENTS.

 2. MAINTAIN CONSTRUCTION ENTRANCE AND SILT FENCE.
- 3. CALL FOR ON-SITE INSPECTION BY INSPECTOR ONCE ALL PHASE 2 EROSION CONTROL MEASURES ARE INSTALLED. OBTAIN CERTIFICATE OF COMPLIANCE FROM WAKE COUNTY.
- 4. CONTRACTOR IS TO CUT AND/OR FILL AREAS TO BRING THE SITE TO THE PROPOSED GRADES SHOWN ON THE GRADING AND DRAINAGE PLANS. GRADING ACTIVITY SHALL BE LIMITED TO WITHIN THE CLEARING LIMITS. MAINTAIN ALL EROSION CONTROL MEASURES AS NECESSARY.
- 5. PROVIDE GROUND COVER ON SLOPES GREATER THAN 3:1 WITHIN 7 DAYS FOLLOWING COMPLETION OF ANY PHASE OF GRADING. PROVIDE GROUND COVER TO ALL OTHER AREAS WITHIN 14 DAYS FOLLOWING COMPLETION OF ANY PHASE OF GRADING OR INACTIVITY.
- 6. INSTALL STORM DRAINAGE AND PROTECT INLETS WITH BLOCK AND GRAVEL INLET CONTROLS.
- SEDIMENT TRAPS, OR OTHER APPROVED MEASURES AS SHOWN ON THE PLAN.

 7. STABILIZE SITE AS AREAS ARE BROUGHT UP TO FINISH GRADE WITH VEGETATION, PAVING,

DITCH LININGS, ETC. SEED AND MULCH DENUDED AREAS PER GROUND STABILIZATION TIME

- 8. INSPECT AND REPAIR EROSION CONTROL MEASURES AFTER EVERY RAINFALL EVENT OF 1/2" OR
- . INSPECT AND REPAIR EROSION CONTROL MEASURES AFTER EVERY RAINFALL EVENT OF 1/2" OF GREATER OR EVERY SEVEN (7) CALENDAR DAYS.
- 9. ALL EROSION CONTROL MEASURES SHALL BE CONSTRUCTED IN ACCORDANCE WITH THE NCDENR EROSION AND SEDIMENT CONTROL PLANNING AND DESIGN MANUAL, U.S. DEPARTMENT OF
- AGRICULTURE, AND CITY OF GREENVILLE EROSION CONTROL ORDINANCE.

10. REFER TO SHEET CO.1 - GENERAL NOTES FOR GENERAL EROSION CONTROL NOTES AND

- 11. ALL EROSION CONTROL MEASURES TO REMAIN IN PLACE UNTIL +/- 80% STABILIZATION IS
- ACHIEVED.

 12. UPON STABILIZATION OF UPSTREAM AREA AND APPROVAL FROM THE INSPECTOR, SKIMMER
- 13. ALL SEDIMENT SHALL REMAIN OUT OF PERMANENT BMP ONCE CONVERTED. SEDIMENT THAT ENTERS THE BMP SHALL BE REMOVED IMMEDIATELY, AND THE BMP INSPECTED TO ENSURE
- COMPLIANCE HAS BEEN MAINTAINED.

 14. ONCE CONSTRUCTION IS COMPLETE AND ENTIRE SITE IS STABILIZED, CALL FOR FINAL INSPECTION BY WAKE COUNTY ENVIRONMENTAL CONSULTANT. IF APPROVED, REMOVE REMAINING EROSION CONTROL MEASURES. ALL REMAINING PERMANENT EROSION CONTROL DEVICES SHOULD

BASIN SHALL BE CLEANED OF SEDIMENT AND CONVERTED TO A WET POND.

15. WHEN VEGETATION HAS BECOME ESTABLISHED, CALL FOR A FINAL INSPECTION BY WAKE COUNTY ENVIRONMENTAL CONSULTANT. OBTAIN A CERTIFICATE OF COMPLETION.

LIMITS OF DISTURBANCE: 0.70 AC

MAINTENANCE.

SURVEY NOTE:
EXISTING TOPOGRAPHICAL INFORMATION IS BASED ON A
TOPOGRAPHIC SURVEY OBTAINED ON 02/23/2023 BY CMP
PROFESSIONAL LAND SURVEYORS, 333 S. WHITE STREET, WAKE
FOREST, NC, 27588, PHONE: (919) 556-3148. CONTRACTOR SHALL BE
RESPONSIBLE FOR VERIFYING ALL EXISTING INFORMATION,
DEPICTED OR NOT, PRIOR TO CONSTRUCTION AND REPORT
POTENTIAL CONFLICTS TO OWNER AND ENGINEER.



3 KIMLEY-HORN AND ASSOCIATES, INC. Y-HORN.COM PHONE: 919-677-2000 FAX: 919-677-20 EVILLE STREET, SUITE 600, RALEIGH, NC 27601



10/31/2023
ALE AS SHOWN
SIGNED BY JAA
AWN BY JAA

SCALE AS
DESIGNED BY
DRAWN BY


EROSION CONTI PLAN - PHASE

ROLESVILLE
PREPARED FOR
JAVA ENTERPRISES

SHEET NUMBER

C5.2

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	DATE	TYPE	PLANTING RATE	REGION	SEEDBED PREPARATION:
	JAN. 1 - MAY 1	RYE (GRAIN)	120 LBS/ACRE	PIEDMONT	 TILL OR DISK THE PREPARED AREAS TO BE SEEDED TO A MINIMUM DEPTH OF FOUR INCHES.
	JAN. 1 - MAY 1	ANNUAL LESPEDEZA (KOBE)	50 LBS/ACRE	PIEDMONT	2. REMOVE STONES LARGER THAN THREE INCHES ON ANY SIDE, STICKS, ROOTS AND OTHER
	MAY 1 - AUG. 15	GERMAN MILLET	40 LBS/ACRE	PIEDMONT	EXTRANEOUS MATERIALS THAT SURFACE.
١	MAY 1 - AUG. 15	SMALL-STEMMED SUDANGRASS	50 LBS/ACRE	PIEDMONT	3. IF NOT INCORPORATED DURING THE SOIL PREPARATION PROCESS, ADD pH MODIFIER AND FERTILIZERS AT THE RATE SPECIFIED IN THE SOIL TEST REPORT. IF THERE IS NO SOIL
l	AUG. 15 - DEC. 30	RYE (GRAIN)	120 LBS/ACRE	PIEDMONT	TEST REPORT, FOLLOW SOIL AMENDMENTS BELOW. 4. RE-COMPACT THE AREA UTILIZING A CULTIPACKER ROLLER. THE FINISHED GRADE SHALL
	DEC. 1 - APR. 15	RYE (GRAIN)	120 LBS/ACRE	COASTAL PLAIN	BE A SMOOTH EVEN SOIL SURFACE WITH A LOOSE, UNIFORMLY FINE TEXTURE.
	DEC. 1 - APR. 15	ANNUAL LESPEDEZA (KOBE)	50 LBS/ACRE	COASTAL PLAIN	EVENLY APPLY SEED USING A CYCLONE SEEDER (BROADCAST), DRILL, CULTIPACKER SEEDER, OR HYDROSEEDER. SMALL GRAINS SHOULD BE PLANTED NO MORE THAN 1 INCH
	APR. 15 - AUG. 15	GERMAN MILLET	40 LBS/ACRE	COASTAL PLAIN	DEEP, AND GRASSES AND LEGUMES NO MORE THAN $\frac{1}{2}$ INCH. BROADCAST SEED MUST BE
	AUG. 15 - DEC. 30	RYE (GRAIN)	120 LBS/ACRE	COASTAL PLAIN	COVERED BY RAKING OR CHAIN DRAGGING, AND THEN LIGHTLY FIRMED WITH A ROLLER OR CULTIPACKER. HYDROSEEDED MIXTURES SHOULD INCLUDE A WOOD FIBER (CELLULOSE)
	FEB. 15 - MAY 15	RYE (GRAIN)	120 LBS/ACRE	MOUNTAINS - ABOVE 2500 FEET	MULCH.
	FEB. 1 — MAY 1	RYE (GRAIN)	120 LBS/ACRE	MOUNTAINS - BELOW 2500 FEET	NOTES:
l	FEB. 15 - MAY 15	ANNUAL LESPEDEZA (KOREAN)	50 LBS/ACRE	MOUNTAINS - ABOVE 2500 FEET	
	FEB. 1 — MAY 1	ANNUAL LESPEDEZA (KOREAN)	50 LBS/ACRE	MOUNTAINS - BELOW 2500 FEET	 CONSULT CONSERVATION ENGINEER OR SOIL CONSERVATION SERVICE FOR ADDITIONAL INFORMATION CONCERNING OTHER ALTERNATIVES FOR VEGETATION OF DENUDED AREAS.
١	MAY 15 - AUG. 15	GERMAN MILLET	40 LBS/ACRE	MOUNTAINS	THE ABOVE VEGETATION RATES ARE THOSE WHICH DO WELL UNDER LOCAL CONDITIONS; OTHER SEEDING RATE COMBINATIONS ARE POSSIBLE.
١	MAY 15 - AUG. 15	SMALL-STEMMED SUDANGRASS	50 LBS/ACRE	MOUNTAINS	2. THIS SEEDING SCHEDULE IS FOR EROSION AND SEDIMENT CONTROL ONLY. SEE
	AUG. 15 - DEC. 15	RYE (GRAIN)	120 LBS/ACRE	MOUNTAINS	LANDSCAPE PLAN FOR FINAL SEEDING.
		•		•	3. THE CONTRACTOR SHALL PROVIDE GROUND COVER ON DESIGNATED AREAS AND SLOPES GREATER THAN 3:1 WITHIN 7 DAYS FOLLOWING COMPLETION OF ANY PHASE OF GRADING.

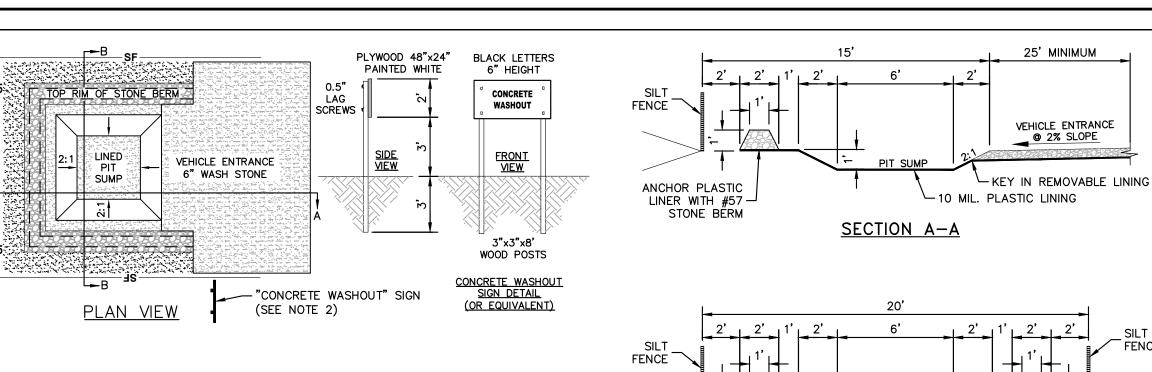LEDE	<u>BED PREPARATION:</u>	
	TILL OR DISK THE PREPARED AREAS TO BE SEEDED TO A MINIMUM DEPTH OF FOUR NCHES.	6. COMPLETE GRADING BEFORE PREPARING SEEDBEDS, AND INSTALL ALL NECESSARY EROSION CONTROL PRACTICES SUCH AS, DIKES, WATERWAYS, AND BASINS.

7. IF SOILS BECOME COMPACTED DURING GRADING, LOOSEN THEM TO A DEPTH OF 6-8

INCHES USING A RIPPER, HARROW, OR CHISEL PLOW. . THE USE OF AN APPROPRIATE MULCH WILL HELP ENSURE ESTABLISHMENT UNDER NORMAL CONDITIONS, AND IS ESSENTIAL TO SEEDING SUCCESS UNDER HARSH SITE CONDITIONS.

SOIL AMENDMENTS:

LATE WINTER THROUGH SUMMER: FOLLOW RECOMMENDATIONS OF SOIL TESTS OR APPLY 2000 LB/ACRE GROUND AGRICULTURAL LIMESTONE AND 750 LB/ACRE 10-10-10 FERTILIZER.

FALL: FOLLOW RECOMMENDATIONS OF SOIL TESTS OR APPLY 2000 LB/ACRE GROUND AGRICULTURAL LIMESTONE AND 1000 LB/ACRE 10-10-10 FERTILIZER.

APPLY 4000 LB/ACRE STRAW. ANCHOR STRAW BY TACKING WITH ASPHALT, NETTING, OR A MULCH ANCHORING TOOL. A DISK WITH BLADES SET NEARLY STRAIGHT CAN BE USED INFORMATION CONCERNING OTHER ALTERNATIVES FOR VEGETATION OF DENUDED AREAS. AS A MULCH ANCHORING TOOL.


LATE WINTER THROUGH SUMMER: REFERTILIZE IF GROWTH IS NOT FULLY ADEQUATE. RESEED, FERTILIZE AND MULCH IMMEDIATELY FOLLOWING EROSION OR OTHER DAMAGE. GREATER THAN 3:1 WITHIN 7 DAYS FOLLOWING COMPLETION OF ANY PHASE OF GRADING.

FALL: REPAIR AND REFERTILIZE DAMAGED AREAS IMMEDIATELY. TOPDRESS WITH 50 LB/ACRE OF NITROGEN IN MARCH. IF IT IS NECESSARY TO EXTEND TEMPORARY COVER BEYOND JUNE 15, OVERSEED WITH 50 LB/ACRE KOBE (PIEDMONT AND COASTAL PLAIN) OR KOREAN (MOUNTAINS) LESPEDEZA IN LATE FEBRUARY OR EARLY MARCH.

TEMPORARY SEEDING SCHEDULE AND SEEDBED PREPARATION

KHA DETAIL NO: 01.104.R0

66466

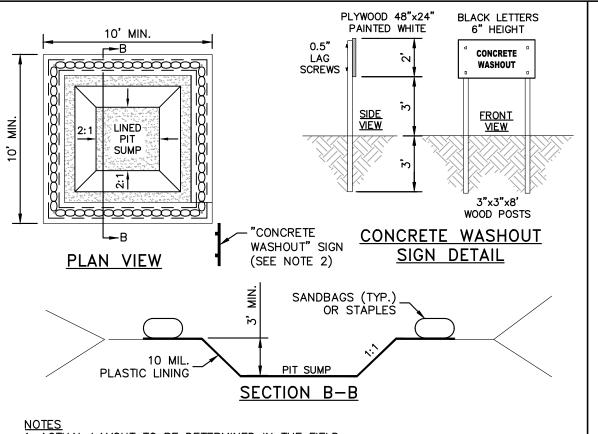

TEMPORARY CONCRETE WASHOUT FACILITIES SHALL BE BACKFILLED, REPAIRED, AND

5. PIT CAPACITY IS MINIMUM OF 6 CUBIC FEET PER 10 CUBIC YARDS OF CONCRETE.

STABILIZED TO PREVENT EROSION.


N.T.S.

CONCRETE WASHOUT STATION

1. ACTUAL LAYOUT TO BE DETERMINED IN THE FIELD.

- 2. A CONCRETE WASHOUT SIGN SHALL BE INSTALLED WITHIN 30' OF THE TEMPORARY CONCRETE WASHOUT FACILITY. 3. MATERIALS USED TO CONSTRUCT TEMPORARY CONCRETE WASHOUT FACILITIES SHALL BE
- REMOVED FROM THE SITE AND DISPOSED OF OR RECYCLED. 4. HOLES, DEPRESSIONS OR OTHER GROUND DISTURBANCE CAUSED BY THE REMOVAL OF THE TEMPORARY CONCRETE WASHOUT FACILITIES SHALL BE BACKFILLED, REPAIRED, AND
- STABILIZED TO PREVENT EROSION 5. PIT CAPACITY IS MINIMUM OF 6 CUBIC FEET PER 10 CUBIC YARDS OF CONCRETE.

CONCRETE WASHOUT STATION N.T.S. KHA DETAIL NO: 01.102.R01

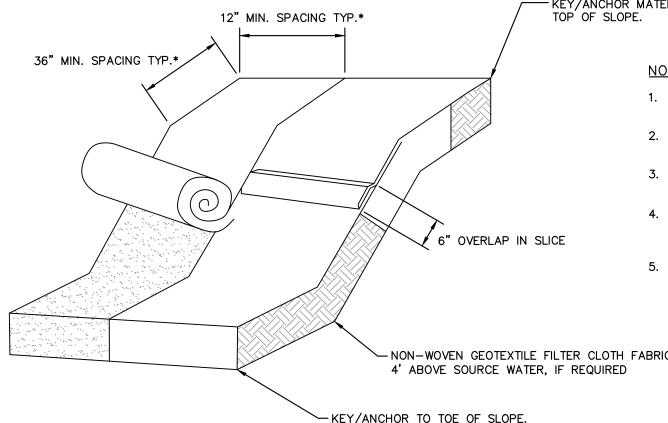

TEMPORARY MATTING

FILTERED .

\WATFR

2. DRIVE 5-FOOT STEEL POSTS 2 FEET INTO THE GROUND SURROUNDING THE INLET. SPACE

4. PLACE CLEAN GRAVEL (NC DOT #5 OR #57 STONE) ON A 2:1 SLOPE WITH A HEIGHT OF

5. ONCE THE CONTRIBUTING DRAINAGE AREA HAS BEEN STABILIZED, REMOVE ACCUMULATED

POSTS EVENLY AROUND THE PERIMETER OF THE INLET, A MAXIMUM OF 4 FEET APART.

SURROUND THE POSTS WITH WIRE MESH HARDWARE CLOTH. SECURE THE WIRE MESH TO

THE STEEL POSTS AT THE TOP, MIDDLE, AND BOTTOM. PLACING A 2-FOOT FLAP OF THE

1. UNIFORMLY GRADE A SHALLOW DEPRESSION APPROACHING THE INLET.

WIRE MESH UNDER THE GRAVEL FOR ANCHORING IS RECOMMENDED.

16 INCHES AROUND THE WIRE, AND SMOOTH TO AN EVEN GRADE.

6. COMPACT THE AREA PROPERLY AND STABILIZE IT WITH GROUNDCOVER.

SEDIMENT, AND ESTABLISH FINAL GRADING ELEVATIONS.

N.T.S.

#57 WASHED

OF BOX-

CONSTRUCTION SPECIFICATIONS

STONE PLACED TO

A HEIGHT OF 16"

MIN. ABOVE TOP

CONTACT WITH THE SOIL. DO NOT STRETCH. ADDITIONAL REQUIREMENTS THAT MUST BE MET. MAT/BLANKETS SHALL HAVE GOOD SOIL CONTACT. #6.17 AND MANUFACTURER'S GUIDELINES. 5. ALL MATTING TO BE ERONET™ S150® EROSION CONTROL BLANKET OR APPROVED EQUIVALENT. - NON-WOVEN GEOTEXTILE FILTER CLOTH FABRIC KEY/ANCHOR TO TOE OF SLOPE.

1. INLET MAINTENANCE SHALL BE DOCUMENTED IN PROJECT LOG BOOK.

FOLLOWING COMPLETION OF ANY PHASE OF GRADING.


COMPLETION OF CONSTRUCTION.

4. CONTRACTOR SHALL PROVIDE GROUND COVER IN 14 DAYS ON ALL OTHER AREAS


WORKING DAYS OR 90 CALENDAR DAYS (WHICHEVER IS SHORTER) FOLLOWING

5. PERMANENT GROUND COVER FOR ALL DISTURBED AREAS SHALL BE PROVIDED WITHIN 15


- 2. FILTER TYPES SHALL BE APPROVED BY THE CITY INSPECTOR PRIOR TO INSTALLATION.
- 3. FILTER BAGS MAY BE REMOVED WHEN SITE IS STABILIZED AT THE DIRECTION OF THE ENGINEER.
- 4. FILTER BAGS SHALL BE REMOVED PRIOR TO STREET ACCEPTANCE.
- 5. FILTER BAGS SHALL BE CLEANED OR REPLACED ON A REGULAR BASIS (NOT

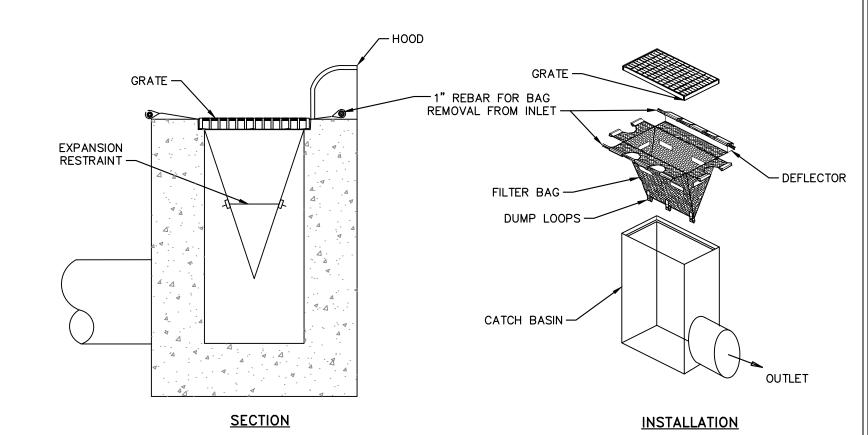

CATCH BASIN INLET PROTECTION

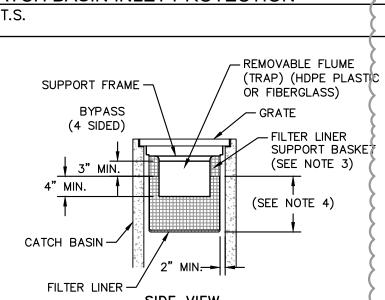


CONSTRUCTED FROM A BIAXIAL GEOGRID WITH A MINIMUM ULTIMATE TENSILE STRENGTH OF 900 X 1400, AS TESTED IN ACCORDANCE WITH ASTM D-4595.

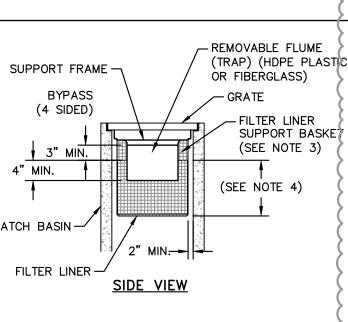

- FIT MOST INDUSTRY-STANDARD CATCH BASINS (SEE CAPACITY CHART). CUSTOM SIZES ARE AVAILABLE.
- 2. FILTER SUPPORT FLANGES SHALL BE CONSTRUCTED FROM STAINLESS STEEL (TYPE 304) DEBRIS TRAP (FLUME) SHALL BE CONSTRUCTED FROM EITHER
- CUSTOM LINER DEPTH'S MAY BE SPECIFIED. MAINTENANCE SPECIFICATIONS

ACCUMULATED SEDIMENT AND DEBRIS FROM VICINITY OF UNIT AFTER EACH STORM EVENT. IF THE CONTAINMENT IS MORE THAN 1/3 FULL OF SEDIMENT, EMPTY THE PROTECTION INSERT BY LIFTING THE UNIT OUT OF THE INLET AND REPLACING.

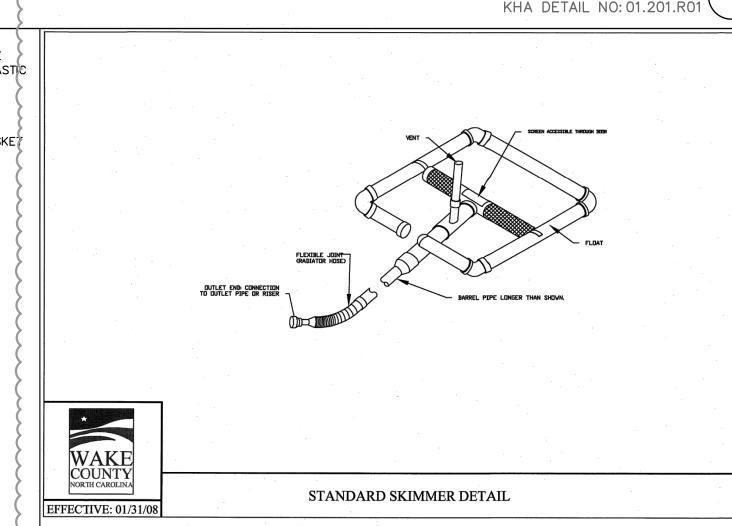

EXISTING TOPOGRAPHICAL INFORMATION IS BASED ON A TOPOGRAPHIC SURVEY OBTAINED ON 02/23/2023 BY CMP PROFESSIONAL LAND SURVEYORS, 333 S. WHITE STREET, WAKE FOREST, NC, 27588, PHONE: (919) 556-3148. CONTRACTOR SHALL BE RESPONSIBLE FOR VERIFYING ALL EXISTING INFORMATION, DEPICTED OR NOT, PRIOR TO CONSTRUCTION AND REPORT POTENTIAL CONFLICTS TO OWNER AND ENGINEER.

WASHED STÖNE --STANDARD METAL POSTS 2'-0" IN GROUND GALVANIZED HARDWARE WIRE EXTENDS TO THE TOP OF BOX. (19 GAUGE, 1/4" MESH OPENINGS.) - #57 WASHED STONE PLACED TO A HEIGHT OF 16" MIN. ABOVE TOP OF BOX

MAINTENANCE

NCDOT #57

INSPECT INLETS AT LEAST WEEKLY AND AFTER EACH SIGNIFICANT (1/2 INCH OR GREATER) RAINFALL EVENT. CLEAR THE MESH WIRE OF ANY DEBRIS OR OTHER OBJECTS TO PROVIDE ADEQUATE FLOW FOR SUBSEQUENT RAINS. TAKE CARE NOT TO DAMAGE OR UNDERCUT THE WIRE MESH DURING SEDIMENT REMOVAL. REPLACE STONE AS NEEDED.

CATCH BASIN AND YARD INLET PROTECTION N.T.S.

KHA DETAIL NO: 01.202.R0

- 19-GAUGE

DRAINAGE AREA MAY NOT

EXCEED 1 ACRE.

HARDWARE CLOTH

(1 MESH OPENINGS)

CATCH BASIN SILT PROTECTION INSERT N.T.S.



SHEET NUMBER SDP-23-09

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 \Box

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1. ACTUAL LAYOUT TO BE DETERMINED IN THE FIELD. 2. A CONCRETE WASHOUT SIGN SHALL BE INSTALLED WITHIN 30' OF THE TEMPORARY CONCRETE WASHOUT FACILITY. 10 MIL. PLASTIC LINING 3. MATERIALS USED TO CONSTRUCT TEMPORARY CONCRETE WASHOUT FACILITIES SHALL BE REMOVED FROM THE SITE AND DISPOSED OF OR RECYCLED. 4. HOLES, DEPRESSIONS OR OTHER GROUND DISTURBANCE CAUSED BY THE REMOVAL OF THE

ANCHOR PLASTIC -LINER WITH #57 STONE BERM

SECTION B-B


KHA DETAIL NO: 01.102.R01


-KEY/ANCHOR MATERIAL AT


1. LAY BLANKETS LOOSELY AND STAKE OR STAPLE TO MAINTAIN DIRECT


- 2. * DIMENSIONS SHOWN ARE MINIMUM, MANUFACTURED PRODUCTS MAY HAVE
- 3. SLOPE SURFACE SHALL BE FREE OF ROCKS, SOIL CLODS, STICKS, GRASS.
- 4. THE DETAIL SHOWN IS FOR SLOPE MATTING. FOR CHANNEL OR PIPE OUTFALL MATTING SPECIFICATIONS, PLEASE REFER TO NCESCPDM STANDARD

KHA DETAIL NO: 01.105.R0

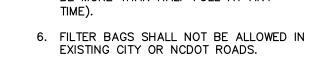

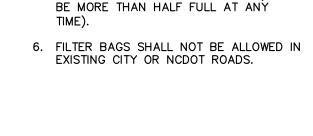

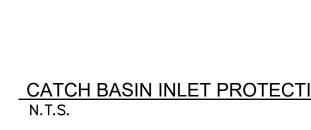

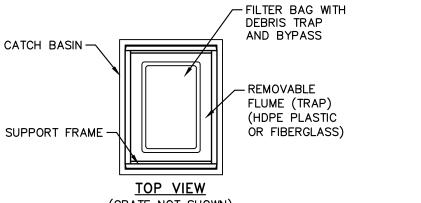

		CAPACII	I CHARI	
MODEL NO.	INLET SIZE	LINER DEPTH	STORAGE CAPACITY*	CLEAN FLOW RATE**
FF-2424HC	24" X 24"	12"	1.67 CU. FT.	470 GPM
" "	24" X 24"	24"	4.18 CU. FT.	914 GPM
29 29	24" X 24"	36"	6.69 CU. FT.	1,357 GPM
FF-2436HC	24" X 36"	12"	2.55 CU. FT.	641 GPM
29 29	24" X 36"	24"	6.38 CU. FT.	1,201 GPM
29 29	24" X 36"	36"	10.20 CU. FT.	1,761 GPM
FF-3636HC-GO	36" X 36"	12"	3.36 CU. FT.	772 GPM
"	36" X 36"	24"	8.39 CU. FT.	1,402 GPM
22	36" X 36"	36"	13.43 CU. FT.	2,032 GPM

** FLOW RATES ARE "CALCULATED CLEAN FLOW RATES" BASED ON LINER MATERIAL FLOW RATE OF 70 GPM/SQ. FT. (RECOMMEND APPLYING FACTOR OF .25 TO .50 TO FLOW RATES TO ALLOW FOR SEDIMENT AND DEBRIS)

<u>NOTES</u>


1. CATCH BASIN INSERTS ARE AVAILABLE IN SIZES TO

- PETROLEUM RESISTANT FIBERGLASS OR HDPE PLASTIC. 3. FILTER LINER SUPPORT BASKET SHALL BE
- 4. INSERT LINERS ARE AVAILABLE IN STANDARD DEPTHS OF 12", 24" OR 36" (REFER TO CAPACITY CHART).


INSPECT THE PROTECTION INSERT AND REMOVE ALL


(GRATE NOT SHOWN) CAPACITY CHART


* STORAGE CAPACITY REFLECTS MAXIMUM SOLIDS COLLECTION PRIOR TO IMPEDING BYPASS.

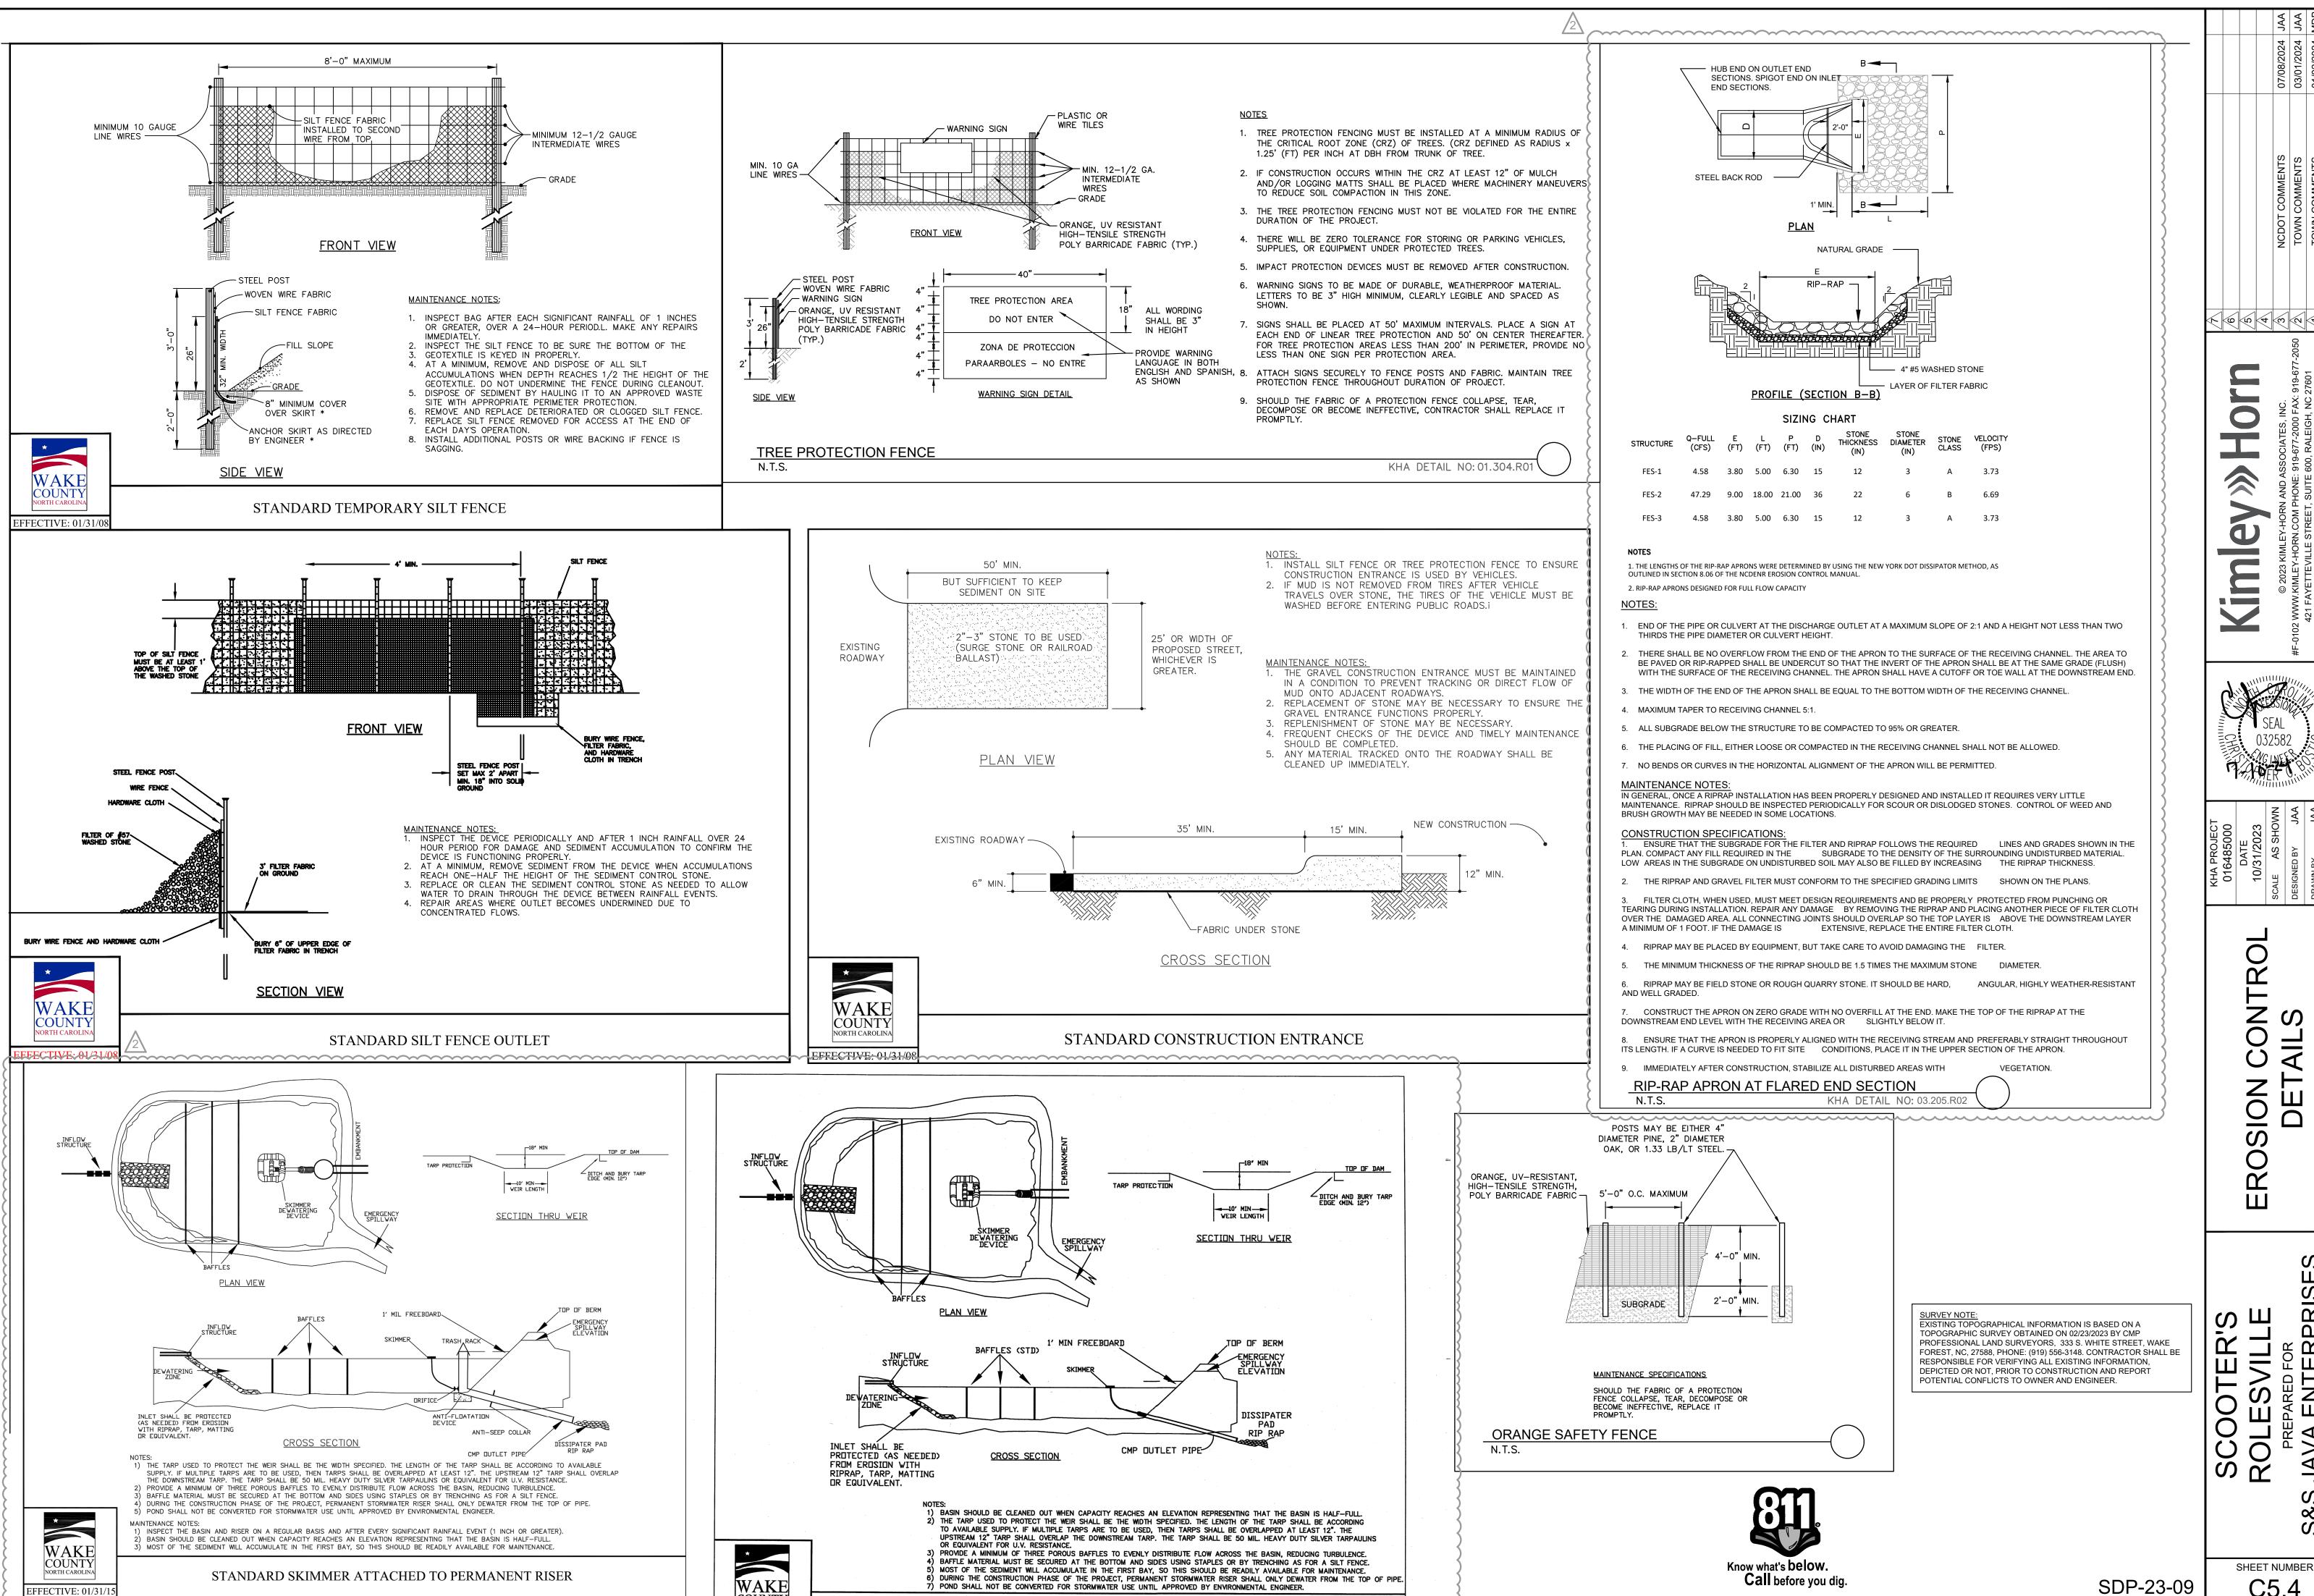



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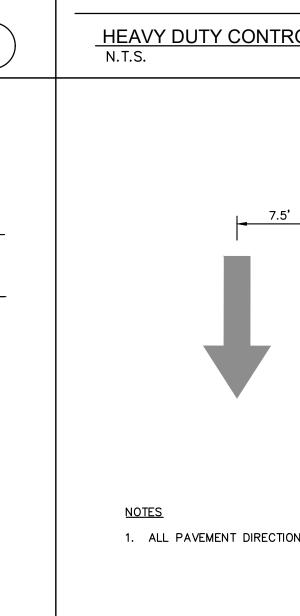


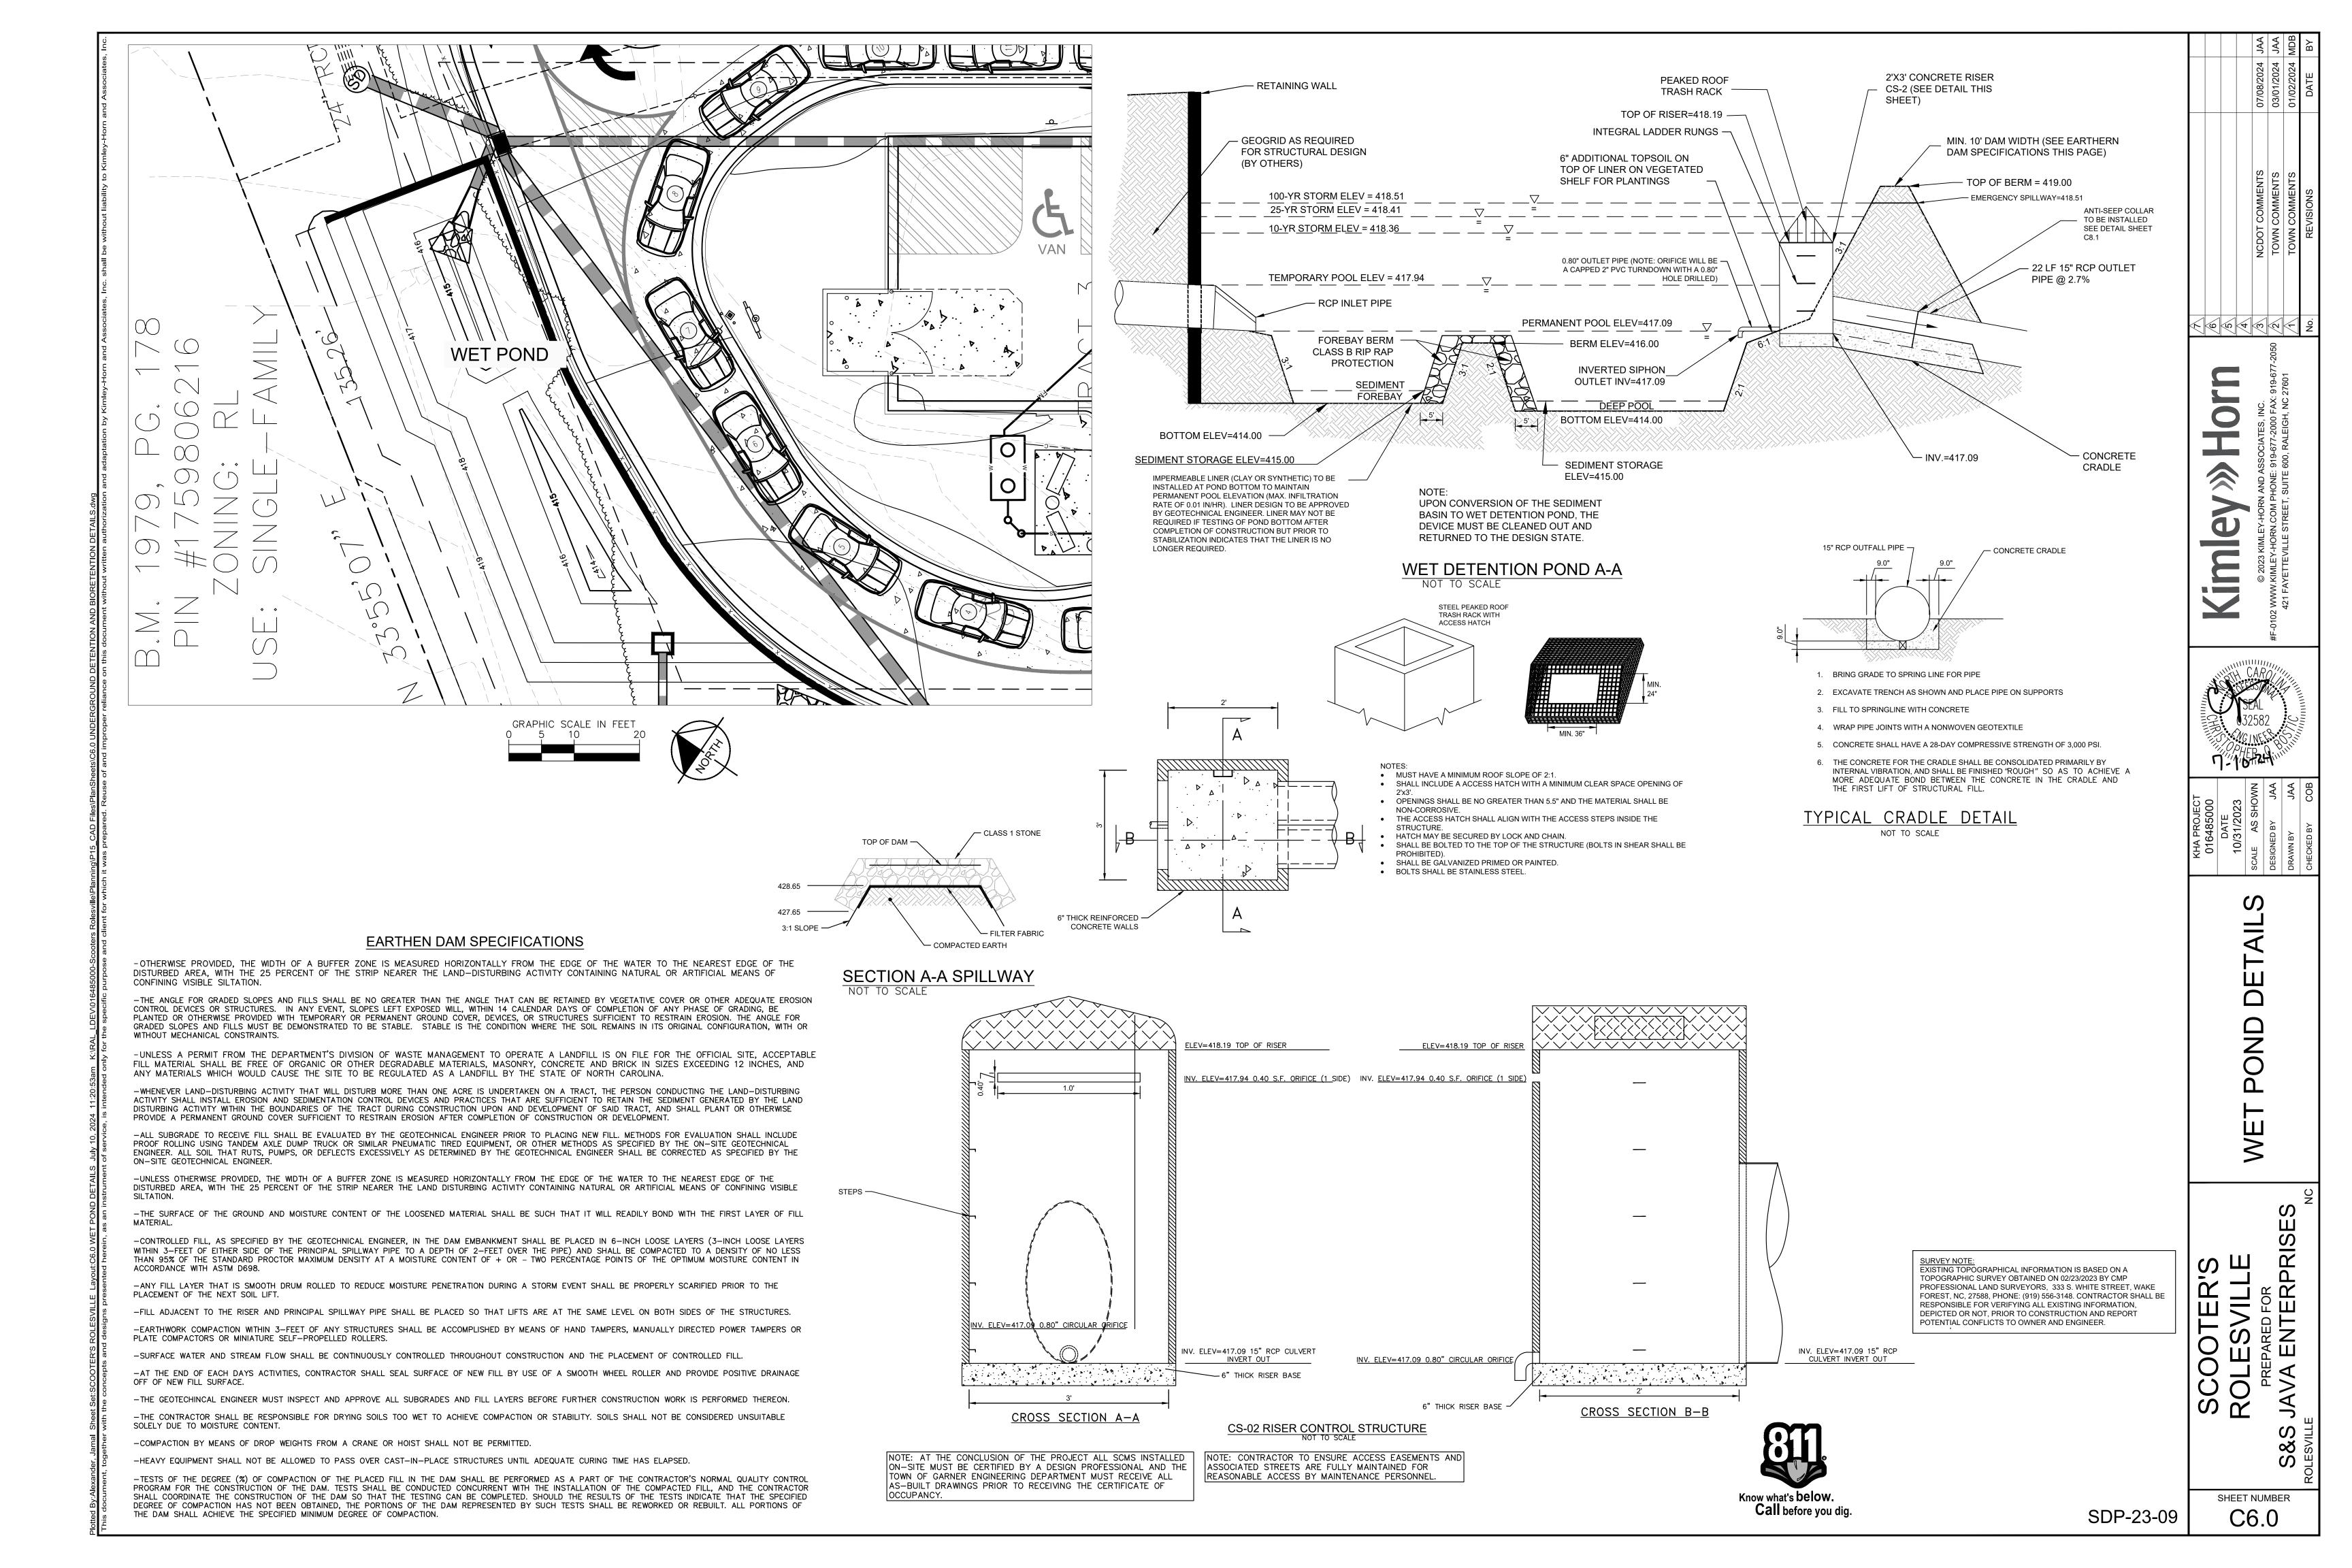

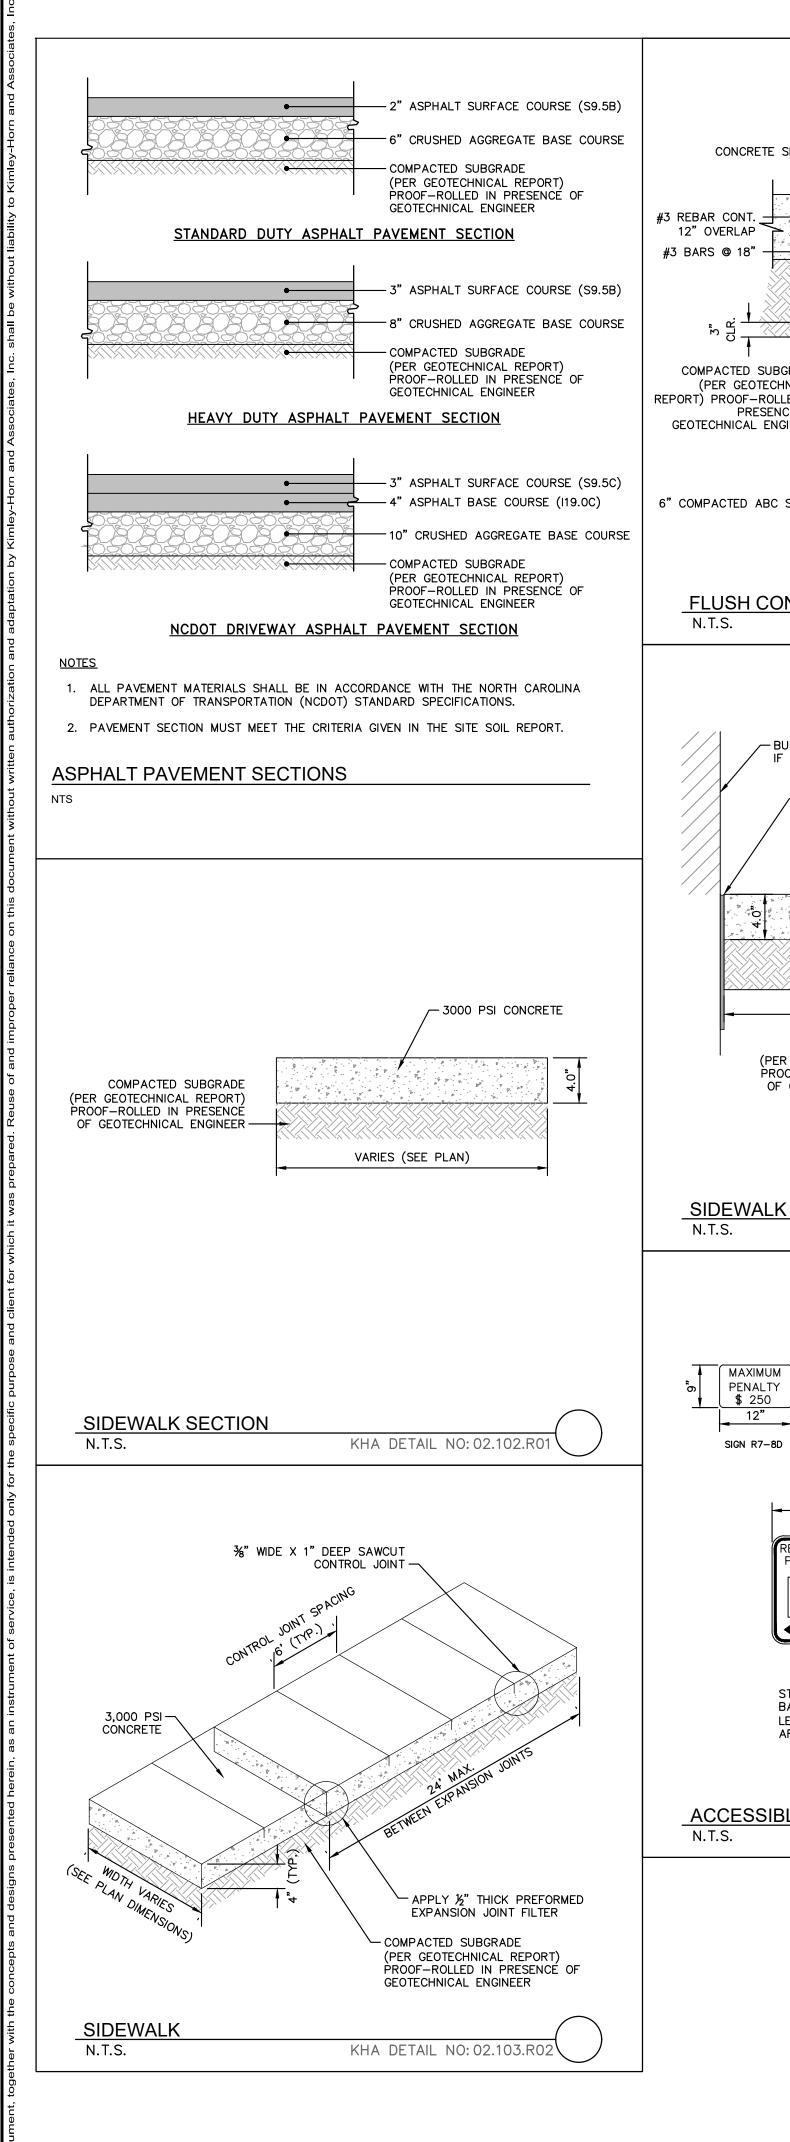

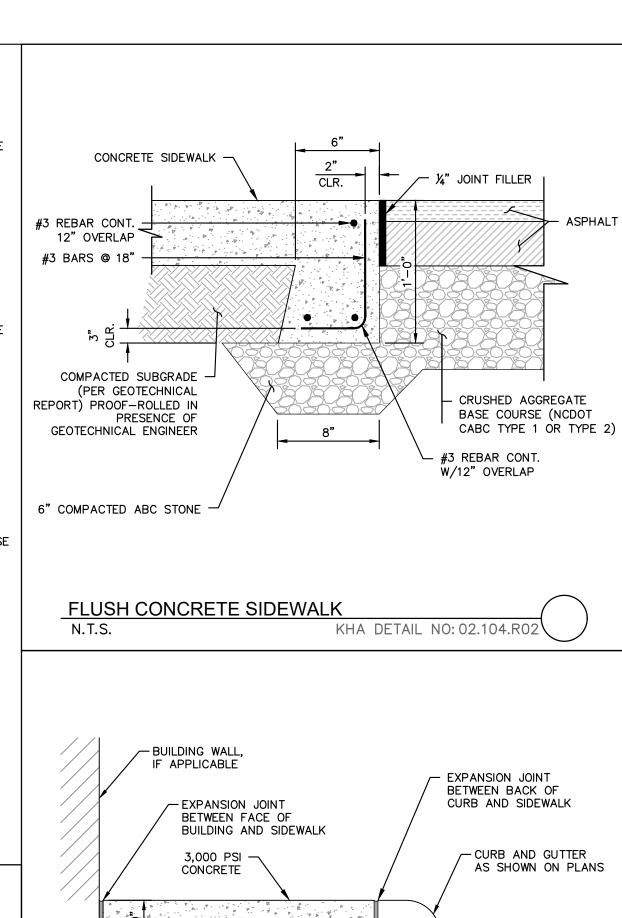

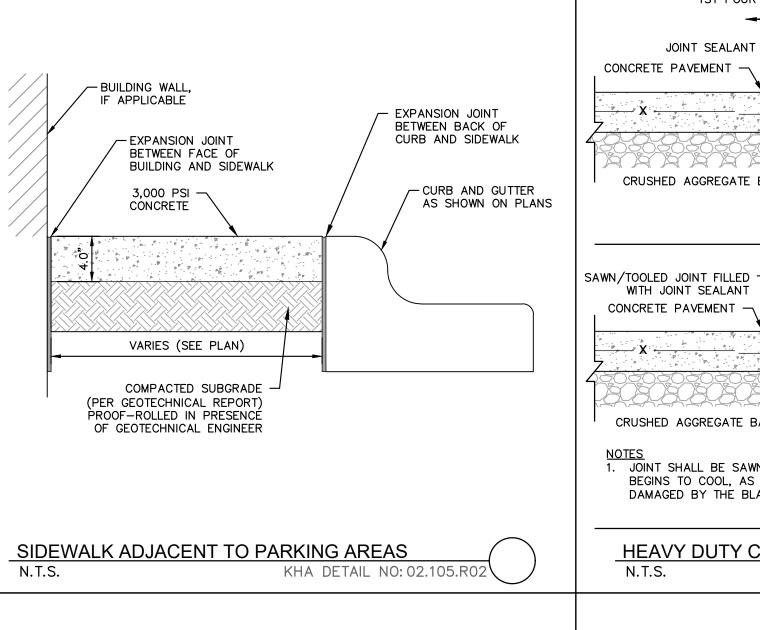

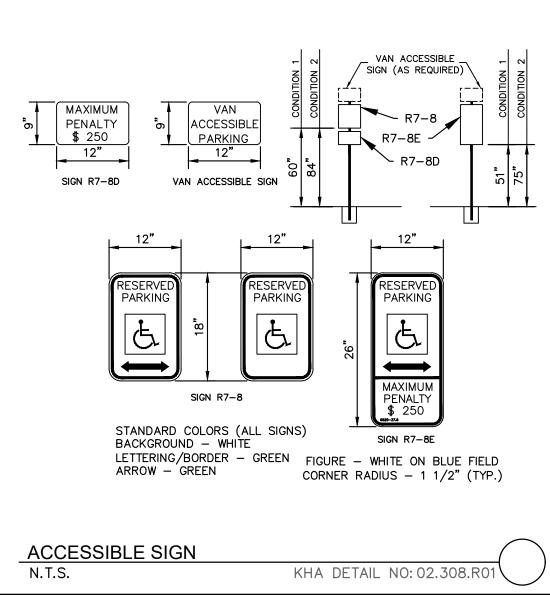

½" THICK PIECE OF BITUMINOUS —

2. CONTROL JOINTS 12' O.C.

5. BROOM FINISH

CONCRETE PAVEMENT

3. EXPANSION JOINTS 30' O.C. (MAX)

1ST POUR ─

JOINT SEALANT

CRUSHED AGGREGATE BASE

WITH JOINT SEALANT

CONCRETE PAVEMENT -

4. CONTROL JOINT SPACING MAY VARY.

(FIBERMESH REINFORCEMENT)

1. EXPANSION JOINTS AT BUILDINGS OR IMMOVABLE OBJECTS.

CONCRETE APRON AND DUMPSTER PAD

_ 2ND POUR

EXPANSION JOINT

- COMPACTED SUBGRADE

GEOTECHNICAL ENGINEER

(PER GEOTECHNICAL REPORT)

PROOF-ROLLED IN PRESENCE OF

KHA DETAIL NO: 02.107.R01

- 1 $\frac{1}{4}$ " ø x 18" LONG SMOOTH DOWEL 12"

WELDED WIRE FABRIC

- THIS SIDE WRAPPED WITH POLYETHYLENE

- 1 $\frac{1}{4}$ " ø x 18" LONG SMOOTH DOWEL 12"

OC IN SLAB. CENTER IN DOWEL BASKET

COVERING OR LUBRICATED

O.C. IN SLAB. CENTER IN DOWEL BASKET


2ND POUR.


JOINT SHALL BE CUT TO A


FIBER REQUIRED WHEN ABUTTING

A RIGID STRUCTURE. SEAL WITH

WATERPROOF SEALANT

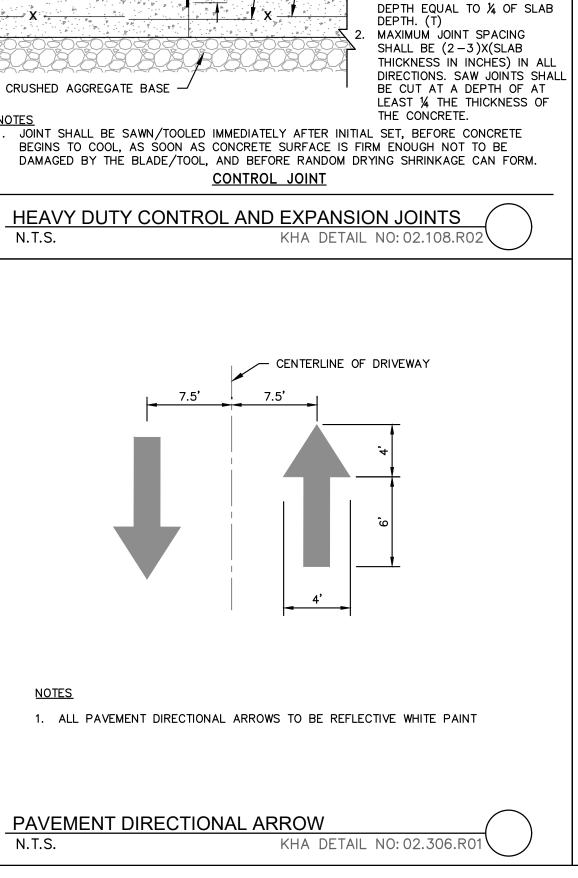

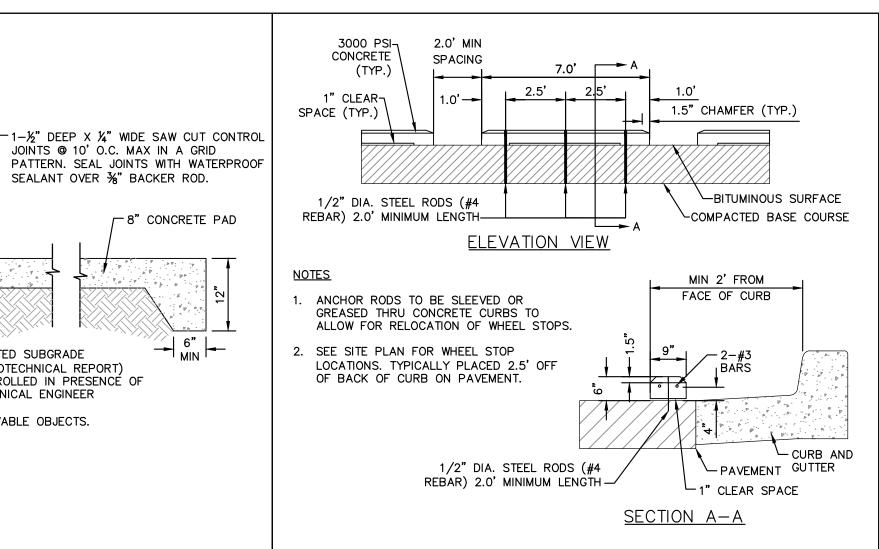


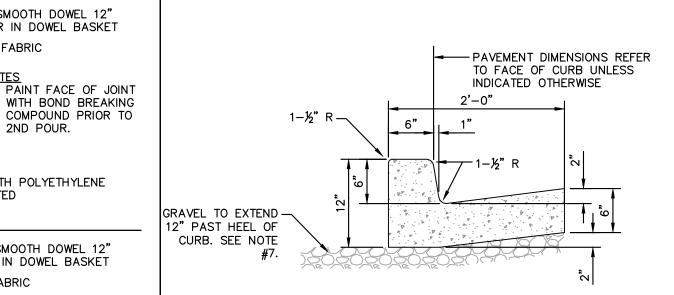

WHEEL STOP



KHA DETAIL NO: 02.111.R02

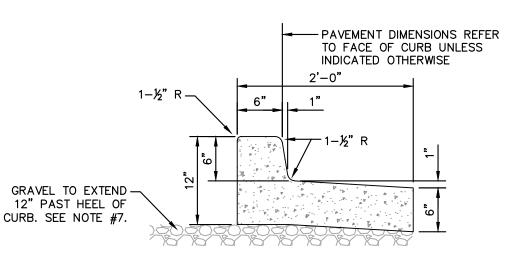

DRY CURB AND GUTTER

NOTE: INSTALL SPILL CURB IN AREAS WHERE PAVEMENT SLOPES AWAY FROM CURB.


CURB AND GUTTER NOTES

- 1. CONTRACTION JOINTS SHALL BE SPACED AT 10-FOOT INTERVALS. JOINT SPACING MAY BE ALTERED BY THE ENGINEER TO PREVENT UNCONTROLLED CRACKING.
- 2. CONTRACTION JOINTS MAY BE INSTALLED BY THE USE OF TEMPLATES OR FORMED BY OTHER APPROVED METHODS. WHERE SUCH JOINTS ARE NOT FORMED BY TEMPLATES, A MINIMUM DEPTH OF 1 1/2" SHALL BE
- 3. ALL EXPANSION JOINTS SHALL BE SPACED AT 90 FOOT INTERVALS, AND ADJACENT TO ALL RIGID OBJECTS. JOINTS SHALL MATCH LOCATIONS WITH JOINTS IN ABUTTING SIDEWALK.
- 4. CONCRETE COMPRESSIVE STRENGTH SHALL BE 3000 P.S.I. IN 28 DAYS.
- 5. CURB SHALL BE DEPRESSED AT INTERSECTIONS TO PROVIDE FOR FUTURE ACCESSIBLE RAMPS, REFER TO SITE PLAN FOR LOCATIONS.

6. TOP 6" OF SUBGRADE BENEATH THE CURB AND GUTTER SHALL BE

- COMPACTED TO 95% STANDARD PROCTOR DENSITY.
- 7. EXTEND GRAVEL 12" PAST HEEL OF CURB IF REQUIRED PER GEOTECHNICAL RECOMMENDATIONS, MIN. DEPTH 4" IF FIELD CONDITIONS

24" CURB AND GUTTER N.T.S. KHA DETAIL NO: 02.203.R0

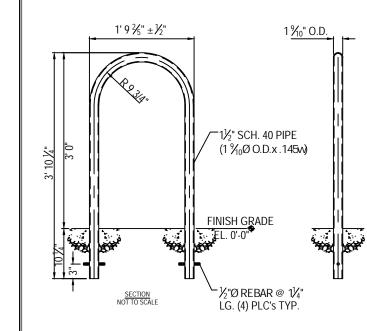


INVERTED "U" RACKS 1.5" I.D. STEEL PIPE, EMBEDDED MOUNT


INSTALLATION TO BE COMPLETED IN ACCORDANCE WITH MANUFACTURERS SPECIFICATIONS. CONTACT MANUFACTURER FOR CUSTOM COLORS.
SUBMIT SHOP DRAWINGS TO ENGINEER FOR APPROVAL.

RACKS SHALL BE SPACED AT LEAST 24" FROM WALLS, CURB FACES, PAVEMENT EDGES, AND OTHER OBSTRUCTIONS. AT LEAST 36" CLEARANCE SHALL BE PROVIDED FROM THE CENTERLINE OF EACH ADJACENT RACK. A MINIMUM 4' AISLE SHALL BE PROVIDED TO THE FRONT OR REAR OF A BICYCLE SPACE.

BIKE RACK DETAIL

REVISION DATE: NTS 05/10/2016

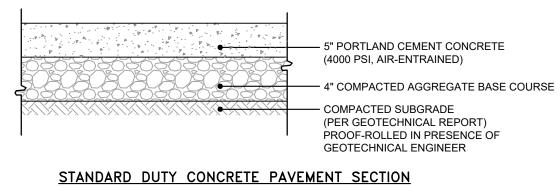

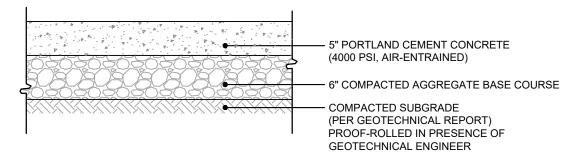

HEAVY DUTY CONCRETE PAVEMENT SECTION

1. ALL PAVEMENT MATERIALS SHALL BE IN ACCORDANCE WITH THE NORTH CAROLINA DEPARTMENT OF TRANSPORTATION (NCDOT) STANDARD SPECIFICATIONS.

SURVEY NOTE:
EXISTING TOPOGRAPHICAL INFORMATION IS BASED ON A

TOPOGRAPHIC SURVEY OBTAINED ON 02/23/2023 BY CMP PROFESSIONAL LAND SURVEYORS, 333 S. WHITE STREET, WAKE

POTENTIAL CONFLICTS TO OWNER AND ENGINEER.

FOREST, NC, 27588, PHONE: (919) 556-3148. CONTRACTOR SHALL BE RESPONSIBLE FOR VERIFYING ALL EXISTING INFORMATION, DEPICTED OR NOT, PRIOR TO CONSTRUCTION AND REPORT


2. PAVEMENT SECTION MUST MEET THE CRITERIA GIVEN IN THE SITE SOIL REPORT.


CONCRETE PAVEMENT SECTIONS KHA DETAIL NO:

< 6 0 4 6 0 4

SHEET NUMBER

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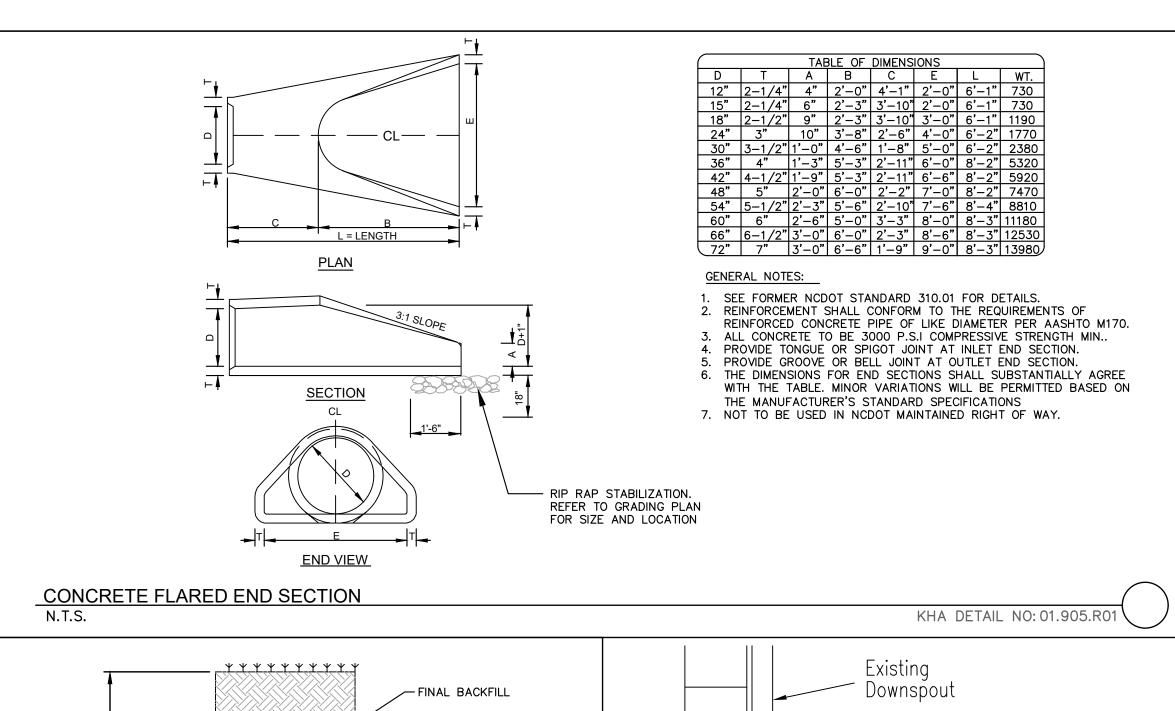
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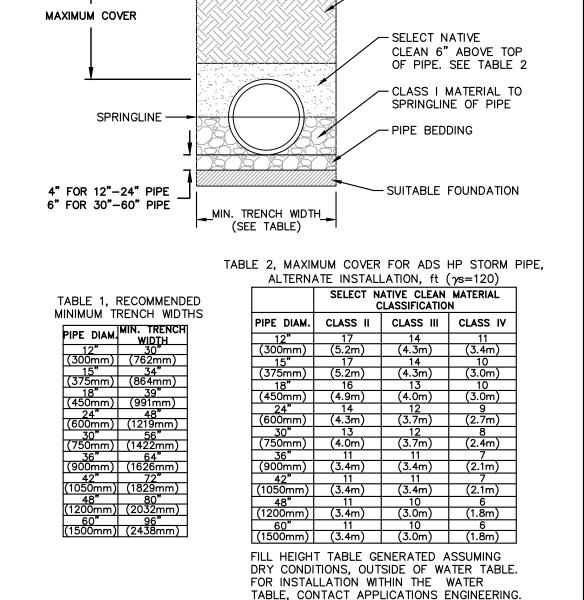
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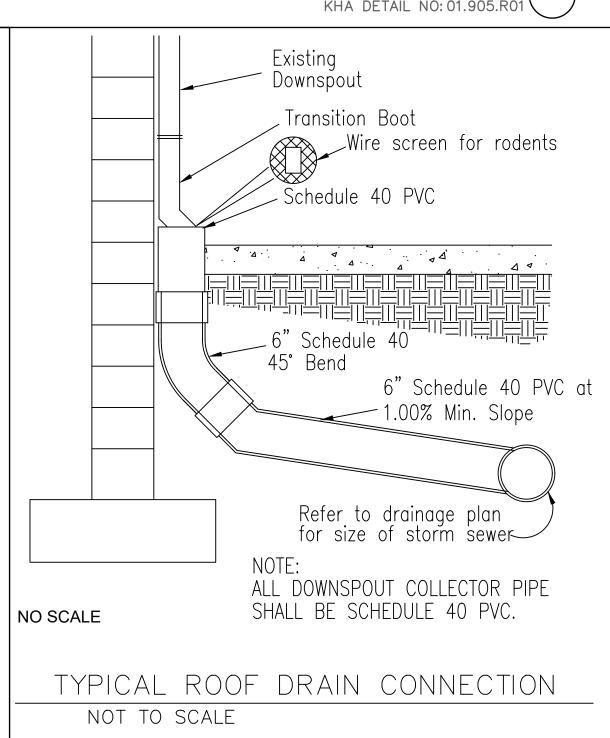
MEASURES SHOULD BE TAKEN TO PREVENT MIGRATION OF NATIVE FINES INTO BACKFILL

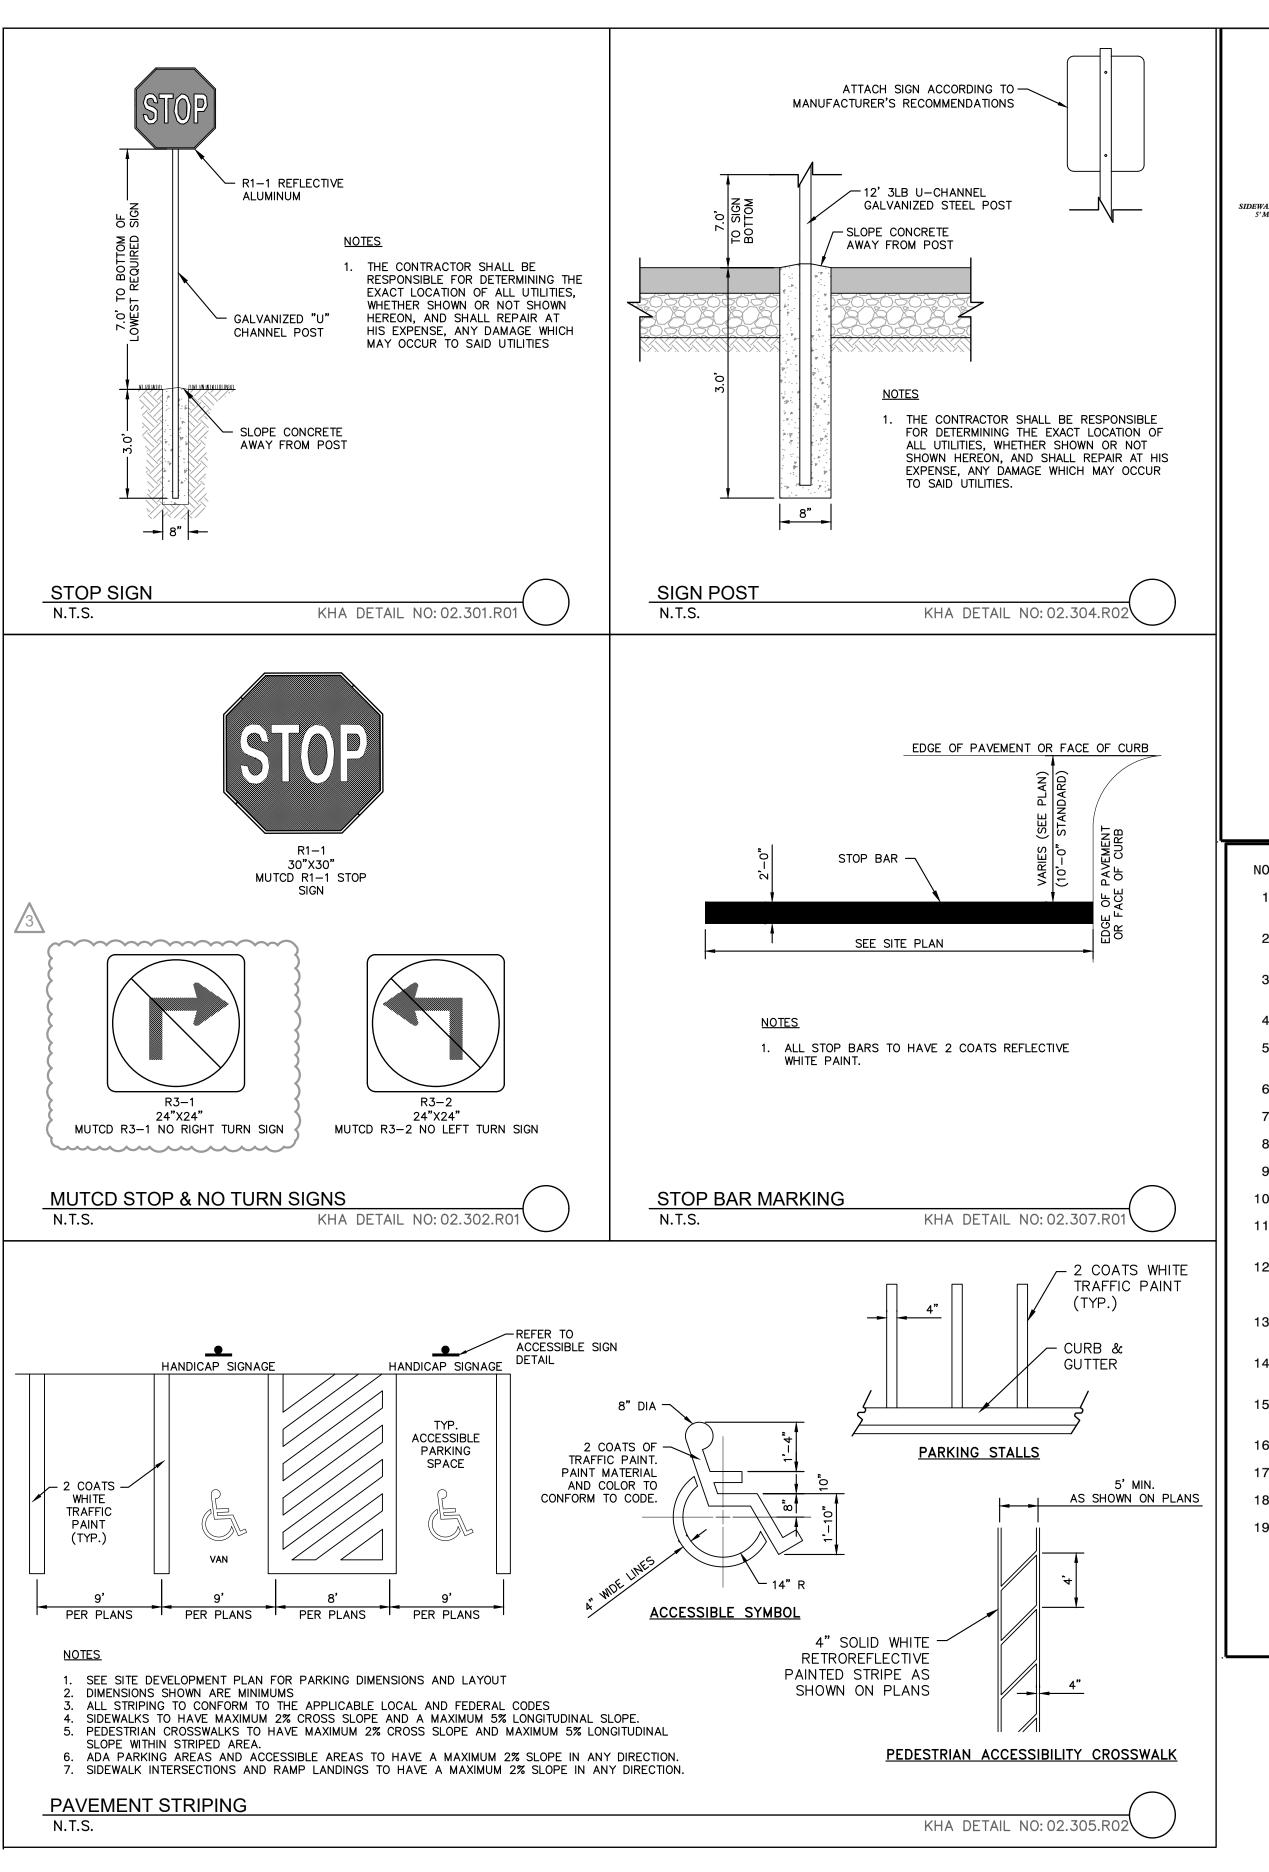
- MATERIAL, WHEN REQUIRED. 2. SOIL CLASSIFICATIONS ARE PER THE LATEST VERSION OF ASTM D2321. CLASS IVB MATERIALS (MH, CH) AS DEFINED IN PREVIOUS VERSIONS OF ASTM D2321 ARE NOT APPROPRIATE BACKFILL MATERIALS.
- FOUNDATION WHERE THE TRENCH BOTTOM IS UNSTABLE, THE CONTRACTOR SHALL EXCAVATE TO A DEPTH REQUIRED BY THE ENGINEER AND REPLACE WITH SUITABLE MATERIAL AS SPECIFIED BY THE ENGINEER. AS AN ALTERNATIVE AND AT THE DISCRETION OF THE DESIGN ENGINEER, THE TRENCH BOTTOM MAY BE STABILIZED USING A GEOTEXTILE MATERIAL.
- <u>BEDDING</u> SUITABLE MATERIAL SHALL BE CLASS I. THE CONTRACTOR SHALL PROVIDE DOCUMENTATION FOR MATERIAL SPECIFICATION TO ENGINEER. UNLESS OTHERWISE NOTED BY THE ENGINEER MINIMUM BEDDING THICKNESS SHALL BE 4" (100mm) FOR 4"-24"
- BACKFILL FOR PIPES OUTSIDE OF PAVEMENT CLASS I MATERIAL TO BE USED FOR BACKFILL UP TO THE SPRINGLINE OF PIPE. THE CONTRACTOR SHALL PROVIDE DOCUMENTATION FOR MATERIAL SPECIFICATION TO ENGINEER. UNLESS OTHERWISE NOTED BY THE ENGINEER. CLASS I MATERIAL MUST BE COMPACTED IN 6" (200mm) LIFTS.

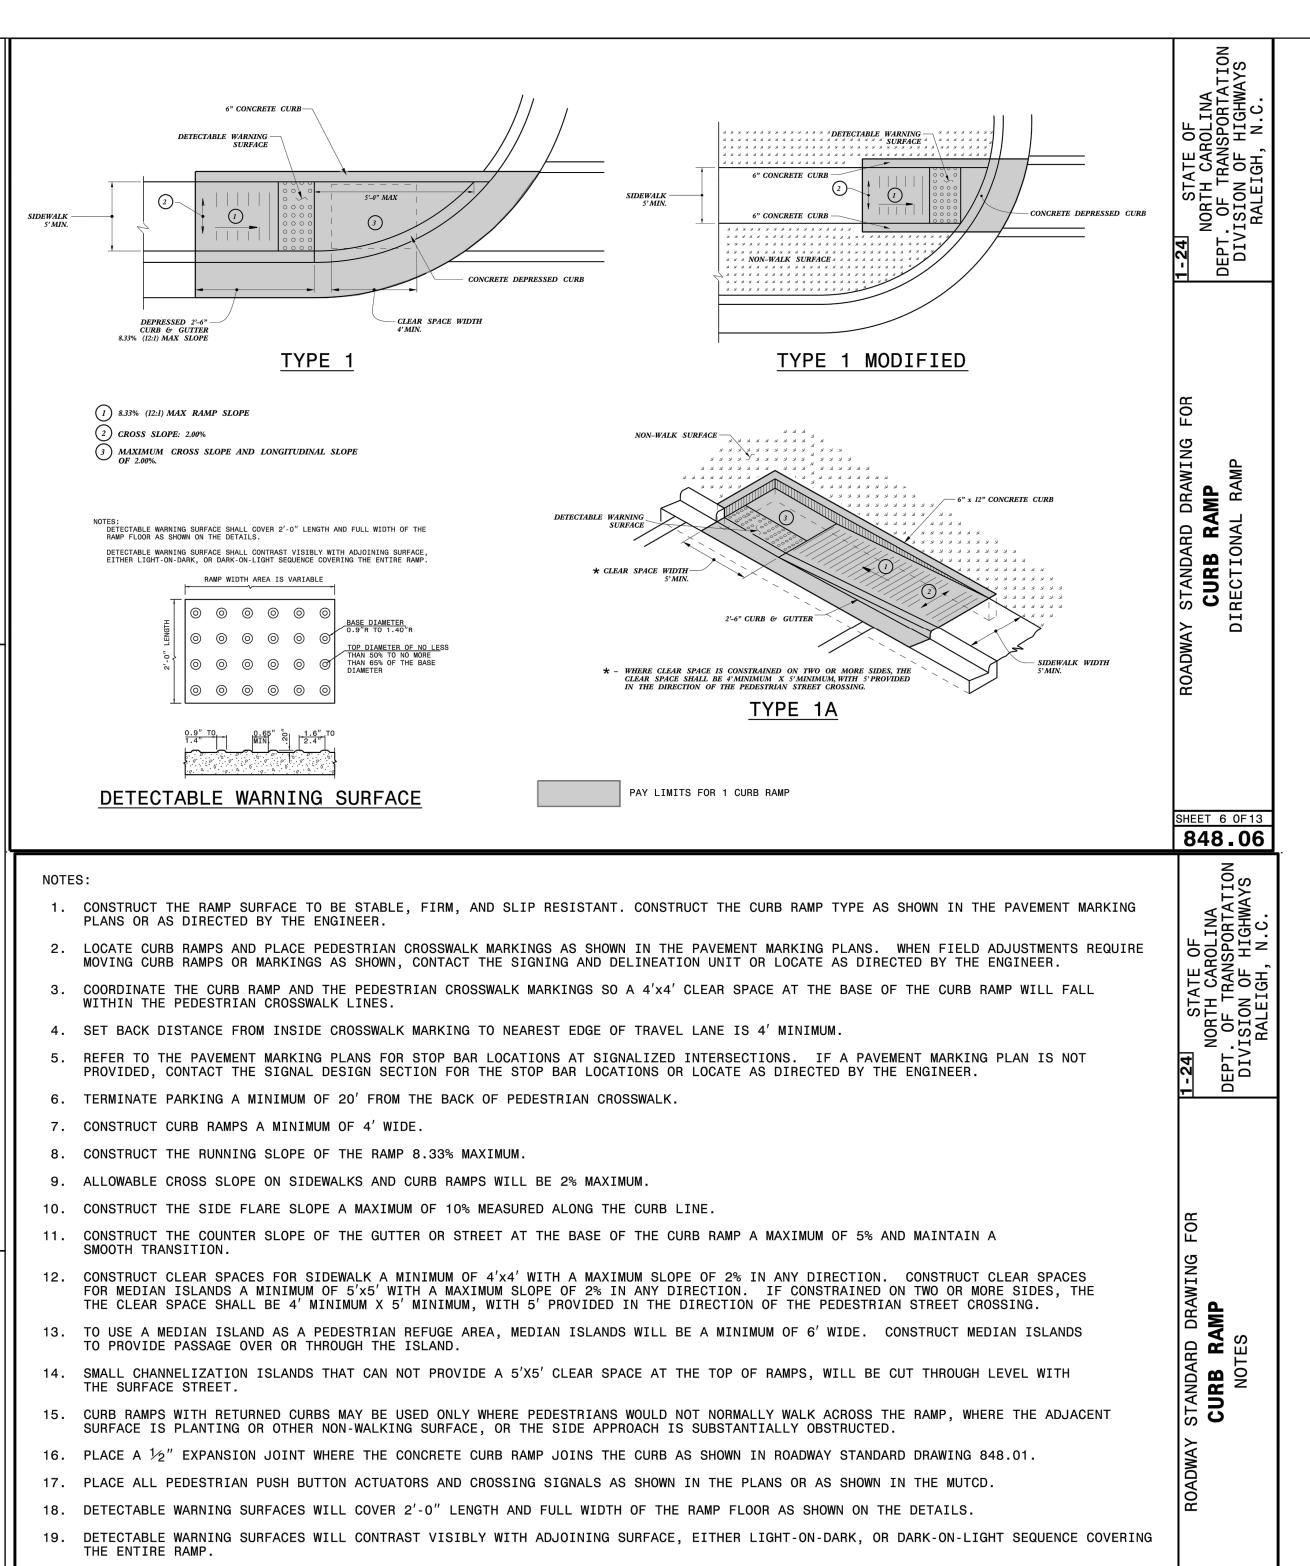(100mm-600mm); 6" (150mm) FOR 30"-60" (750mm-1500mm).

- MINIMUM COVER MINIMUM COVER, H, IN NON-TRAFFIC APPLICATIONS (GRASS OR LANDSCAPE AREAS IS 12" (300mm) FROM THE TOP OF PIPE TO GROUND SURFACE. ADDITIONAL COVER MAY BE REQUIRED TO PREVENT FLOTATION.
- SELECT NATIVE CLEAN BACKFILL SHALL BE WELL PLACED, MODERATELY COMPACTED (85% SPD) CLASS IV OR BETTER PER ASTM D2321 WITH NO FOREIGN DEBRIS INCLUDING ROCKS, LARGE CLUMPS ORGANIC MATERIAL, OR FROZEN MATERIAL.
- B. HP STORM ALTERNATE TRENCH DETAIL ONLY APPLIES TO BACKFILL INSTALLATIONS IN NON-TRAFFIC APPLICATIONS PER TN 2.04A. ALTERNATE TRENCH USE MUST BE APPROVED BY DESIGN ENGINEER. DETAIL DOES NOT SUPERSEDE ADS STANDARD DETAIL STD-108.

HP STORM TRENCH INSTALLATION DETAIL N.T.S. KHA DETAIL NO: 03.101.R01



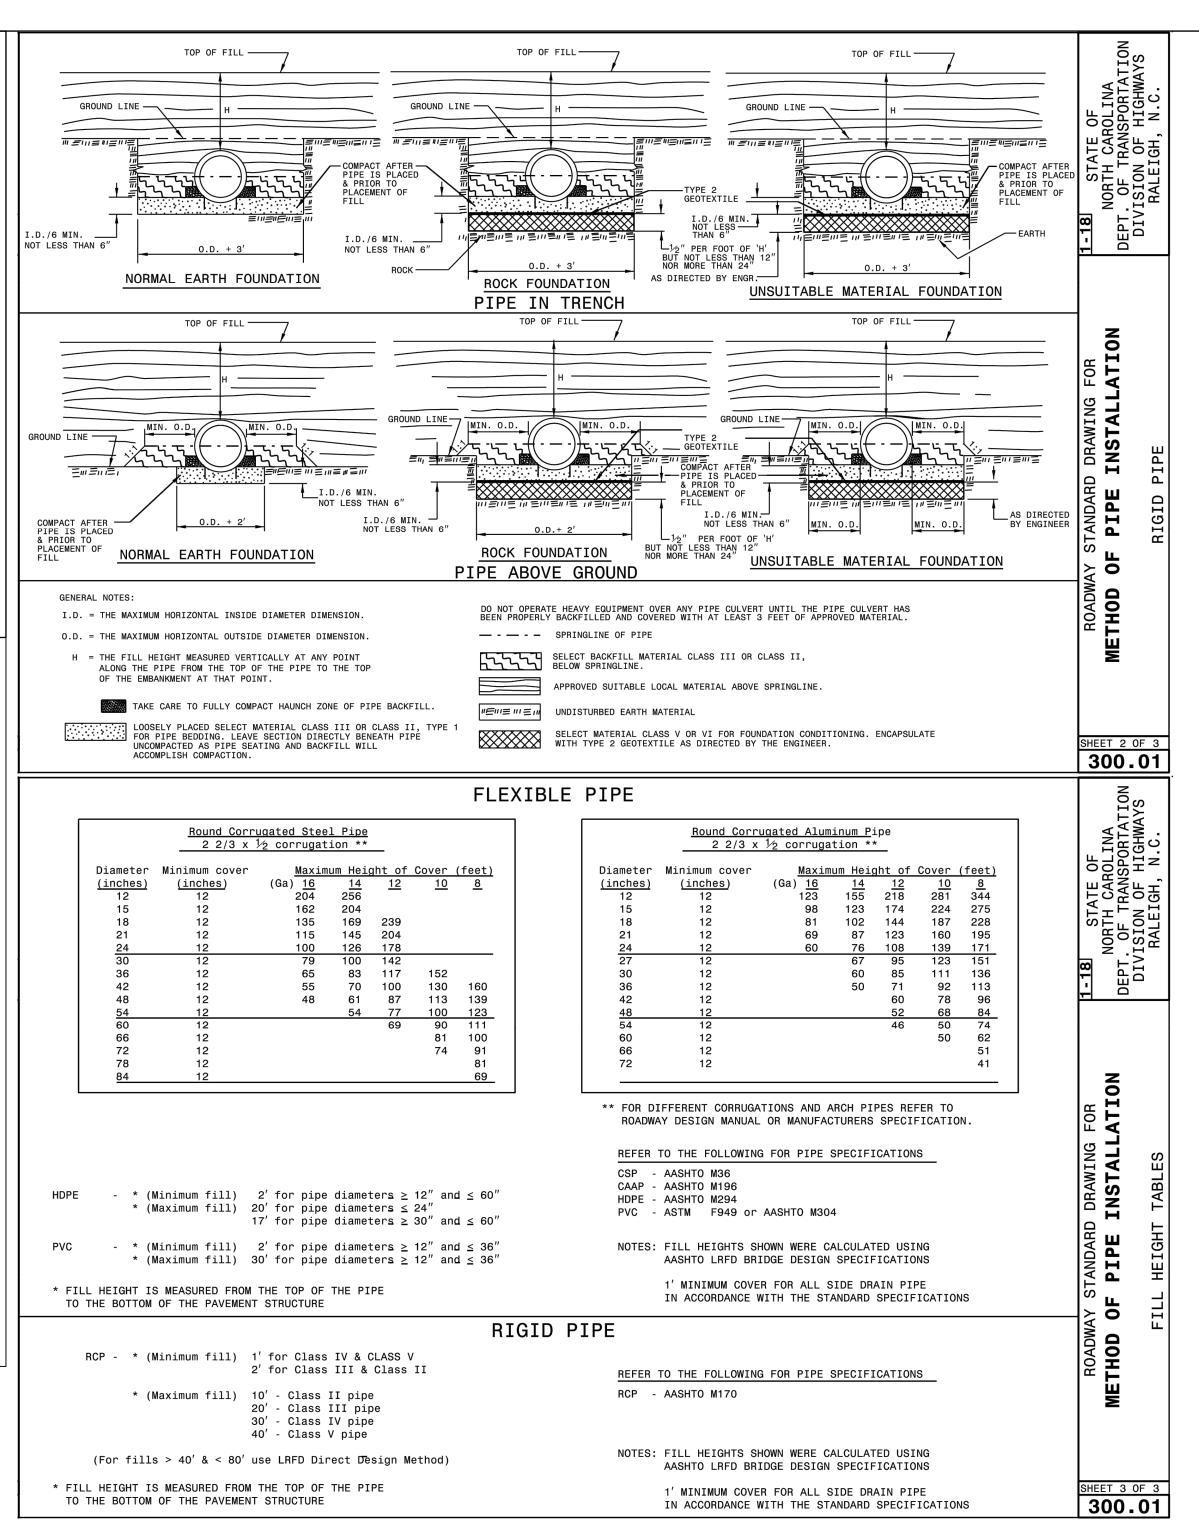

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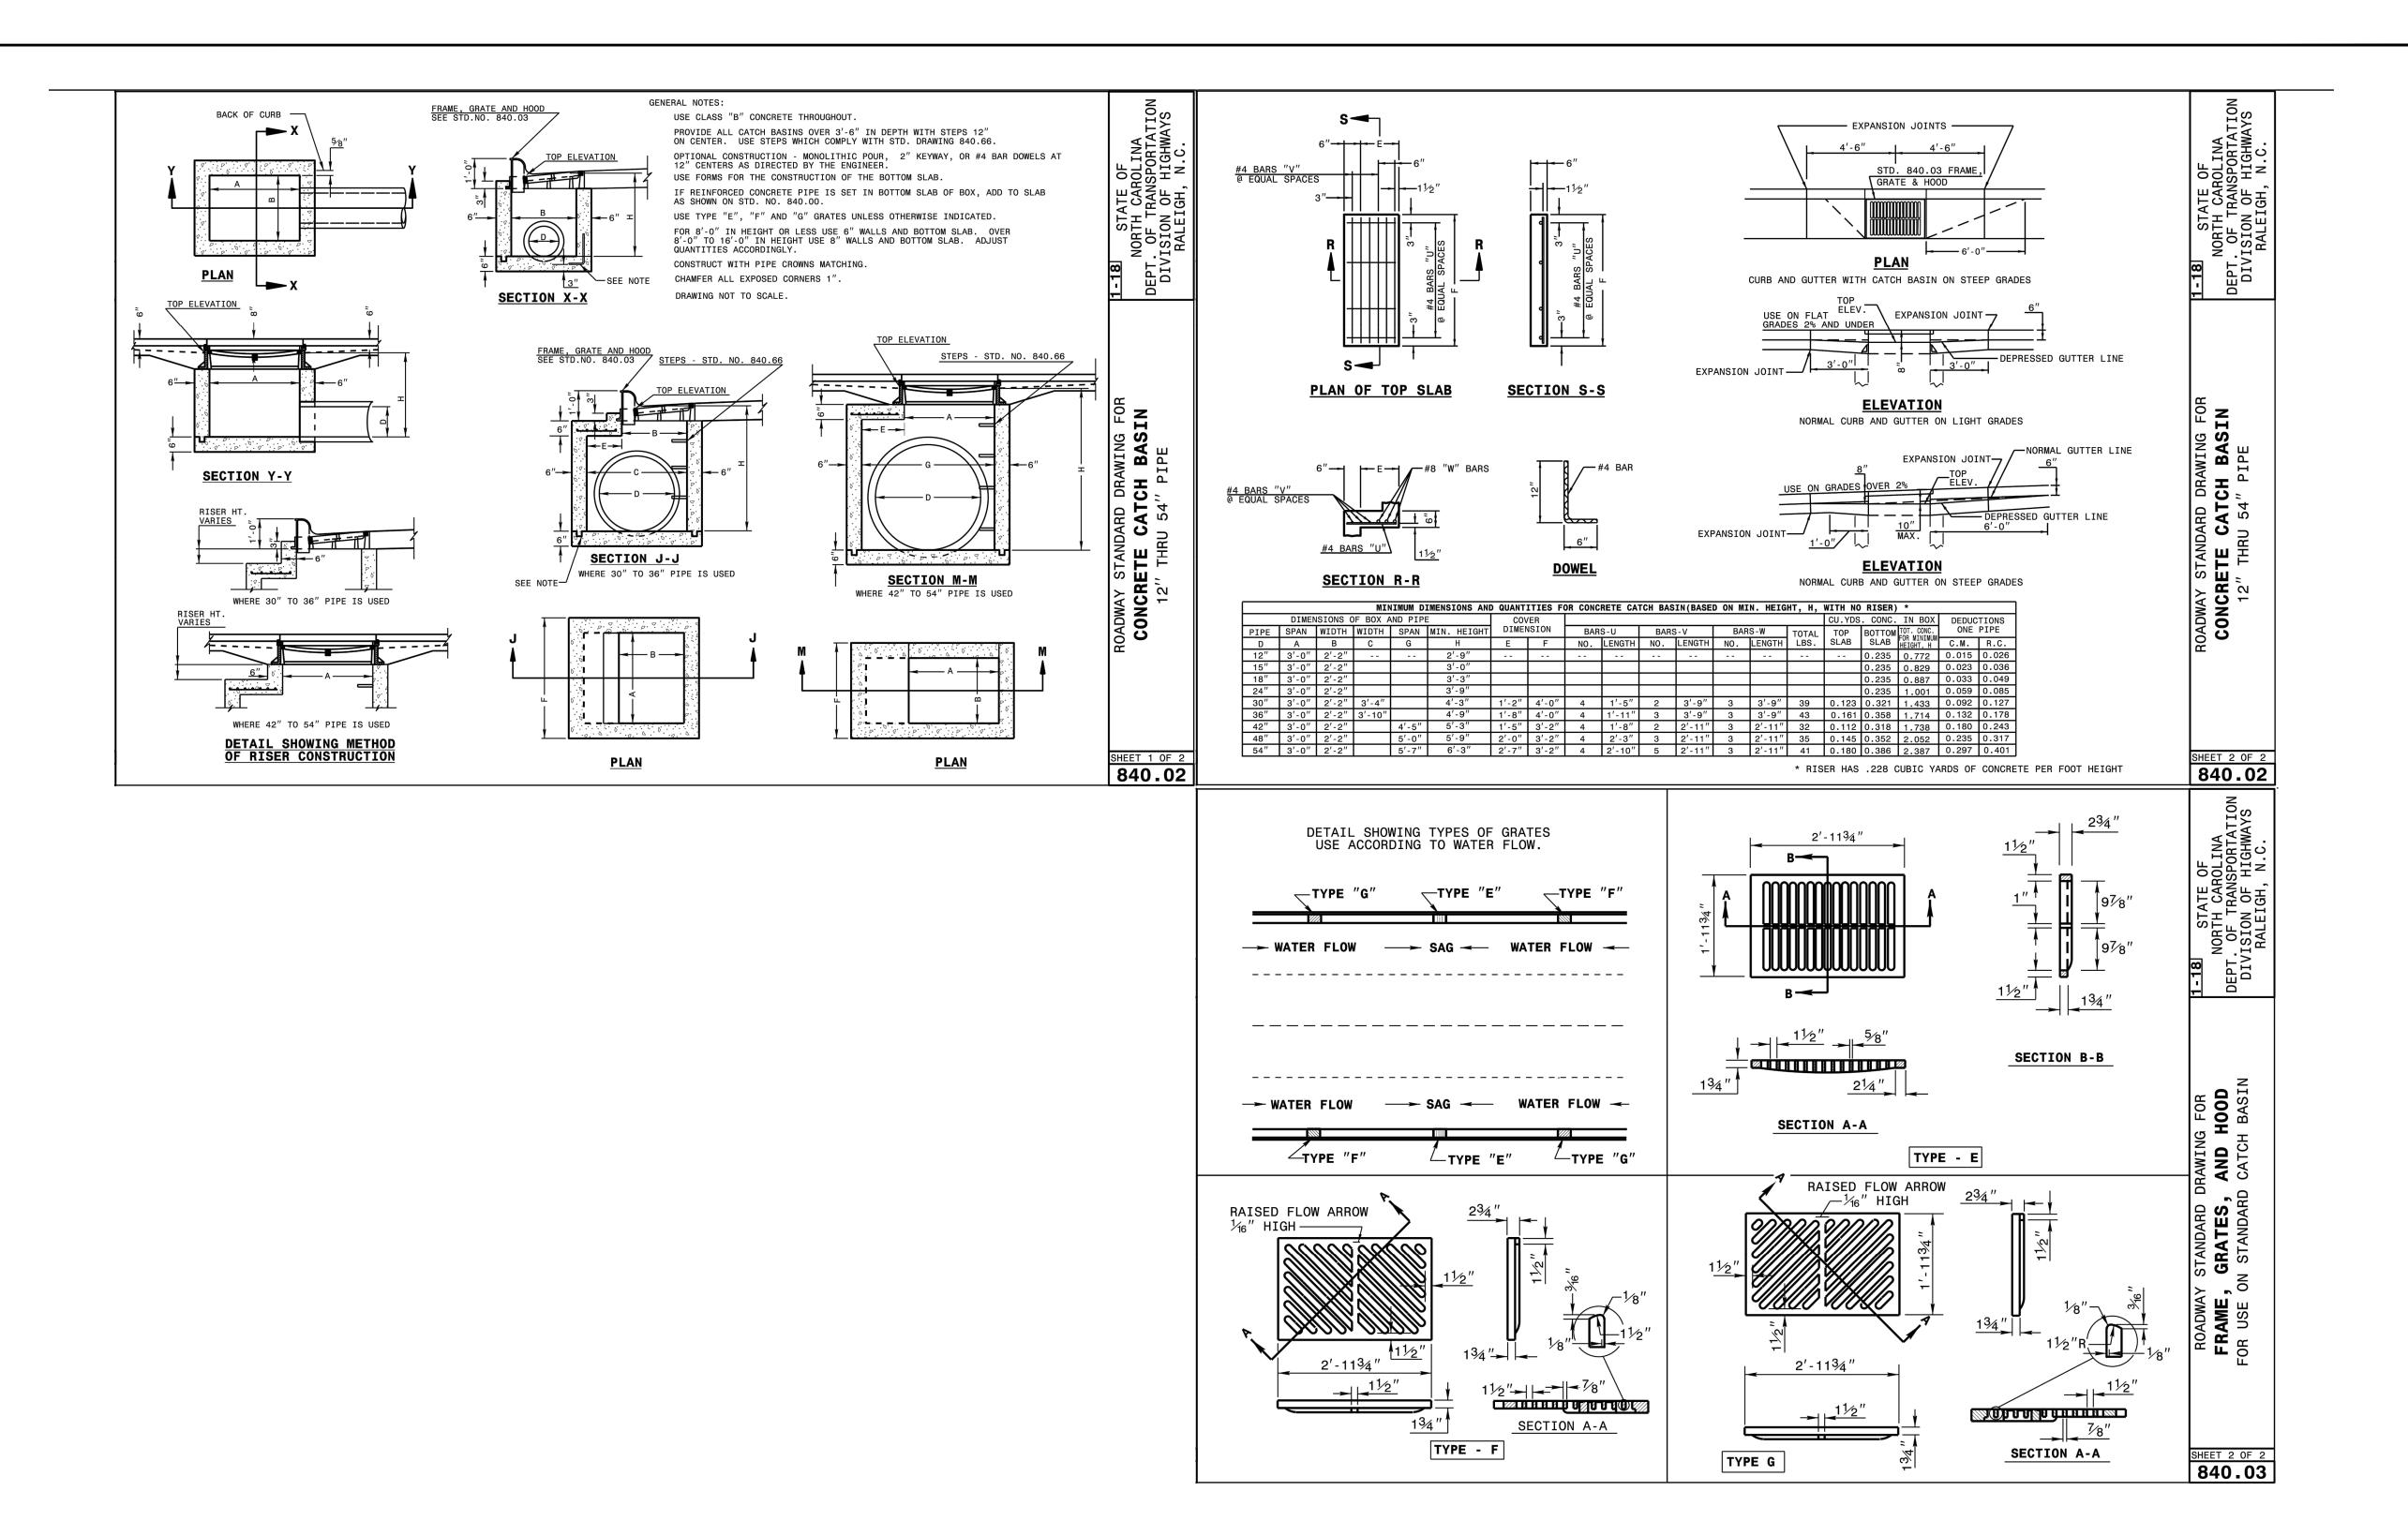
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SCOOTER'S ROLESVILLE

DETAIL


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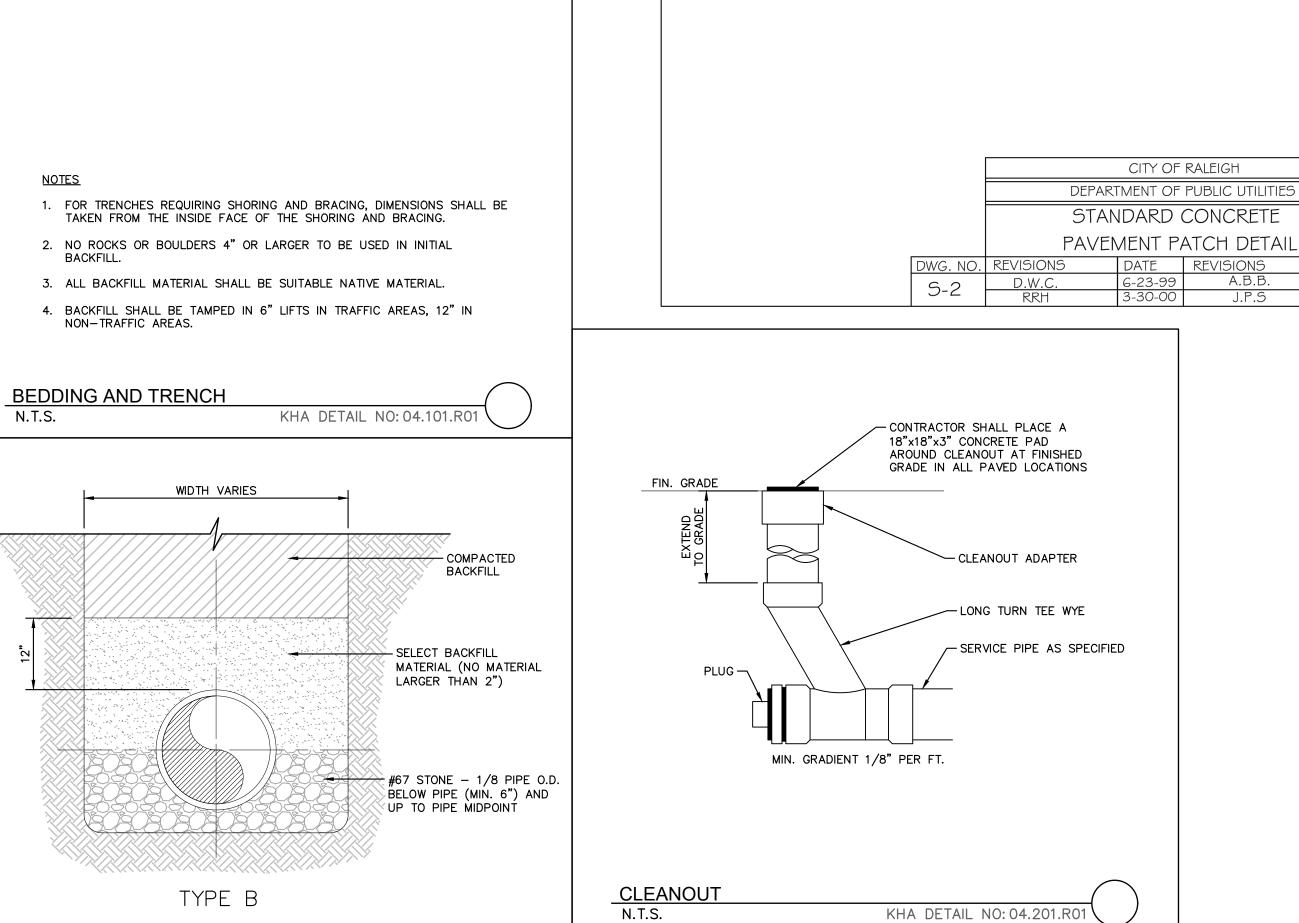



N.T.S.

BACKFILL SECTION

KHA DETAIL NO: 04.102.R01

N.T.S.

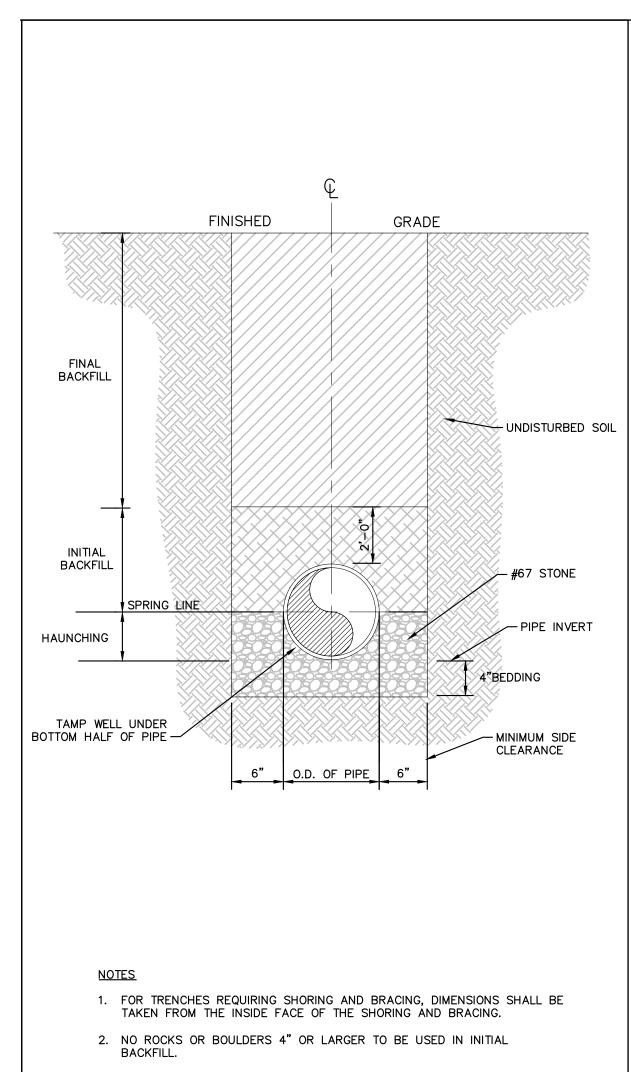

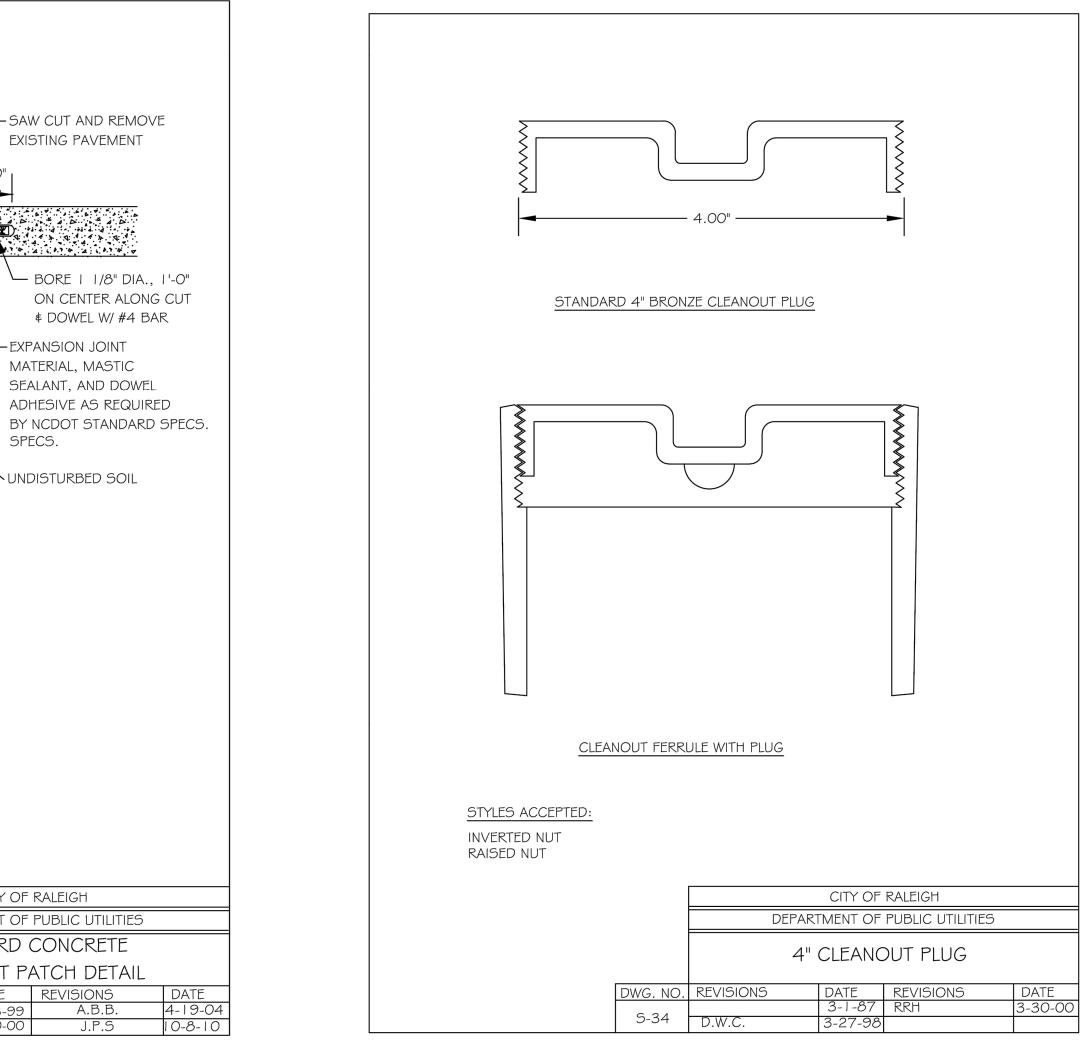

—— SAW CUT AND REMOVE

EXISTING PAVEMENT

- BORE | 1/8" DIA., 1'-0" ON CENTER ALONG CUT

DOWEL W/ #4 BAR

-EXPANSION JOINT

MATERIAL, MASTIC

NUNDISTURBED SOIL

SEALANT, AND DOWEL

ADHESIVE AS REQUIRED

SPECS.

NEW CONC. TO BE 3000 PSI -

SEE S-4 \$ S-5

KHA DETAIL NO: 04.201.R01

I. See City of Raleigh standards for trenches and pipe bedding (

2. Pavement cuts over 5'-0" in width shall be reinforced to

3. Pavement cuts shall be made with an appropriate saw cut

4. Pavement cuts within NCDOT ROW shall conform to the approved

EXISTING CONC.

6" COMPACTED -

BACKFILL, TAMPED


S-4 \$ S-5) for additional details.

N.C.D.O.T. standards.

on site encroachment permit.

NO. 67 STONE

IN 6" LIFTS

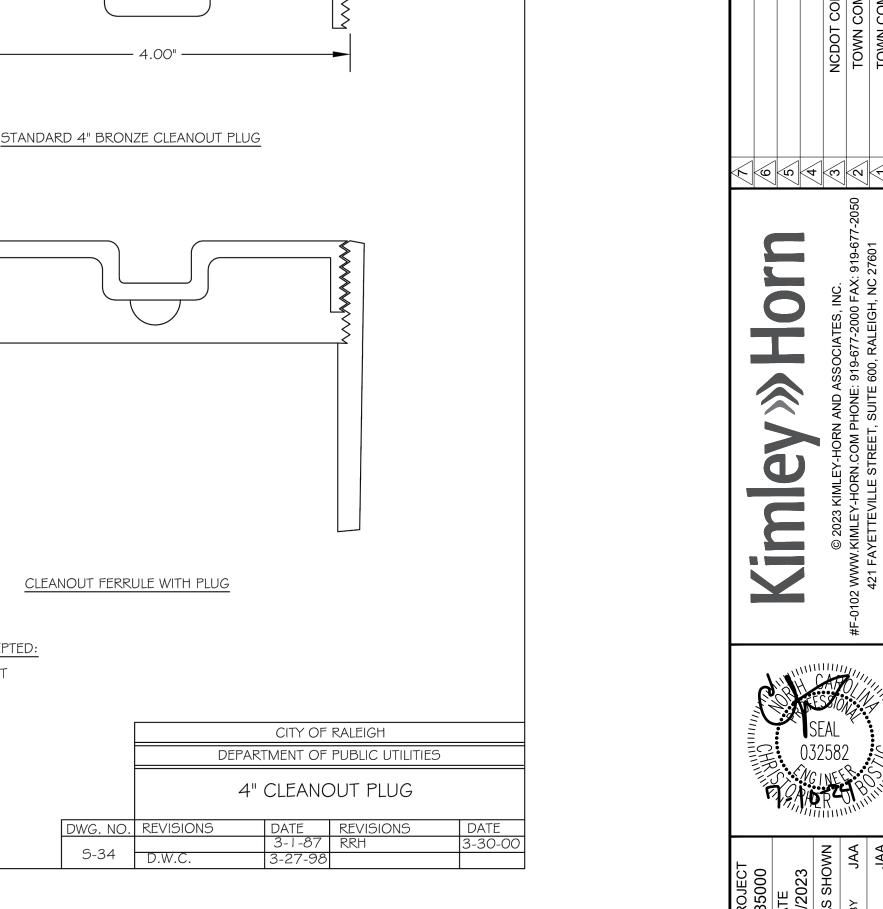

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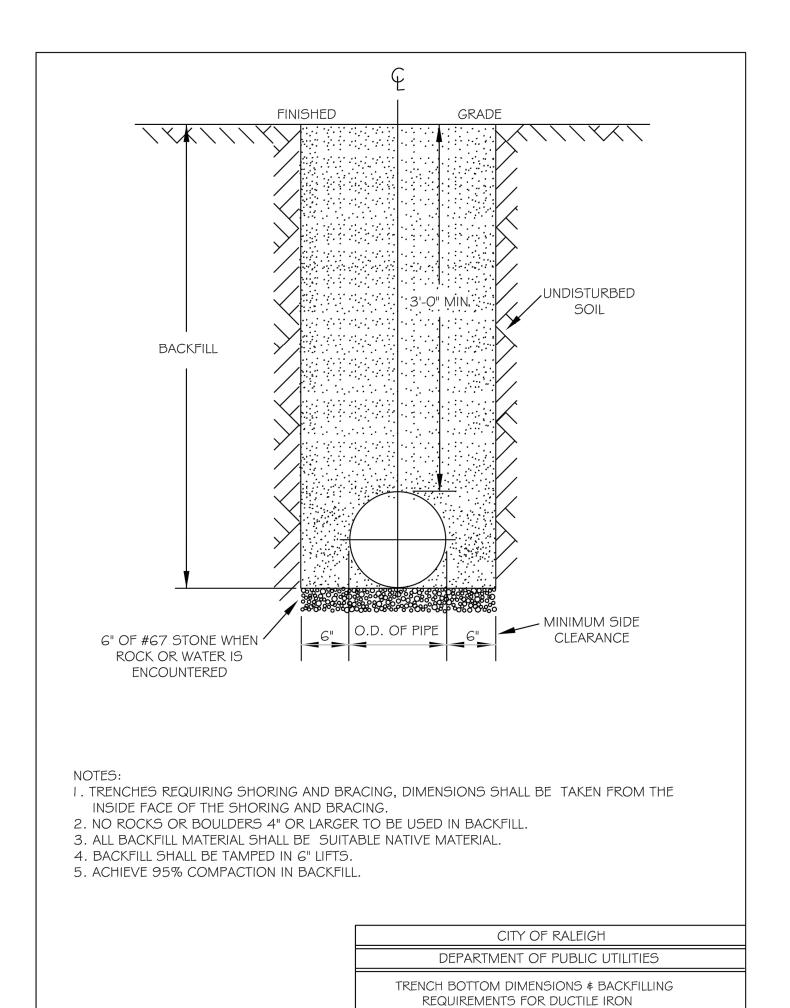
PREPARED FOR JAVA ENTERPRISES S&S


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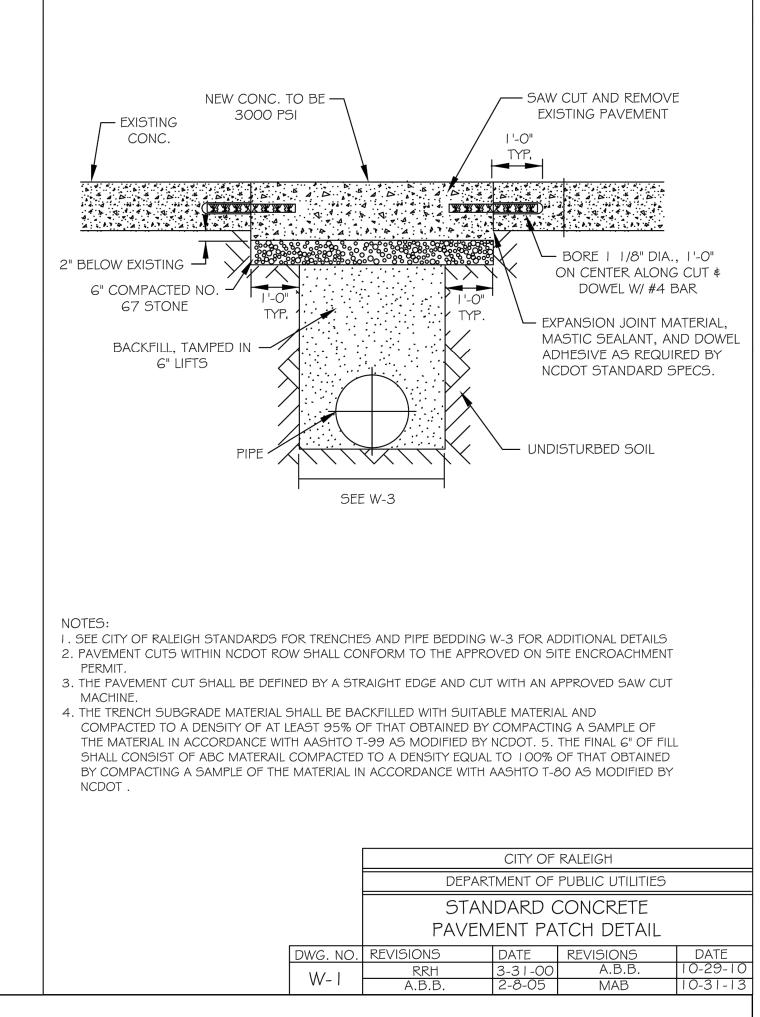
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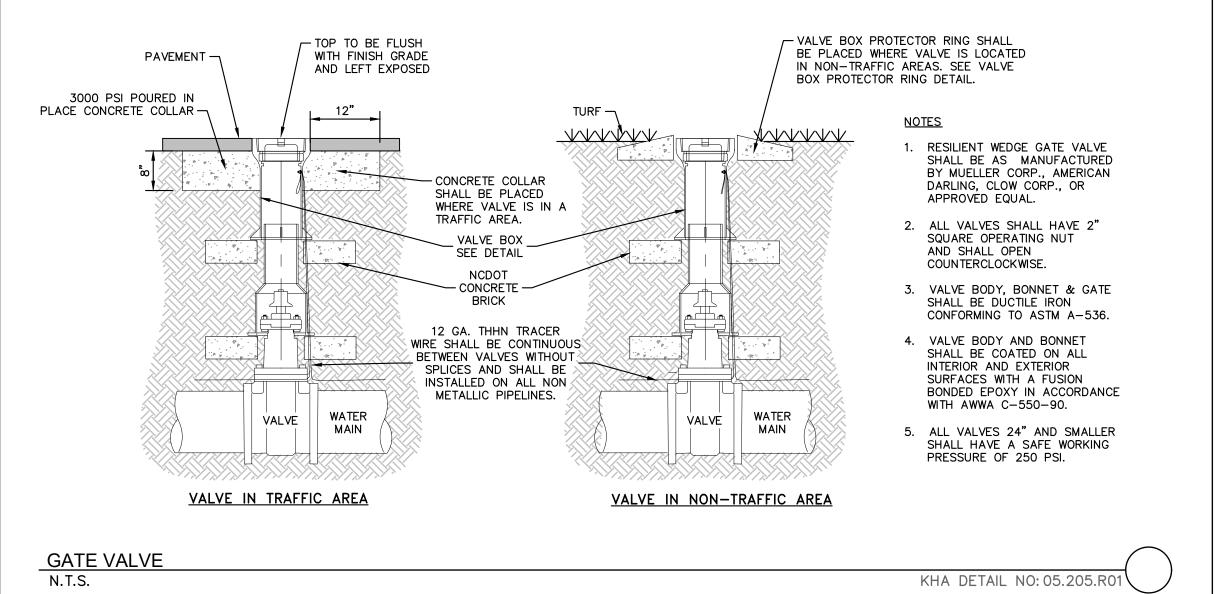
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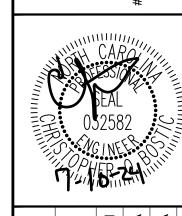






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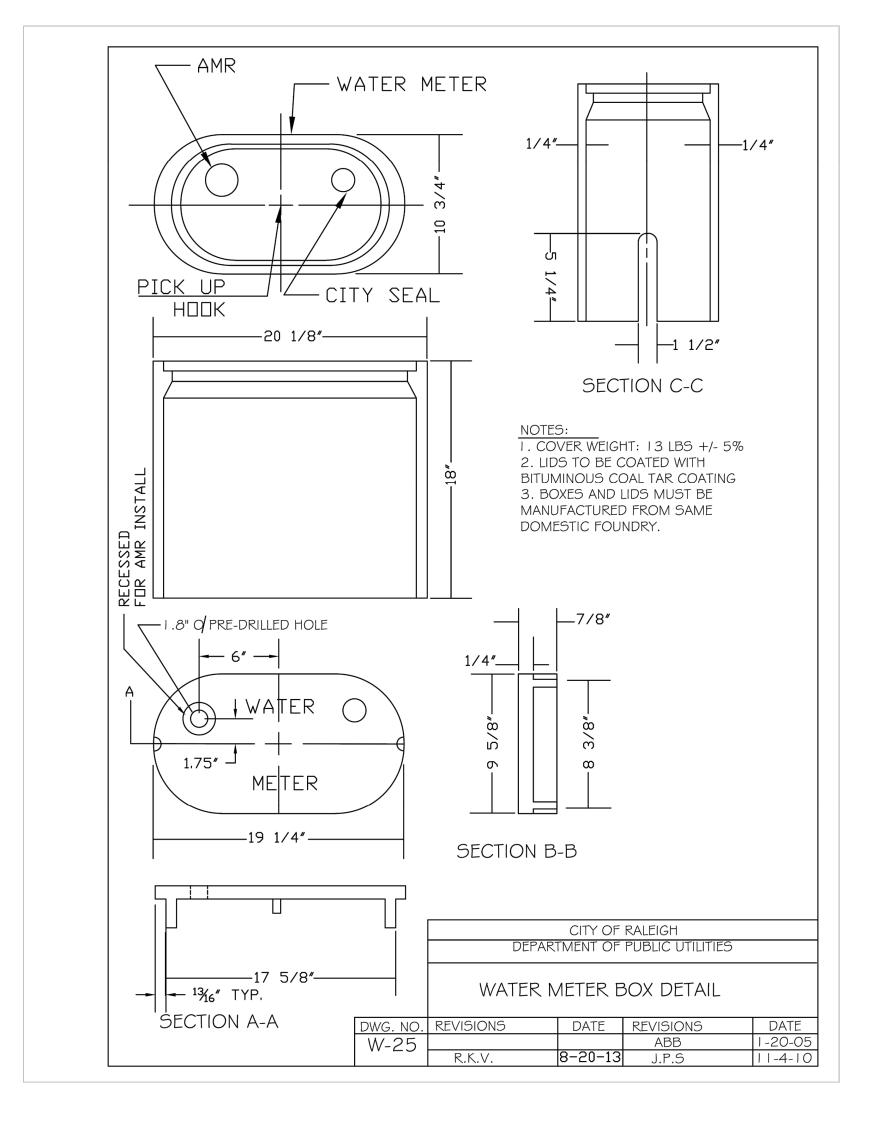



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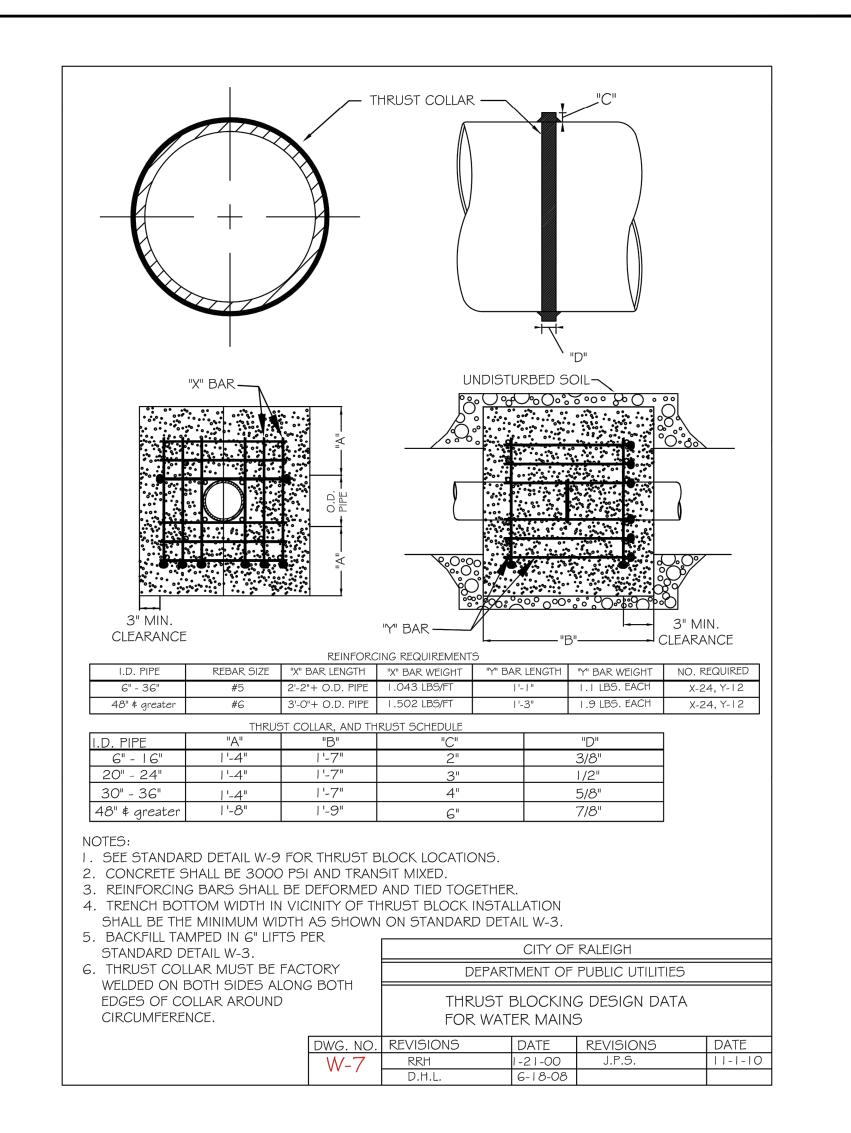
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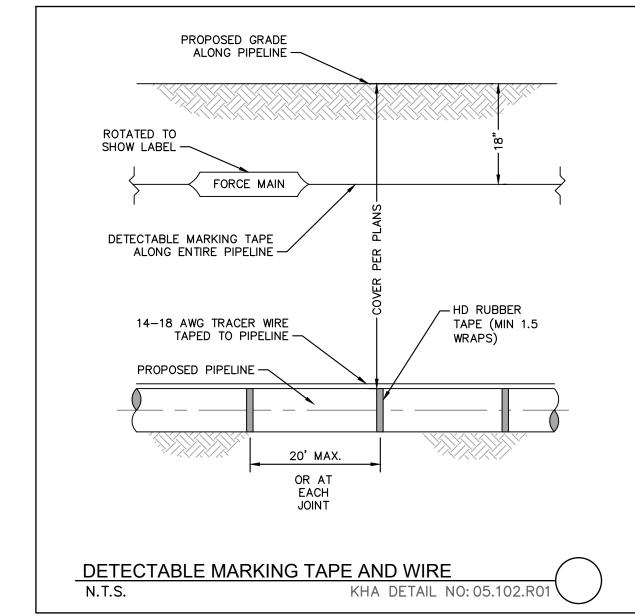
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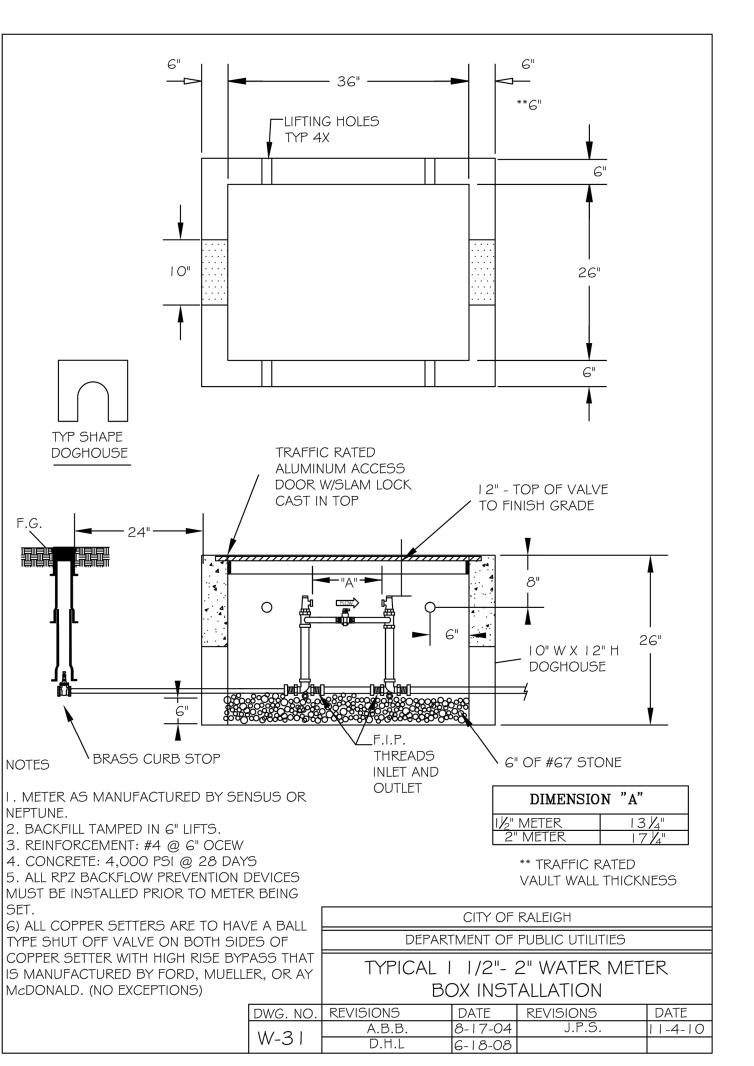
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SHEET NUMBER C11.1

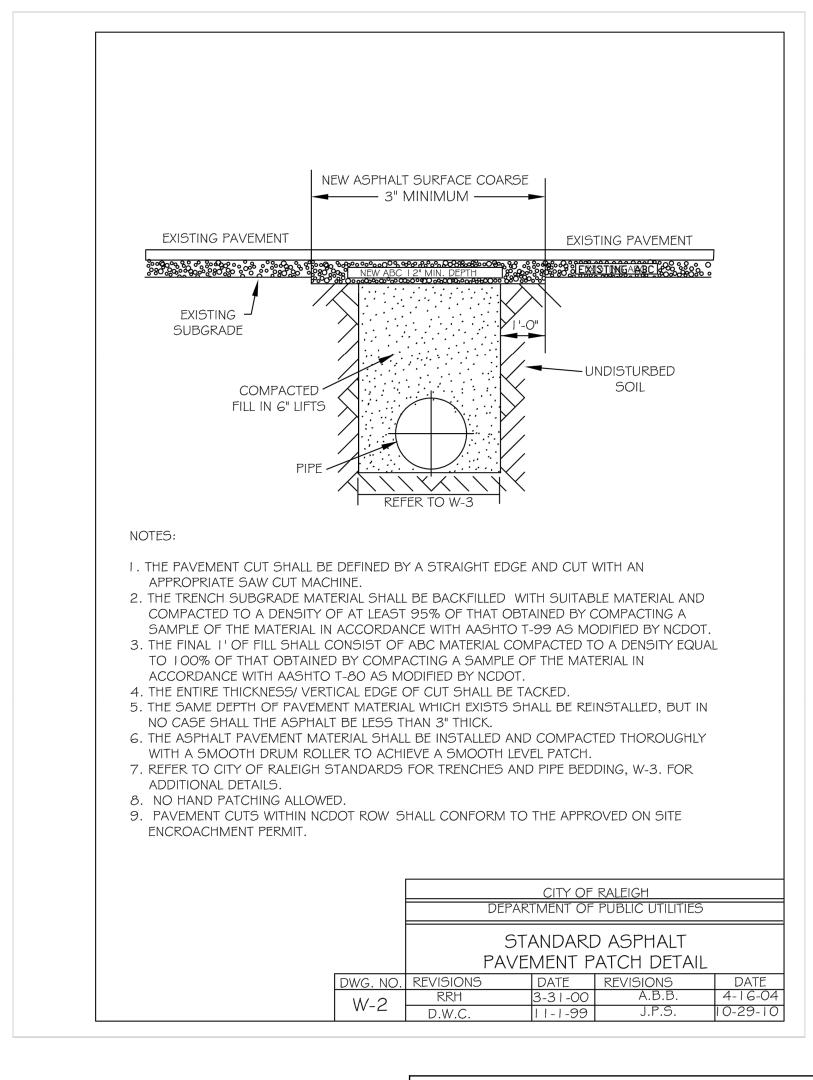SDP-23-09

VED FOR VIERPRISES S&S

WATER

(0) (4) (6) (4)

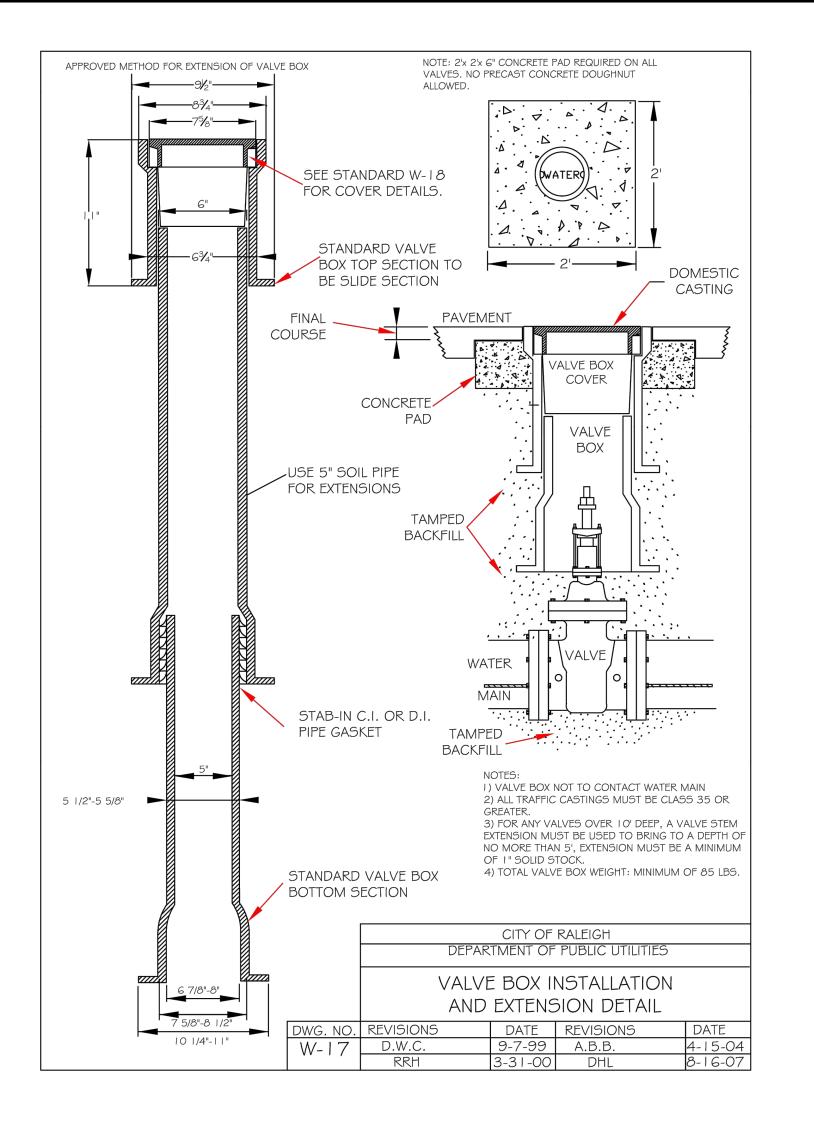LANDSCAPE NOTES:

MULCHLINE

SYMBOL CODE QTY BOTANICAL NAME

SYMBOL CODE QTY BOTANICAL NAME

CORNUS FLORIDA

ACER RUBRUM

ITEA VIRGINICA

MAGNOLIA GRANDIFLORA

LEUCOTHOE FONTANESIANA

RHODODENDRON CATAWBIENSE | MOUNTAIN ROSEBAY

PERIMETER BUFFER TREES

STREET BUFFER TREES

PERIMETER BUFFER SHRUBS

COMMON NAME

RED MAPLE

COMMON NAME

DROOPING LEUCOTHOE 3 GAL

VIRGINIA SWEETSPIRE 3 GAL

FLOWERING DOGWOOD | FG, B&B | 2" CAL. MIN | 8` MIN.

FG, B&B 3" CAL.

HEIGHT

24" HT.

24" HT.

CONT.

3 GAL

10-12` MIN

10-12` MIN

SOUTHERN MAGNOLIA FG, B&B 3" CAL.

- 1. ALL LANDSCAPED AREAS ARE TO RECEIVE A MINIMUM OF 3" OF TOPSOIL. DO NOT MOUND MULCH AGAINST ROOT FLARES.
- 2. ALL PLANT MATERIAL SHALL BE HEALTHY, VIGOROUS, AND FREE OF PESTS AND DISEASE.
- 3. ALL MATERIALS ARE SUBJECT TO THE APPROVAL OF THE LANDSCAPE ARCHITECT BEFORE, DURING, AND AFTER INSTALLATION.
- 4. ALL TREES MUST BE GUYED OR STAKED AS SHOWN IN THE DETAILS.
- 5. ALL PLANTING AREAS SHALL BE COMPLETELY MULCHED AS SPECIFIED.
- 6. ANY DISTURBED GRASS AREA IS TO BE REPLANTED. ALL SLOPES 3:1 OR GREATER SHALL BE SEEDED WITH SLOPE MASTER NO-MOW MIX OR OWNER
- 7. PRIOR TO CONSTRUCTION, THE CONTRACTOR SHALL BE RESPONSIBLE FOR LOCATING ALL UNDERGROUND UTILITIES AND SHALL AVOID DAMAGE TO ALL UTILITIES DURING THE COURSE OF THE WORK. LOCATIONS OF EXISTING BURIED UTILITY LINES SHOWN ON THE PLANS ARE BASED UPON BEST AVAILABLE INFORMATION AND ARE TO BE CONSIDERED APPROXIMATE. IT SHALL BE THE RESPONSIBILITY OF THE CONTRACTOR 1) TO VERIFY THE LOCATIONS OF UTILITY LINES AND ADJACENT TO THE WORK AREA 2) TO PROTECT OF ALL UTILITY LINES DURING THE CONSTRUCTION PERIOD 3) TO REPAIR ANY AND ALL DAMAGE TO UTILITIES, STRUCTURES, SITE APPURTENANCES, ETC. WHICH OCCURS AS A RESULT OF THE CONSTRUCTION.
- 8. THE CONTRACTOR SHALL BE RESPONSIBLE FOR VERIFYING ALL QUANTITIES SHOWN ON THESE PLANS BEFORE PRICING THE WORK.
- 9. CONTRACTOR SHALL BE RESPONSIBLE FOR DELIVERY SCHEDULE AND PROTECTION BETWEEN DELIVERY AND PLANTING TO MAINTAIN HEALTHY PLANT
- 10. THE CONTRACTOR SHALL BE RESPONSIBLE FOR FULLY MAINTAINING (INCLUDING BUT NOT LIMITED TO: WATERING, SPRAYING, MULCHING, FERTILIZING, ETC.) ALL OF THE PLANT MATERIALS AND LAWN FOR THE WARRANTY PERIOD.
- 11. ANY PLANT MATERIAL WHICH IS DISEASED, DISTRESSED, DEAD, OR REJECTED (PRIOR TO SUBSTANTIAL COMPLETION) SHALL BE PROMPTLY REMOVED FROM THE SITE AND REPLACED WITH MATERIAL OF THE SAME SPECIES, QUANTITY, AND SIZE AND MEETING ALL PLANT LIST SPECIFICATIONS.
- 12. THE CONTRACTOR SHALL COMPLETELY GUARANTEE ALL PLANT MATERIAL FOR WARRANTY PERIOD. THE CONTRACTOR SHALL PROMPTLY MAKE ALL REPLACEMENTS DURING THE NORMAL PLANTING SEASON.
- 13. STANDARDS SET FORTH IN "AMERICAN STANDARD FOR NURSERY STOCK" REPRESENT GUIDELINE SPECIFICATIONS ONLY AND SHALL CONSTITUTE MINIMUM QUALITY REQUIREMENTS FOR PLANT MATERIAL.
- 14. ALL LANDSCAPING SHALL BE INSTALLED ACCORDING TO SOUND NURSERY PRACTICES, AND SHALL BE STATE STANDARD OR BETTER
- 15. ALL INVASIVE / EXOTIC SPECIES AND PROHIBITED TREE SPECIES SHALL BE REMOVED FROM SITE, INCLUDING ROOT BALLS TO THE EXTENT POSSIBLE WITH NO DAMAGE TO ADJACENT EXISTING TREES.
- 16. CONTRACTOR TO DESIGN BUILD SYSTEM AND VERIFY ALL PRODUCTS WITH LANDSCAPE ARCHITECT.
- 17. TREE SUPPORT MATERIALS ARE TO BE REMOVED FROM EACH TREE ONCE IT IS "ESTABLISHED" (AS APPROVED BY THE LANDSCAPE ARCHITECT).
- 18. CONTRACTOR SHALL BE RESPONSIBLE FOR ENSURING ALL UTILITIES ARE ADEQUATELY SCREENED WITH THE REQUIRED PLANTING MATERIAL AND
- 19. ALL PLANT SPECIFICATIONS IN THE PLANT SCHEDULE SHALL BE CONSIDERED THE MINIMUM ALLOWABLE SPECIFICATIONS. CONTRACTOR SHALL PROCURE PLANT MATERIALS AND UPSIZE AS NECESSARY TO MEET THE MOST STRINGENT SPECIFICATION.

PERIMETER BUFFER REQUIREMENTS 6.2.2.1					
Type 3 Perimeter Buffer: 136 lf	Required	Provided Provided			
Width	25 feet				
Canopy Trees	4 canopy trees per 100 linear feet = 6 canopy trees	6 Canopy Trees			
Understory Trees	2 understory trees per 100 linear feet = 3 understory trees	3 Understory Trees			
Shrubs	60 shrubs per 100 linear feet = 82 shrubs	83 shrubs			
STREET BUFFER 6.2.2.2					
Street Buffer: 126 lf	Required	Provided			
Width	30 feet	Provided			
Street Tree	1 per 40 linear feet = 4 street trees	4 Street Trees			
PARKING LANDSCAPING 6.2.4.4					
Parking Perimeter	Required	Provided			
Shrubs	Continious row of shrubs within 5 feet of the parking lot edge	Provided			

- 1. ESTABLISH SOD IN ALL DISTURBED AREAS. SEE
- SPECIFICATIONS FOR MORE INFORMATION. 2. ALL AREAS WITH PROPOSED LANDSCAPE MATERIAL SHALL RECEIVE A MINIMUM THREE (3) INCHES OF SHREDDED HARDWOOD MULCH. SEE LANDSCAPE PLAN FOR MULCH BOUNDARY LINES. SEE LANDSCAPE DETAILS FOR TYPICAL MULCH AREA DIMENSIONS.


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ANDSC,

SHEET NUMBER

SDP-23-09



PLUMB/LEVEL IN PLANTING PIT.

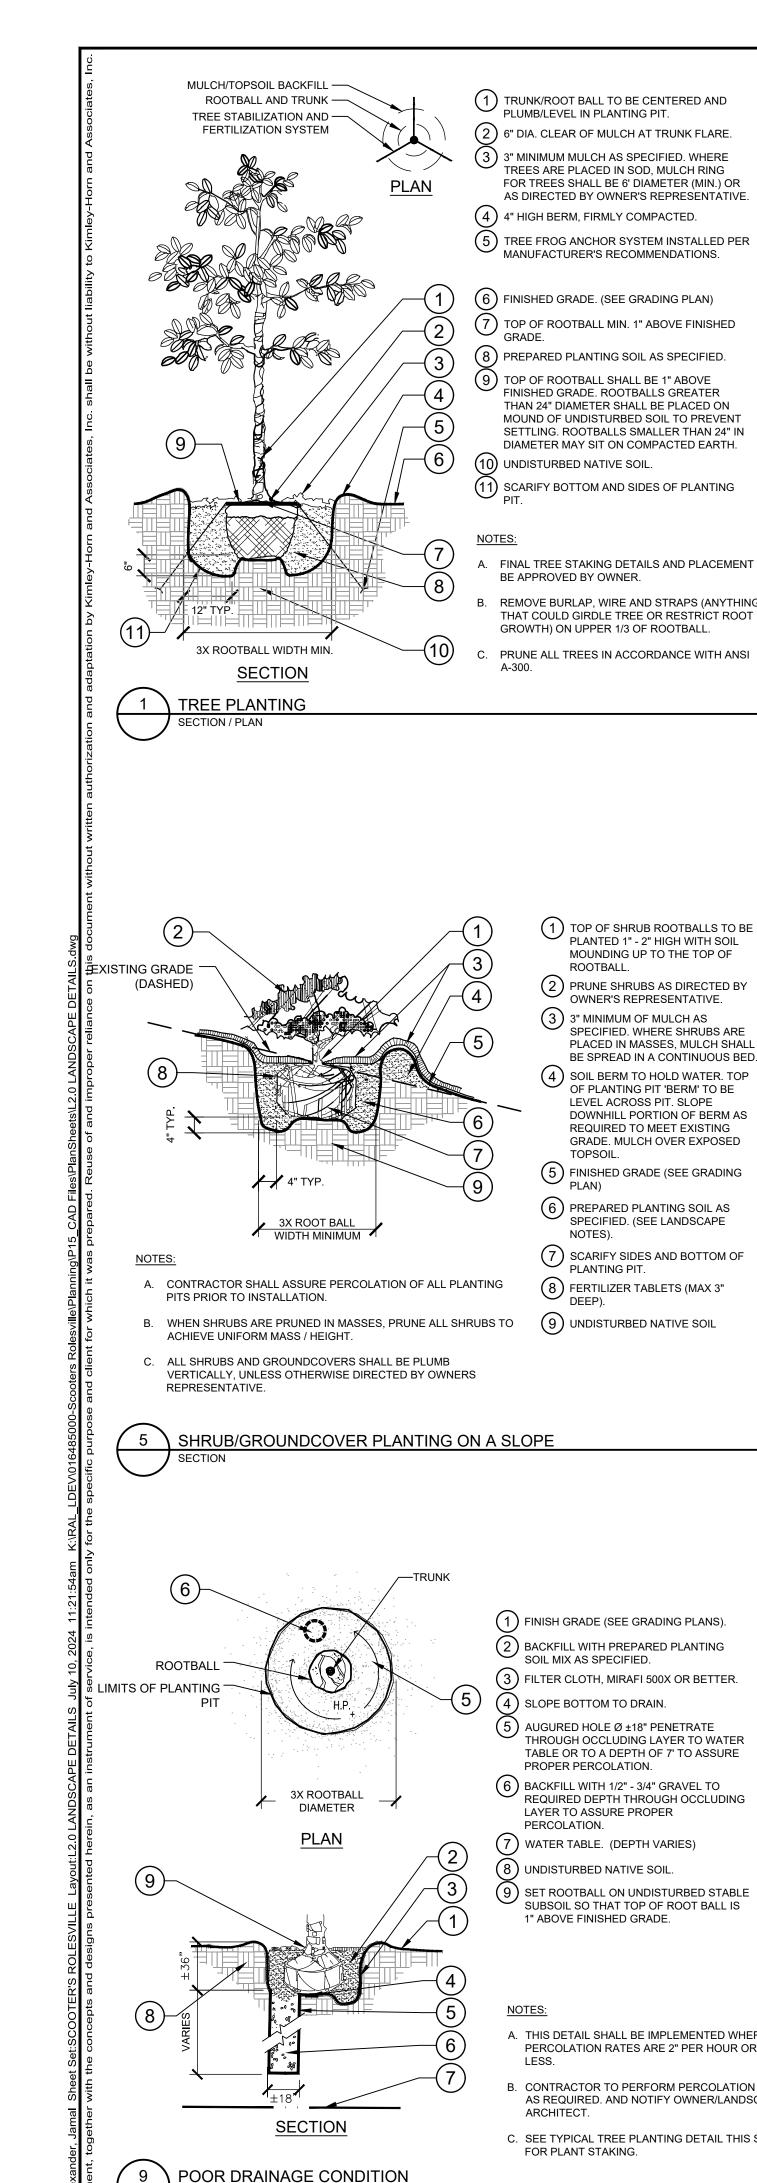TREES ARE PLACED IN SOD, MULCH RING

MANUFACTURER'S RECOMMENDATIONS.

FINISHED GRADE. ROOTBALLS GREATER

THAN 24" DIAMETER SHALL BE PLACED ON

MOUND OF UNDISTURBED SOIL TO PREVENT

SETTLING. ROOTBALLS SMALLER THAN 24" IN

DIAMETER MAY SIT ON COMPACTED EARTH.

FINAL TREE STAKING DETAILS AND PLACEMENT TO

REMOVE BURLAP, WIRE AND STRAPS (ANYTHING

1) TOP OF SHRUB ROOTBALLS TO BE PLANTED 1" - 2" HIGH WITH SOIL

MOUNDING UP TO THE TOP OF

PRUNE SHRUBS AS DIRECTED BY OWNER'S REPRESENTATIVE.

SPECIFIED. WHERE SHRUBS ARE PLACED IN MASSES, MULCH SHALL BE SPREAD IN A CONTINUOUS BED. 4) SOIL BERM TO HOLD WATER. TOP

OF PLANTING PIT 'BERM' TO BE

DOWNHILL PORTION OF BERM AS

LEVEL ACROSS PIT. SLOPE

REQUIRED TO MEET EXISTING

(5) FINISHED GRADE (SEE GRADING

SPECIFIED. (SEE LANDSCAPE

7 SCARIFY SIDES AND BOTTOM OF

8 FERTILIZER TABLETS (MAX 3" DEEP).

9 UNDISTURBED NATIVE SOIL

FINISH GRADE (SEE GRADING PLANS).

(2) BACKFILL WITH PREPARED PLANTING

(5) AUGURED HOLE Ø ±18" PENETRATE

(6) BACKFILL WITH 1/2" - 3/4" GRAVEL TO

LAYER TO ASSURE PROPER

(3) FILTER CLOTH, MIRAFI 500X OR BETTER.

THROUGH OCCLUDING LAYER TO WATER

TABLE OR TO A DEPTH OF 7' TO ASSURE

REQUIRED DEPTH THROUGH OCCLUDING

9) SET ROOTBALL ON UNDISTURBED STABLE

SUBSOIL SO THAT TOP OF ROOT BALL IS

A. THIS DETAIL SHALL BE IMPLEMENTED WHERE

PERCOLATION RATES ARE 2" PER HOUR OR

. CONTRACTOR TO PERFORM PERCOLATION TEST AS REQUIRED. AND NOTIFY OWNER/LANDSCAPE

C. SEE TYPICAL TREE PLANTING DETAIL THIS SHEET

SOIL MIX AS SPECIFIED.

(4) SLOPE BOTTOM TO DRAIN.

PROPER PERCOLATION.

8) UNDISTURBED NATIVE SOIL.

FOR PLANT STAKING.

1" ABOVE FINISHED GRADE.

PERCOLATION.

6 PREPARED PLANTING SOIL AS

GRADE. MULCH OVER EXPOSED

3) 3" MINIMUM OF MULCH AS

ROOTBALL.

TOPSOIL.

PLANTING PIT.


THAT COULD GIRDLE TREE OR RESTRICT ROOT

GROWTH) ON UPPER 1/3 OF ROOTBALL.

BE APPROVED BY OWNER.

FOR TREES SHALL BE 6' DIAMETER (MIN.) OR

AS DIRECTED BY OWNER'S REPRESENTATIVE.

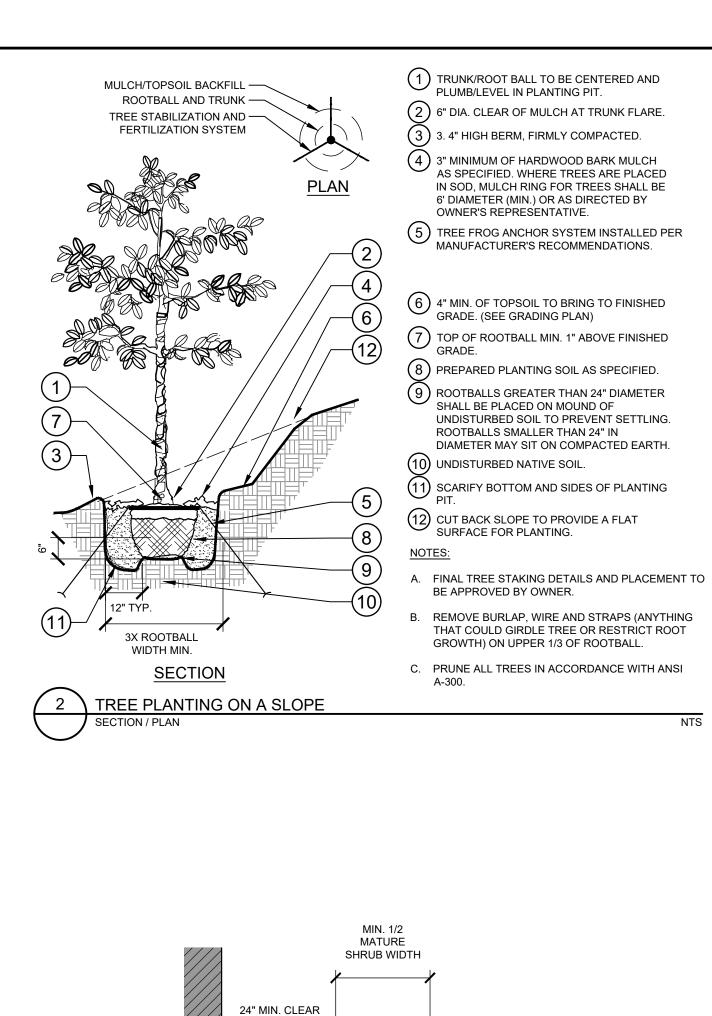

A DEPTH OF 3" (MIN.)

ELEVATION

<u>PLAN</u>

CONNECTION

TREE PROTECTION FENCING

PLANTINGS ADJACENT TO BUILDINGS

PLUMB/LEVEL IN PLANTING PIT.

OWNER'S REPRESENTATIVE.

GRADE. (SEE GRADING PLAN)

SHALL BE PLACED ON MOUND OF

ROOTBALLS SMALLER THAN 24" IN

SURFACE FOR PLANTING.

BE APPROVED BY OWNER.

(1) 6'H "PERIMETER PLUS" CONSTRUCTION FENCE BY CONWED PLASTICS OR OWNER'S

REPRESENTATIVE APPROVED EQUAL.

SUBMIT PRODUCT INFORMATION FOR

2) 8' TALL METAL "T" POSTS OR 2" x 2" X 8' PRESSURE TREATED WOOD POSTS WITH 24"

A. POST SELECTION SHOULD BE BASED ON EXPECTED

CONSTRUCTION AND OTHER APPLICATIONS.

C. SPACE POSTS EVERY 6' (MIN.) TO 8' (MAX.).

PROTECTION BETWEEN TIES AND POSTS.

NOTE: IF WIRE TIES ARE USED, AVOID DIRECT CONTACT WITH FENCE. WIRE MAY DAMAGE FENCE OVER TIME.

STRENGTH NEEDS AND THE LENGTH OF TIME FENCE WILL

CROWD CONTROL INSTALLATIONS. METAL "T" POSTS OR

BE IN PLACE. FLEXIBLE FIBERGLASS ROD POSTS ARE

RECOMMENDED FOR PARKS, ATHLETIC EVENTS AND

TREATED WOOD POSTS ARE TYPICALLY USED FOR

B. POSTS SHOULD BE DRIVEN INTO THE GROUND TO A DEPTH

D. SECURE FENCING TO POST WITH NYLON CABLE TIES (AVAILABLE FROM CONWED PLASTICS). WOOD STRIPS MAY

BE ALSO BE USED TO PROVIDE ADDITIONAL SUPPORT AND

OF 1/3 OF THE HEIGHT OF THE POST. FOR EXAMPLE, A 6' POST SHOULD BE SET AT LEAST 2' INTO THE GROUND.

APPROVAL PRIOR TO INSTALLATION.

BURIAL BELOW GRADE.

INSTALLATION NOTES:

UNDISTURBED SOIL TO PREVENT SETTLING.

DIAMETER MAY SIT ON COMPACTED EARTH.

REMOVE BURLAP, WIRE AND STRAPS (ANYTHING

THAT COULD GIRDLE TREE OR RESTRICT ROOT

GROWTH) ON UPPER 1/3 OF ROOTBALL.


.) 3" MINIMUM OF HARDWOOD BARK MULCH

6' DIAMETER (MIN.) OR AS DIRECTED BY

MANUFACTURER'S RECOMMENDATIONS.

AS SPECIFIED. WHERE TREES ARE PLACED

IN SOD, MULCH RING FOR TREES SHALL BE

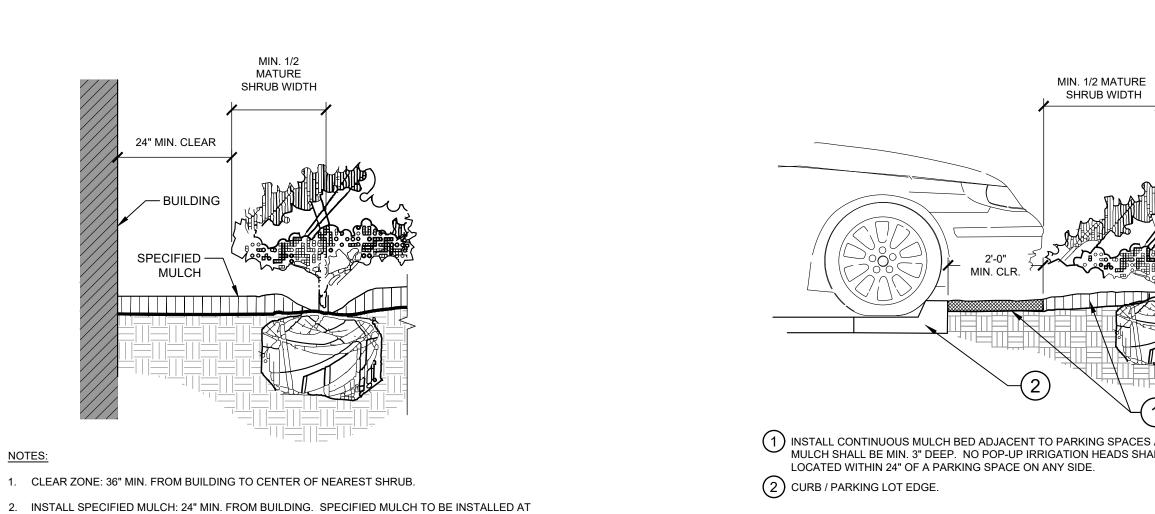

BEST FACE OF SHRUB/

REFER TO PLANT

AT BED EDGE.

3X ROOT BALL WIDTH

MINIMUM

SHRUB/GROUNDCOVER PLANTING

REPRESENTATIVE.

A. CONTRACTOR SHALL ASSURE PERCOLATION OF ALL PLANTING PITS PRIOR TO INSTALLATION.

B. WHEN SHRUBS ARE PRUNED IN MASSES, PRUNE ALL SHRUBS TO ACHIEVE UNIFORM MASS / HEIGHT


C. ALL SHRUBS AND GROUNDCOVERS SHALL BE PLUMB VERTICALLY, UNLESS OTHERWISE DIRECTED BY OWNERS


GROUNDCOVER TO FACE


FRONT OF PLANTING BED.

SCHEDULE FOR SPACING.

MAINTAIN 12" DEAD ZONE

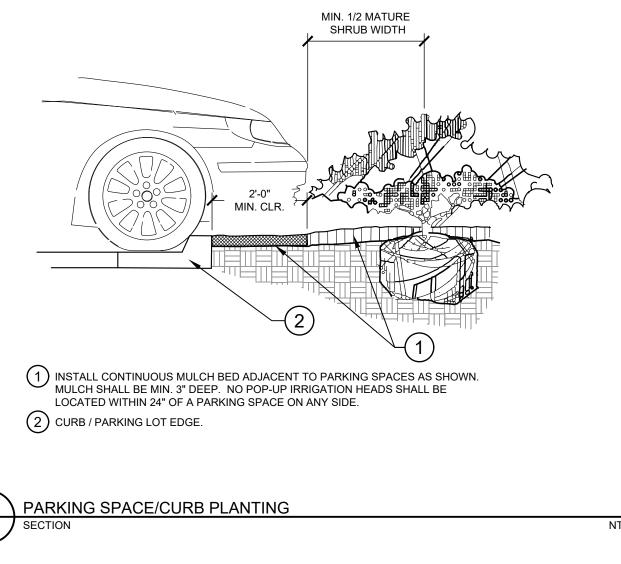

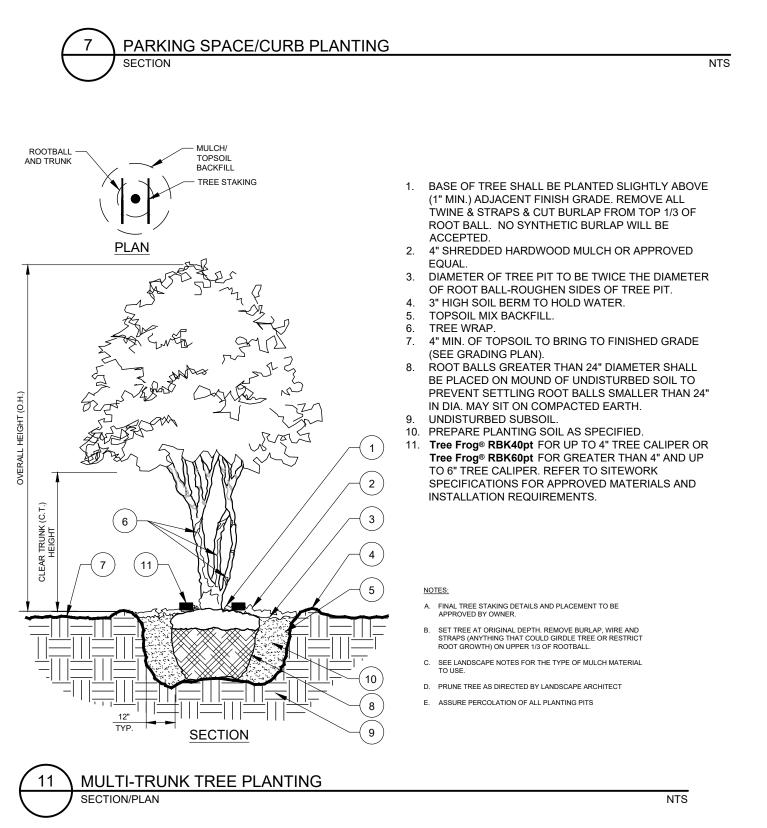

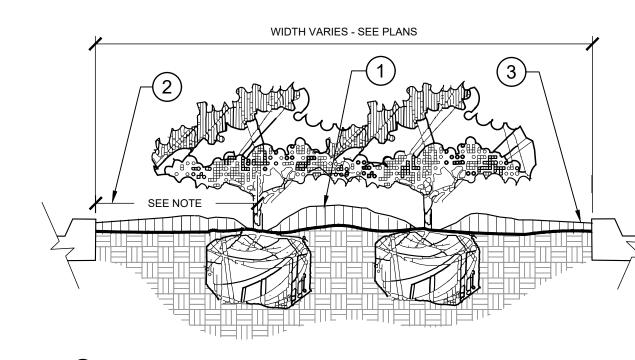

(1) CROWN ISLANDS @ 5:1 SLOPES (OR AS SPECIFIED ON THE LANDSCAPE PLANS).

2) CLEAR ZONE: 36" MIN. FROM BACK OF CURB TO CENTER OF NEAREST SHRUB. CLEAR ZONE SHALL CONTAIN 3" CONTINUOUS MULCH OR TURF, SEE PLANS. (3) 2" MIN VERTICAL CLEARANCE, TOP OF CURB TO TOP OF MULCH.

1) TOP OF SHRUB ROOTBALLS TO

OF ROOTBALL.

MASS/HEIGHT.

(3) 3" MULCH LAYER AS

(4) EXCAVATE ENTIRE BED

5 FINISHED GRADE (SEE GRADING PLAN).

MIX AS SPECIFIED.

(7) SCARIFY OF PLANTING PIT

(9) UNDISTURBED NATIVE SOIL.

(10) FERTILIZER TABLETS (MAX 3"

SIDES AND BOTTOM.

(8) 4" HIGH BERM FIRMLY

COMPACTED.

(6) PREPARED PLANTING SOIL AS

SPECIFIED. (SEE LANDSCAPE NOTES) NOTE: WHEN GROUND-

COVERS AND SHRUBS USED IN

AMENDED WITH PLANTING SOIL

MASSES, ENTIRE BED TO BE

SPECIFIED.

2) PRUNE ALL SHRUBS TO


ACHIEVE A UNIFORM


BE PLANTED 1" - 2" HIGH WITH


SOIL MOUNDING UP TO THE TOP

SPECIFIED FOR GROUNDCOVER

- A. EXCAVATE A CONTINUOUS 24" DEEP PIT (FROM TOP OF CURB) FOR ENTIRE LENGTH AND WIDTH OF ISLAND & BACKFILL WITH APPROVED PLANTING MIX.
- B. PROTECT AND RETAIN ALL CURBS AND BASE. COMPACTED SUBGRADE TO REMAIN FOR STRUCTURAL SUPPORT OF CURB SYSTEM (TYP).
- C. ALL ISLANDS SHALL UTILIZE POOR DRAINAGE DETAIL WHEN PERCOLATION RATES ARE 2" PER HOUR

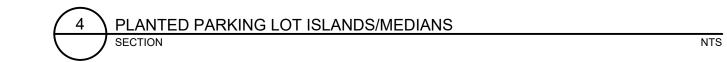

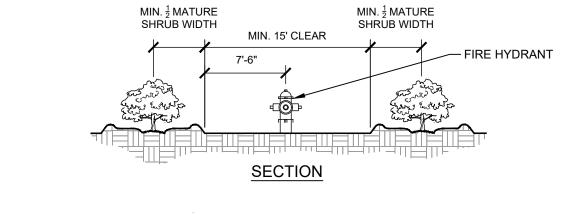

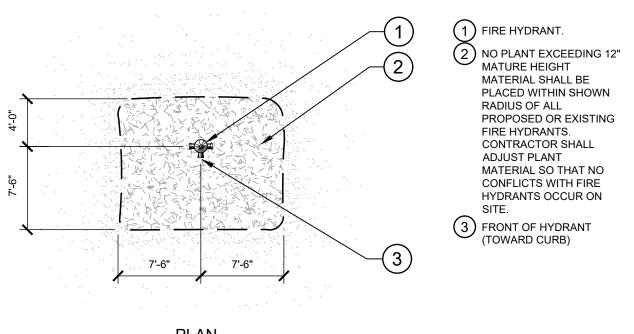

SHRUB PLANTING AT FIRE HYDRANT

Know what's below. Call before you dig.

66466

SDP-23-09

SHEET NUMBER

GENERAL LANDSCAPE SPECIFICATIONS AND NOTES

A. SCOPE OF WORK

- 1. THE WORK CONSISTS OF: FURNISHING ALL LABOR, MATERIALS, EQUIPMENT, TOOLS, TRANSPORTATION, AND ANY OTHER APPURTENANCES NECESSARY FOR THE COMPLETION OF THIS PROJECT AS SHOWN ON THE DRAWINGS, AS INCLUDED IN THE PLANT LIST, AND AS SPECIFIED
- 2. WORK SHALL INCLUDE MAINTENANCE AND WATERING OF ALL CONTRACT PLANTING AREAS UNTIL CERTIFICATION OF ACCEPTANCE BY THE

B. PROTECTION OF EXISTING STRUCTURES

- I. ALL EXISTING BUILDINGS, WALKS, WALLS, PAVING, PIPING, OTHER SITE CONSTRUCTION ITEMS, AND PLANTING ALREADY COMPLETED OR ESTABLISHED AND DESIGNATED TO REMAIN SHALL BE PROTECTED FROM DAMAGE BY THE CONTRACTOR UNLESS OTHERWISE SPECIFIED. ALL DAMAGE RESULTING FROM NEGLIGENCE SHALL BE REPAIRED OR REPLACED TO THE SATISFACTION OF THE OWNER, AT NO COST TO THE OWNER.
- THE CONTRACTOR SHALL BE RESPONSIBLE FOR MAINTAINING ALL NECESSARY BMP DEVICES ACCORDING TO ALL REGULATORY AGENCY'S STANDARDS THROUGH THE DURATION OF ALL CONSTRUCTION ACTIVITIES.
- THE CONTRACTOR SHALL SUBMIT A DETAILED PROJECT SPECIFIC WORK ZONE TRAFFIC CONTROL PLAN UNLESS THE WORK REQUIRES NOTHING MORE THAN A DIRECT APPLICATION OF DOT DESIGN STANDARDS, INDEX 600. IF A DIRECT APPLICATION OF INDEX 600 IS PROPOSED, THE CONTRACTOR SHALL SUBMIT IN WRITING A STATEMENT INDICATING THE STANDARD INDEX AND PAGE NUMBER NO LESS THAN 10 BUSINESS DAYS PRIOR TO START OF CONSTRUCTION. WHEN A DIRECT APPLICATION OF DOT STANDARD INDEX 600 IS NOT ACCEPTABLE A PROJECT SPECIFIC WORK ZONE TRAFFIC CONTROL PLAN SHALL BE PREPARED BY A PROFESSIONAL ENGINEER WHO HAS SUCCESSFULLY COMPLETED ADVANCED TRAINING IN MAINTENANCE OF TRAFFIC, AS DEFINED BY DOT FOR APPROVAL BY THE COUNTY ENGINEER'S REPRESENTATIVE.
- 4. THE CONTRACTOR SHALL BE RESPONSIBLE FOR LOCATING ALL UTILITIES, WHETHER PUBLIC OR PRIVATE, PRIOR TO EXCAVATION. THE INFORMATION AND DATA SHOWN WITH RESPECT TO EXISTING UNDERGROUND FACILITIES AT OR CONTIGUOUS TO THE SITE IS APPROXIMATE AND BASED ON INFORMATION FURNISHED BY THE OWNER OF SUCH UNDERGROUND FACILITIES OR ON PHYSICAL APPURTENANCES OBSERVED IN THE FIELD. THE OWNER AND DESIGN PROFESSIONAL SHALL NOT BE RESPONSIBLE FOR THE ACCURACY AND COMPLETENESS OF ANY SUCH INFORMATION OR DATA. THE CONTRACTOR SHALL HAVE FULL RESPONSIBILITY FOR; REVIEWING AND CHECKING ALL SUCH INFORMATION AND DATA; LOCATING ALL UNDERGROUND FACILITIES DURING CONSTRUCTION; THE SAFETY AND PROTECTION THEREOF; REPAIRING ANY DAMAGE THERETO RESULTING FROM THE WORK. THE COST OF ALL WILL BE CONSIDERED AS HAVING BEEN INCLUDED IN THE CONTRACT PRICE. THE CONTRACTOR SHALL NOTIFY ANY AFFECTED UTILITY COMPANIES OR AGENCIES IN WRITING AT LEAST 48 HOURS PRIOR TO BEGINNING CONSTRUCTION

C. PROTECTION OF EXISTING PLANT MATERIALS

THE CONTRACTOR SHALL BE RESPONSIBLE FOR ALL UNAUTHORIZED CUTTING OR DAMAGE TO TREES AND SHRUBS EXISTING OR OTHERWISE, CAUSED BY CARELESS EQUIPMENT OPERATION, MATERIAL STOCKPILING, ETC... THIS SHALL INCLUDE COMPACTION BY DRIVING OR PARKING INSIDE THE DRIP-LINE AND SPILLING OIL, GASOLINE, OR OTHER DELETERIOUS MATERIALS WITHIN THE DRIP-LINE. NO MATERIALS SHALL BE BURNED ON SITE. EXISTING TREES KILLED OR DAMAGED SO THAT THEY ARE MISSHAPEN AND/OR UNSIGHTLY SHALL BE REPLACED AT THE COST TO THE CONTRACTOR OF THREE HUNDRED DOLLARS (\$300) PER CALIPER INCH ON AN ESCALATING SCALE WHICH ADDS AN ADDITIONAL TWENTY (20) PERCENT PER INCH OVER FOUR (4) INCHES CALIPER AS FIXED AND AGREED LIQUIDATED DAMAGES. CALIPER SHALL BE MEASURED SIX (6) INCHES ABOVE GROUND LEVEL FOR TREES UP TO AND INCLUDING FOUR (4) INCHES IN CALIPER AND TWELVE (12) INCHES ABOVE GROUND LEVEL FOR TREES OVER FOUR (4) INCHES IN CALIPER.

2. SEE TREE MITIGATION PLAN AND NOTES, IF APPLICABLE.

D. MATERIALS

1. GENERAL

MATERIAL SAMPLES LISTED BELOW SHALL BE SUBMITTED FOR APPROVAL, ON SITE OR AS DETERMINED BY THE OWNER. UPON APPROVAL DELIVERY OF MATERIALS MAY COMMENCE.

MATERIAL SAMPLE SIZE

MULCH ONE (1) CUBIC FOOT

TOPSOIL MIX ONE (1) CUBIC FOOT

PLANTS ONE (1) OF EACH VARIETY (OR TAGGED IN NURSERY)

2. PLANT MATERIALS

- a. PLANT SPECIES AND SIZE SHALL CONFORM TO THOSE INDICATED ON THE DRAWINGS. ALL PLANTS SHALL BE DETERMINED BY THE STATE DIVISION OF PLANT INDUSTRY. ALL PLANTS SHALL BE HEALTHY, VIGOROUS, SOUND, WELL-BRANCHED, AND FREE OF DISEASE AND INSECTS, INSECT EGGS AND LARVAE AND SHALL HAVE ADEQUATE ROOT SYSTEMS. TREES FOR PLANTING IN ROWS SHALL BE UNIFORM IN SIZE AND SHAPE. ALL MATERIALS SHALL BE SUBJECT TO APPROVAL BY THE OWNER. WHERE ANY REQUIREMENTS ARE OMITTED FROM THE PLANT LIST, THE PLANTS FURNISHED SHALL BE NORMAL FOR THE VARIETY. PLANTS SHALL BE PRUNED PRIOR TO DELIVERY ONLY WITH APPROVAL FROM OWNER OR OWNER'S REPRESENTATIVE. NO SUBSTITUTIONS SHALL BE MADE WITHOUT WRITTEN PERMISSION FROM THE OWNER'S REPRESENTATIVE
- b. MEASUREMENTS: THE HEIGHT AND/OR WIDTH OF TREES SHALL BE MEASURED FROM THE GROUND OR ACROSS THE NORMAL SPREAD OF BRANCHES WITH THE PLANTS IN THEIR NORMAL POSITION. THIS MEASUREMENT SHALL NOT INCLUDE THE IMMEDIATE TERMINAL GROWTH. PLANTS LARGER IN SIZE THAN THOSE SPECIFIED IN THE PLANT LIST MAY BE USED IF APPROVED BY THE OWNER. IF THE USE OF LARGER PLANTS IS APPROVED, THE BALL OF EARTH OR SPREAD OF ROOTS SHALL BE INCREASED IN PROPORTION TO THE SIZE OF THE PLANT.
- c. INSPECTION: PLANTS SHALL BE SUBJECT TO INSPECTION AND APPROVAL AT THE PLACE OF GROWTH, OR UPON DELIVERY TO THE SITE, AS DETERMINED BY THE OWNER, FOR QUALITY, SIZE, AND VARIETY. SUCH APPROVAL SHALL NOT IMPAIR THE RIGHT OF INSPECTION AND REJECTION AT THE SITE DURING PROGRESS OF THE WORK OR AFTER COMPLETION FOR SIZE AND CONDITION OF ROOT BALLS OR ROOTS, LATENT DEFECTS OR INJURIES. REJECTED PLANTS SHALL BE REMOVED IMMEDIATELY FROM THE SITE. NOTICE REQUESTING INSPECTION SHALL BE SUBMITTED IN WRITING BY THE CONTRACTOR AT LEAST ONE (1) WEEK PRIOR TO ANTICIPATED DATE.

E. SOIL MIXTURE (PLANTING MEDIUM, PLANTING MIX, TOPSOIL MIX)

- 1. CONTRACTOR SHALL TEST EXISTING SOIL AND AMEND AS NECESSARY IN ACCORDANCE WITH THE GUIDELINES BELOW:
- 2. SOIL MIXTURE (PLANTING MEDIUM FOR PLANT PITS) SHALL CONSIST OF TWO PARTS OF TOPSOIL AND ONE PART SAND, AS DESCRIBED BELOW. CONTRACTOR TO SUBMIT SAMPLES AND PH TESTING RESULTS OF SOIL MIXTURE FOR OWNER'S REPRESENTATIVE APPROVAL PRIOR TO PLANT INSTALLATION OPERATIONS COMMENCE.
- a. TOPSOIL FOR USE IN PREPARING SOIL MIXTURE FOR BACKFILLING PLANT PITS SHALL BE FERTILE, FRIABLE, AND OF A LOAMY CHARACTER; REASONABLY FREE OF SUBSOIL, CLAY LUMPS, BRUSH WEEDS AND OTHER LITTER; FREE OF ROOTS, STUMPS, STONES LARGER THAN 2" IN ANY DIRECTION, AND OTHER EXTRANEOUS OR TOXIC MATTER HARMFUL TO PLANT GROWTH. IT SHALL CONTAIN THREE (3) TO FIVE (5) PERCENT DECOMPOSED ORGANIC MATTER AND HAVE A PH BETWEEN 5.5 AND 7.0.
- b. <u>SAND</u> SHALL BE COARSE, CLEAN, WELL-DRAINING, NATIVE SAND.
- 2. TREES SHALL BE PLANTED IN THE EXISTING NATIVE SOIL ON SITE, UNLESS DETERMINED TO BE UNSUITABLE AT WHICH POINT THE CONTRACTOR SHALL CONTACT OWNER'S REPRESENTATIVE TO DISCUSS ALTERNATE RECOMMENDATION PRIOR TO PLANTING.

F. WATE

1. WATER NECESSARY FOR PLANTING AND MAINTENANCE SHALL BE OF SATISFACTORY QUALITY TO SUSTAIN ADEQUATE PLANT GROWTH AND SHALL NOT CONTAIN HARMFUL, NATURAL OR MAN-MADE ELEMENTS DETRIMENTAL TO PLANTS. WATER MEETING THE ABOVE STANDARD SHALL BE OBTAINED ON THE SITE FROM THE OWNER, IF AVAILABLE, AND THE CONTRACTOR SHALL BE RESPONSIBLE TO MAKE ARRANGEMENTS FOR ITS USE BY HIS TANKS, HOSES, SPRINKLERS, ETC.... IF SUCH WATER IS NOT AVAILABLE AT THE SITE, THE CONTRACTOR SHALL PROVIDE SATISFACTORY WATER FROM SOURCES OFF THE SITE AT NO ADDITIONAL COST TO THE OWNER.

* WATERING/IRRIGATION RESTRICTIONS MAY APPLY - REFER TO PROPERTY'S JURISDICTIONAL AUTHORITY.

G. FERTILIZER

CONTRACTOR SHALL PROVIDE FERTILIZER APPLICATION SCHEDULE TO OWNER, AS APPLICABLE TO SOIL TYPE, PLANT INSTALLATION TYPE, AND SITE'S PROPOSED USE. SUGGESTED FERTILIZER TYPES SHALL BE ORGANIC OR OTHERWISE NATURALLY-DERIVED.

* FERTILIZER RESTRICTIONS MAY APPLY - REFER TO PROPERTY'S JURISDICTIONAL AUTHORITY.

H. MULCH

- MULCH MATERIAL SHALL BE MOISTENED AT THE TIME OF APPLICATION TO PREVENT WIND DISPLACEMENT, AND APPLIED AT A DEPTH OF THREE (3) INCHES. CLEAR MULCH FROM EACH PLANT'S CROWN (BASE). MULCH SHALL BE "FLORIMULCH," EUCALYPTUS MULCH, OR SIMILAR SUSTAINABLY HARVESTED MULCH UNLESS SPECIFIED OTHERWISE.
- 2. PROVIDE A THREE (3) INCH MINIMUM LAYER OF SPECIFIED MULCH OVER THE ENTIRE AREA OF EACH SHRUB BED, GROUND COVER, VINE BED, AND TREE PIT (6' MINIMUM) PLANTED UNDER THIS CONTRACT.

I. DIGGING AND HANDLING

- 1. PROTECT ROOTS OR ROOT BALLS OF PLANTS AT ALL TIMES FROM SUN, DRYING WINDS, WATER AND FREEZING, AS NECESSARY UNTIL PLANTING. PLANT MATERIALS SHALL BE ADEQUATELY PACKED TO PREVENT DAMAGE DURING TRANSIT. TREES TRANSPORTED MORE THAN TEN (10) MILES OR WHICH ARE NOT PLANTED WITHIN THREE (3) DAYS OF DELIVERY TO THE SITE SHALL BE SPRAYED WITH AN ANTITRANSPIRANT PRODUCT ("WILTPRUF" OR EQUAL) TO MINIMIZE TRANSPIRATIONAL WATER LOSS.
- 2. BALLED AND BURLAPPED (B&B), AND FIELD GROWN (FG) PLANTS SHALL BE DUG WITH FIRM, NATURAL BALLS OF SOIL OF SUFFICIENT SIZE TO ENCOMPASS THE FIBROUS AND FEEDING ROOTS OF THE PLANTS. NO PLANTS MOVED WITH A ROOT BALL SHALL BE PLANTED IF THE BALL IS

CRACKED OR BROKEN. PLANTS SHALL NOT BE HANDLED BY STEMS.

- 3. PLANTS MARKED "BR" IN THE PLANT LIST SHALL BE DUG WITH BARE ROOTS. CARE SHALL BE EXERCISED THAT THE ROOTS DO NOT DRY OUT DURING TRANSPORTATION AND PRIOR TO PLANTING.
- 4. PROTECTION OF PALMS: ONLY A MINIMUM OF FRONDS SHALL BE REMOVED FROM THE CROWN OF THE PALM TREES TO FACILITATE MOVING AND HANDLING. CLEAR TRUNK (CT) SHALL BE AS SPECIFIED AFTER THE MINIMUM OF FRONDS HAVE BEEN REMOVED. ALL PALMS SHALL BE BRACED PER PALM PLANTING DETAIL.
- EXCAVATION OF TREE PITS SHALL BE PERFORMED USING EXTREME CARE TO AVOID DAMAGE TO SURFACE AND SUBSURFACE ELEMENTS SUCH AS UTILITIES OR HARDSCAPE ELEMENTS, FOOTERS AND PREPARED SUB-BASES.

CONTAINER GROWN STOCK

- 1. ALL CONTAINER GROWN MATERIAL SHALL BE HEALTHY, VIGOROUS, WELL-ROOTED PLANTS ESTABLISHED IN THE CONTAINER IN WHICH THEY ARE SOLD. THE PLANTS SHALL HAVE TOPS WHICH ARE OF GOOD QUALITY AND ARE IN A HEALTHY GROWING CONDITION.
- AN ESTABLISHED CONTAINER GROWN PLANT SHALL BE TRANSPLANTED INTO A CONTAINER AND GROWN IN THAT CONTAINER SUFFICIENTLY LONG ENOUGH FOR THE NEW FIBROUS ROOTS TO HAVE DEVELOPED SO THAT THE ROOT MASS WILL RETAIN ITS SHAPE AND HOLD TOGETHER WHEN REMOVED FROM THE CONTAINER. CONTAINER GROWN STOCK SHALL NOT BE HANDLED BY THEIR STEMS.
- 3. ROOT BOUND PLANTS ARE NOT ACCEPTABLE AND WILL BE REJECTED.
- 4. RPG= "ROOTS PLUS GROWER" CONTAINER PRODUCTS SHALL BE USED WHERE SPECIFIED.

. COLLECTED STOCK

WHEN THE USE OF COLLECTED STOCK IS PERMITTED AS INDICATED BY THE OWNER OR OWNER'S REPRESENTATIVE, THE MINIMUM SIZES OF ROOTBALLS SHALL BE EQUAL TO THAT SPECIFIED FOR THE NEXT LARGER SIZE OF NURSERY GROWN STOCK OF THE SAME VARIETY.

L. NATIVE STOCK

PLANTS COLLECTED FROM WILD OR NATIVE STANDS SHALL BE CONSIDERED NURSERY GROWN WHEN THEY HAVE BEEN SUCCESSFULLY RE-ESTABLISHED IN A NURSERY ROW AND GROWN UNDER REGULAR NURSERY CULTURAL PRACTICES FOR A MINIMUM OF TWO (2) GROWING SEASONS AND HAVE ATTAINED ADEQUATE ROOT AND TOP GROWTH TO INDICATE FULL RECOVERY FROM TRANSPLANTING INTO THE NURSERY ROW.

M. MATERIALS LIST

QUANTITIES NECESSARY TO COMPLETE THE WORK ON THE DRAWINGS SHALL BE FURNISHED BY THE CONTRACTOR. QUANTITY ESTIMATES HAVE BEEN MADE CAREFULLY, BUT THE LANDSCAPE ARCHITECT OR OWNER ASSUMES NO LIABILITY FOR OMISSIONS OR ERRORS. SHOULD A DISCREPANCY OCCUR BETWEEN THE PLANS AND THE PLANT LIST QUANTITY, THE OWNER'S REPRESENTATIVE SHALL BE NOTIFIED FOR CLARIFICATION PRIOR TO BIDDING OR INSTALLATION. ALL DIMENSIONS AND/OR SIZES SPECIFIED SHALL BE THE MINIMUM ACCEPTABLE SIZE.

N. FINE GRADIN

- FINE GRADING UNDER THIS CONTRACT SHALL CONSIST OF FINAL FINISHED GRADING OF LAWN AND PLANTING AREAS THAT HAVE BEEN ROUGH GRADED BY OTHERS. BERMING AS SHOWN ON THE DRAWINGS SHALL BE THE RESPONSIBILITY OF THE CONTRACTOR, UNLESS OTHERWISE NOTED.
- THE CONTRACTOR SHALL FINE GRADE THE LAWN AND PLANTING AREAS TO BRING THE ROUGH GRADE UP TO FINAL FINISHED GRADE ALLOWING FOR THICKNESS OF SOD AND/OR MULCH DEPTH. CONTRACTOR SHALL FINE GRADE BY HAND AND/OR WITH ALL EQUIPMENT NECESSARY

INCLUDING A GRADING TRACTOR WITH FRONT-END LOADER FOR TRANSPORTING SOIL WITHIN THE SITE

3. ALL PLANTING AREAS SHALL BE GRADED AND MAINTAINED FOR POSITIVE DRAINAGE TO SURFACE/SUBSURFACE STORM DRAIN SYSTEMS. AREAS ADJACENT TO BUILDINGS SHALL SLOPE AWAY FROM THE BUILDINGS. REFER TO CIVIL ENGINEER'S PLANS FOR FINAL GRADES, IF APPLICABLE.

O. PLANTING PROCEDURES

- 1. CLEANING UP BEFORE COMMENCING WORK: THE CONTRACTOR SHALL CLEAN WORK AND SURROUNDING AREAS OF ALL RUBBISH OR OBJECTIONABLE MATTER DAILY. ALL MORTAR, CEMENT, AND TOXIC MATERIAL SHALL BE REMOVED FROM THE SURFACE OF ALL PLANT BEDS. THESE MATERIALS SHALL NOT BE MIXED WITH THE SOIL. SHOULD THE CONTRACTOR FIND SUCH SOIL CONDITIONS BENEATH THE SOIL WHICH WILL IN ANY WAY ADVERSELY AFFECT THE PLANT GROWTH, HE SHALL IMMEDIATELY CALL IT TO THE ATTENTION OF THE OWNER'S REPRESENTATIVE. FAILURE TO DO SO BEFORE PLANTING SHALL MAKE THE CORRECTIVE MEASURES THE RESPONSIBILITY OF THE CONTRACTOR.
- VERIFY LOCATIONS OF ALL UTILITIES, CONDUITS, SUPPLY LINES AND CABLES, INCLUDING BUT NOT LIMITED TO: ELECTRIC, GAS (LINES AND TANKS), WATER, SANITARY SEWER, STORMWATER SYSTEMS, CABLE, AND TELEPHONE. PROPERLY MAINTAIN AND PROTECT EXISTING UTILITIES. CALL STATE OFFICIAL (811) TO LOCATE UTILITIES AT LEAST 48 HOURS PRIOR TO CONSTRUCTION.
- 3. SUBGRADE EXCAVATION: CONTRACTOR IS RESPONSIBLE TO REMOVE ALL EXISTING AND IMPORTED LIMEROCK AND LIMEROCK SUB-BASE FROM ALL LANDSCAPE PLANTING AREAS TO A MINIMUM DEPTH OF 36" OR TO NATIVE SOIL. CONTRACTOR IS RESPONSIBLE TO BACKFILL THESE PLANTING AREAS TO ROUGH FINISHED GRADE WITH CLEAN TOPSOIL FROM AN ON-SITE SOURCE OR AN IMPORTED SOURCE. IF LIMEROCK OR OTHER ADVERSE CONDITIONS OCCUR IN PLANTED AREAS AFTER 36" DEEP EXCAVATION BY THE CONTRACTOR, AND POSITIVE DRAINAGE CAN NOT BE ACHIEVED, CONTRACTOR SHALL UTILIZE POOR DRAINAGE CONDITION PLANTING DETAIL.
- 4. FURNISH NURSERY'S CERTIFICATE OF COMPLIANCE WITH ALL REQUIREMENTS AS SPECIFIED HEREIN. INSPECT AND SELECT PLANT MATERIALS BEFORE PLANTS ARE DUG AT NURSERY OR GROWING SITE.
- 5. COMPLY WITH APPLICABLE FEDERAL, STATE, COUNTY, AND LOCAL REGULATIONS GOVERNING LANDSCAPE MATERIALS AND WORK. CONFORM TO ACCEPTED HORTICULTURAL PRACTICES AS USED IN THE TRADE. UPON ARRIVAL AT THE SITE, PLANTS SHALL BE THOROUGHLY WATERED AND PROPERLY MAINTAINED UNTIL PLANTED. PLANTS STORED ONSITE SHALL NOT REMAIN UNPLANTED OR APPROPRIATELY HEALED IN FOR A PERIOD EXCEEDING TWENTY-FOUR (24) HOURS. AT ALL TIMES WORKMANLIKE METHODS CUSTOMARY IN GOOD HORTICULTURAL PRACTICES
- 6. THE WORK SHALL BE COORDINATED WITH OTHER TRADES TO PREVENT CONFLICTS. COORDINATE PLANTING WITH IRRIGATION WORK TO ASSURE AVAILABILITY OF WATER AND PROPER LOCATION OF IRRIGATION APPURTENANCES AND PLANTS.
- ALL PLANTING PITS SHALL BE EXCAVATED TO SIZE AND DEPTH IN ACCORDANCE WITH THE USA STANDARD FOR NURSERY STOCK 260.1, UNLESS SHOWN OTHERWISE ON THE DRAWINGS, AND BACK FILLED WITH THE PREPARED PLANTING SOIL MIXTURE AS SPECIFIED IN SECTION E. TEST ALL TREE PITS WITH WATER BEFORE PLANTING TO ASSURE PROPER DRAINAGE PERCOLATION IS AVAILABLE. NO ALLOWANCE WILL BE MADE FOR LOST PLANTS DUE TO IMPROPER DRAINAGE. IF POOR DRAINAGE EXISTS, UTILIZE "POOR DRAINAGE CONDITION" PLANTING DETAIL. TREES SHALL BE SET PLUMB AND HELD IN POSITION UNTIL THE PLANTING MIXTURE HAS BEEN FLUSHED INTO PLACE WITH A SLOW, FULL HOSE STREAM. ALL PLANTING SHALL BE PERFORMED BY PERSONNEL FAMILIAR WITH PLANTING PROCEDURES AND UNDER THE SUPERVISION OF A QUALIFIED LANDSCAPE FOREMAN. PROPER "JETTING IN" SHALL BE ASSURED TO ELIMINATE AIR POCKETS AROUND THE ROOTS. "JET STICK" OR EQUAL IS PECOMMENDED."
- 8. TAKE ALL NECESSARY PRECAUTIONS TO AVOID DAMAGE TO BUILDINGS AND BUILDING STRUCTURES WHILE INSTALLING TREES.
- 9. SOIL MIXTURE SHALL BE AS SPECIFIED IN SECTION E OF THESE SPECIFICATIONS.
- 10. TREES AND SHRUBS SHALL BE SET STRAIGHT AT AN ELEVATION THAT, AFTER SETTLEMENT, THE PLANT CROWN WILL STAND ONE (1) TO TWO (2) INCHES ABOVE GRADE. EACH PLANT SHALL BE SET IN THE CENTER OF THE PIT. PLANTING SOIL MIXTURE SHALL BE BACK FILLED, THOROUGHLY TAMPED AROUND THE BALL, AND SETTLED BY WATER (AFTER TAMPING).
- 11. AMEND PINE AND OAK PLANT PITS WITH ECTOMYCORRHIZAL SOIL APPLICATION PER MANUFACTURER'S RECOMMENDATION. ALL OTHER PLANT PITS SHALL BE AMENDED WITH ENDOMYCORRHIZAL SOIL APPLICATION PER MANUFACTURER'S RECOMMENDATION. PROVIDE PRODUCT INFORMATION SUBMITTAL PRIOR TO INOCULATION.
- 12. FILL HOLE WITH SOIL MIXTURE, MAKING CERTAIN ALL SOIL IS SATURATED. TO DO THIS, FILL HOLE WITH WATER AND ALLOW TO SOAK MINIMUM TWENTY (20) MINUTES, STIRRING IF NECESSARY TO GET SOIL THOROUGHLY WET. PACK LIGHTLY WITH FEET, ADD MORE WET SOIL MIXTURE. DO NOT COVER TOP OF BALL WITH SOIL MIXTURE. ALL BURLAP, ROPE, WIRES, BASKETS, ETC.., SHALL BE REMOVED FROM THE SIDES AND TOPS OF BALLS, BUT NO BURLAP SHALL BE PULLED FROM UNDERNEATH.
- PLANT. ALL SOFT WOOD OR SUCKER GROWTH AND ALL BROKEN OR BADLY DAMAGED BRANCHES SHALL BE REMOVED WITH A CLEAN CUT. ALL PRUNING TO BE PERFORMED BY CERTIFIED ARBORIST, IN ACCORDANCE WITH ANSI A-300.

 14. SHRUBS AND GROUND COVER PLANTS SHALL BE EVENLY SPACED IN ACCORDANCE WITH THE DRAWINGS AND AS INDICATED ON THE PLANT LIST

MATERIALS INSTALLED SHALL MEET MINIMUM SPECIMEN REQUIREMENTS OR QUANTITIES SHOW ON PLANS, WHICHEVER IS GREATER. CULTIVATE

PRECAUTIONS AND SPECIFICATIONS. PRIOR TO FINAL INSPECTION, TREAT ALL PLANTING BEDS WITH AN APPROVED PRE-EMERGENT HERBICIDE

13. TREES SHALL BE PRUNED, AT THE DIRECTION OF THE OWNER OR OWNER'S REPRESENTATIVE, TO PRESERVE THE NATURAL CHARACTER OF THE

- ALL PLANTING AREAS TO A MINIMUM DEPTH OF 6", REMOVE AND DISPOSE ALL DEBRIS. MIX TOP 4" THE PLANTING SOIL MIXTURE AS SPECIFIED IN SECTION E. THOROUGHLY WATER ALL PLANTS AFTER INSTALLATION.

 15. TREE GUYING AND BRACING SHALL BE INSTALLED BY THE CONTRACTOR IN ACCORDANCE WITH THE PLANS TO INSURE STABILITY AND MAINTAIN TREES IN AN UPRIGHT POSITION. IF THE CONTRACTOR AND OWNER DECIDE TO WAIVE THE TREE GUYING AND BRACING, THE OWNER SHALL
- NOTIFY THE PROJECT LANDSCAPE ARCHITECT IN WRITING AND AGREE TO INDEMNIFY AND HOLD HARMLESS THE PROJECT LANDSCAPE ARCHITECT IN THE EVENT UNSUPPORTED TREES PLANTED UNDER THIS CONTRACT FALL AND DAMAGE PERSON OR PROPERTY.

16. ALL PLANT BEDS SHALL BE KEPT FREE OF NOXIOUS WEEDS UNTIL FINAL ACCEPTANCE OF WORK. IF DIRECTED BY THE OWNER, "ROUND-UP" SHALL BE APPLIED FOR WEED CONTROL BY QUALIFIED PERSONNEL TO ALL PLANTING AREAS IN SPOT APPLICATIONS PER MANUFACTURER'S

P. LAWN SODDING

1. THE WORK CONSISTS OF LAWN BED PREPARATION, SOIL PREPARATION, AND SODDING COMPLETE, IN STRICT ACCORDANCE WITH THE SPECIFICATIONS AND THE APPLICABLE DRAWINGS TO PRODUCE A TURF GRASS LAWN ACCEPTABLE TO THE OWNER.

AT AN APPLICATION RATE RECOMMENDED BY THE MANUFACTURER. (AS ALLOWED BY JURISDICTIONAL AUTHORITY)

- 2. ALL AREAS THAT ARE TO BE SODDED SHALL BE CLEARED OF ANY ROUGH GRASS, WEEDS, AND DEBRIS BY MEANS OF A SOD CUTTER TO A DEPTH OF THREE (3) INCHES, AND THE GROUND BROUGHT TO AN EVEN GRADE. THE ENTIRE SURFACE SHALL BE ROLLED WITH A ROLLER WEIGHING NOT MORE THAN ONE-HUNDRED (100) POUNDS PER FOOT OF WIDTH. DURING THE ROLLING, ALL DEPRESSIONS CAUSED BY SETTLEMENT SHALL BE FILLED WITH ADDITIONAL SOIL, AND THE SURFACE SHALL BE REGRADED AND ROLLED UNTIL PRESENTING A SMOOTH AND EVEN FINISH TO THE REQUIRED GRADE.
- 3. PREPARE LOOSE BED FOUR (4) INCHES DEEP. HAND RAKE UNTIL ALL BUMPS AND DEPRESSIONS ARE REMOVED. WET PREPARED AREA

- a. THE CONTRACTOR SHALL SOD ALL AREAS THAT ARE NOT PAVED OR PLANTED AS DESIGNATED ON THE DRAWINGS WITHIN THE CONTRACT LIMITS, UNLESS SPECIFICALLY NOTED OTHERWISE.
- b. THE SOD SHALL BE CERTIFIED TO MEET STATE REQUIREMENTS & SPECIFICATIONS, ABSOLUTELY TRUE TO VARIETAL TYPE, AND FREE FROM WEEDS, FUNGUS, INSECTS AND DISEASE OF ANY KIND.
- c. SOD PANELS SHALL BE LAID TIGHTLY TOGETHER SO AS TO MAKE A SOLID SODDED LAWN AREA. SOD SHALL BE LAID UNIFORMLY AGAINST THE EDGES OF ALL CURBS AND OTHER HARDSCAPE ELEMENTS, PAVED AND PLANTED AREAS. ADJACENT TO BUILDINGS, A 24 INCH STONE MULCH STRIP SHALL BE PROVIDED. IMMEDIATELY FOLLOWING SOD LAYING, THE LAWN AREAS SHALL BE ROLLED WITH A LAWN ROLLER CUSTOMARILY USED FOR SUCH PURPOSES, AND THEN THOROUGHLY IRRIGATED. IF, IN THE OPINION OF THE OWNER, TOP-DRESSING IS NECESSARY AFTER ROLLING TO FILL THE VOIDS BETWEEN THE SOD PANELS AND TO EVEN OUT INCONSISTENCIES IN THE SOD, CLEAN SAND, AS APPROVED BY THE OWNER'S REPRESENTATIVE, SHALL BE UNIFORMLY SPREAD OVER THE ENTIRE SURFACE OF THE SOD AND THOROUGHLY WATERED IN. FERTILIZE INSTALLED SOD AS ALLOWED BY PROPERTY'S JURISDICTIONAL AUTHORITY.
- 5. DURING DELIVERY, PRIOR TO, AND DURING THE PLANTING OF THE LAWN AREAS, THE SOD PANELS SHALL AT ALL TIMES BE PROTECTED FROM EXCESSIVE DRYING AND UNNECESSARY EXPOSURE OF THE ROOTS TO THE SUN. ALL SOD SHALL BE STACKED SO AS NOT TO BE DAMAGED BY SWEATING OR EXCESSIVE HEAT AND MOISTURE.

6 I AWN MAINTENANCE

- a. WITHIN THE CONTRACT LIMITS, THE CONTRACTOR SHALL PRODUCE A DENSE, WELL ESTABLISHED LAWN. THE CONTRACTOR SHALL BE RESPONSIBLE FOR THE REPAIR AND RE-SODDING OF ALL ERODED, SUNKEN OR BARE SPOTS (LARGER THAN 12"X12") UNTIL CERTIFICATION OF ACCEPTANCE BY THE OWNER'S REPRESENTATIVE. REPAIRED SODDING SHALL BE ACCOMPLISHED AS IN THE ORIGINAL WORK (INCLUDING BEGRADING IS NECESSARY)
- b. CONTRACTOR RESPONSIBLE FOR ESTABLISHING AND MAINTAINING SOD/LAWN UNTIL ACCEPTANCE BY THE OWNER'S REPRESENTATIVE. PRIOR TO AND UPON ACCEPTANCE, CONTRACTOR TO PROVIDE WATERING/IRRIGATION SCHEDULE TO OWNER. OBSERVE ALL APPLICABLE WATERING RESTRICTIONS AS SET FORTH BY THE PROPERTY'S JURISDICTIONAL AUTHORITY.

Q. CLEANUP

UPON COMPLETION OF ALL PLANTING WORK AND BEFORE FINAL ACCEPTANCE, THE CONTRACTOR SHALL REMOVE ALL MATERIAL, EQUIPMENT, AND DEBRIS RESULTING FROM HIS WORK. ALL PAVED AREAS SHALL BE CLEANED AND THE SITE LEFT IN A NEAT AND ACCEPTABLE CONDITION AS APPROVED BY THE OWNER'S REPRESENTATIVE.

R. PLANT MATERIAL MAINTENANCE

ALL PLANTS AND PLANTING INCLUDED UNDER THIS CONTRACT SHALL BE MAINTAINED BY WATERING, CULTIVATING, SPRAYING, AND ALL OTHER OPERATIONS (SUCH AS RE-STAKING OR REPAIRING GUY SUPPORTS) NECESSARY TO INSURE A HEALTHY PLANT CONDITION BY THE CONTRACTOR UNTIL CERTIFICATION OF ACCEPTANCE BY THE OWNER'S REPRESENTATIVE.

S. FINAL INSPECTION AND ACCEPTANCE OF WORK

FINAL INSPECTION AT THE END OF THE WARRANTY PERIOD SHALL BE ON PLANTING, CONSTRUCTION AND ALL OTHER INCIDENTAL WORK PERTAINING TO THIS CONTRACT. ANY REPLACEMENT AT THIS TIME SHALL BE SUBJECT TO THE SAME ONE (1) YEAR WARRANTY (OR AS SPECIFIED BY THE LANDSCAPE ARCHITECT OR OWNER IN WRITING) BEGINNING WITH THE TIME OF REPLACEMENT AND ENDING WITH THE SAME INSPECTION AND ACCEPTANCE HEREIN DESCRIBED.

T. WARRANTY

- 1. THE LIFE AND SATISFACTORY CONDITION OF ALL PLANT MATERIAL INSTALLED (INCLUDING SOD) BY THE LANDSCAPE CONTRACTOR SHALL BE WARRANTED BY THE CONTRACTOR FOR A MINIMUM OF ONE (1) CALENDAR YEAR COMMENCING AT THE TIME OF CERTIFICATION OF ACCEPTANCE BY THE OWNER'S REPRESENTATIVE.
- 2. ANY PLANT NOT FOUND IN A HEALTHY GROWING CONDITION AT THE END OF THE WARRANTY PERIOD SHALL BE REMOVED FROM THE SITE AND REPLACED AS SOON AS WEATHER CONDITIONS PERMIT. ALL REPLACEMENTS SHALL BE PLANTS OF THE SAME KIND AND SIZE AS SPECIFIED IN THE PLANT LIST. THEY SHALL BE FURNISHED PLANTED AND MULCHED AS SPECIFIED AT NO ADDITIONAL COST TO THE OWNER.
- 3. IN THE EVENT THE OWNER DOES NOT CONTRACT WITH THE CONTRACTOR FOR LANDSCAPE AND IRRIGATION MAINTENANCE, THE CONTRACTOR SHOULD VISIT THE PROJECT SITE PERIODICALLY DURING THE ONE (1) YEAR WARRANTY PERIOD TO EVALUATE MAINTENANCE PROCEDURES BEING PERFORMED BY THE OWNER. CONTRACTOR SHALL NOTIFY THE OWNER IN WRITING OF MAINTENANCE PROCEDURES OR CONDITIONS WHICH THREATEN VIGOROUS AND HEALTHY PLANT GROWTH. SITE VISITS SHALL BE CONDUCTED A MINIMUM OF ONCE PER MONTH FOR A PERIOD OF TWELVE (12) MONTHS FROM THE DATE OF ACCEPTANCE.

EY-HORN AND ASSOCIATES, INC.

N.COM PHONE: 919-677-2000 FAX: 919-677-2050

STREET, SUITE 600, RALEIGH, NC 27601

© 2023 | #F-0102 WWW.KIMLEY-421 FAYETTEV

10/31/2023
SCALE AS SHOWN
DESIGNED BY JAA
DRAWN BY JAA

ANDSCAPE NOTES

ESVILLE
PARED FOR
ENTERPRISES

SCOOTER'
ROLESVILL
PREPARED FOR

SHEET NUMBER


SDP-23-09

1 TYPICAL LANDSCAPE SPECIFICATIONS




Schedule											
Symbol	Label	Image	QTY	Manufacturer	Catalog	Description	Number Lamps	Lamp Output	LLF	Input Power	Polar Plot
	А		7	RAB LIGHTING INC.	SLIM12Y/D10		1	2006	0.8	15	Max 1296cd
	В		130		NF/SP-PROW-120-24V- 3000K		1	180	0.8	2.89861	Max 57cd

Statistics						
Description	Symbol	Avg	Max	Min	Max/Min	Avg/M
Scooter Property	+	0.4 fc	17.7 fc	0.0 fc	N/A	N/A

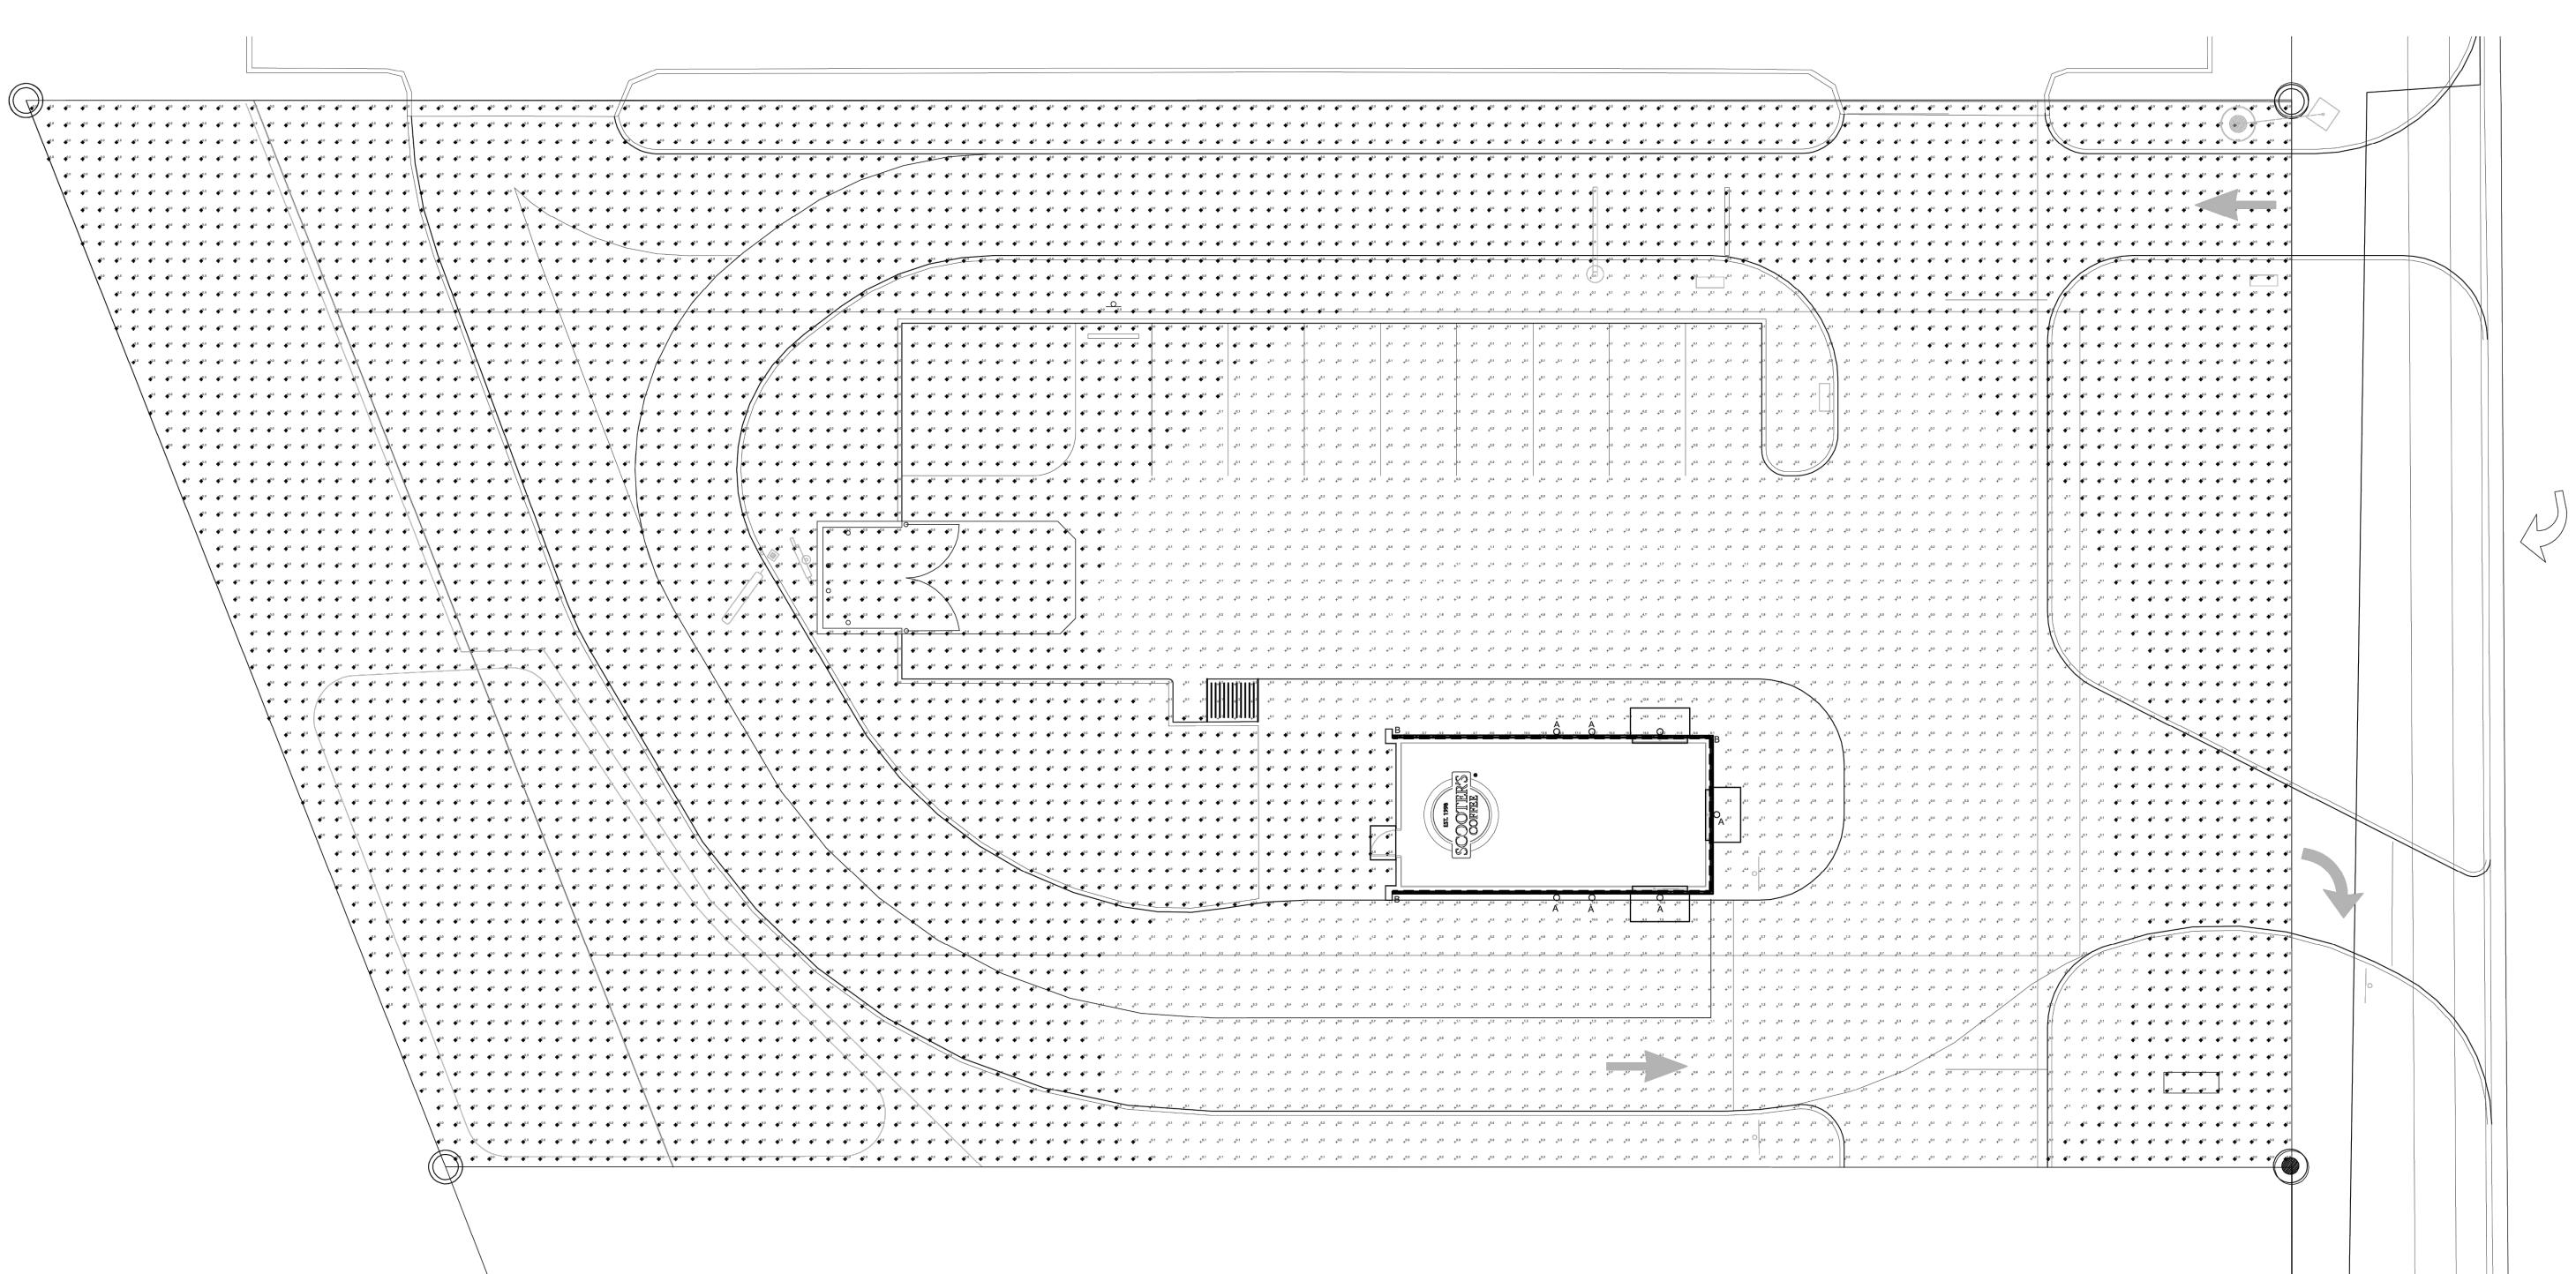

1 EXTERIOR SITE PHOTOMETRIC PLAN SCALE: 1'- 10'-0'



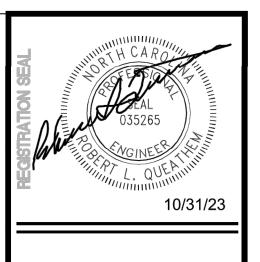

100' PUBLIC R/W

lacksquare


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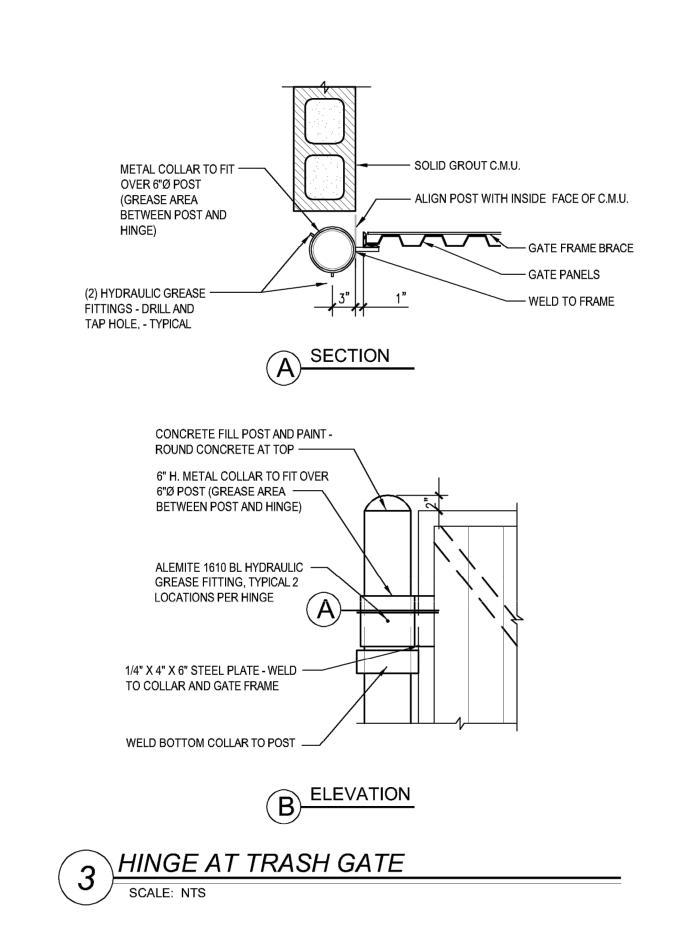
RANCHISEE & STORE NUMBER:
COLESVILLE, NC 27571
RANCHISEE & STORE NUMBER:
COOTER'S COFFEE #562


KIOSK PROTOTYPE:
4.1 PROTOTYPE
MAY 2022
ISSUE DATE:
08/14/2023
PROJECT NO.
230522
DRAWN BY:
JDK
CHECKED BY:


SHEET NO.

E3.⁻



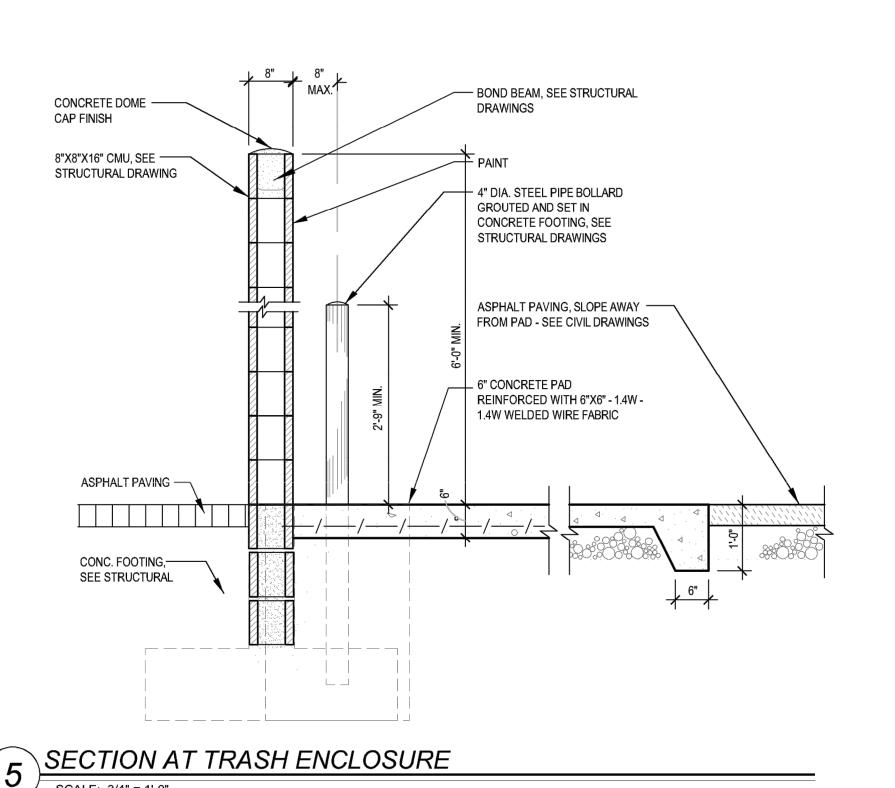

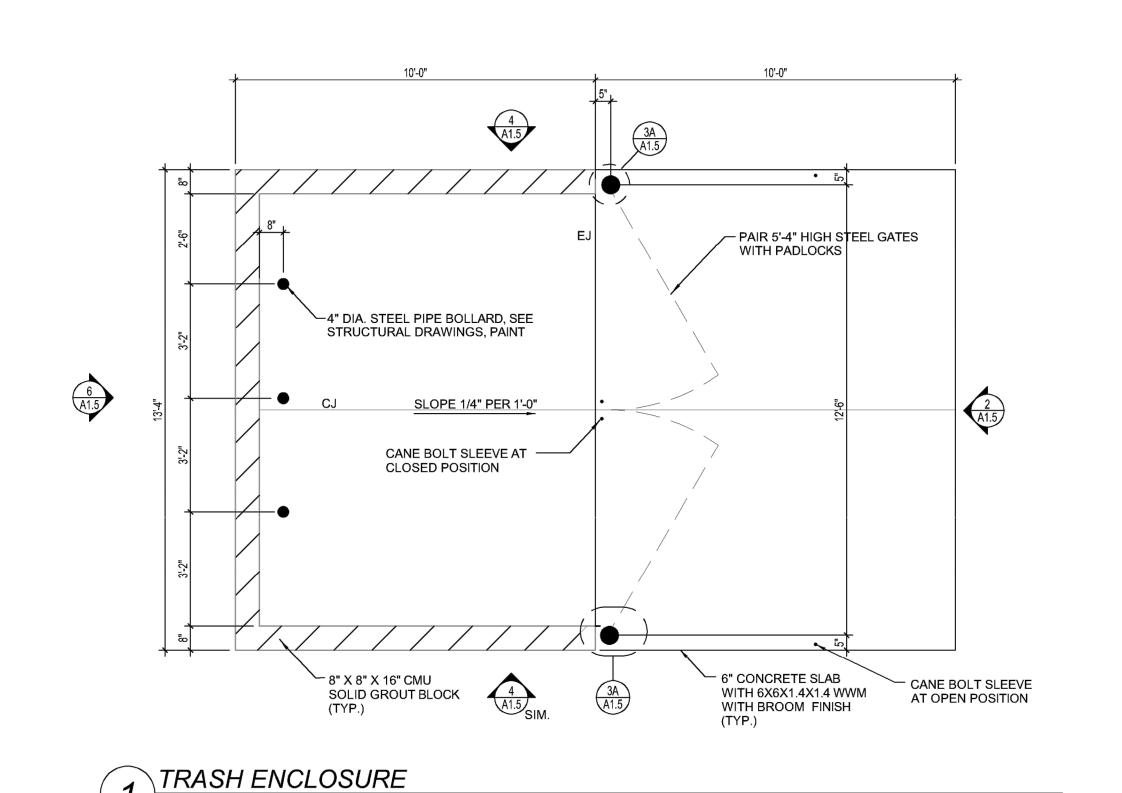

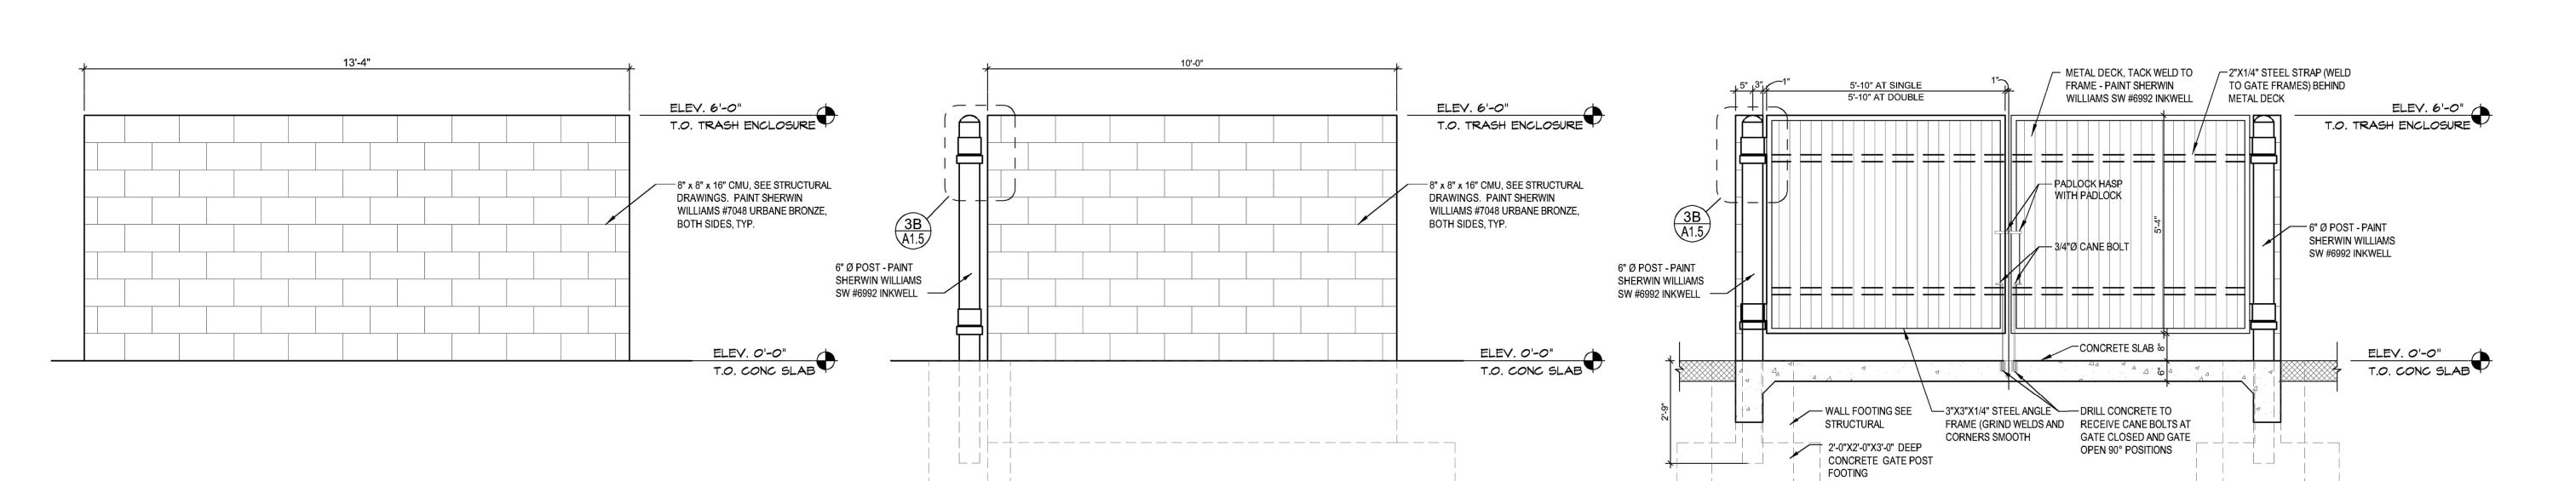

TRASH ENCLOSURE - BACK ELEVATION

SCALE: 1/2" = 1'-0"

TRASH ENCLOSURE - SIDE BACK ELEVATION

SCALE: 1/2" = 1'-0"

2 TRASH ENCLOSURE -FRONT ELEVATION

SCALE: 1/2" = 1'-0"

SCALE: 3/8" = 1'-0"



ORPORERING STORE PLANN


DALLAS / LAS VEGAS / ORLAN

SUITE 300

ST. LOUIS. MO 63

ARCHITECTURE
SAINT LOUIS / D
1950 CRAIG ROAD, SUIT



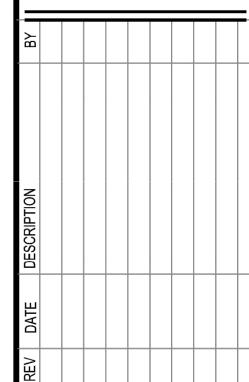

TITLE: TRASH ENCLOSURE PLAN, ELEVATIONS &

DETAIL

PROJECT ADDRESS:
306 S. MAIN ST.
ROLESVILLE, NC 27571
FRANCHISEE & STORE NUMBER:
SCOOTER'S COFFEE #562
P&S JAVA ENTERPRISES, INC.

KIOSK PROTOTYPE:
4.1 PROTOTYPE
MAY 2022
ISSUE DATE:
08/14/2023
PROJECT NO.
230522
DRAWN BY:
BB
CHECKED BY:
XXX

SHEET NO.

A1.5

FINISH SCHEDULE



4 DRIVE THRU SIDE EXTERIOR ELEVATION


SCALE: 1/4" = 1'-0"



FRONT EXTERIOR ELEVATION

SCALE: 1/4" = 1'-0"

SIDE EXTERIOR ELEVATION

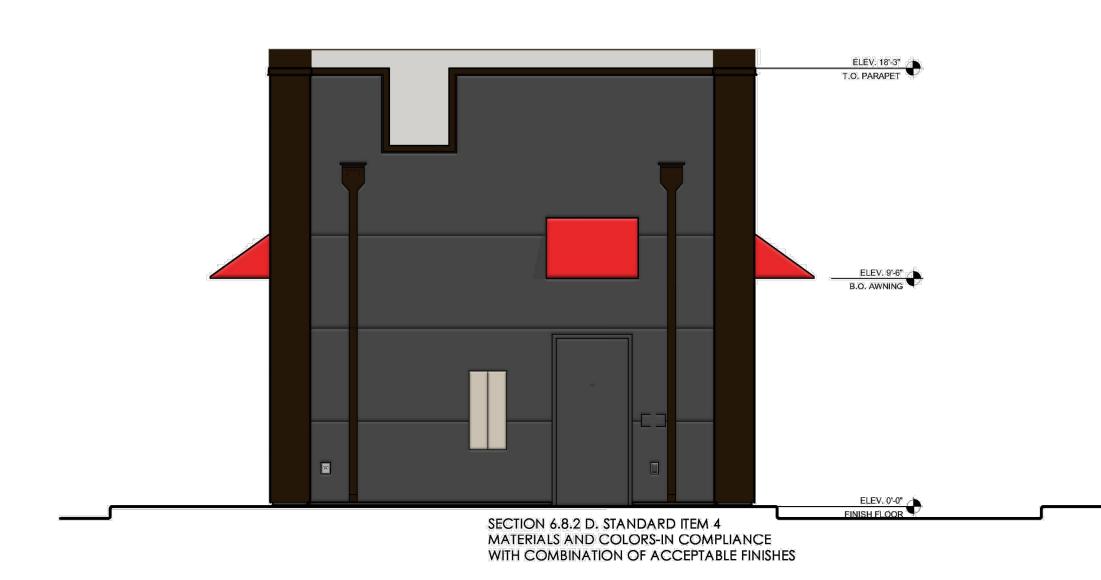

2 BACK EXTERIOR ELEVATION

SCALE: 1/4" = 1'-0"

ELEV. 19'-0' T.O. OF PARAPET	SLOPE — SECTION 6.8.2 D. STANDARD ITEM C HORIZONTAL MASS ELEV. 18:37 T.O. PARAPET
SECTION 6.8.2 D. STANDARD ITEM B ROOF LINES-MATERIALS & ROOF DESIGN STANDARDS 7C. ROOF OVERHANG & TEXTURED MATERIALS ELEV. 12'-2 1/2" T.O. LAP SIDING	SOFFEE DRIVE-THRU
B.O., AWNING/LIGHTING	SECTION 6.8.2 D. STANDARD ITEM 3 BUILDING BLANK WALL AREA-IN COMPLIANCE BY USING SUBSTANTIAL MATERIAL CHANGES & REVEAL ARCHITECTURAL ELEMENT IN STUCCO FINISH
SILL ELEV. 0'-0"	87°
SECTION 6.8.2 D. STANDARD ITEM 2 TRANSPARENCY NOT REQUIRED (SERVICE AREA)	SECTION 6.8.2 D. STANDARD ITEM 4 MATERIALS AND COLORS-IN COMPLIANCE HORIZONTAL MASS WITH COMBINATION OF ACCEPTABLE FINISHES

MATERIALP	ERCENTAC	SES
DRIVE THRU SIDE I	EXTERIOR ELE	VATION
TOTAL WALL AREA	714 SQ. FT.	100%
STUCCO - INKWELL	0 SQ. FT.	0%
STUCCO - SKYLINE STEEL	201 SQ. FT.	28%
CARBON LEDGE STONE	229 SQ. FT.	32%
FIBERON COMPOSITE CLADDING	97 SQ. FT.	14%
WINDOWS/DOORS	39 SQ. FT.	5%
TRIMS	63 SQ. FT.	9%

MATERIALPERCENTAGES					
BACK EXTER	RIOR ELEVATION				
TOTAL WALL AREA	357 SQ. FT.	100%			
STUCCO - INKWELL	250 SQ. FT.	70%			
STUCCO - SKYLINE STEEL	0 SQ. FT.	0%			
CARBON LEDGE STONE	0 SQ. FT.	0%			
FIBERON COMPOSITE	0 SQ. FT.	0%			
M	24 SQ. FT.	7%			
TRIMS	83 SQ. FT.	23%			

	MATERIALPI	ERCENTAGES	;
	SIDE EXTERI	OR ELEVATION	
%	TOTAL WALL AREA	714 SQ. FT.	100%
%	STUCCO - INKWELL	0 SQ. FT.	0%
%	STUCCO - SKYLINE STEEL	201 SQ. FT.	28%
%	CARBON LEDGE STONE	229 SQ. FT.	32%
%	FIBERON COMPOSITE CLADDING	97 SQ. FT.	14%
%	WINDOWS/DOORS	39 SQ. FT.	5%
%	TRIMS	63 SQ. FT.	9%

MATERIAL PERCENTAGES
FRONT EXTERIOR ELEVATION

STUCCO - INKWELL STUCCO - SKYLINE

STEEL

CARBON LEDGE STONE
FIBERON COMPOSITE

CLADDING WINDOWS/DOORS

TRIMS

0 SQ. FT.

20 SQ. FT.

217 SQ. FT.

36 SQ. FT.

21 SQ. FT.

SECTION 6.8.2 D. STANDARD ITEM
MINIMUM DESIGN ITEMS-DESIGN HAS (4) ITEMS INCLUDING:
A-PROJECTION OF PARAPET/OVERHANG WITH WOOD FINISH ON UNDERSIDE
B-STACKED STONE COLUMN AT STREET FACING FACADE)
D-AWNINGS PROVIDED

F-COMPLEMENTARY CHANGE IN MATERIAL & TEXTURES USING STACKED STONE, WOOD AND STUCCO FINISHES F-FINISHES VARY IN COLOR

6408


ARCHITECT

ARCHITECT

10/30/23

J. GOGLIA ST. LOUIS, MO 63146

CRAIG ROAD, SUITE 300
S14) 415-2400
FAX (314) 415-26

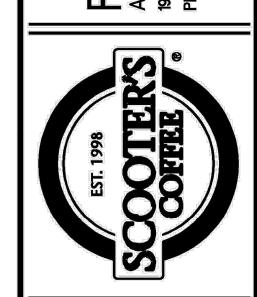

EXTERIOR COLOR

27571 NUMBER: FEE #562 PRISES, INC.

ELEVATIONS


ROLESVILLE, NC 2757
FRANCHISEE & STORE NUMB
SCOOTER'S COFFEE
P&S JAVA ENTERPRIS


KIOSK PROTOTYPE:
4.1 PROTOTYPE
MAY 2022
ISSUE DATE:
08/14/2023
PROJECT NO.
230522
DRAWN BY:

CHECKED BY:

SHEET NO.

A2.0

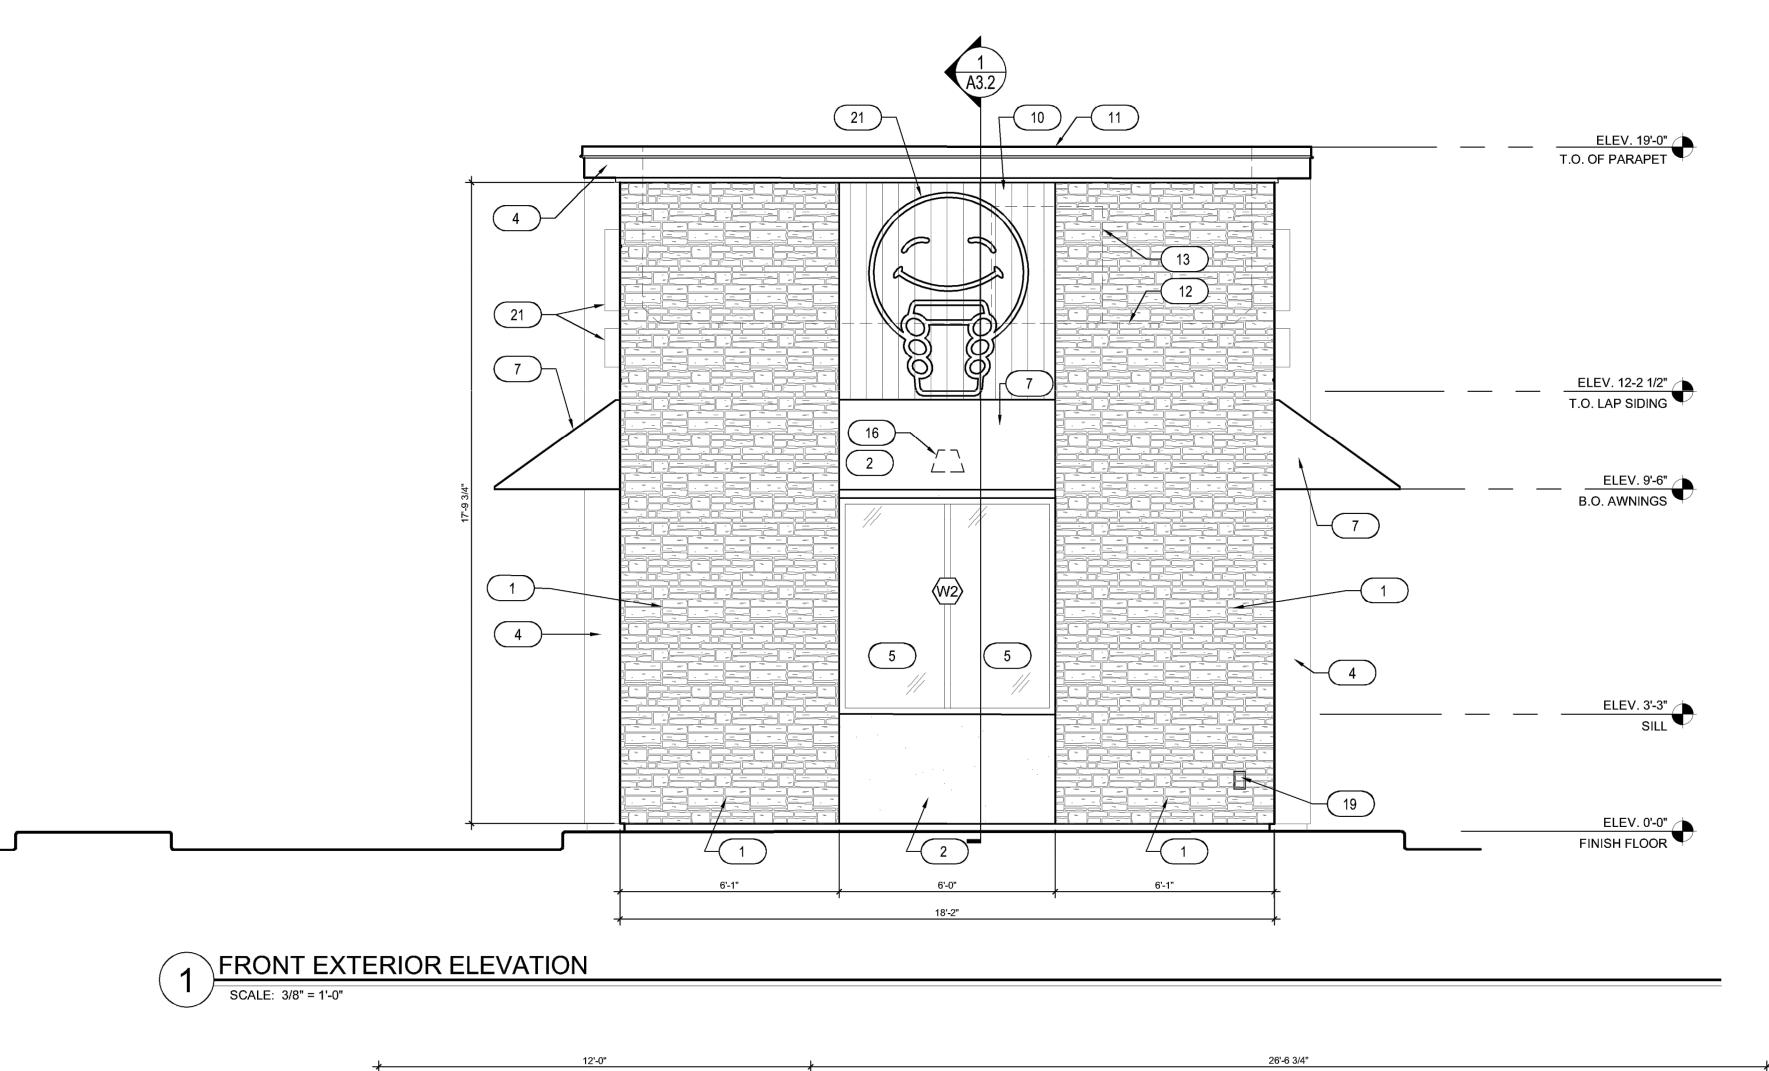

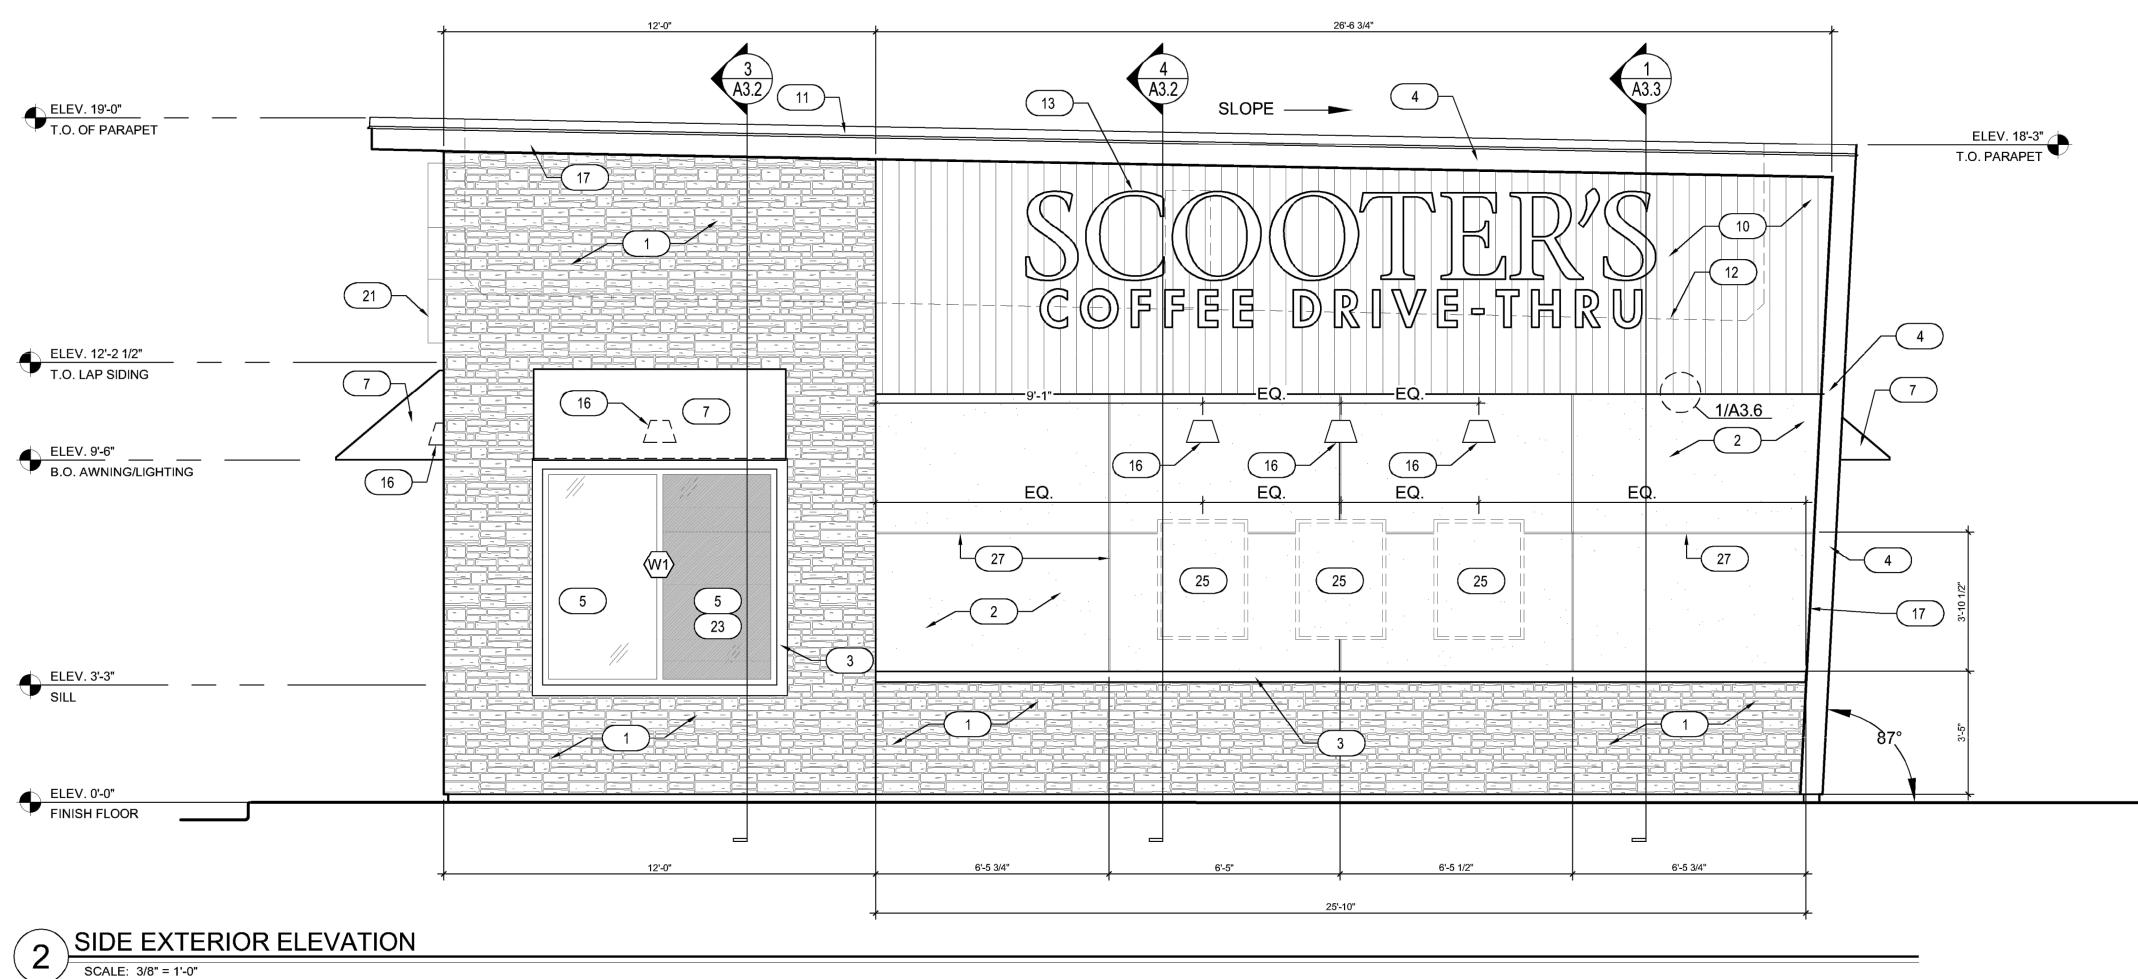

SCALE: 3/8" = 1'-0"


KEYNOTES

- 1. CARBON LEDGE STONE BY REALSTONE SYSTEMS
- 2. STUCCO COLOR: SHERWIN WILLIAMS SW1015 SKYLINE STEEL
- 3. 3 1/2" TRIM COLOR: SHERWIN WILLIAMS SW2848 ROYCROFT PEWTER
- 4. METAL FASCIA DARK BRONZE
- 5. INSULATED DARK BRONZE ALUMINUM WINDOWS WITH DUAL PANE TEMPERED
- 6. QUICKSERVE 48X48 WINDOW COLOR: DARK BRONZE
- AWNING BY OTHERS COLOR: RED
- 8. INSULATED HOLLOW METAL DOOR & FRAME; PAINT SHERWIN WILLIAMS SW6992
- 9. WIDE ANGLE PEEP HOLE, BY DOOR MANUFACTURER
- 10. FIBERON COMPOSITE CLADDING
- 11. PARAPET CAP FLASHING DARK BRONZE
- 12. LINE OF ROOF BEYOND
- 13. AIR CONDENSER, SEE MECHANICAL DRAWINGS
- 14. ROOF SCUPPER AND DOWNSPOUT, SEE DETAIL 8/A6.3
- 15. MAILBOX BY GC BLACK
- 16. WALL MOUNTED LIGHT FIXTURE, SEE ELECTRICAL DRAWINGS
- 17. LED LIGHT BAND, SEE ELECTRICAL DRAWINGS
- 18. SES PANEL, SEE ELECTRICAL DRAWINGS
- 19. ELECTRICAL OUTLETS, SEE ELECTRICAL DRAWINGS
- 20. HOSE BIBB, SEE PLUMBING DRAWINGS
- 21. PROPOSED SIGNAGE BY OTHERS, UNDER SEPARATE PERMIT
- 22. CONNECT DOWNSPOUTS TO UNDERGROUND PIPING, REF. CIVIL.
- 23. SPANDREL GLASS
- 24. NEW SECURITY CAMERA
- 25. CUSTOMER PROVIDED SIGN PANELS. PANELS TO BE MOUNTED TO FASCIA BY GC (WHEN PROVIDED) IN CUSTOMER SPECIFIED LOCATION USING PROPER HARDWARE AND FASTENERS (NON-CORROSIVE)
- 26. STUCCO COLOR: SHERWIN WILLIAMS SW6993 INKWELL EGGSHELL FINISH
- 27. STUCCO REVEAL



``10/30/23



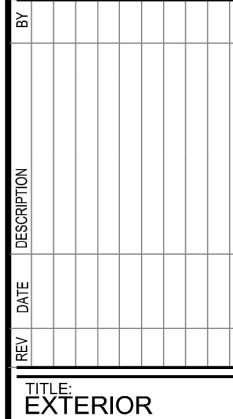


ELEVATIONS

PROJECT ADDRESS:
306 S. MAIN ST.
ROLESVILLE, NC 27571

KIOSK PROTOTYPE: 4.1 PROTOTYPE MAY 2022 ISSUE DATE: 08/14/2023 PROJECT NO. 230522 DRAWN BY: CHECKED BY:

SHEET NO.

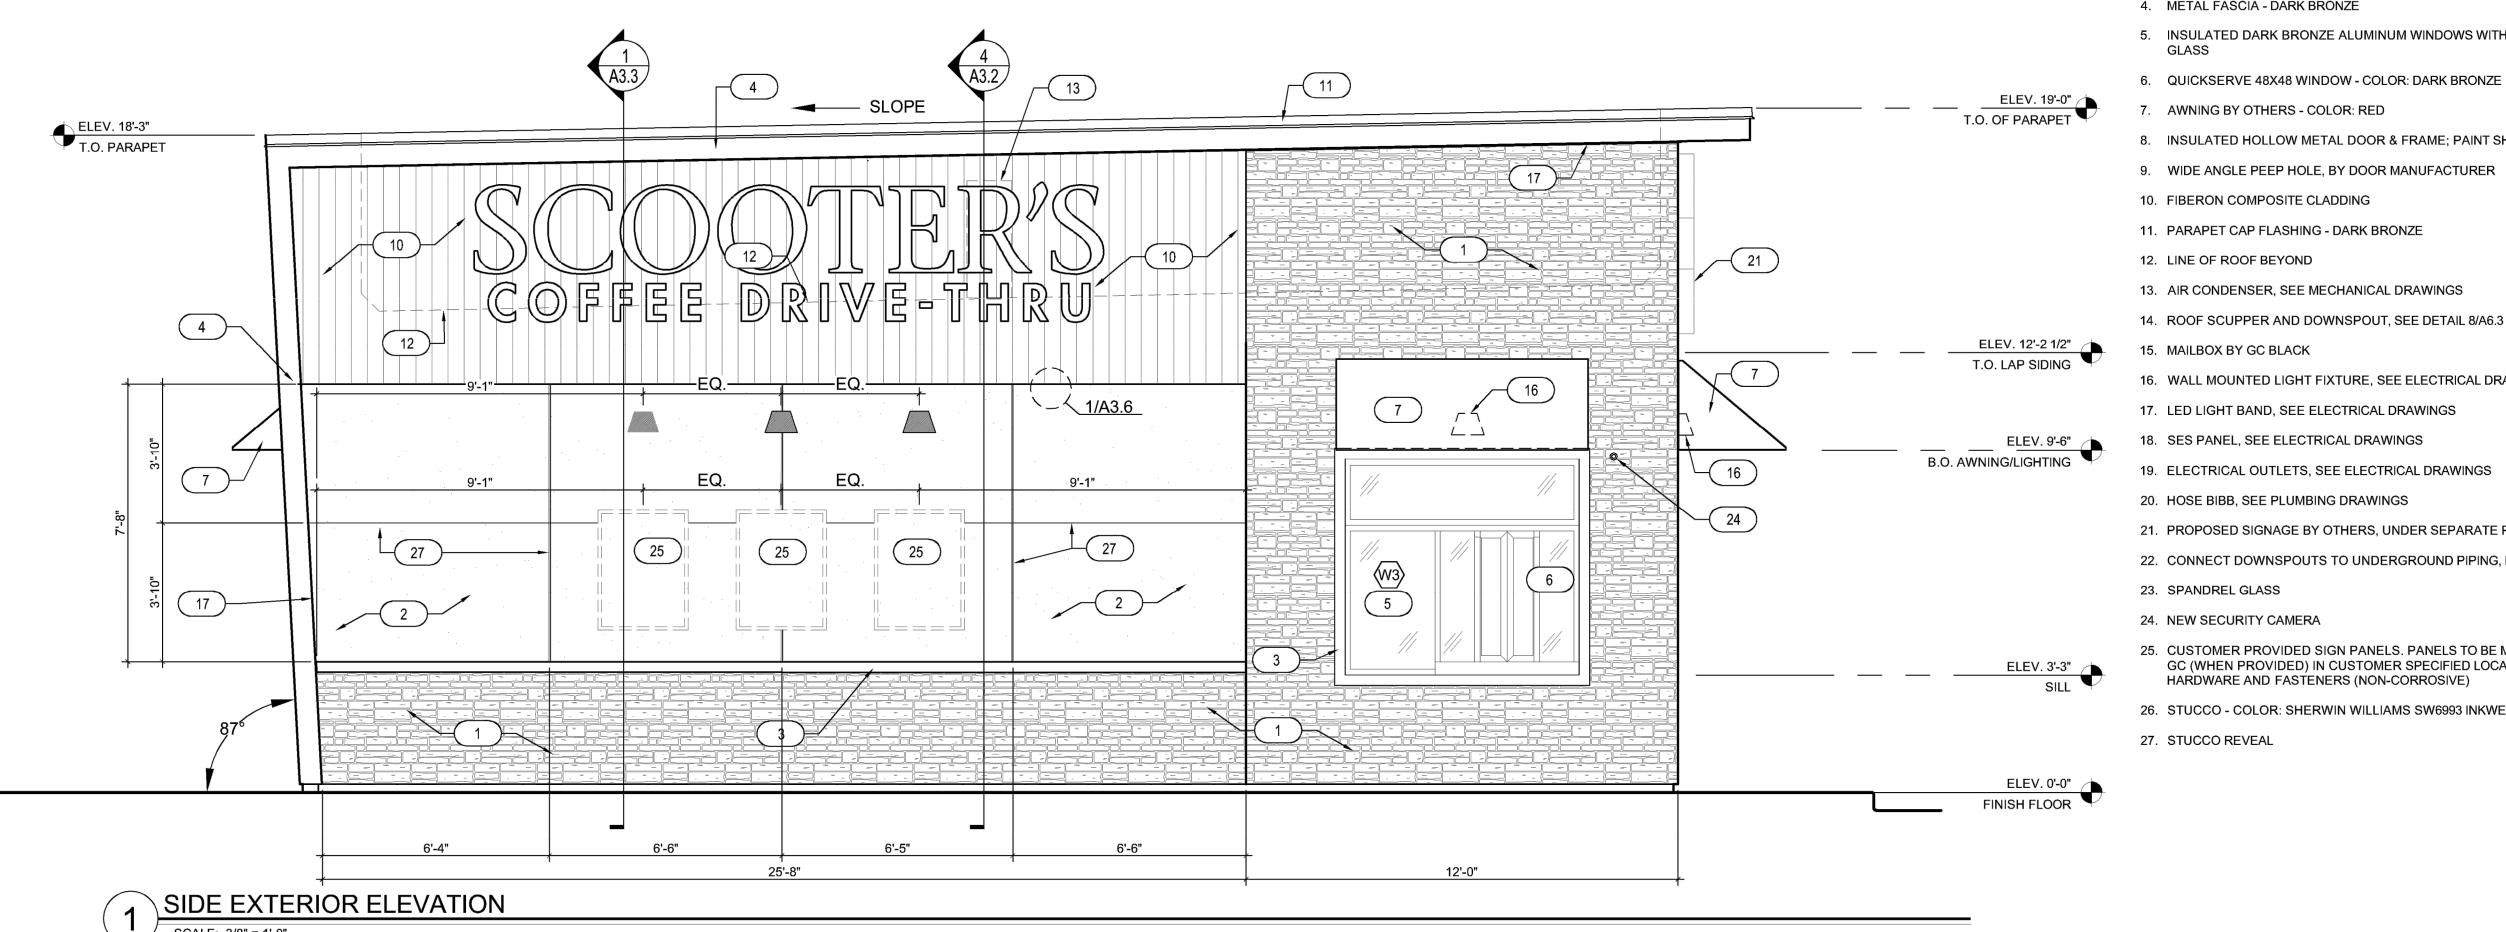


MATERIALP	ERCENTAC	SES
DRIVE THRU SIDE	EXTERIOR ELE	VATION
TOTAL WALL AREA	714 SQ. FT.	100%
STUCCO - INKWELL	0 SQ. FT.	0%
STUCCO - SKYLINE STEEL	201 SQ. FT.	28%
CARBON LEDGE STONE	229 SQ. FT.	32%
FIBERON COMPOSITE CLADDING	97 SQ. FT.	14%
WINDOWS/DOORS	39 SQ. FT.	5%
TRIMS	63 SQ. FT.	9%

MATERIALPERCENTAGES				
BACK EXTERIOR ELEVATION				
TOTAL WALL AREA	357 SQ. FT.	100%		
STUCCO - INKWELL	250 SQ. FT.	70%		
STUCCO - SKYLINE STEEL	0 SQ. FT.	0%		
CARBON LEDGE STONE	0 SQ. FT.	0%		
FIBERON COMPOSITE CLADDING	0 SQ. FT.	0%		
M	24 SQ. FT.	7%		
TRIMS	83 SQ. FT.	23%		

MATERIALP	ERCENTAC	SES		
FRONT EXTERIOR ELEVATION				
TOTAL WALL AREA	324 SQ. FT.	100%		
STUCCO - INKWELL	0 SQ. FT.	0%		
STUCCO - SKYLINE STEEL	20 SQ. FT.	6%		
CARBON LEDGE STONE	217 SQ. FT.	67%		
FIBERON COMPOSITE CLADDING	36 SQ. FT.	11%		
WINDOWS/DOORS	36 SQ. FT.	11%		
TRIMS	21 SQ. FT.	6%		

MATERIALP	ERCENTAGES	S
SIDE EXTER	IOR ELEVATION	
TOTAL WALL AREA	714 SQ. FT.	100%
STUCCO - INKWELL	0 SQ. FT.	0%
STUCCO - SKYLINE STEEL	201 SQ. FT.	28%
CARBON LEDGE STONE	229 SQ. FT.	32%
FIBERON COMPOSITE CLADDING	97 SQ. FT.	14%
WINDOWS/DOORS	39 SQ. FT.	5%
TRIMS	63 SQ. FT.	9%

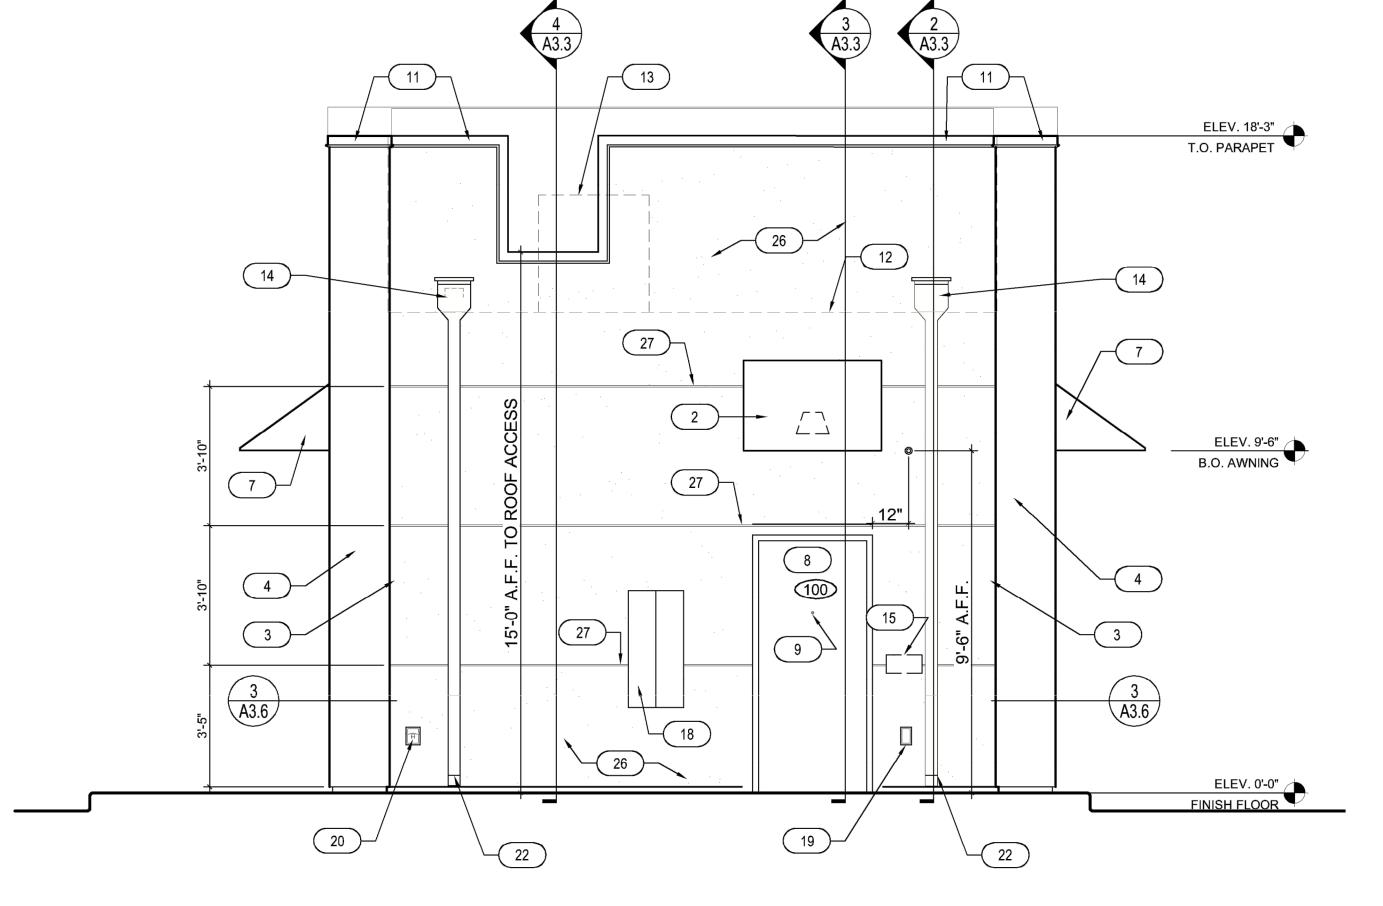

BACK EXTERIOR ELEVATION

SCALE: 3/9" - 41.0" SCALE: 3/8" = 1'-0"


KEYNOTES

- 1. CARBON LEDGE STONE BY REALSTONE SYSTEMS
- 2. STUCCO COLOR: SHERWIN WILLIAMS SW1015 SKYLINE STEEL
- 3. 3 1/2" TRIM COLOR: SHERWIN WILLIAMS SW2848 ROYCROFT PEWTER
- 4. METAL FASCIA DARK BRONZE
- 5. INSULATED DARK BRONZE ALUMINUM WINDOWS WITH DUAL PANE TEMPERED
- AWNING BY OTHERS COLOR: RED
- 8. INSULATED HOLLOW METAL DOOR & FRAME; PAINT SHERWIN WILLIAMS SW6992
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- 12. LINE OF ROOF BEYOND
- 13. AIR CONDENSER, SEE MECHANICAL DRAWINGS
- 14. ROOF SCUPPER AND DOWNSPOUT, SEE DETAIL 8/A6.3
- 15. MAILBOX BY GC BLACK
- 16. WALL MOUNTED LIGHT FIXTURE, SEE ELECTRICAL DRAWINGS
- 17. LED LIGHT BAND, SEE ELECTRICAL DRAWINGS
- 18. SES PANEL, SEE ELECTRICAL DRAWINGS
- 19. ELECTRICAL OUTLETS, SEE ELECTRICAL DRAWINGS
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- 22. CONNECT DOWNSPOUTS TO UNDERGROUND PIPING, REF. CIVIL.
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- 26. STUCCO COLOR: SHERWIN WILLIAMS SW6993 INKWELL EGGSHELL FINISH
- 27. STUCCO REVEAL



``10/30/23

GOGLIA

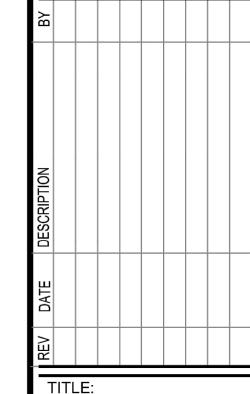

TITLE: EXTERIOR ELEVATIONS

PROJECT ADDRESS: 306 S. MAIN ST. ROLESVILLE, NC 27571

KIOSK PROTOTYPE: 4.1 PROTOTYPE MAY 2022 ISSUE DATE: 08/14/2023 PROJECT NO. 230522 DRAWN BY:

SHEET NO.

CHECKED BY:

Holloway (Summit Design & Engineering), Magda P

From: Marsh, Eric L

Sent: Monday, April 1, 2024 5:04 PM

To: Josh Douthit; Elabarger, Michael S; McFarland, Mical

Cc: Gruber, Meredith; Alexander, Jamal; Holloway (Summit Design & Engineering), Magda P;

Bostic, Chris

Subject: RE: [External] RE: Rolesville Driveway Permit Applications (D051-092-24-00038 &

D051-092-24-00039)

Josh captured my additional concerns. Feel free to move forward with these recommendations in mind.

Thanks,

Eric L. Marsh, MPA, El Assistant Town Manager

Town of Rolesville PO Box 250 502 Southtown Circle Rolesville, NC 27571 919.556.3506





From: Josh Douthit < jdouthit@rkk.com> Sent: Monday, April 1, 2024 4:59 PM

To: Elabarger, Michael S <michael.elabarger@rolesville.nc.gov>; Marsh, Eric L <Eric.Marsh@rolesville.nc.gov>; McFarland, Mical <mical.mcfarland@rolesville.nc.gov>

Cc: Gruber, Meredith <meredith.gruber@rolesville.nc.gov>; Alexander, Jamal <Jamal.Alexander@kimley-horn.com>; Holloway (Summit Design & Engineering), Magda P <ext-mpholloway@ncdot.gov>; Bostic, Chris <Chris.Bostic@kimley-horn.com>

Subject: [External] RE: Rolesville Driveway Permit Applications (D051-092-24-00038 & D051-092-24-00039)

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Chris/Mike

I don't see any conflicts in the area but there will need to be some coordination between the developments and our LAP project to prevent extra costs/rework and aesthetic reasons. Luckily we are doing minimal work in this section of the project. A couple of things that I have noted are:

- 302 S. Main / The Learning Center
 - Differing Trees/Landscaping plans adjacent to existing sidewalk parallel with Main Street.
 - Both plans show installing a new ADA curb ramp on Old Rogers Rd, our plans also have a few joints of sidewalk to tie in while The Learning Center is redoing entire sidewalk.

- Our plans call for a resurfacing of Main Street so it would be beneficial to have the sawcut and waterline tie in done prior to the resurfacing of Main Street.
- o Street light to be added from our project on SE corner of lot near the intersection.
- 306 S. Main / Scooters Coffee
 - o Differing Trees/Landscaping plans adjacent to existing sidewalk parallel with Main Street
 - Our plans call for a resurfacing of Main Street so it would be beneficial to have the water/sewer tie in done prior to the resurfacing of Main Street.

I don't see any issues or direct conflicts with these projects moving forward in accordance with the LDO and Planning review process but will let Eric provide the final ok.

Let me know if you have any questions.

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JOSH DOUTHIT. PE

Project Engineer



8601 Six Forks Road, Suite 700 Raleigh, NC 27615

910-644-4054 C www.rkk.com

Responsive People | Creative Solutions

From: Elabarger, Michael S < <u>michael.elabarger@rolesville.nc.gov</u>>

Sent: Monday, April 1, 2024 11:33 AM

To: Josh Douthit <<u>idouthit@rkk.com</u>>; Marsh, Eric L <<u>Eric.Marsh@rolesville.nc.gov</u>>; McFarland, Mical <<u>mical.mcfarland@rolesville.nc.gov</u>>

Cc: Gruber, Meredith < meredith.gruber@rolesville.nc.gov >; Alexander, Jamal < Jamal.Alexander@kimley-horn.com >; Holloway (Summit Design & Engineering), Magda P < ext-mpholloway@ncdot.gov >; Bostic, Chris < Chris.Bostic@kimley-horn.com >

Subject: RE: Rolesville Driveway Permit Applications (D051-092-24-00038 & D051-092-24-00039)

EXTERNAL EMAIL: Do not click links or open attachments unless you trust the 'Sender' and know the content is safe.

Good morning,

I'm forwarding this to the <u>LAPP project management</u> representative Josh Douthit, and cc'ing the Interim Town Manager and Economic Development Director as well. I believe Josh can speak to this on behalf of the project and Town, but if not, Mr. Marsh likely can.

For reference some links for these 2 development projects:

302 S. Main / The Learning Center – latest Site Development Plan submittal –
 https://www.rolesvillenc.gov/sites/default/files/uploads/projects/documents/v3_sdp-24-02-tle-rolesville-plans.pdf

 306 S. Main / Scooters Coffee – latest Site Development Plan submittal -https://www.rolesvillenc.gov/sites/default/files/uploads/projects/documents/v3_sdp-23-09_rvsd-plan-set_2024-03-01.pdf

I can offer that through 2 reviews of each of these projects by the Town's Technical Review Committee [TRC] staff, there have not been any conflicts identified with the LAPP project and any improvements planned for this stretch of S. Main Street.

Thank you! Mike Elabarger Senior Planner / TRC Coordinator

From: Bostic, Chris < Chris.Bostic@kimley-horn.com>

Sent: Monday, April 1, 2024 9:51 AM

To: Elabarger, Michael S < michael.elabarger@rolesville.nc.gov>

Cc: Gruber, Meredith <meredith.gruber@rolesville.nc.gov>; Alexander, Jamal.Alexander@kimley-horn.com>;

Holloway (Summit Design & Engineering), Magda P < ext-mpholloway@ncdot.gov>

Subject: FW: [External] Rolesville Driveway Permit Applications (D051-092-24-00038 & D051-092-24-00039)

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Good morning Michael.

Please see below thread. DOT is wanting confirmation in their review of both TLE and Scooters that we have coordinated with the Town on U-6241/Main Street. They reference Eric Marsh but sending to you for direction. Have also copied our reviewer at NCDOT.

Can you please respond to this thread as we have coordinated during TRC review?

Chris

From: Holloway (Summit Design & Engineering), Magda P < ext-mpholloway@ncdot.gov>

Sent: Wednesday, March 27, 2024 8:49 AM

To: Alexander, Jamal < Jamal. Alexander@kimley-horn.com>

Cc: Bostic, Chris < Chris.Bostic@kimley-horn.com>; Haidari, Mohammad J < mjhaidari@ncdot.gov>

Subject: Re: [External] Rolesville Driveway Permit Applications (D051-092-24-00038 & D051-092-24-00039)

Good morning. Thank you for this information. As it states in the portal, Eric Marsh would need to provide comments for both of these projects confirming that he is good for this project to move forward. We always have to hear from the PM for our documentation. Can you coordinate that effort to get us the response we need? It can all be within this email as long as both encroachments are referenced. Thank you in advance.

Magda

Get Outlook for iOS

From: Alexander, Jamal < Jamal. Alexander@kimley-horn.com>

Sent: Tuesday, March 26, 2024 11:22:28 AM

To: Holloway (Summit Design & Engineering), Magda P <ext-mpholloway@ncdot.gov>

Cc: Bostic, Chris < Chris.Bostic@kimley-horn.com>

Subject: [External] Rolesville Driveway Permit Applications (D051-092-24-00038 & D051-092-24-00039)

You don't often get email from jamal.alexander@kimley-horn.com. Learn why this is important

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Good Morning Magda,

I'm reaching out regarding comments received on the Scooter's Rolesville (D051-092-24-00038) and The Learning Center Rolesville (D051-092-24-00039) projects, shown below. We have already coordinated with the Town of Rolesville on the sidewalk project in our TRC reviews. Could you please let us know next steps?

Scooters:

DP Comments Per Raymond Hayes, this project is within U-6241

project limits. The town will need to provide comments

(Eric Marsh).

New DOT Comments Magda P Holloway(Tue Mar 12 2024 06:54:26 GMT-

0400 (Eastern Daylight Time))Per Raymond Hayes, this

project is within U-6241 project limits. The town will

need to provide comments (Eric Marsh).;

Preston A Fisher(Thu Mar 07 2024 11:56:35 GMT-0500 (Eastern Standard Time))Project may conflict with BP-2021-05. Reached out to Raymond Hayes for more

information.;

The Learning Center Rolesville:

DP Comments Per Raymond Hayes, this project is within U-6241

project limits. The town will need to provide comments

(Eric Marsh).

New DOT Comments Magda P Holloway(Tue Mar 12 2024 06:54:26 GMT-

0400 (Eastern Daylight Time))Per Raymond Hayes, this

project is within U-6241 project limits. The town will

need to provide comments (Eric Marsh).;

Preston A Fisher(Thu Mar 07 2024 11:56:35 GMT-0500 (Eastern Standard Time))Project may conflict with BP-

2021-05. Reached out to Raymond Hayes for more

information.;

Thanks,

Jamal Alexander, El | Civil Analyst

Kimley-Horn | 421 Fayetteville Street, Suite 600, Raleigh, NC 27601

Direct: 919 566 1945

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KIMLEY-HORN & ASSOCIATES, INC.

421 Fayetteville Street, Suite 600 Raleigh, North Carolina 27601 TEL: (919) 677-2000 FAX: (919) 677-2050

ENGINEER'S OPINION OF PROBABLE COST

PROJECT: Scooter's Rolesville (US HWY 401/S MAIN ST)

JOB NUMBER: 016485000 **PREPARED BY: Luke Newton** DATE: 5/20/2024 **CHECKED BY: Chris Bostic** DATE: 5/20/2024

ITEM	DESCRIPTION	QUANTITY	UNIT	UNIT BID	TOTAL
1	Erosion Control	131	LF	\$7.00	\$917.00
5	30" Curb & Gutter	164	LF	\$20.00	\$3,280.00
8	Accessible Ramps	4	EA	\$1,500.00	\$6,000.00
9	10" ABC Stone Base	78	TON	\$40.00	\$3,120.00
10	4" Intermediate Course	31	TON	\$90.00	\$2,790.00
11	3" Asphalt Surface	23	TON	\$90.00	\$2,070.00
12	Seeding & Mulching	0.05	AC	\$5,000.00	\$250.00
13	2-inch Saddle & Valve	1	EA	\$5,000.00	\$5,000.00
14	2-inch Waterline	23	LF	\$25.00	\$575.00
15	1-1/4" Force Main	78	LF	\$20.00	\$1,560.00
16	Catch Basin	1	EA	\$3,500.00	\$3,500.00
17	Storm Drainage Pipe	29	LF	\$40.00	\$1,160.00
18	Signs	1	EA	\$1,000.00	\$1,000.00
19	6' Concrete Sidewalk	39	SY	\$50.00	\$1,950.00
				TOTAL	\$33,200

Notes:

- 1. Cost opinion is based on the Site Plan named "Scooter's Rolesville" dated March 01, 2024 prepared by Kimley-Horn.
- Cost opinion does not include costs for unsuitable soils or general conditions.
- 3. Cost opinion does not include permitting and review fees.



The Engineer has no control over the cost of labor, materials, or equipment, or over the Contractor's methods of determining prices or over competitive bidding or market conditions. Opinions of probable costs, as provided here, are made on the basis of the Engineer's experience and qualifications and represent the Engineer's judgement as a design professional familiar with the construction industry. The Engineer cannot and does not guarantee that proposals, bids, or actual construction costs will not vary from opinions of probable cost prepared for the Owner.

KIMEEY-HORN & ASSOC., INC. 421 FAYETTEVILLE STREET SUITE 600

RALEIGH, NC 27601 919-677-2000

PAY

Fifty And 00/100 Dollars

To The Order Of

NCDOT 4009 DISTRICT DRIVE RALEIGH, NC 27607 66-156/531

WELLS FARGO BANK, N.A. Charlotte, No.

216850017

DATE

CONTROL NO.

AMOUNT

06/24/2024

216850017

\$50.00

216850017# # #053101561# 2079985320339#

KIMLEY-HORN & ASSOC., INC.

216850017

Voucher No.	Invoice Number	Invoice Date	Invoice Amount	Discount Taken	Net Amount Paid
310024493	62124	06/21/2024	\$50.00	\$.00	\$50.00
Subtotals Totals			\$50.00 \$50.00	\$.00 \$.00	\$50.00 \$50.00
	Check Notes				
10024493	permit number (DOS	51-092-24-000391			

(10051-092-24-00038)

1026 Bank of America 100 N. Tryon St. Charlotte, NC 28255 S&S Java Enterprises - Rolesville, Llc 13 Lafoy Dr Clayton, NC 27527 68-19/530 -2024 1\$ 50.00 PAY TO THE ORDER OF_ DOLLA 1 Permit # 2051-092-24-00038 AUTHORIZED SIGNATURE 237050633478# #001026# #053000196#

VERIFICATION OF COMPLIANCE WITH ENVIRONMENTAL REGULATIONS

(Check Appropriate Box)

4	Permits from the N.C. Department of Environmental Quality and the U.S. Army Corp of Engineers are not required for this project. However, all applicable federal and state regulations have been followed.							
	The required permits from the N.C. Department of Environmental Quality and the U.S. Army Corp of Engineers have been obtained for this project. Copies of the permits are attached.							
4	All applicable NPDES Stormwater Permit requirements have been or will be met for this project.							
4	The project is in compliance with all applicable sedimentation and erosion control laws and regulations.							
Pro	ject Name:	Scooter's Rolesville						
Township:		Rolesville	County:	Wake				
Project Engineer:		Kimley-Horn	Phone Number	919-653-2927				
Project Contact:		Chris Bostic						
Applicant's Name: Date Submitted:		S&S Java Enterprises- Rolesville, LLC January , 2024						
Dal	e Jubiliitteu.			GOODS OF THE CONTROL				

Form VCER-1 June 2016

National Pollutant Elimination System (NPDES) Stormwater Permit Compliance Certification

I Robert Southerland	, a duly authorized representative of					
S&S Java Enterprises - Rolesville, LLC	, an industrial/commercial/residential					
facility requesting attachment to a North Carolina Department of Transportation						
highway drainage system at US 401 (South Main	st) in					
County, do hereby certify the following:						
Check appropriate box and circle type of facility						
The Industrial / Commercial / Residential facility does not require an NPDES stormwater permit.						
stormwater permit. The permit has Pollution Prevention Plan (SPPP) i stormwater best management pract required by the Department of Env	s in place. Appropriate structural ices (BMP) are designed and installed as ironment and Natural Resources (DENR) All structural stormwater BMP's are					
I understand if the Department of Transpe	ortation determines the facility is not in					
compliance with NPDES stormwater requirements, the Department will report the						
noncompliance to the DENR Division of Water Quality. I also understand that						
falsification of this certification may result in penalty of law against the facility						
and me as prescribed in the North Carolina General Statutes.						
Signature: Robert L. South						
Note: If the applicant has a question as to	whether an NPDES stormwater permit is					

Note: If the applicant has a question as to whether an NPDES stormwater permit is required, he or she may contact the N.C. Division of Water Quality in Raleigh at (919) 733-5083 (ask for Stormwater and General Permits Unit).

Form NPDES-1 May 22, 2006