V1 - SDP-24-06

ROLESVILLE CROSSING


1801 ROLESVILLE RD ROLESVILLE, NC 27587

AMENITY CENTER CONSTRUCTION DRAWINGS

PROJECT NUMBER: LEN2026

SDP-24-XXXX

DATE: JULY 1, 2024

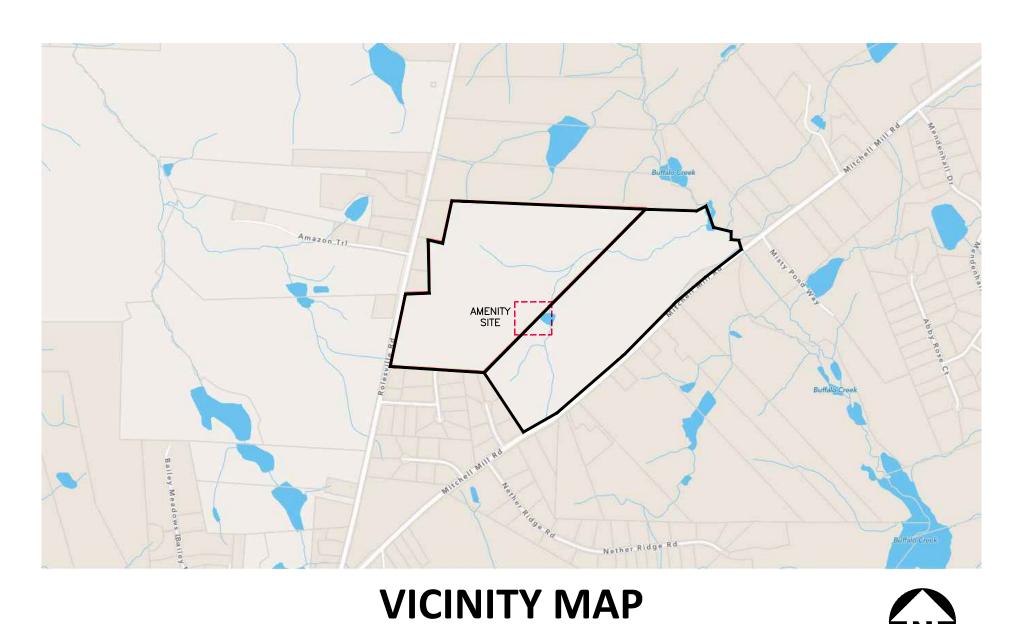

N.T.S.

SHEET INDEX

SHEET HADEN	
C0.00	COVER SHEET
C1.00	OVERALL SUBDIVISION PLAN
C1.01	AMENITY EXISTING CONDITION
C2.00	AMENITY HARDSCAPE PLAN
C3.00	AMENITY GRADING PLAN
C4.00	AMENITY UTILITY PLAN - SHEET 1 OF 2
C4.01	AMENITY UTILITY PLAN - SHEET 2 OF 2
C8.00	SITE AND UTILITY DETAILS
C8.01	SITE DETAILS
L5.00	AMENITY LANDSCAPE PLAN
L5.01	LANDSCAPE NOTES AND DETAILS
L6.00	AMENITY LIGHTING PLAN

3. Add site data table including: Property Identification Numbers (PIN) for all properties, Zoning, Watershed, River Basin, Current Use, Proposed Use, Current Impervious, Proposed Impervious, Parking Data per use, Tree Coverage Data, Building Height, Building Square Footage and/or residential density and unit data per housing type.



The John R. McAdams Company, 621 Hillsborough Street Suite 500 Raleigh, NC 27603

phone 919. 361. 5000 fax 919. 361. 2269 license number: C-0293, C-187

www.mcadamsco.com

CONTACT

SARA DONOHOE donohoe@mcadamsco.com PHONE: 703.431.8058

CLIENT

LENNAR

2. Add contact phone number.

1100 PERIMETER PARK DRIVE, SUITE 112 MORRISVILLE, NC 27560



PROJECT DIRECTORY



REVISIONS

NO. DATE

CONSTRUCTION DRAWINGS DRAWINGS FOR:

ROLESVILLE CROSSING AMENITY CENTER ROLESVILLE, NC 27587 PROJECT NUMBER: LEN23026





phone 919. 361. 5000 fax 919. 361. 2269

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CROSSING
CENTER
N DRAWINGS
SVILLE RD



REVISIONS

NO. DATE


PLAN INFORMATION

PROJECT NO. LEN23026 FILENAME CHECKED BY SRD DRAWN BY

SCALE DATE 07.01.2024

PRELIMINARY DRAWING - NOT RELEASED FOR CONSTRUCTION

SHEET OVERALL SUBDIVISION PLAN

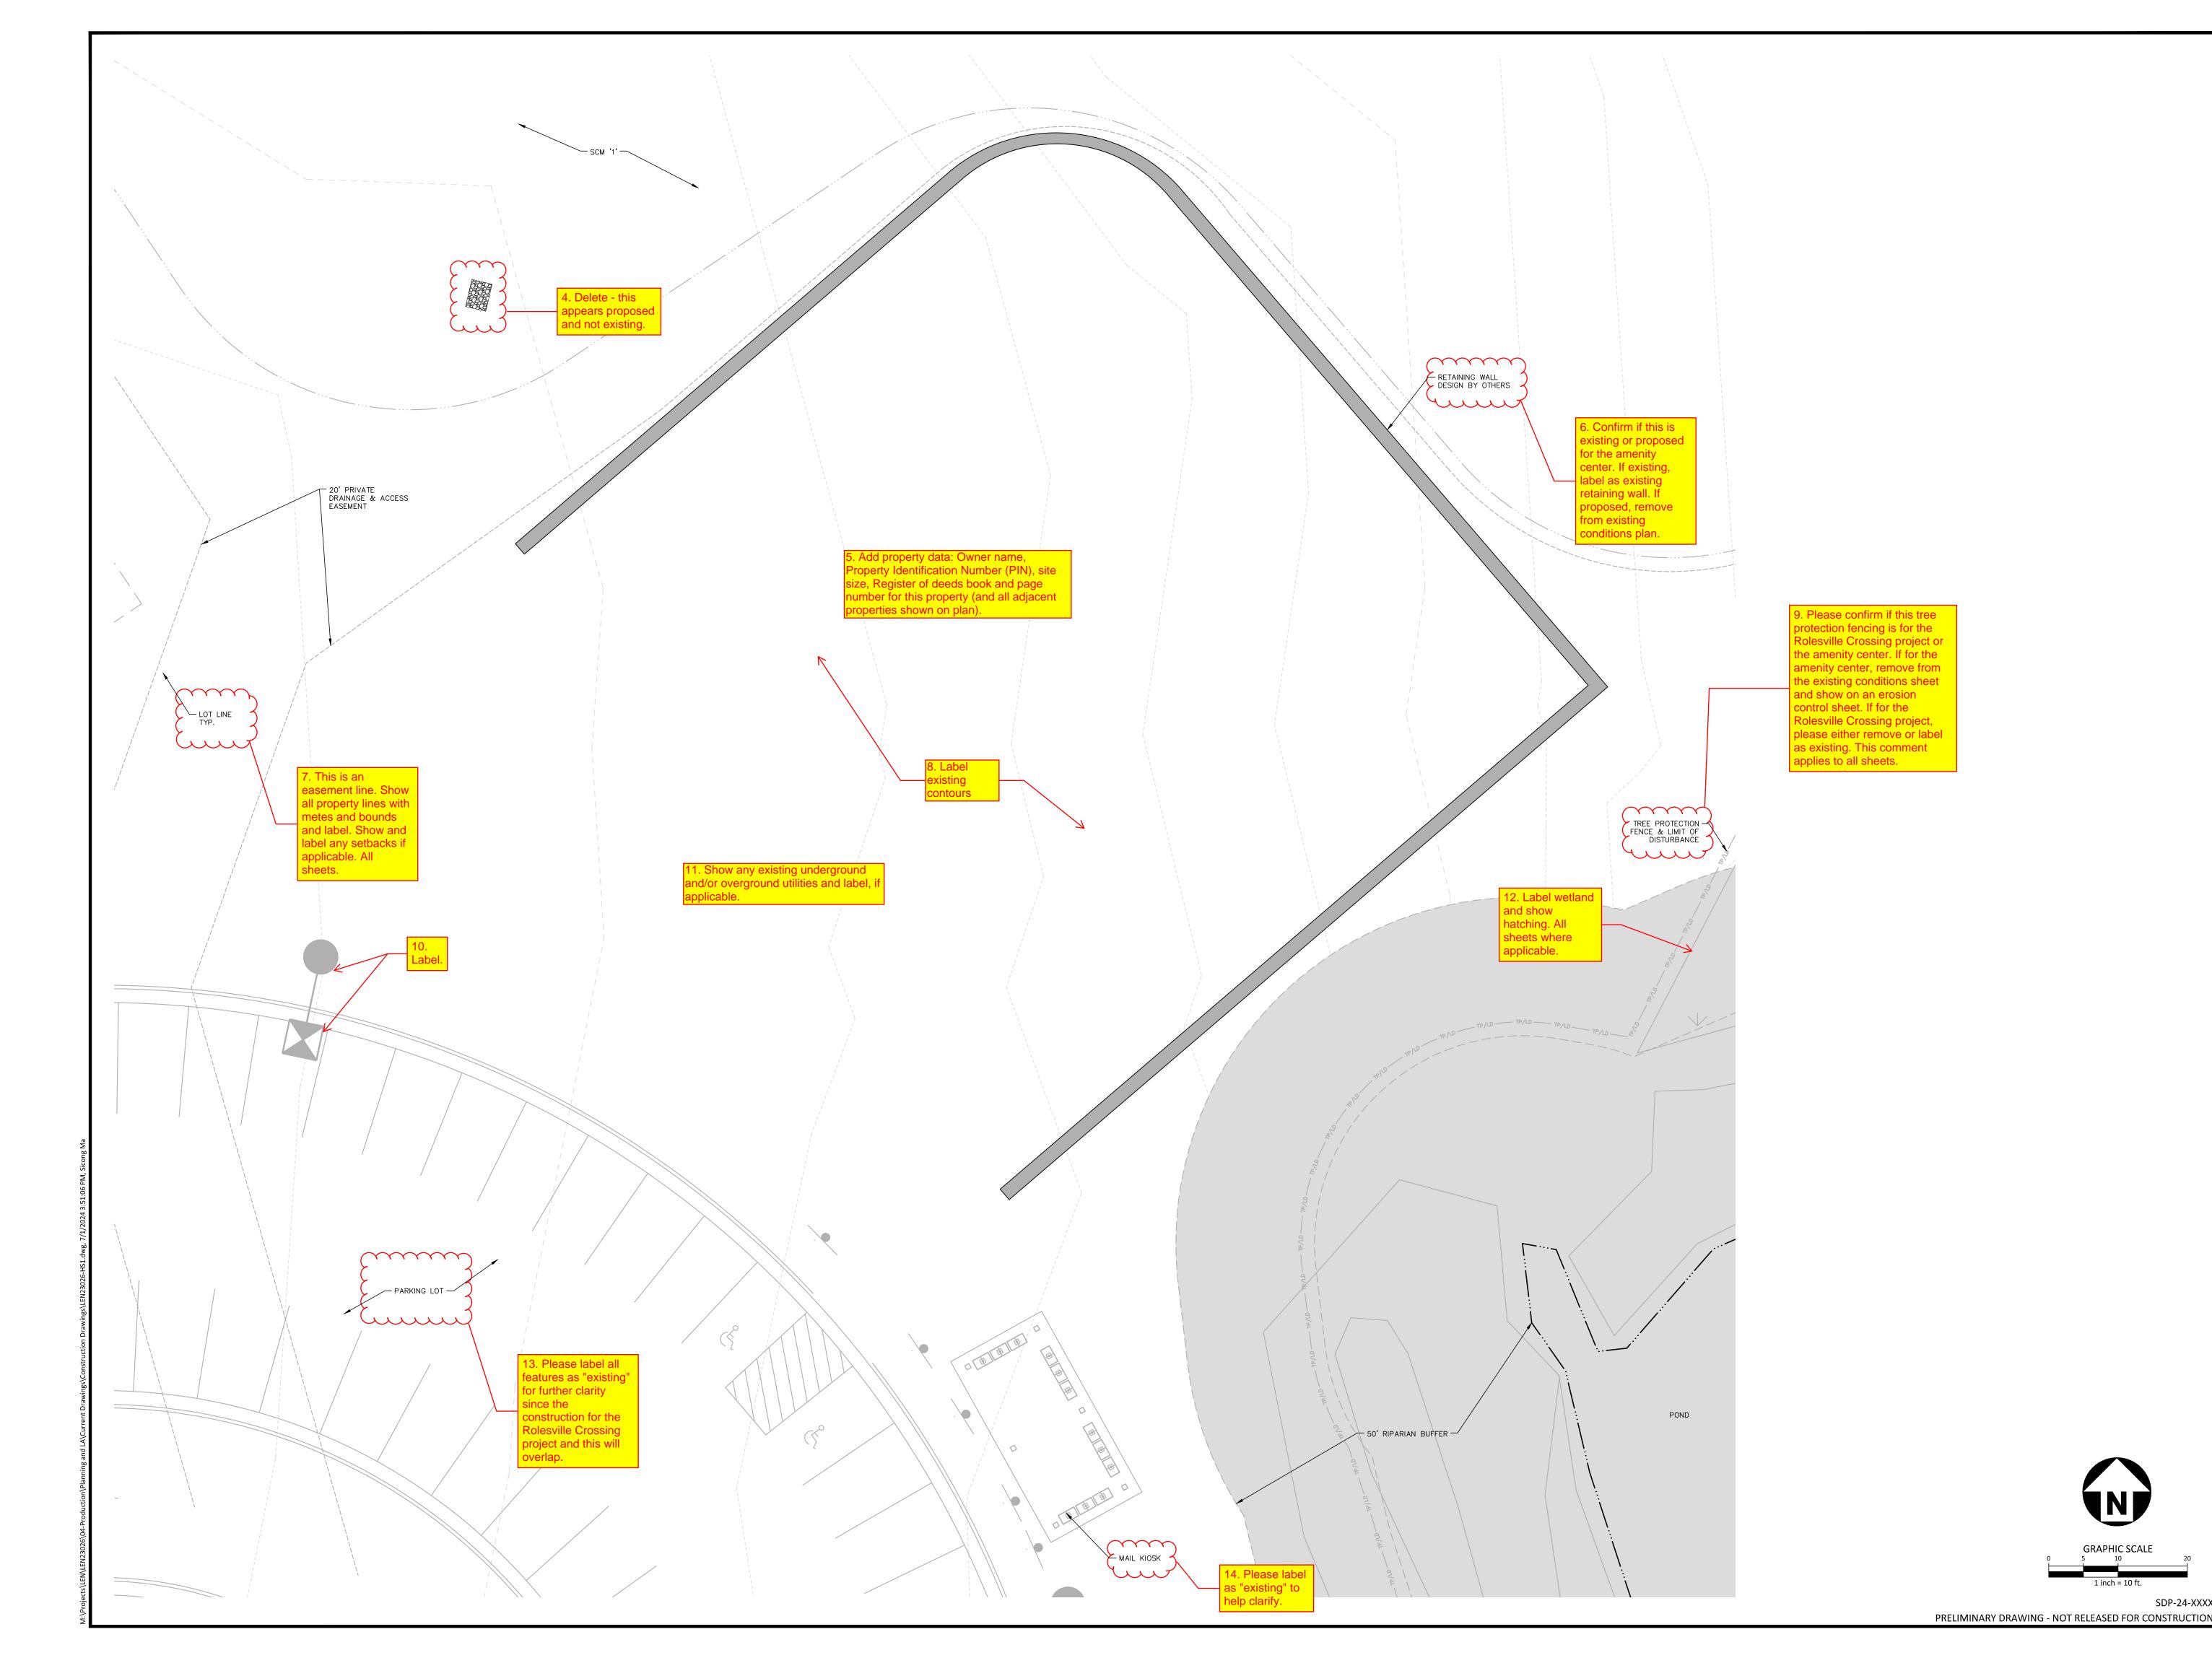



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CROSSING

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SVILLE RD ROLESVILLE (
AMENITY (
CONSTRUCTION
1801 ROLES
ROLESVILLE, P




REVISIONS

PLAN INFORMATION

PROJECT NO. LEN23026 FILENAME CHECKED BY DRAWN BY SCALE

DATE SHEET

AMENITY EXISTING CONDITION

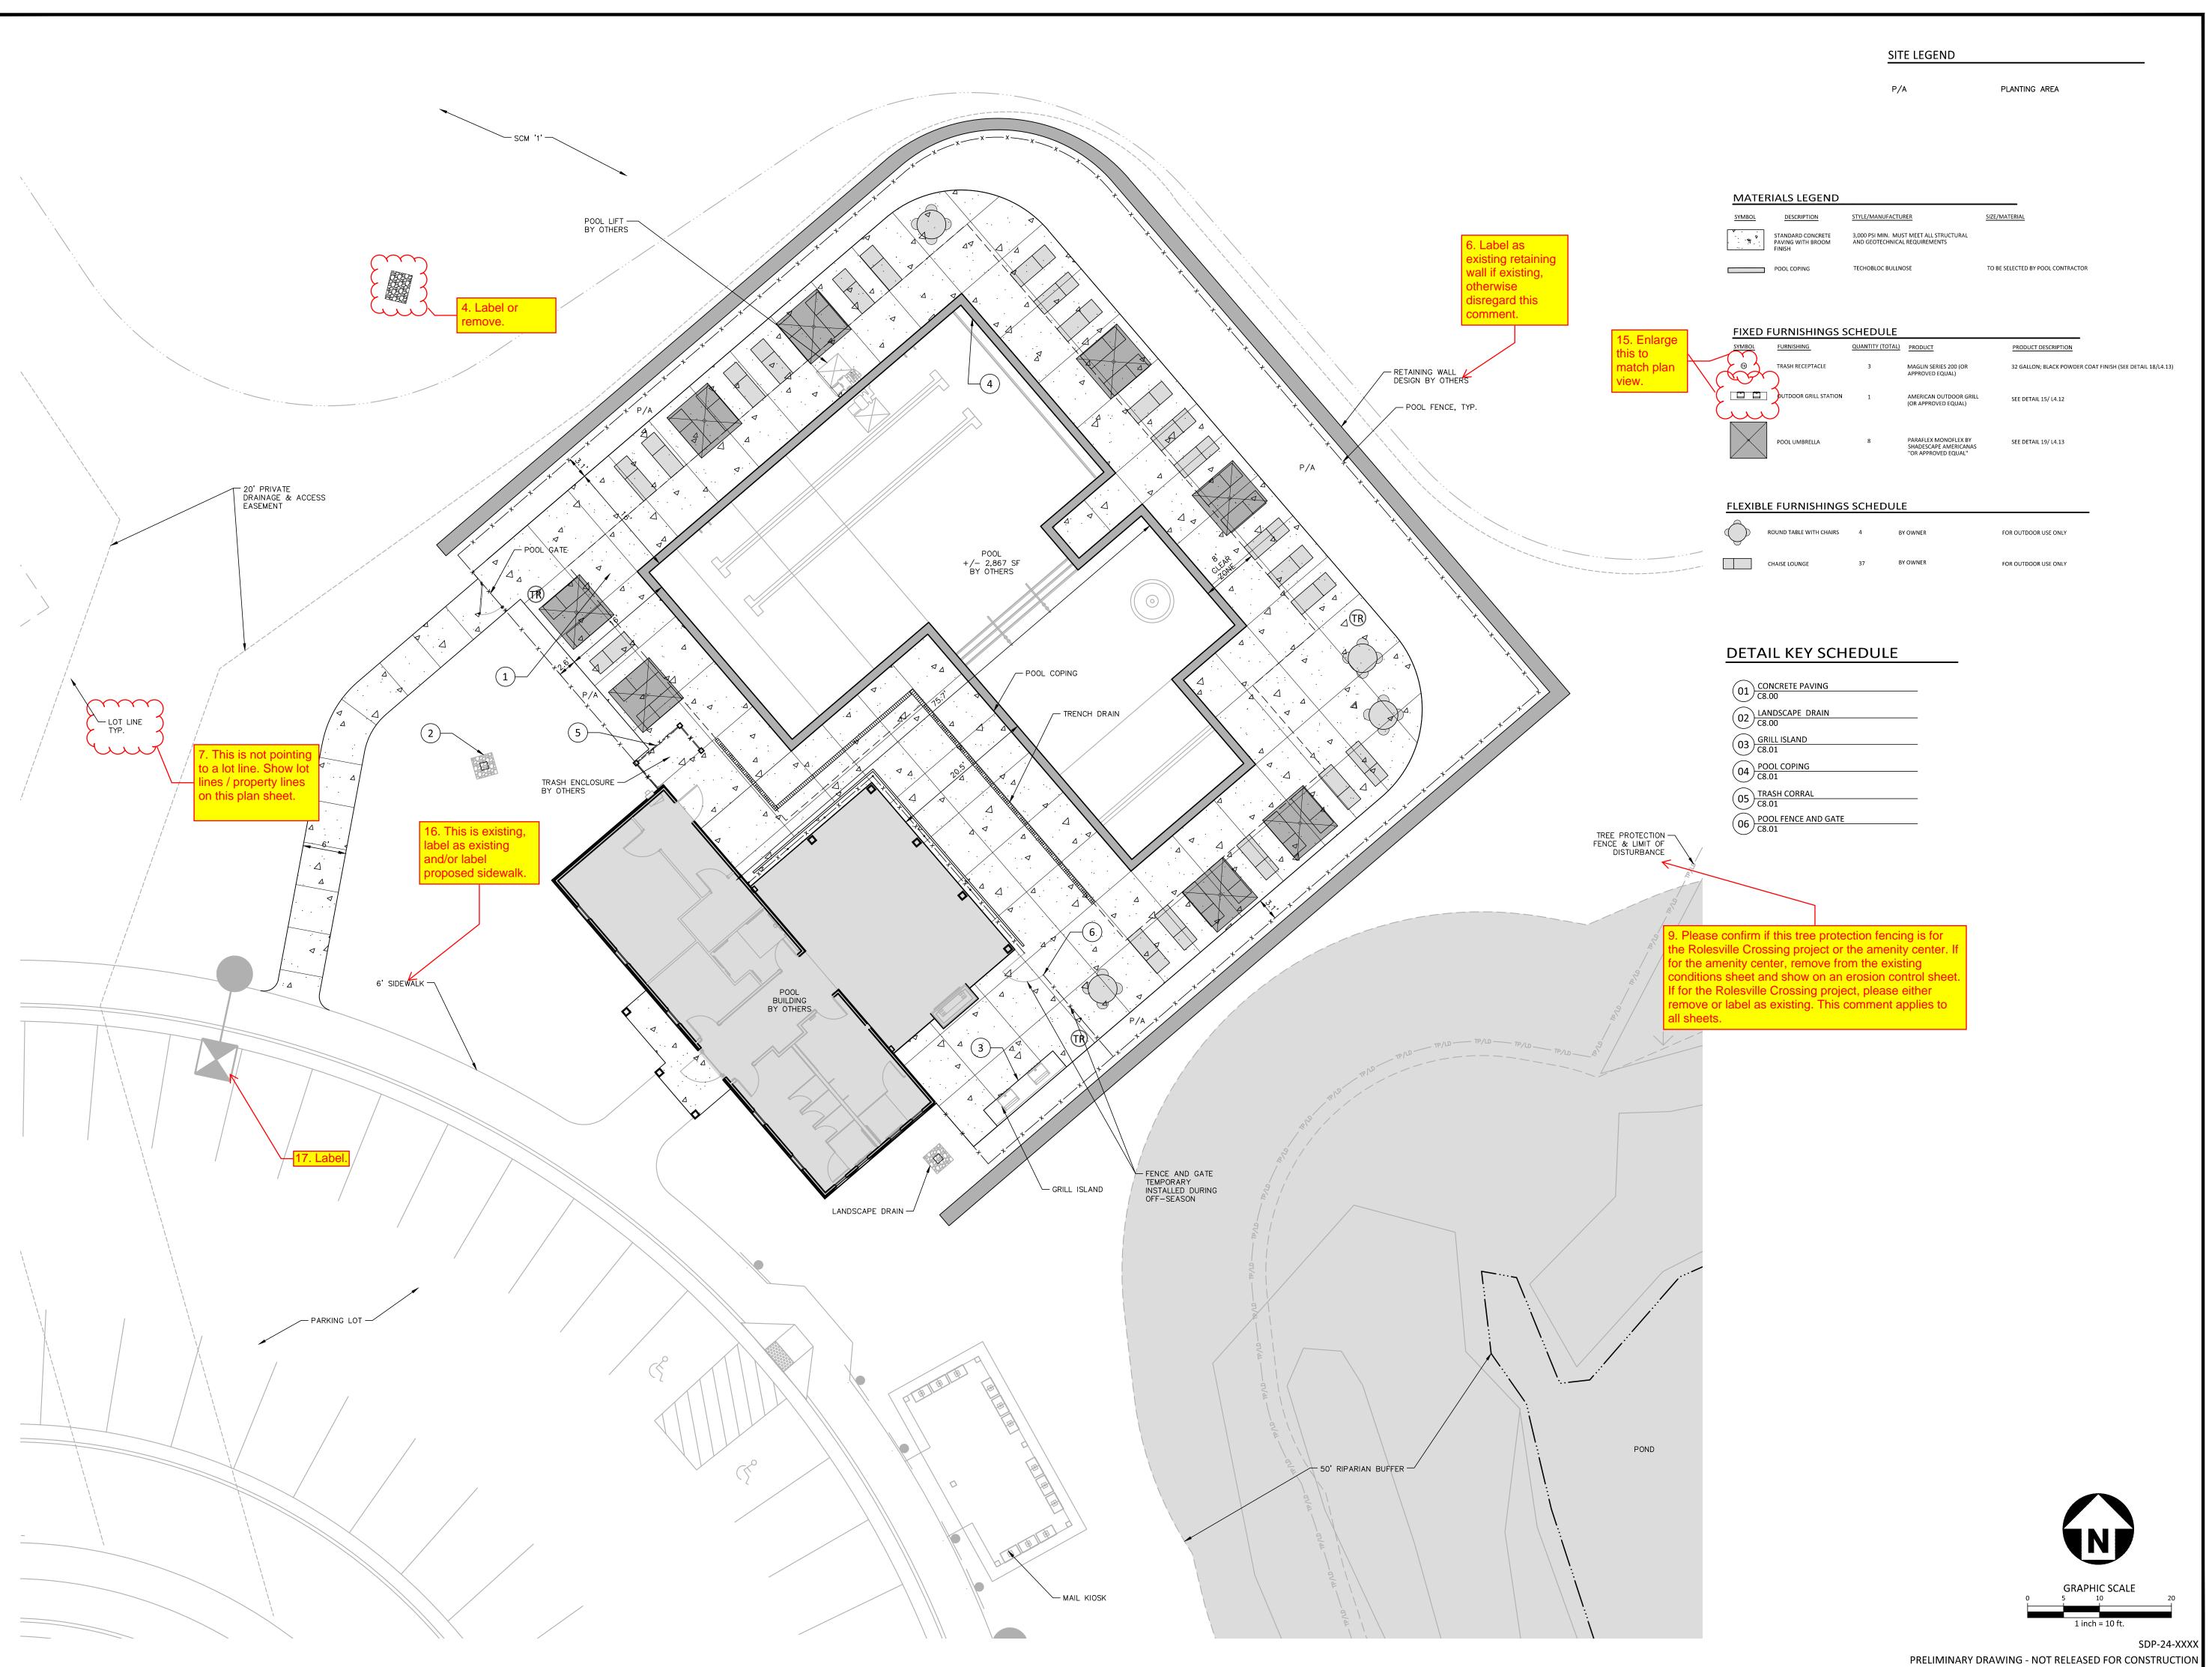



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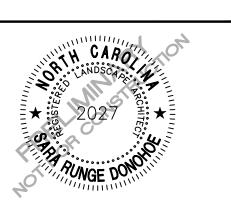
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OLESVILLE CROSSING
AMENITY CENTER
ONSTRUCTION DRAWINGS
1801 ROLESVILLE RD
ROLESVILLE, NC 27587



REVISIONS

NO. DATE

PLAN INFORMATION

PROJECT NO. LEN23026

FILENAME LEN23026-HS1

CHECKED BY SRD

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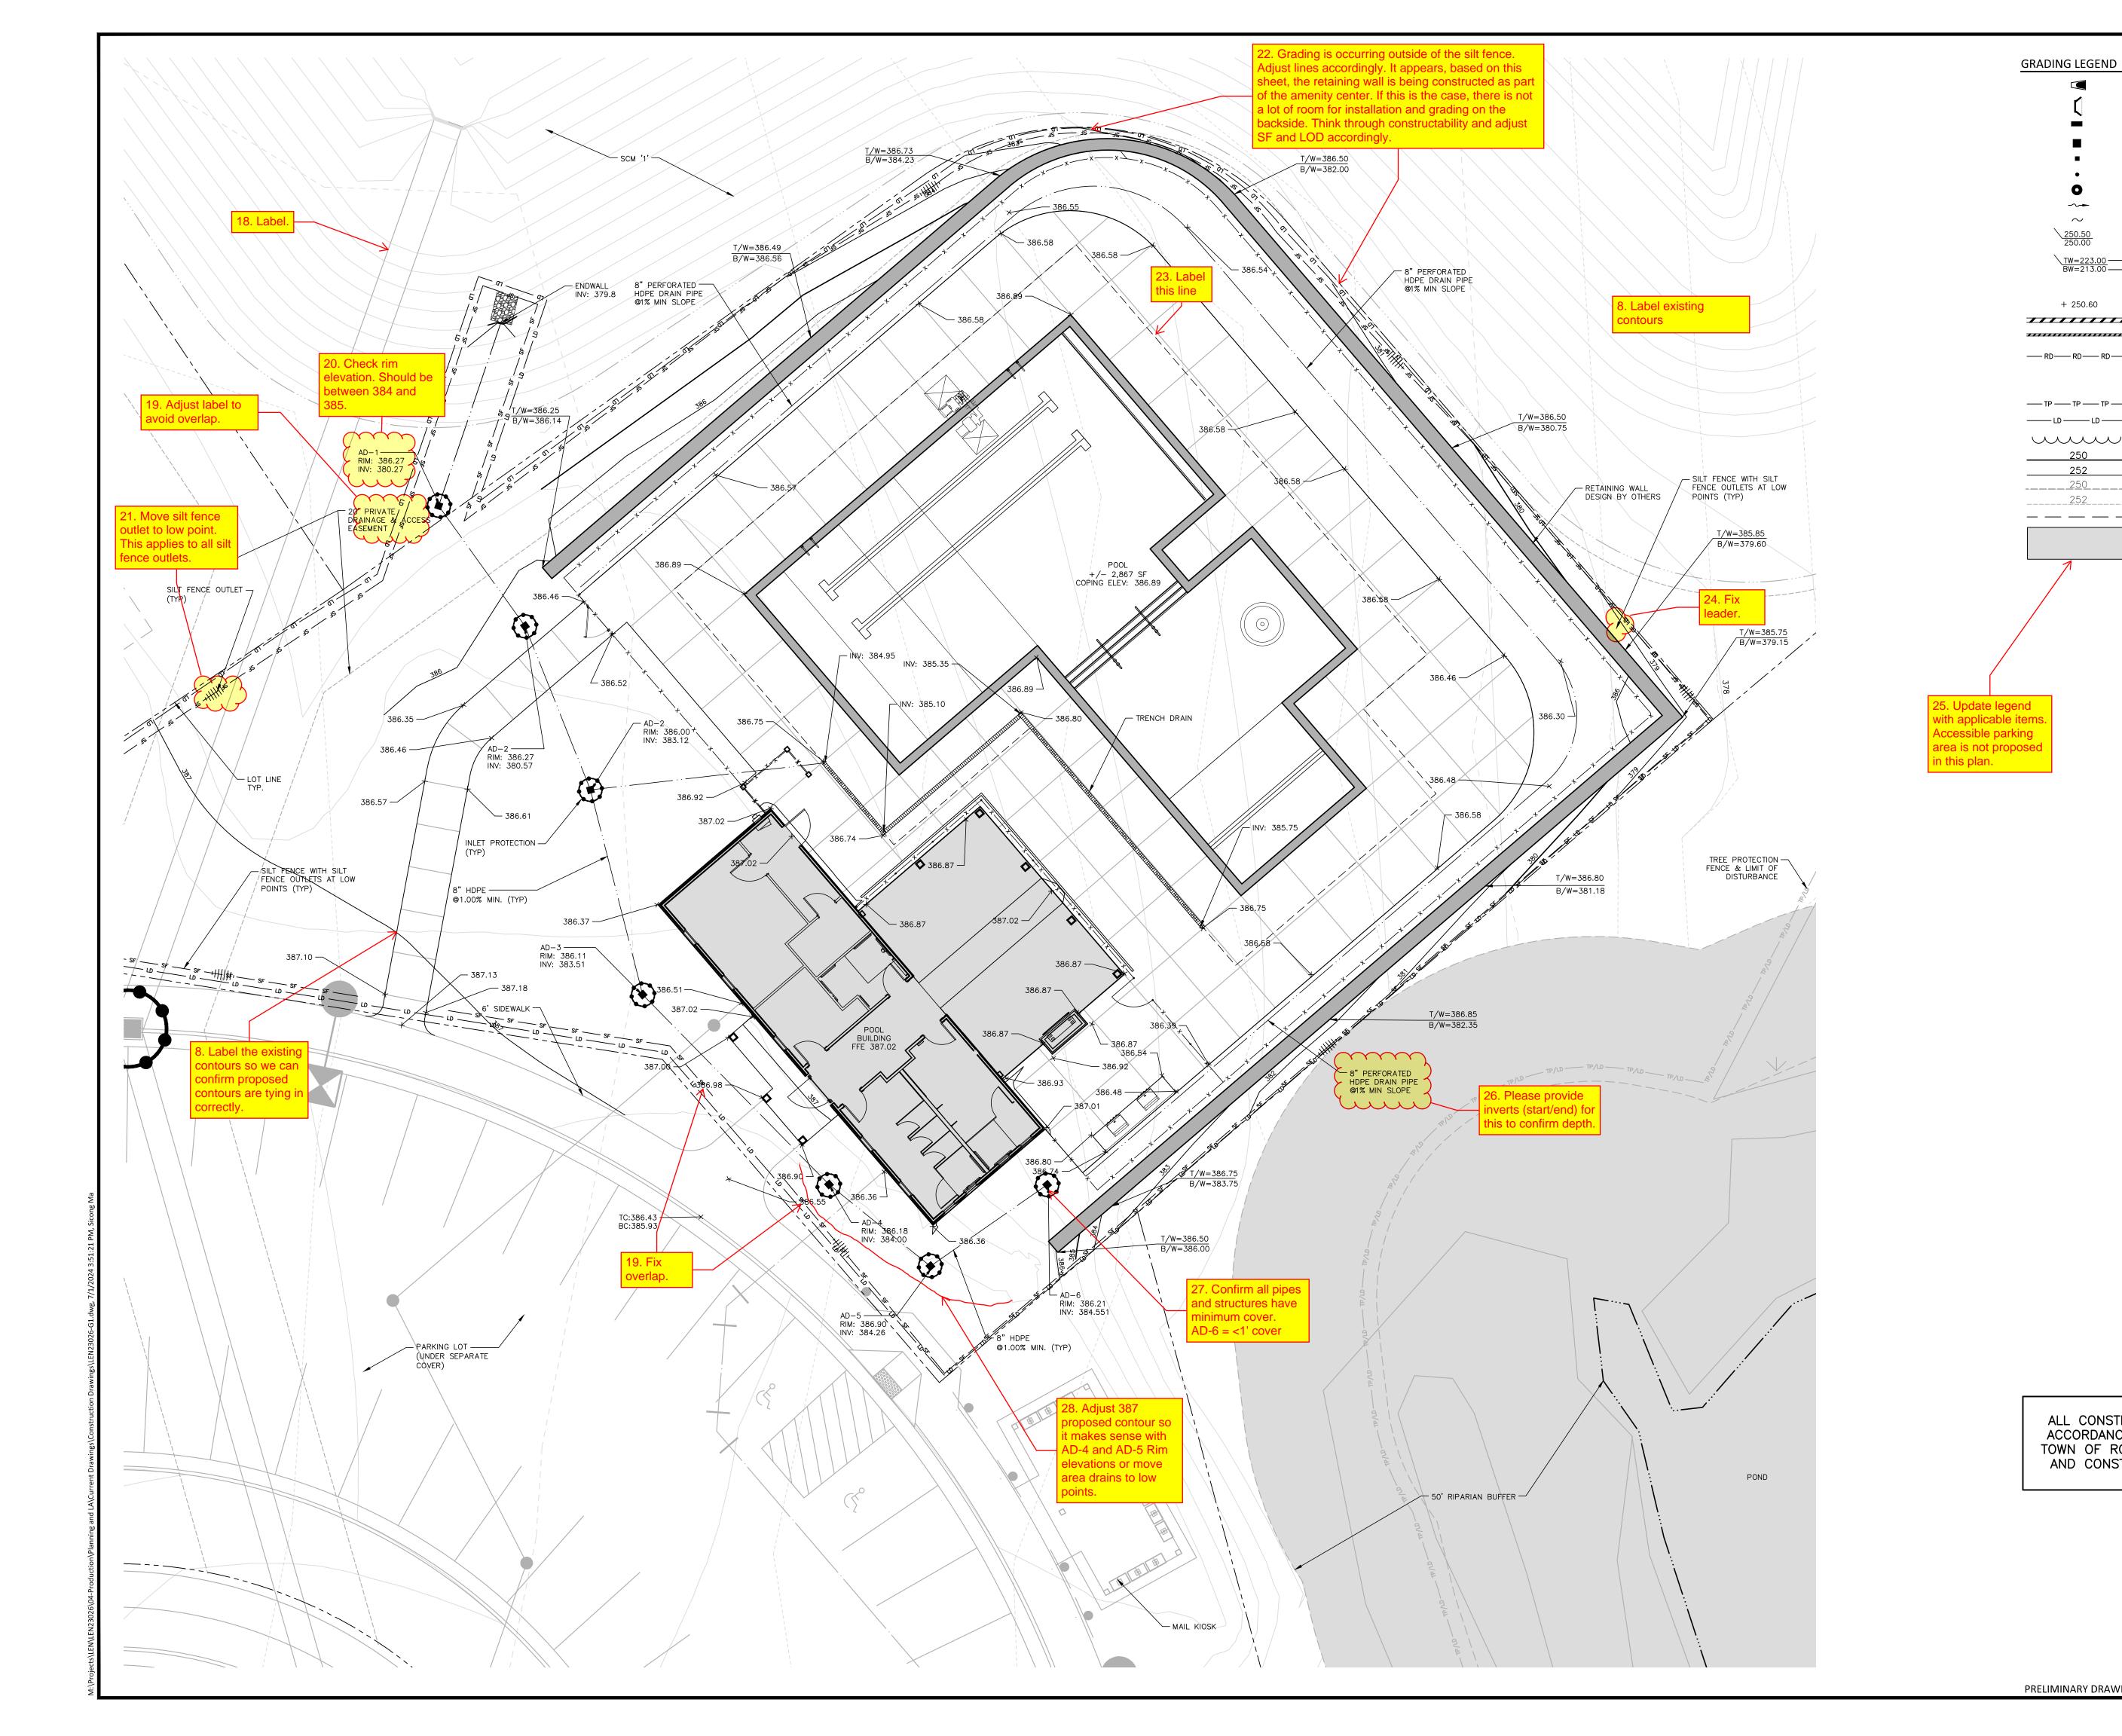
SCALE 1" = 10'

DATE 07.01.2024

DATE SHEET

AMENITY HARDSCAPE PLAN

C2.00





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> Raleigh, NC 27603 phone 919. 361. 5000 fax 919. 361. 2269

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FLARED END SECTION

STORM SERVICE INLET

DRAINAGE FLOW ARROW

LINE BREAK SYMBOL

STORM SERVICE ROOF-DRAIN

TOP & BOTTOM CURB ELEVATIONS

COVER PVC SCHEDULE 40 IN

EXISTING MINOR CONTOUR

ACCESSIBLE PARKING AREA
(2% MAX. SLOPE IN ALL DIRECTIONS)

ENDWALL SECTION

CATCH BASIN

DROP INLET

JUNCTION BOX

TW=223.00 — TOP OF WALL ELEVATION
BW=213.00 — BOTTOM OF WALL ELEVATION
(NOTE: BOTTOM OF WALL IS GROUND ELEVATION NOT WALL FOUNDATION)

TRAFFIC AREAS

____ MAJOR CONTOUR

+ 250.60 SPOT ELEVATION

— TP — TP — TP — TREE PROTECTION FENCE

EXISTING MAJOR CONTOUR

WOODED AREA

— — — EASEMENT LINE


252____

STORM DRAINAGE

STORM SERVICE LINE

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29. Label this sheet as

the Grading, Drainag and Erosion Control

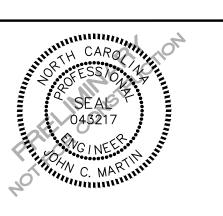lan if that is the

ALL CONSTRUCTION SHALL BE IN

ACCORDANCE WITH THE CURRENT

AND CONSTRUCTION STANDARDS.

TOWN OF ROLESVILLE ENGINEERING

PRELIMINARY DRAWING - NOT RELEASED FOR CONSTRUCTION

PLAN INFORMATION


PROJECT NO. LEN23026 LEN23026-G1 FILENAME CHECKED BY DRAWN BY

SCALE DATE

07.01.2024 SHEET

AMENITY GRADING PLAN

C3.00

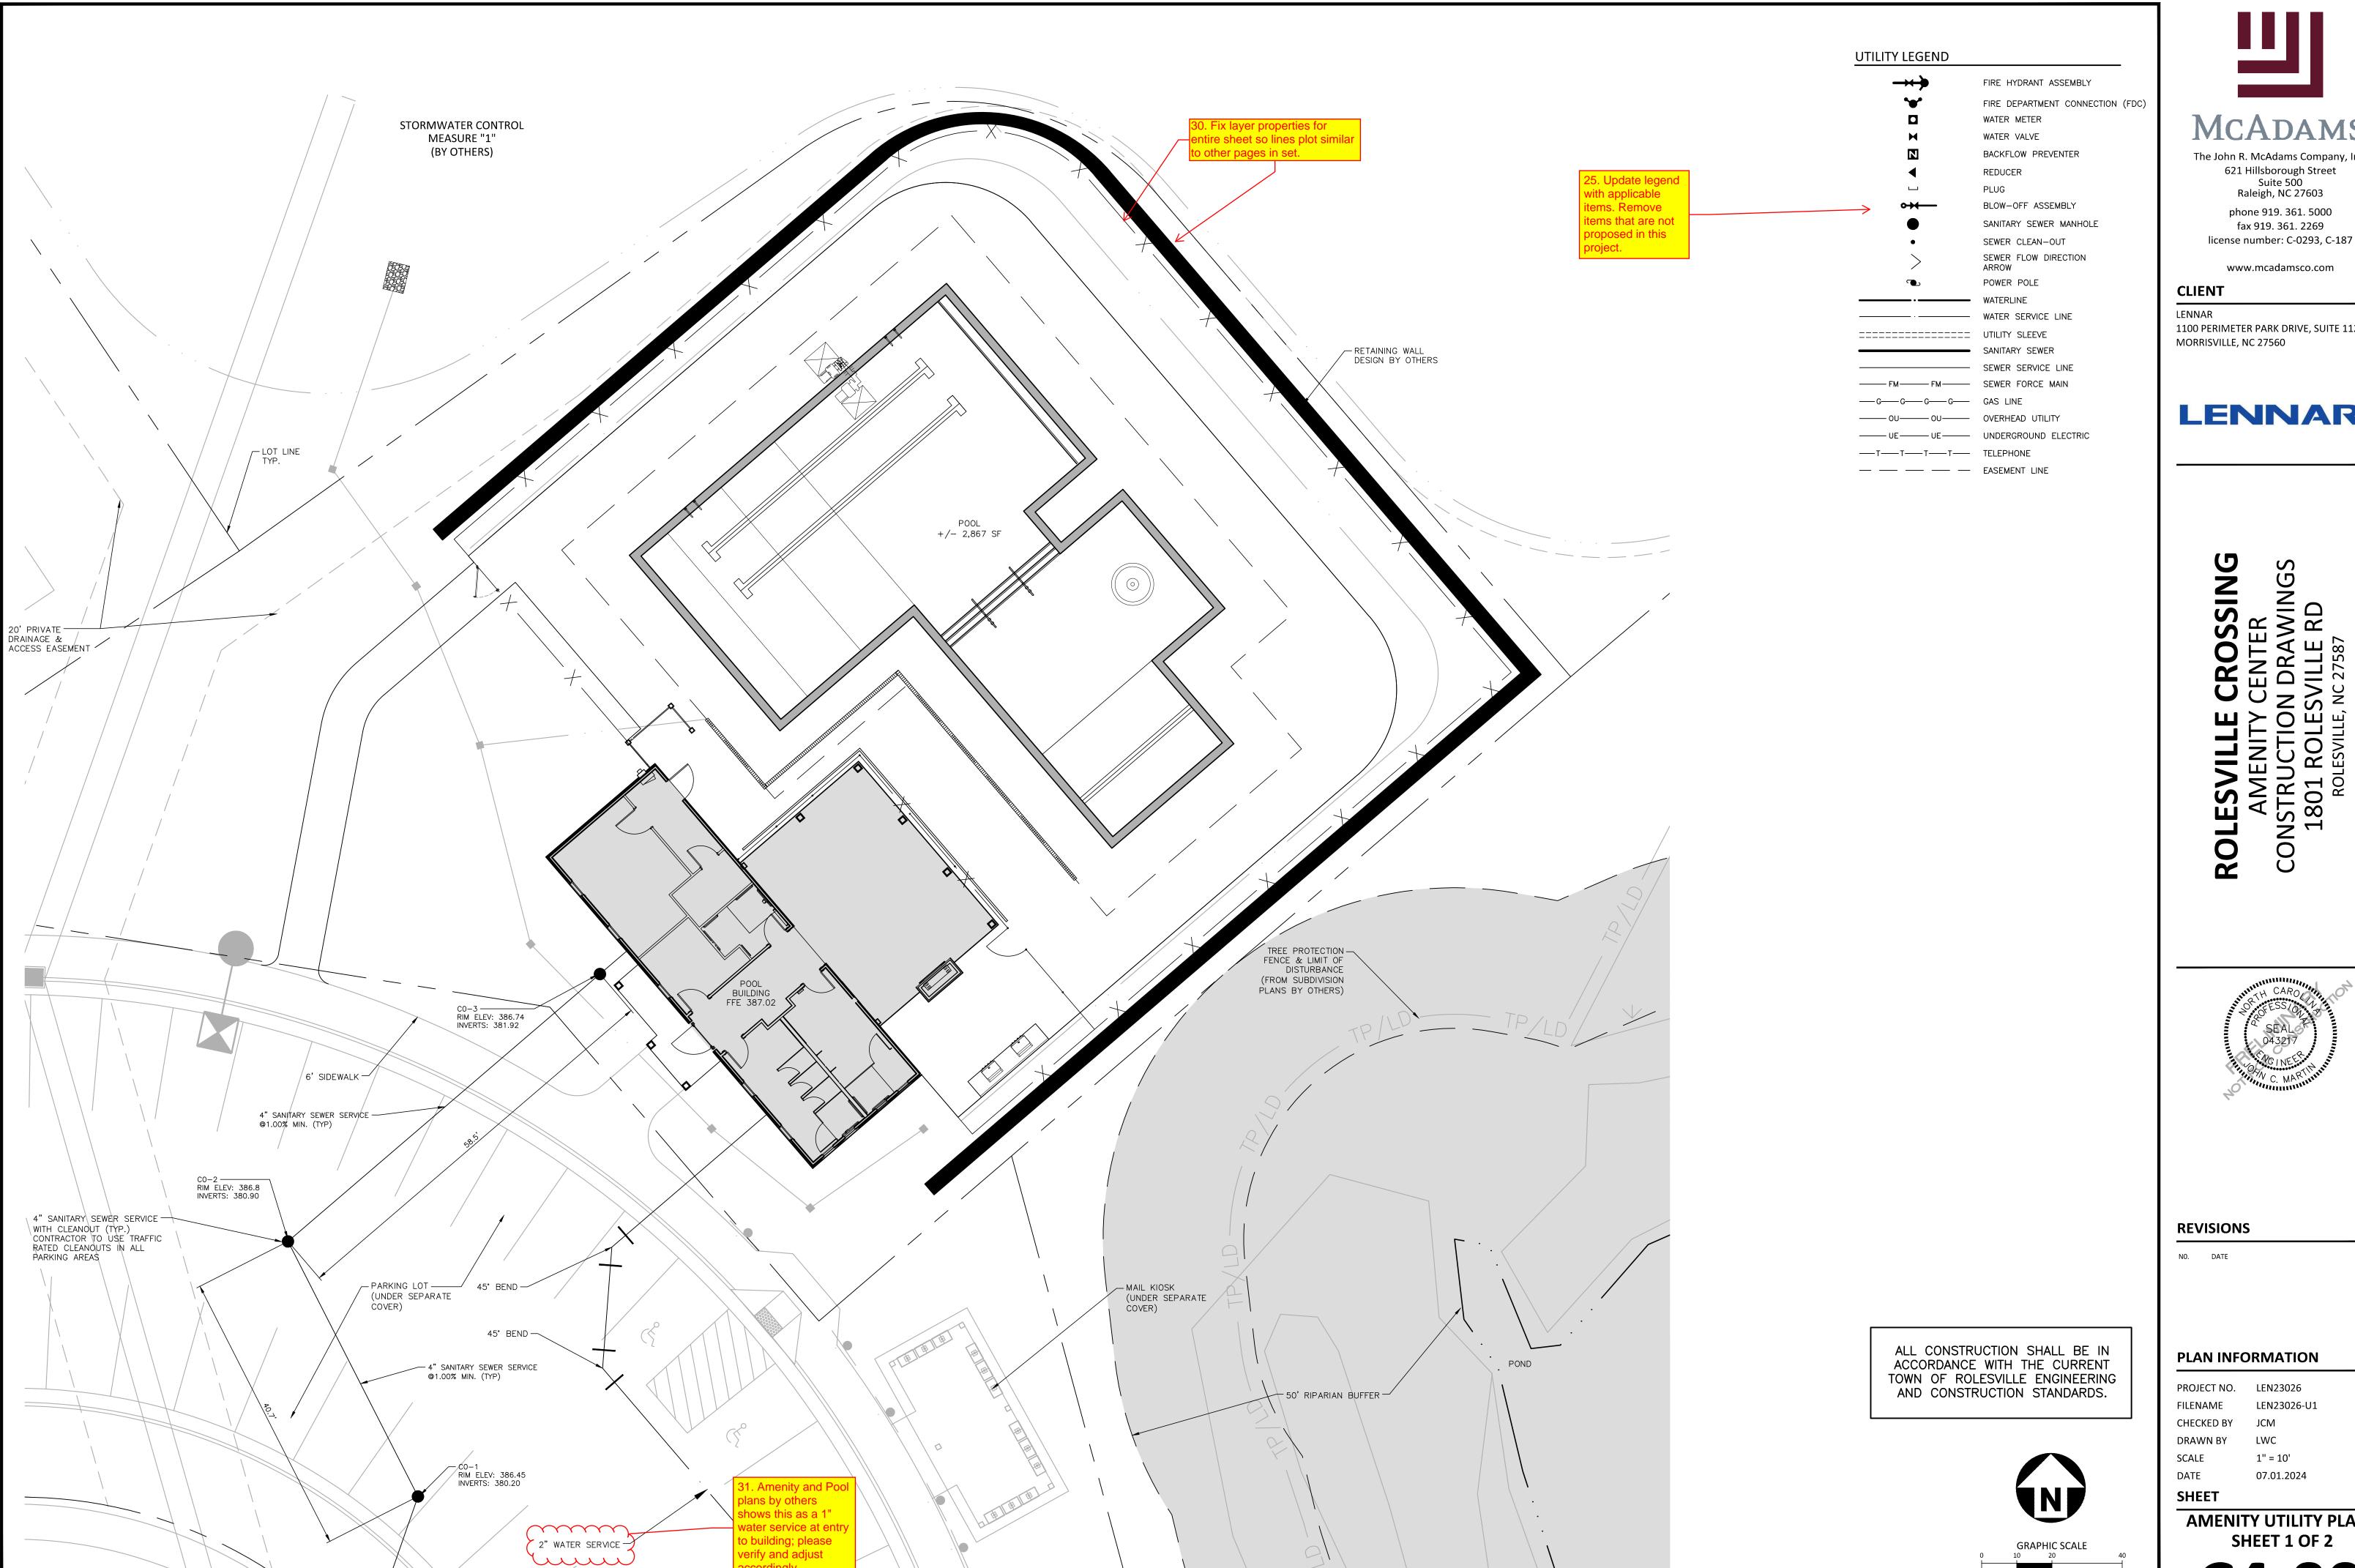




phone 919. 361. 5000 fax 919. 361. 2269

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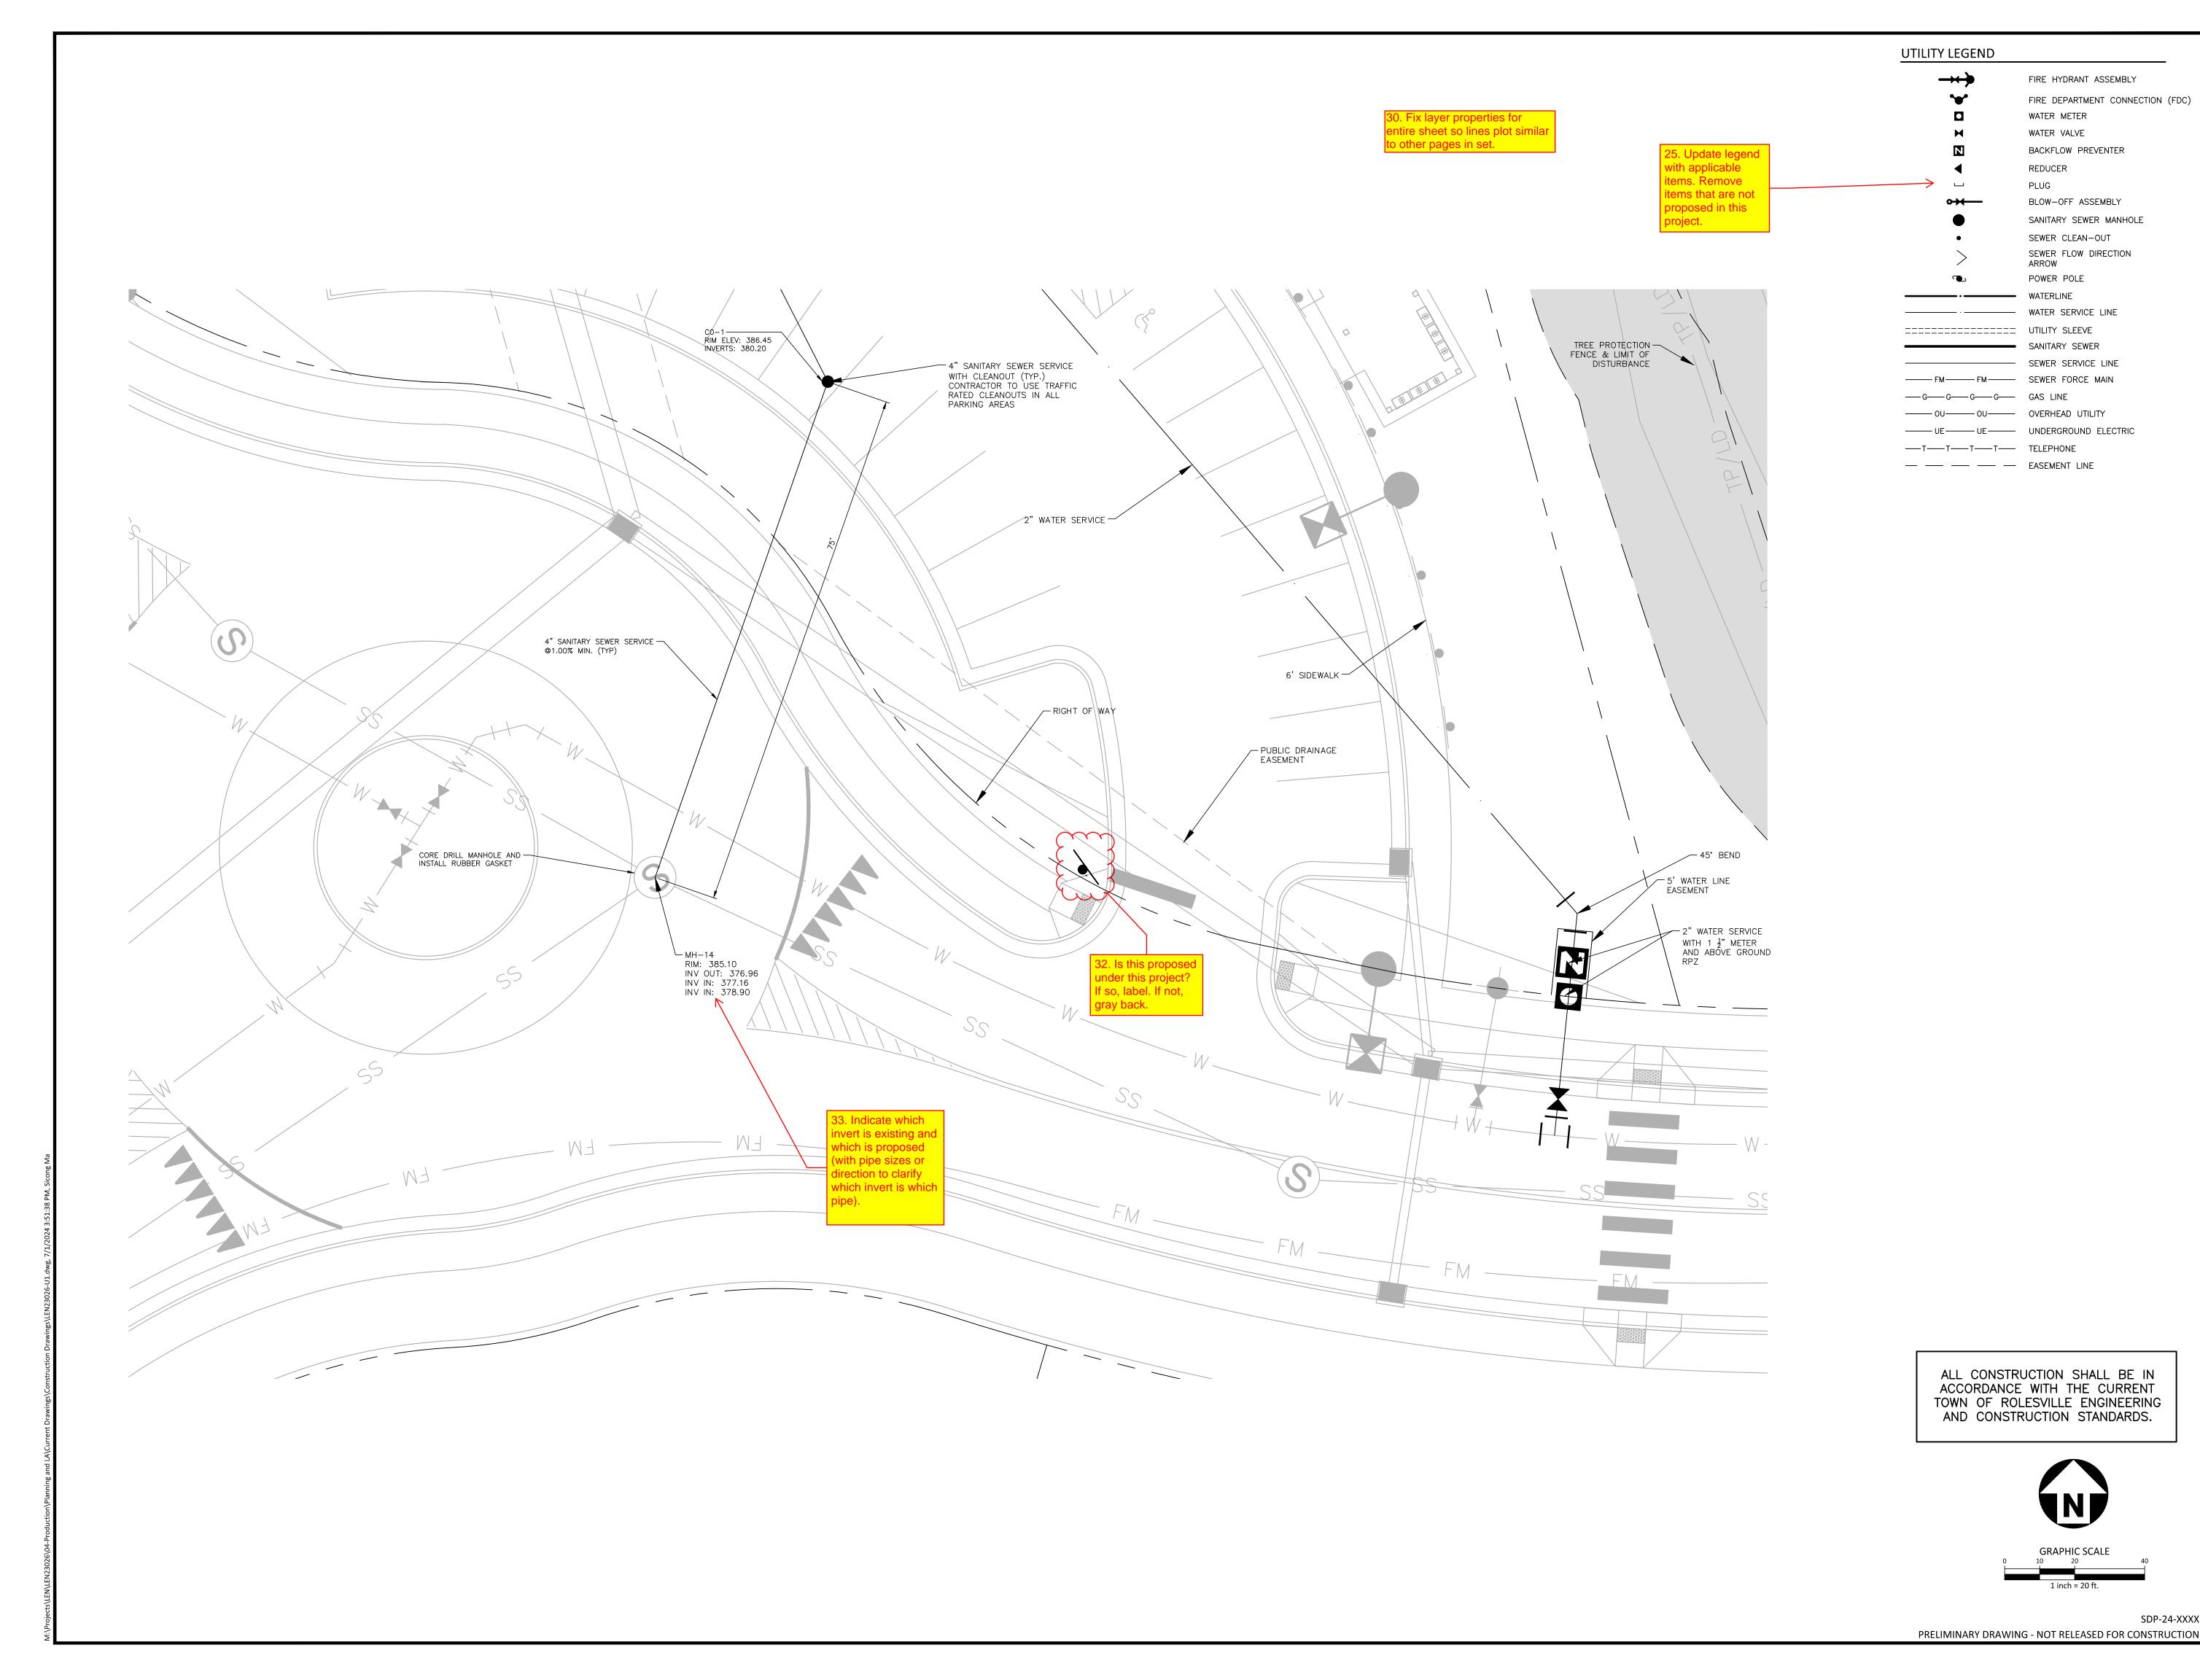
PLAN INFORMATION

PROJECT NO. LEN23026 LEN23026-U1 FILENAME CHECKED BY DRAWN BY 1" = 10'

PRELIMINARY DRAWING - NOT RELEASED FOR CONSTRUCTION

AMENITY UTILITY PLAN -SHEET 1 OF 2

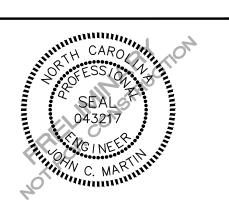07.01.2024





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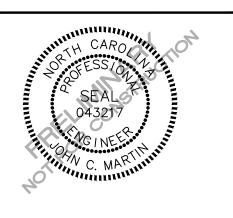
CLIENT

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NO. DATE

PLAN INFORMATION


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DRAWN BY SCALE 1" = 10' DATE 07.01.2024


SHEET

SDP-24-XXXX

AMENITY UTILITY PLAN -SHEET 2 OF 2

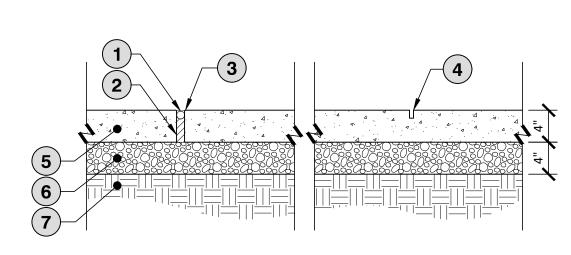

- (1) BACKER ROD (STRAIGHT JOINTS ONLY)
- (2) SEAL PREFORMED FIBER EXPANSION JOINT WITH COLORED JOINT SEALANT/CAULK. COLOR SHALL MATCH ADJACENT CONCRETE AND BE APPROVED BY OWNER'S REPRESENTATIVE
- (3) TOOLED EDGE (1/8" RADIUS)
- (4) SCORE JOINT (TYP) SAW CUT MINIMUM 1/4 DEPTH OF PAVEMENT
- (5) ADJACENT PAVING OR VERTICAL SURFACE
- (6) COMPACTED BASE COURSE MEETING STRUCTURAL AND GEOTECHNICAL REQUIREMENTS
- (7) COMPACTED SUBGRADE MEETING GEOTECHNICAL AND STRUCTURAL REQUIREMENTS

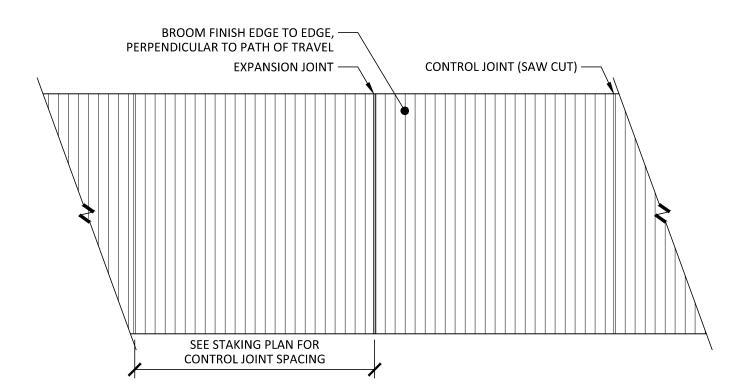

NOTES:


- 1. EXPANSION JOINTS SHALL BE INSTALLED WHERE CONCRETE PAVEMENT ABUTS ALL VERTICAL SURFACES INCLUDING BUT NOT LIMITED TO ALL BUILDINGS, STRUCTURES, STAIRS, CURBS, COLUMNS, WALLS, LIGHT POLES, ETC.
- 2. WHERE WALK ABUTS RIGID STRUCTURE, JOINT SHALL BE WATERTIGHT.
- 3. PROVIDE EXPANSION JOINTS @ 30' O.C. MAX UNLESS OTHERWISE SHOWN/ REQUIRED. (SEE MATERIALS & STAKING PLAN)
- 4. CONTROL JOINT SPACING SHALL BE EQUAL TO SIDEWALK WIDTH BUT IN NO INSTANCE EXCEED 6' SEE MATERIALS & STAKING PLAN FOR ALL OTHER
- 5. SAW CUT TO A MIN. 1/4 DEPTH OF PAVEMENT. CONTRACTOR TO CLOSELY COORDINATE LOCATIONS AND DESIGNS PRIOR TO AND DURING CONSTRUCTION.
- 6. ALL CONCRETE SHALL BE 3,000 PSI UNLESS


JOINT SPACING

OTHERWISE REQUIRED BY PROJECT SPECIFICATIONS.

- 7. CONCRETE AND BASE DEPTH TO BE VERIFIED BY GEOTECHNICAL ENGINEER. DEPTHS MAY BE MODIFIED TO MEET ALL LOADING REQUIREMENTS.
- 8. REFER TO STRUCTURAL FOR CONCRETE REINFORCEMENT.
- 9. REFER TO DETAILED LAYOUT PLAN FOR SIDEWALK LOCATIONS, TYPES AND WIDTHS.
- 10. REFER TO DETAILED LAYOUT PLAN FOR SPECIFIC JOINT LOCATIONS AND SPACING.
- 11. USE THIS DETAIL FOR TYPICAL JOINT SPACING WHEN NO SPECIFIC JOINT SPACING IS INDICATED ON PLANS.
- 12. MAXIMUM SIDEWALK CROSS-SLOPE IS 2%.


O1 TYPICAL CONCRETE SIDEWALK SCALE: 1" = 1'-0"

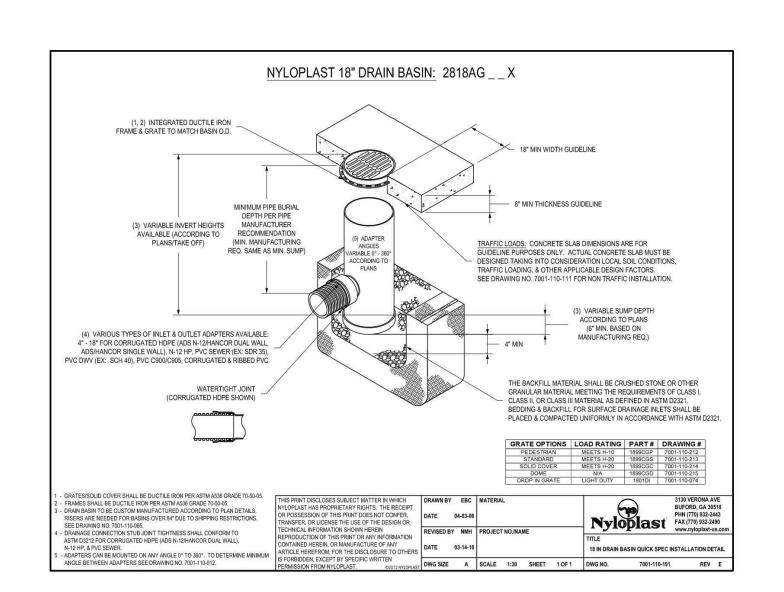


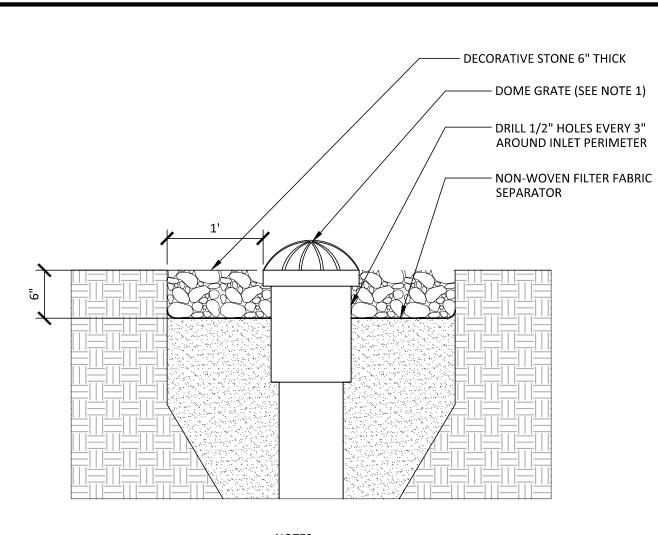

1. SEE MATERIAL & PLANTING SCHEDULE FOR GRATE INFO 2. FOLLOW MANUFACTURERS GUIDELINES FOR MATERIAL REQUIREMENTS AND INSTALLATION METHODS. 3. SEE GRADING PLAN FOR ALL GRATE AND PIPE SIZES

02 LANDSCAPE DRAIN INLET WITH DOME GRATE SCALE: 1" = 1'-0"

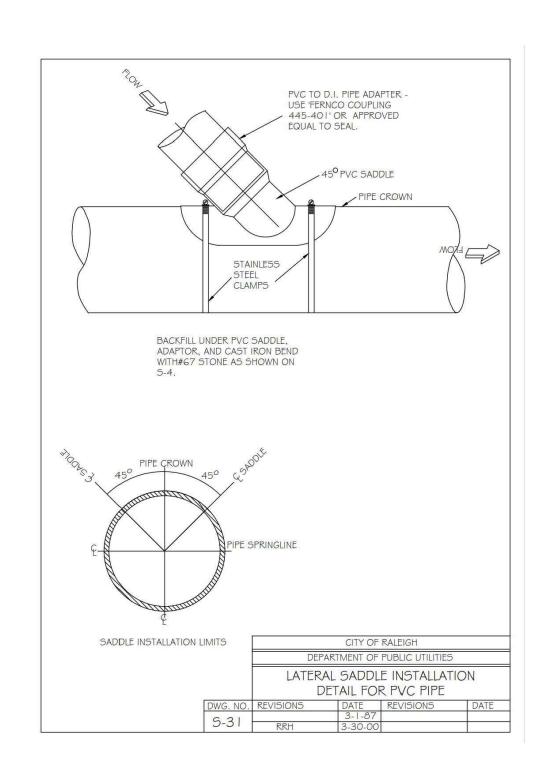


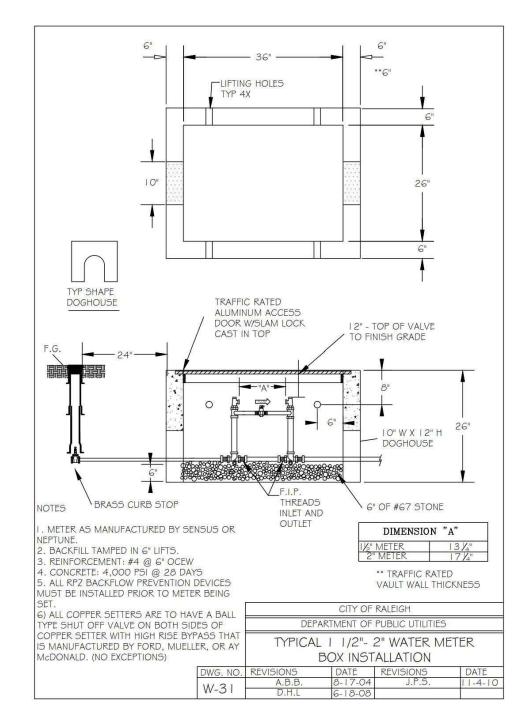



Section 2721 **Engineered Surface Drainage Products** PVC surface drainage inlets shall include the drain basin type as indicated on the contract drawing and referenced within the contract specifications. The ductile iron grates for each of these fittings are to be considered an integral part of the surface drainage inlet and shall be furnished by the same manufacturer. The surface drainage inlets shall be as manufactured by Nyloplast a division of Advanced Drainage Systems, Inc., or prior approved equal. The drain basins required for this contract shall be manufactured from PVC pipe stock, utilizing a thermoforming process to reform the pipe stock to the specified configuration. The drainage pipe connection stubs shall be manufactured from PVC pipe stock and formed to provide a watertight connection with the specified pipe system. This joint tightness shall conform to ASTM D3212 for joints for drain and sewer plastic pipe using flexible elastomeric seals. The flexible elastomeric seals shall conform to ASTM F477. The pipe bell spigot shall be joined to the main body of the drain basin or catch basin. The raw material used to manufacture the pipe stock that is used to manufacture the main body and pipe stubs of the surface drainage inlets shall conform to ASTM D1784 cell class 12454. The grates and frames furnished for all surface drainage inlets shall be ductile iron for sizes 8", 10", 12", 15", 18", 24" and 30" and shall be made specifically for each basin so as to provide a round bottom flange that closely matches the diameter of the surface drainage inlet. Grates for drain basins shall be capable of supporting various wheel loads as specified by Nyloplast, 12" and 15" square grates will be hinged to the frame using pins. Ductile iron used in the manufacture of the castings shall conform to <u>ASTM A536 grade 70-50-05</u>. Grates and covers shall be provided painted black. The specified PVC surface drainage inlet shall be installed using conventional flexible pipe backfill materials and procedures. The backfill material shall be crushed stone or other granular material meeting the requirements of class 1, class 2, or class 3 material as defined in ASTM D2321. Bedding and backfill for surface drainage inlets shall be well placed and compacted uniformly in accordance with ASTM D2321. The drain basin body will be cut at the time of the final grade. No brick, stone or concrete block will be required to set the grate to the final grade height. For load rated installations, a concrete slab shall be poured under and around the grate and frame. The concrete slab must be designed taking into consideration local soil conditions, traffic loading, and other applicable design factors. For other installation considerations such as migration of fines, ground water, and soft foundations refer to ASTM D2321 guidelines.


THIS PRINT DISCLOSES SUBJECT MATTER IN WHICH DRAWN BY CJA MATERIA


NYLOPLAST HAS PROPRIETARY RIGHTER IN WHILE IN WHILE IN THE RECEIPT OR POSSESSION OF THIS PRINT DOES NOT CONFER, TRANSED OR LOCALISE THE LIFE OF THE DESIGN OF

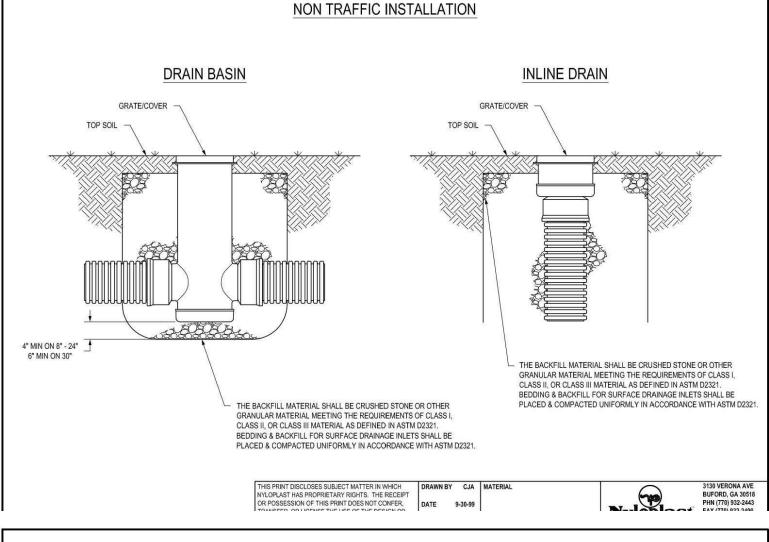


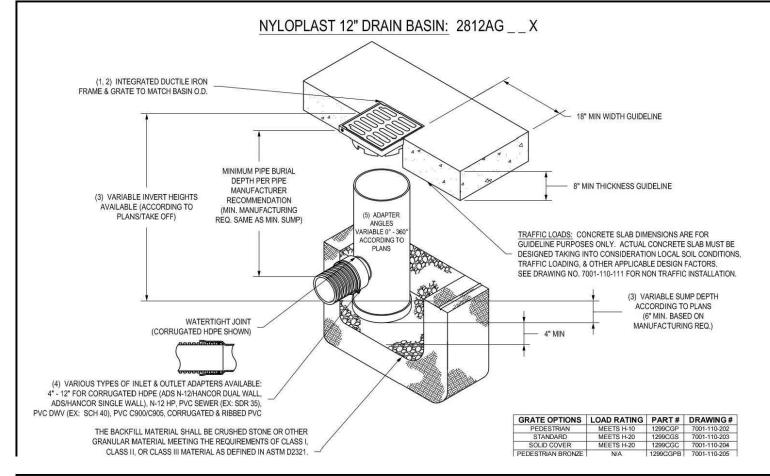

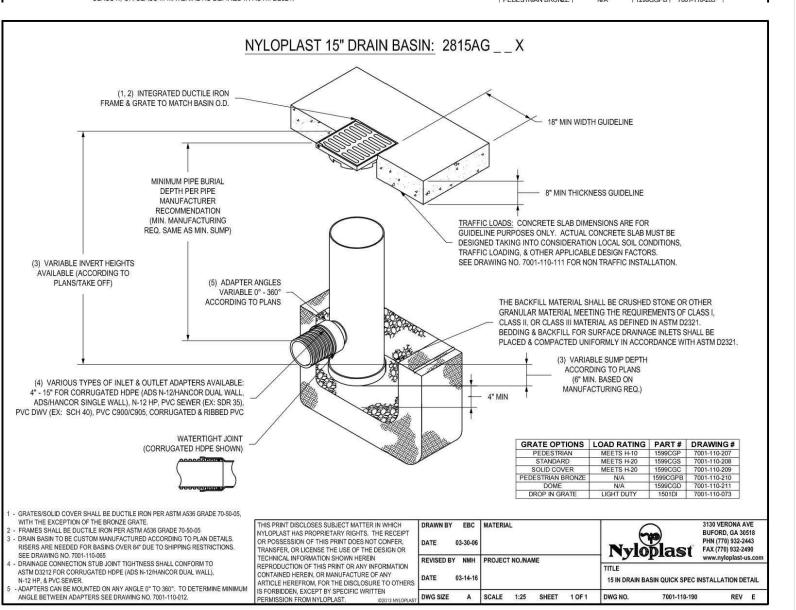

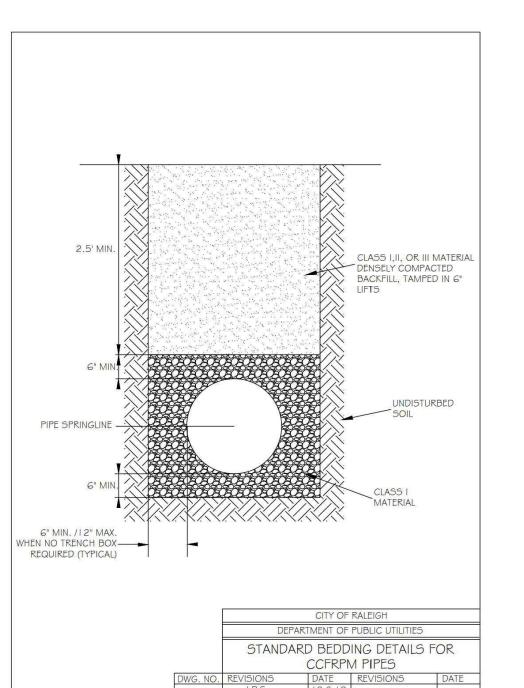

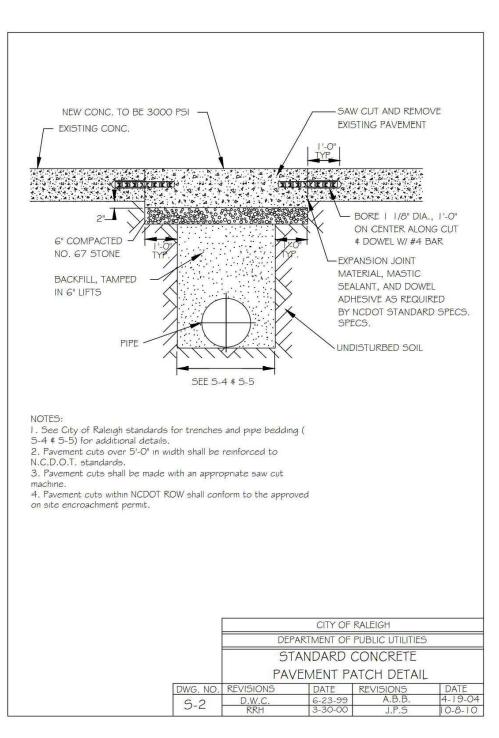

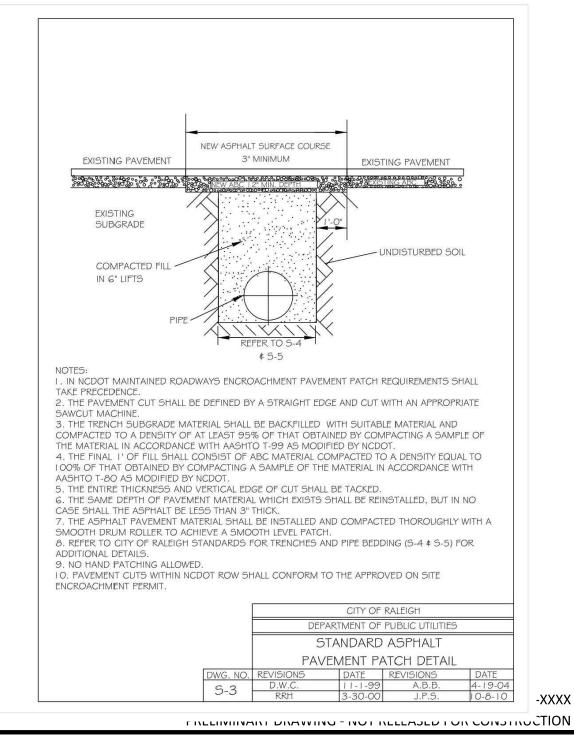



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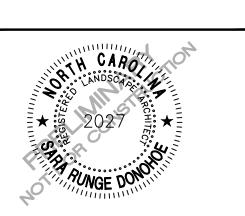
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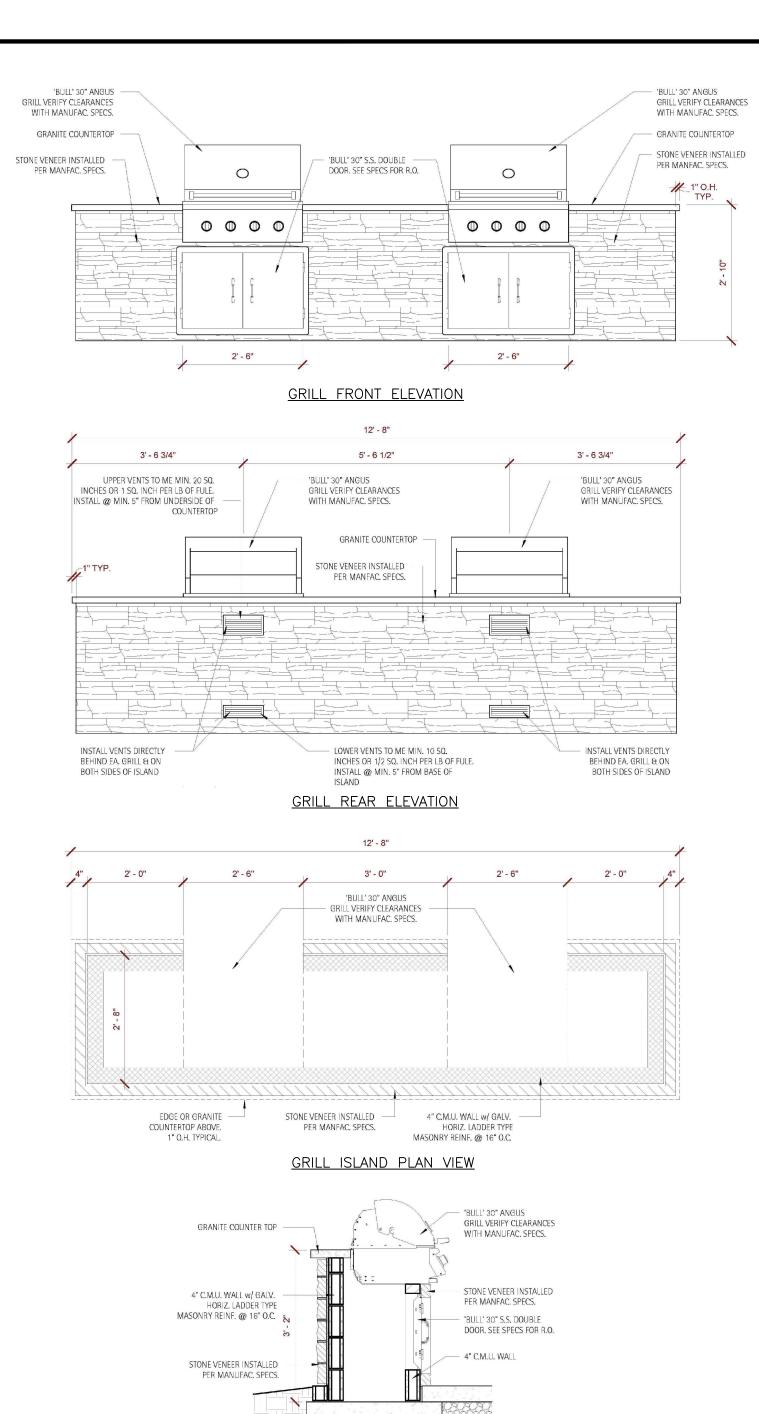
NO. DATE


PLAN INFORMATION

PROJECT NO. LEN23026 FILENAME LEN23026-D1 CHECKED BY SRD **DRAWN BY SCALE** AS SHOWN 07.01.2024

SHEET


SITE AND UTILITY DETAILS




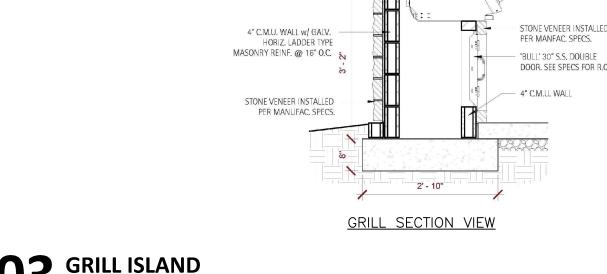

GRILL ISLAND


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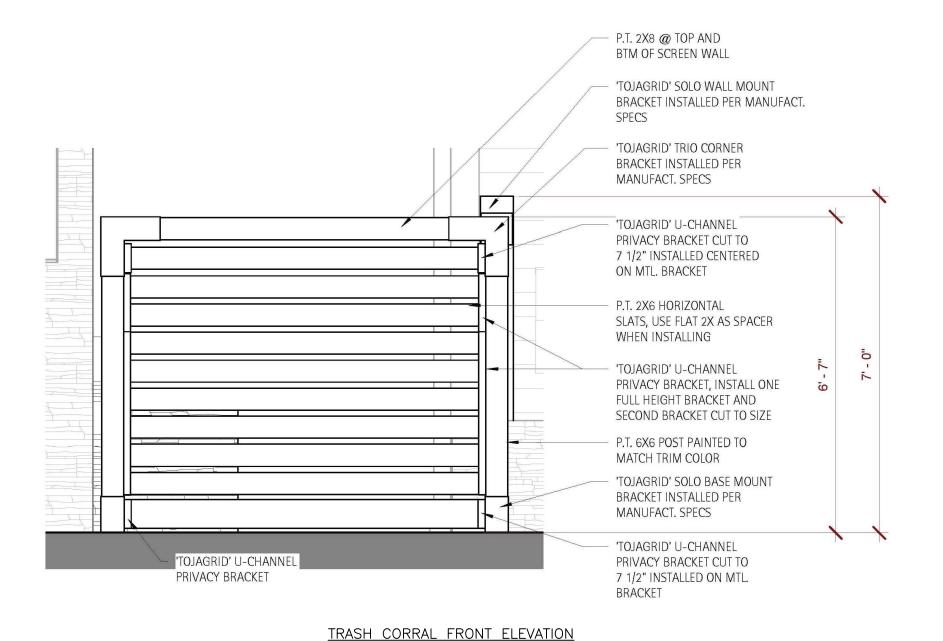


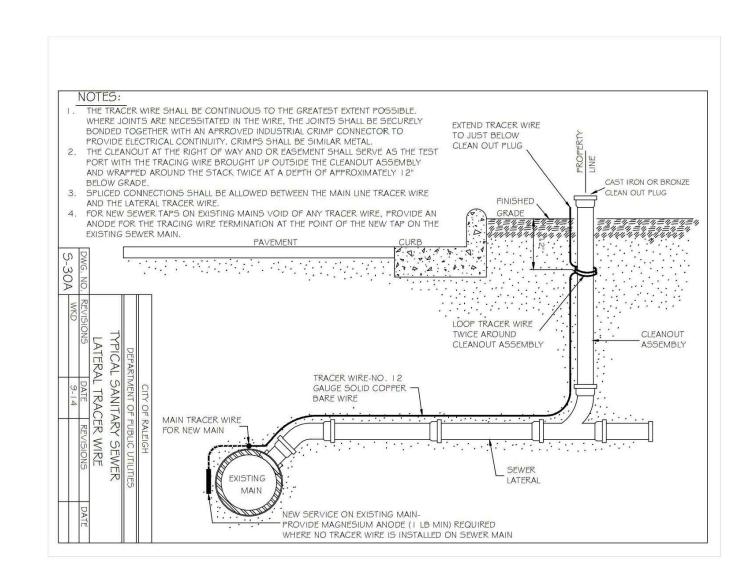

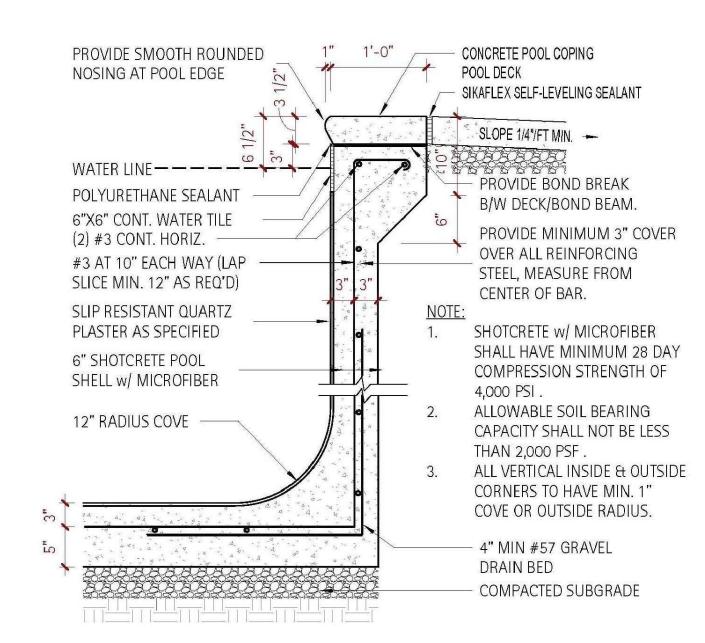POOL COPING


SCALE: 1"=1'-0"



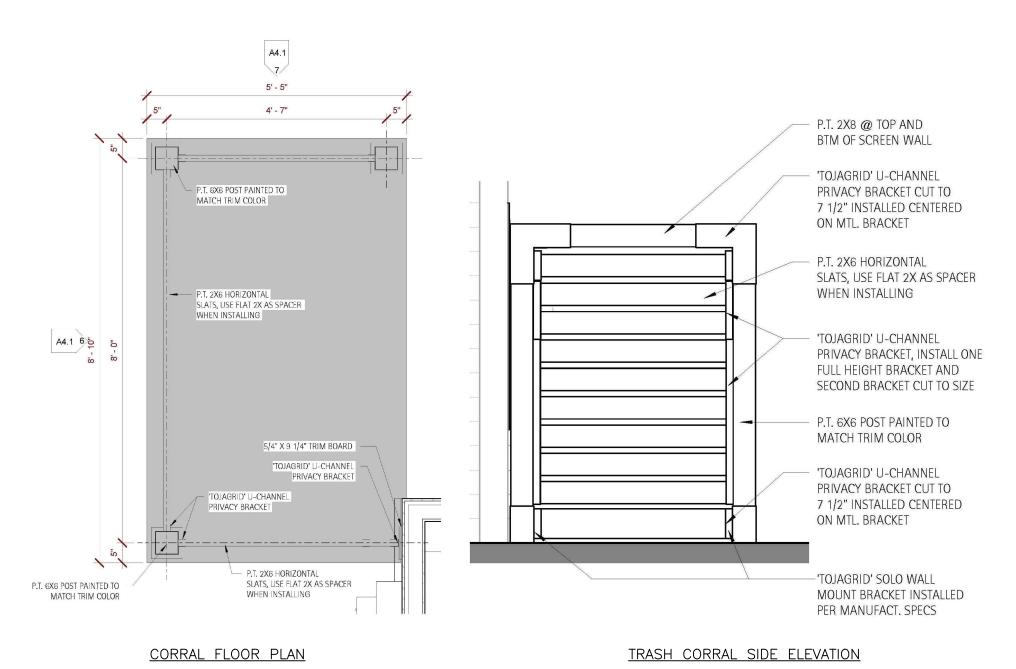

TRASH CORRAL


SCALE: 1/2"=1'-0"

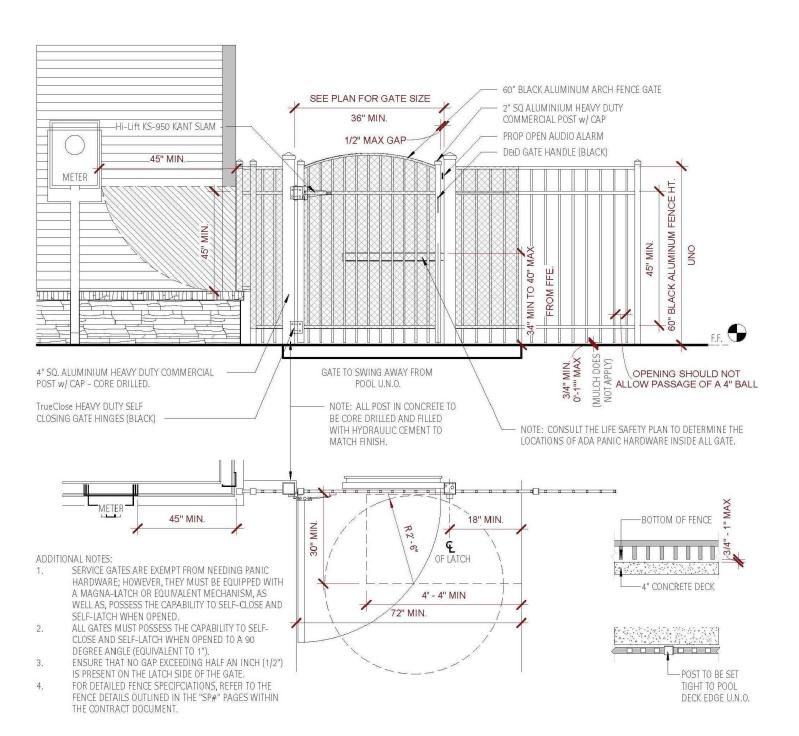


06 POOL FENCE AND GATE

SCALE: 1/2"=1'-0"

1. DETAILS FROM OTHERS, FOR REFERENCE ONLY.

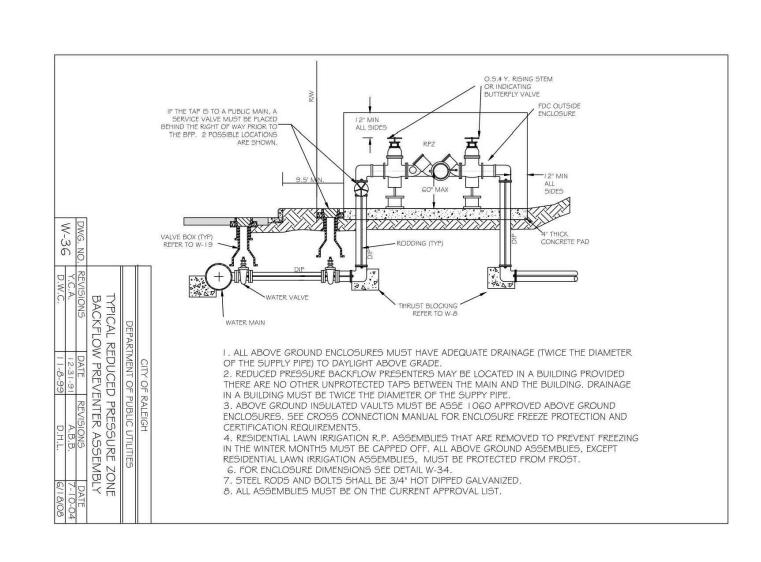

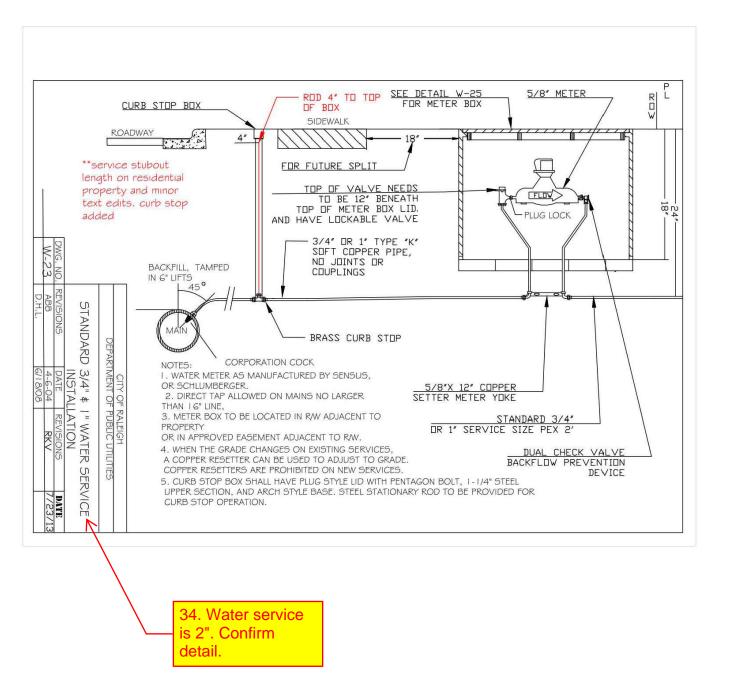

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PLAN INFORMATION


PROJECT NO. LEN23026 FILENAME LEN23026-D1 CHECKED BY DRAWN BY SCALE AS SHOWN


SHEET

DATE

SITE DETAILS

07.01.2024

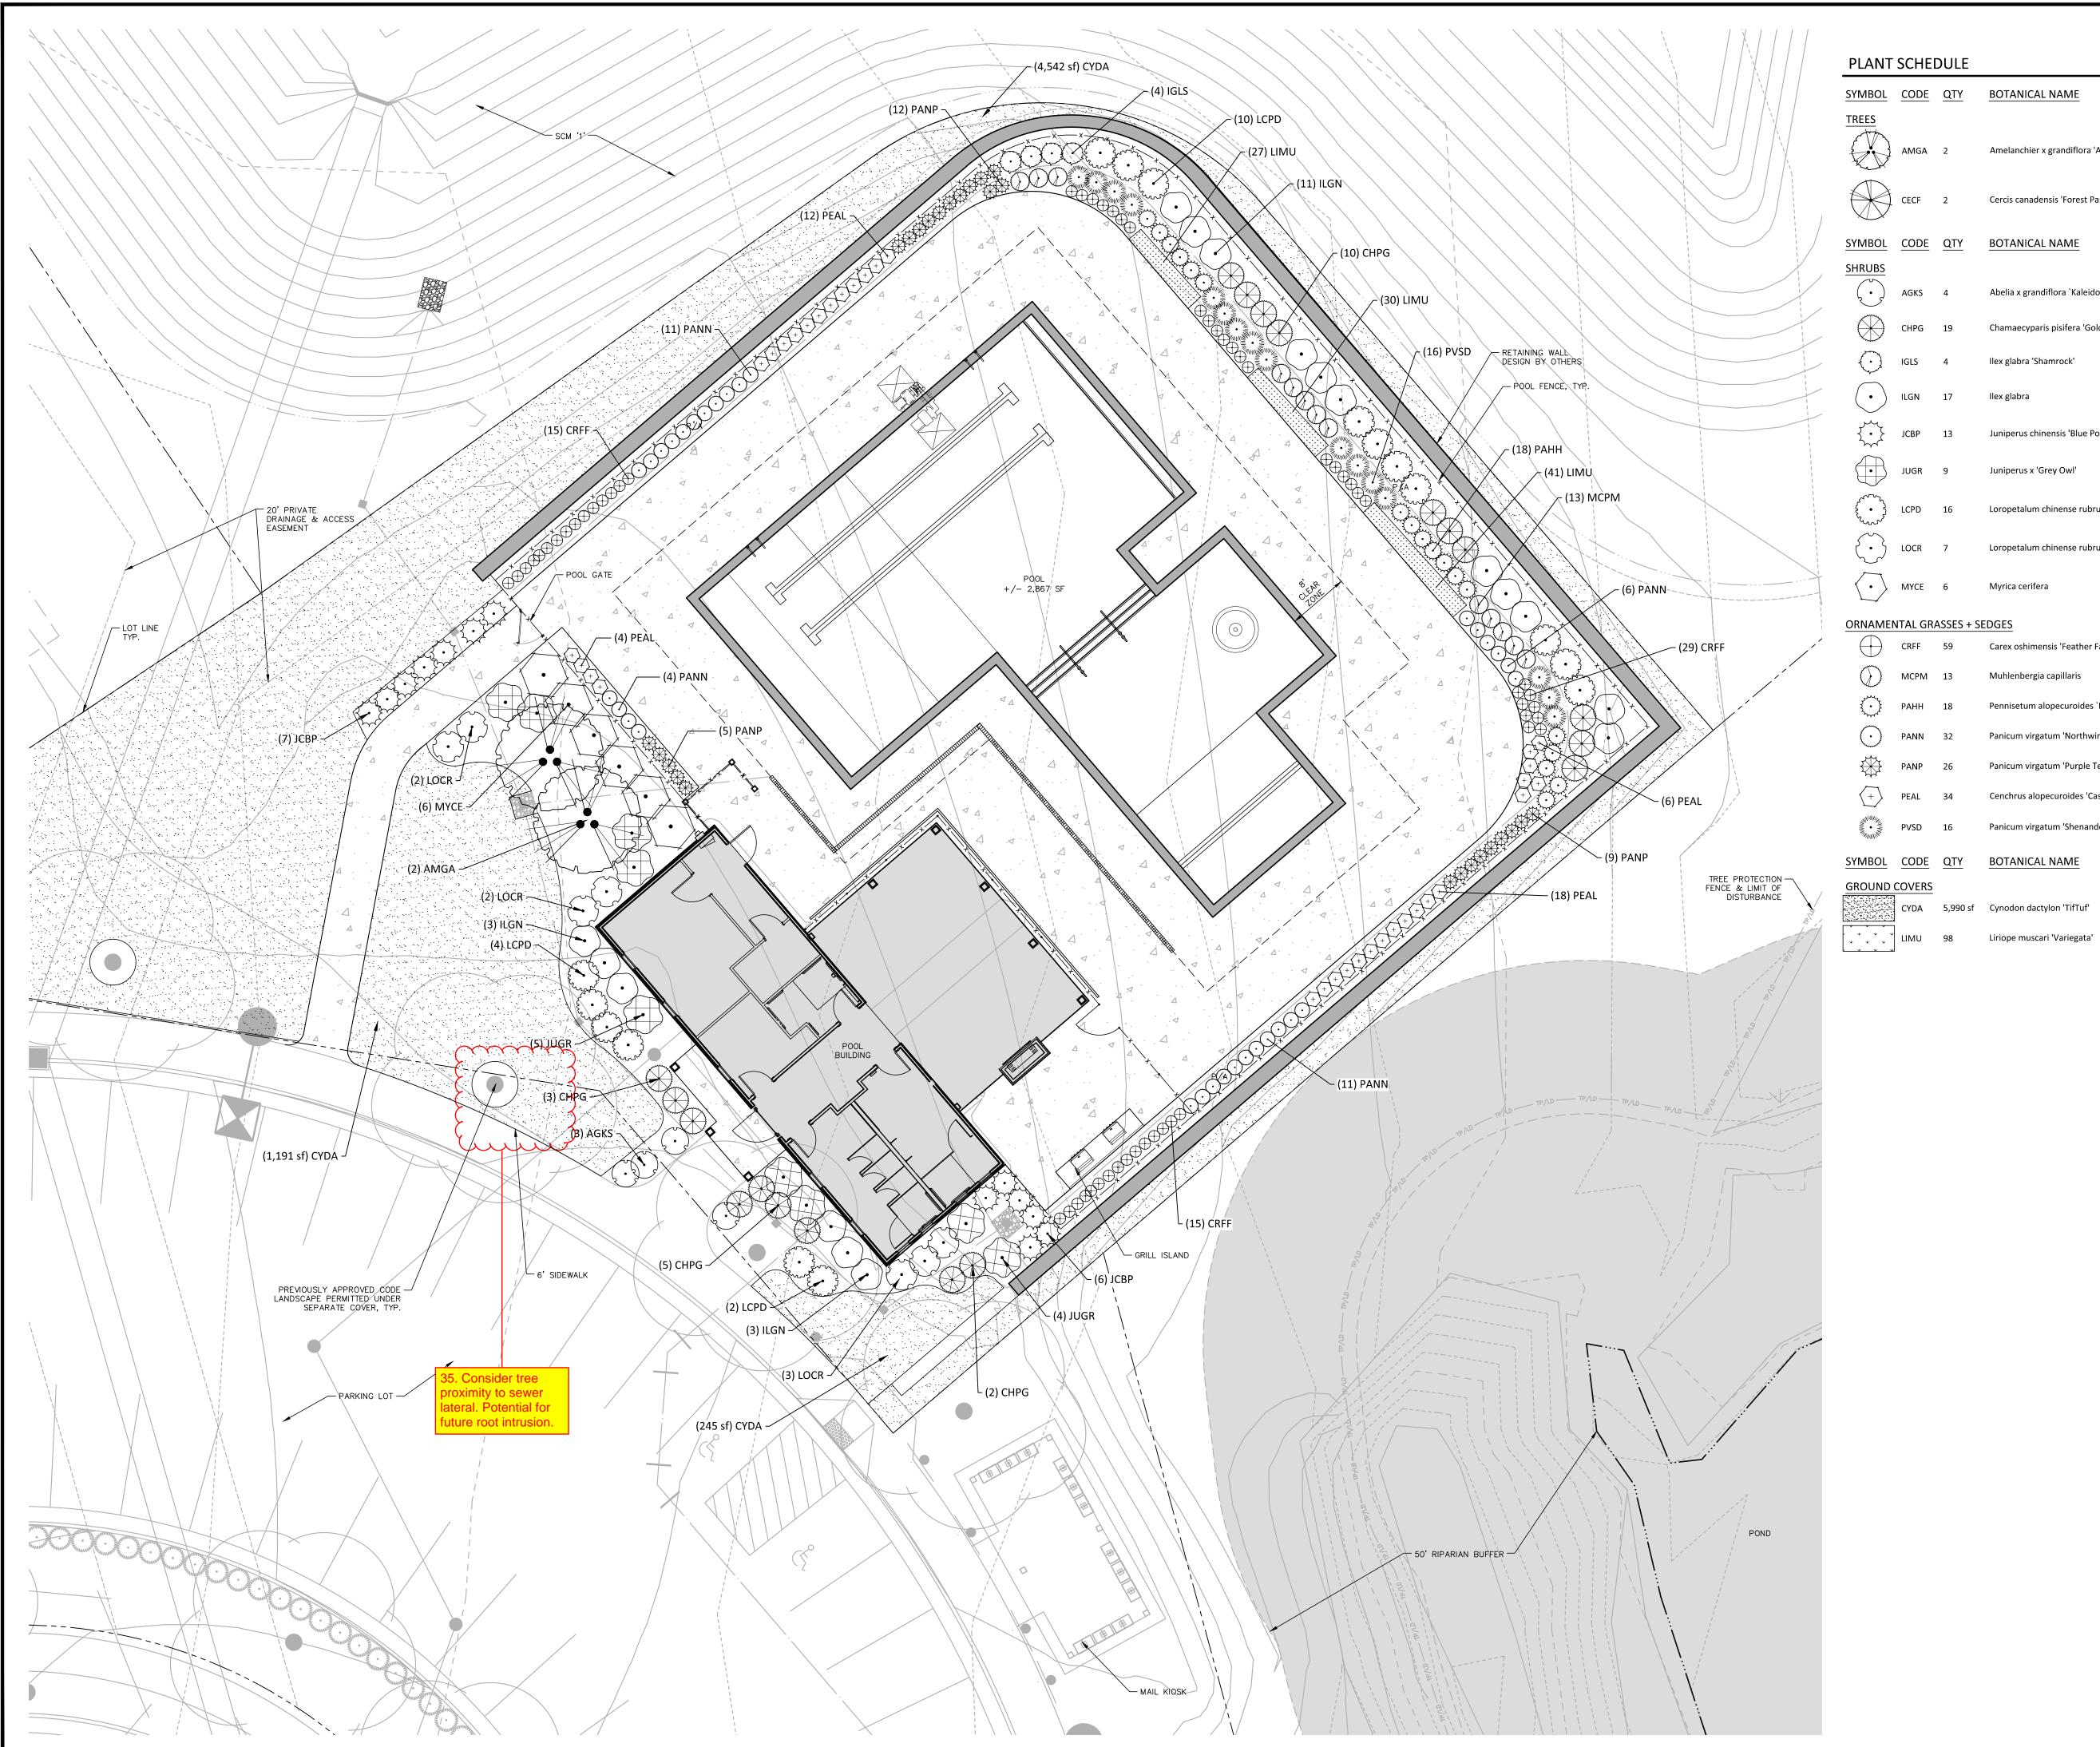

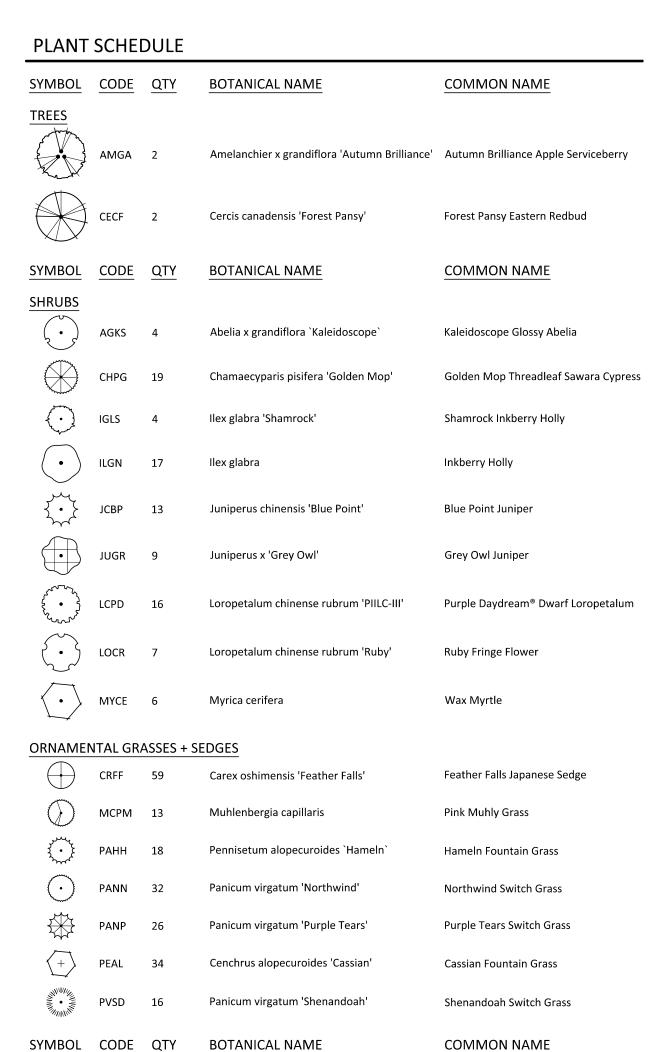



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PLAN INFORMATION

PROJECT NO. LEN23026 LEN23026-LP1 FILENAME CHECKED BY DRAWN BY SCALE DATE 07.01.2024


SHEET

AMENITY LANDSCAPE PLAN


PRELIMINARY DRAWING - NOT RELEASED FOR CONSTRUCTION

Bermuda 'TifTuf'


Variegated Lilyturf

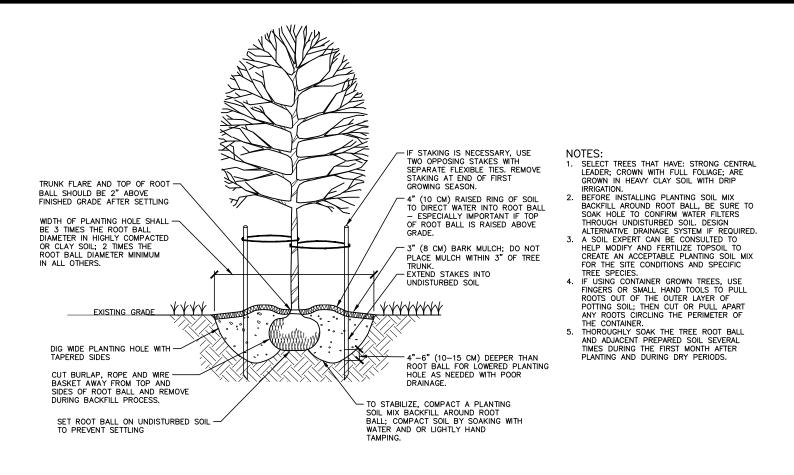


1 TREE INSTALLATION

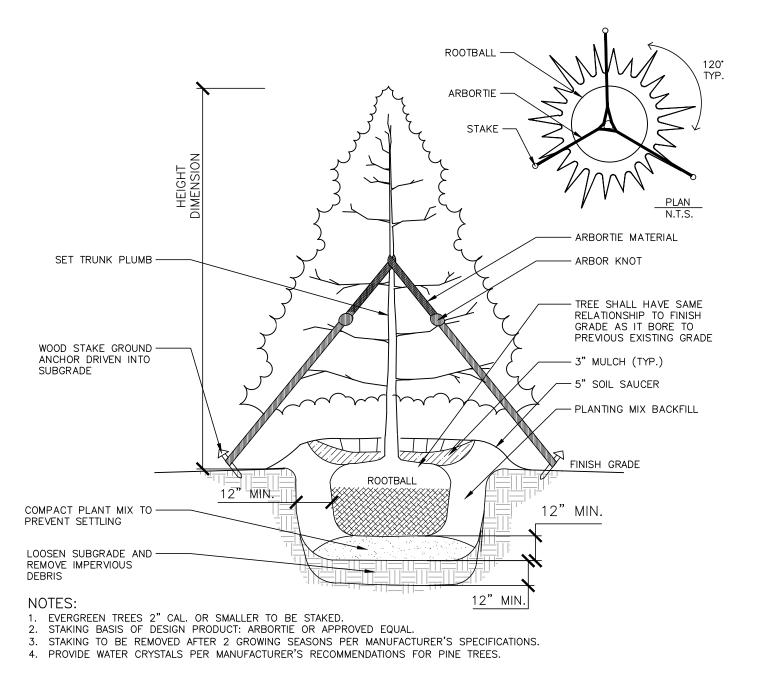


02 EVERGREEN TREE INSTALLATION SCALE: NTS

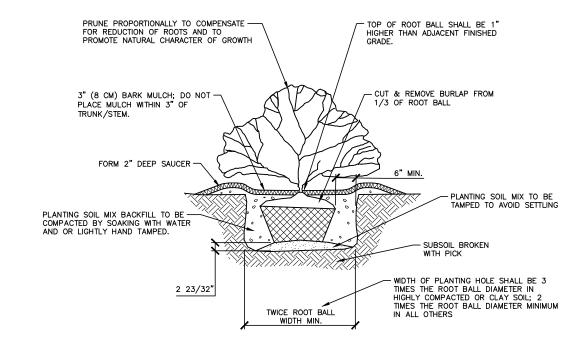

03 SHRUB INSTALLATION SCALE: NTS

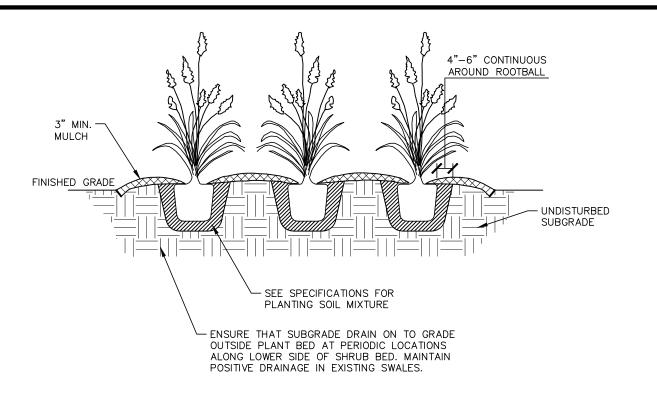

ORNAMENTAL GRASS PLANTING SCALE: NTS

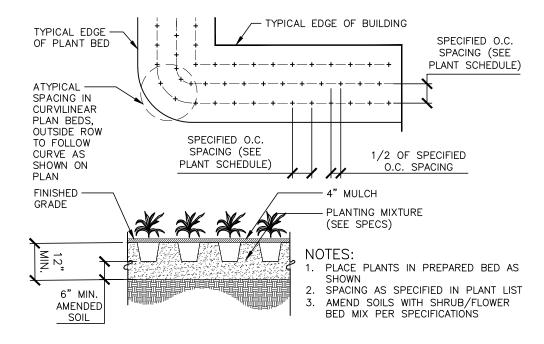

O5 GROUNDCOVER PLANTING SCALE: NTS

PLANT SCHEDULE								
SYMBOL	CODE	<u>QTY</u>	BOTANICAL NAME	COMMON NAME	CAL	HEIGHT		
TREES								
	AMGA	2	Amelanchier x grandiflora 'Autumn Brilliance'	Autumn Brilliance Apple Serviceberry	-	8` min		
	CECF	2	Cercis canadensis 'Forest Pansy'	Forest Pansy Eastern Redbud	2" min	8` min		
SYMBOL	CODE	QTY	BOTANICAL NAME	COMMON NAME	CONT	HEIGHT		
SHRUBS								
	AGKS	4	Abelia x grandiflora `Kaleidoscope`	Kaleidoscope Glossy Abelia	#3	12" min		
	CHPG	19	Chamaecyparis pisifera 'Golden Mop'	Golden Mop Threadleaf Sawara Cypress	#3	15" min		
\bigcirc	IGLS	4	llex glabra 'Shamrock'	Shamrock Inkberry Holly	5 gal	24" min		
•	ILGN	17	llex glabra	Inkberry Holly	#3	18" min		
**	JCBP	13	Juniperus chinensis 'Blue Point'	Blue Point Juniper	-	48" - 60"		
	JUGR	9	Juniperus x 'Grey Owl'	Grey Owl Juniper	#5	18" min		
£	LCPD	16	Loropetalum chinense rubrum 'PIILC-III'	Purple Daydream® Dwarf Loropetalum	3 gal	12" min		
	LOCR	7	Loropetalum chinense rubrum 'Ruby'	Ruby Fringe Flower	#3	15" min		
$\langle \cdot \rangle$	MYCE	6	Myrica cerifera	Wax Myrtle	#10	36" min		
ORNAMENTAL GRASSES + SEDGES								
	CRFF	59	Carex oshimensis 'Feather Falls'	Feather Falls Japanese Sedge	3 gal			
\bigcirc	МСРМ	13	Muhlenbergia capillaris	Pink Muhly Grass	3 gal			
3 · }	РАНН	18	Pennisetum alopecuroides 'Hameln'	Hameln Fountain Grass	3 gal			
\odot	PANN	32	Panicum virgatum 'Northwind'	Northwind Switch Grass	1 gal			
	PANP	26	Panicum virgatum 'Purple Tears'	Purple Tears Switch Grass	3 gal			
+	PEAL	34	Cenchrus alopecuroides 'Cassian'	Cassian Fountain Grass	1 gal			
	PVSD	16	Panicum virgatum 'Shenandoah'	Shenandoah Switch Grass	3 gal			
SYMBOL	CODE	QTY	BOTANICAL NAME	COMMON NAME	CONT			
GROUND (COVERS							
	CYDA	5,990 sf	Cynodon dactylon 'TifTuf'	Bermuda 'TifTuf'	Sod			
\ \ \ \ \ \ \ \ \ \ \ \ \ \ \ \ \ \ \	LIMU	98	Liriope muscari 'Variegata'	Variegated Lilyturf	Seed			

GENERAL LANDSCAPE NOTES:

BEFORE BEGINNING DEMOLITION OR INSTALLATION.

- ALL MATERIALS AND METHODS OF CONSTRUCTION SHALL BE IN ACCORDANCE WITH THE CITY OF ROLESVILLE AND THE STATE OF NORTH CAROLINA STANDARDS AND SPECIFICATIONS.
- 2. CONTRACTOR IS RESPONSIBLE FOR THE SITE INSPECTION BEFORE LANDSCAPE CONSTRUCTION AND INSTALLATION IN ORDER TO BECOME FAMILIAR WITH THE EXISTING
- LANDSCAPE CONTRACTOR IS RESPONSIBLE FOR LOCATING ALL UNDERGROUND UTILITIES
- 4. CONTRACTOR SHALL NOTIFY LANDSCAPE ARCHITECT OF ANY DISCREPANCIES BETWEEN THE NOTES, SPECIFICATIONS, DRAWINGS OR SITE CONDITIONS FOR RESOLUTION PRIOR TO INSTALLATION
- 5. ANY DAMAGE TO UTILITIES SHALL BE REPAIRED AT THE CONTRACTOR'S EXPENSE.
- 6. THIS PLAN IS FOR PLANTING PURPOSES ONLY. FOR INFORMATION REGARDING BUILDINGS, GRADING, WALLS, ETC., REFER TO ARCHITECTURE, SITE AND GRADING PLANS.
- 7. VERIFICATION OF TOTAL PLANT QUANTITIES AS SHOWN IN THE PLANT SCHEDULE SHALL BE THE RESPONSIBILITY OF THE LANDSCAPE CONTRACTOR. ANY DISCREPANCIES SHALL BE BROUGHT TO THE ATTENTION OF THE LANDSCAPE ARCHITECT.
- 8. CONTRACTOR TO ENSURE PROPER STABILIZATION AND SEEDING OF THE SITE IN ACCORDANCE WITH APPLICABLE REGULATIONS.
- 9. LANDSCAPE MATERIAL SHALL BE WELL FORMED, VIGOROUS, GROWING SPECIMENS WITH GROWTH TYPICAL OF VARIETIES SPECIFIED AND SHALL BE FREE FROM DAMAGE, INSECTS AND DISEASES. MATERIAL SHALL EQUAL OR SURPASS #1 QUALITY AS DEFINED IN THE CURRENT ISSUE OF "AMERICAN STANDARD FOR NURSERY STOCK" AS PUBLISHED BY THE AMERICAN NURSERY & LANDSCAPE ASSOCIATION.
- 10. ALL PLANT MATERIAL IS TO BE CAREFULLY HANDLED BY THE ROOT BALL, NOT THE TRUNK, BRANCHES AND/OR FOLIAGE OF THE PLANT. MISHANDLED PLANT MATERIAL MAY BE REJECTED BY THE LANDSCAPE ARCHITECT.
- 11. ALL PLANT MATERIAL IS TO BE WELL ROOTED, NOT ROOT BOUND, SUCH THAT THE ROOT BALL REMAINS INTACT THROUGHOUT THE PLANTING PROCESS. DEFICIENT PLANT MATERIAL MAY BE REJECTED BY THE LANDSCAPE ARCHITECT OR OWNER.
- 12. ALL PLANTS TO BE A MINIMUM OF WHAT IS SPECIFIED IN THE PLANT SCHEDULE. ANY CHANGES OR SUBSTITUTIONS SHALL BE APPROVED BY THE LANDSCAPE ARCHITECT AND GOVERNING JURISDICTION PRIOR TO ANY HOLE BEING DUG.
- 13. CONTRACTOR TO COORDINATE WITH OWNER'S REPRESENTATIVE AND LANDSCAPE ARCHITECT TO ESTABLISH THE EXTENTS OF MULCH/SEED/SOD IF NOT SPECIFICALLY SHOWN
- 14. CONTRACTOR SHALL PROVIDE POSITIVE DRAINAGE IN ALL PLANTING AREAS.
- 15. PROPOSED TREES TO BE PLANTED A MINIMUM 10 FEET FROM ANY LIGHT POLE AS MEASURED FROM TRUNK OF THE TREE TO THE POLE.
- 16. PROPOSED TREES TO BE PLANTED A MINIMUM 5 FEET FROM ANY FIRE HYDRANT AS
- MEASURED FROM TRUNK OF THE TREE TO THE HYDRANT.

 17. CONTRACTOR SHALL COMPLETE SOIL TEST IN ALL PLANTING AREAS TO DETERMINE SOIL
- AMENDMENT REQUIREMENTS UNLESS WAIVED BY OWNER'S REPRESENTATIVE.
 CONTRACTOR SHALL ADJUST PH AND FERTILITY BASED UPON THE SOIL TEST RESULTS.

 18. TOPSOIL SHALL BE FREE OF MATERIAL LARGER THAN 1.0 INCH IN DIAMETER OR LENGTH
- AND SHALL NOT CONTAIN SLAG, CINDERS, STONES, LUMPS OF SOIL, STICKS, ROOTS, TRASH, OR OTHER EXTRANEOUS MATERIAL.

 19. LOOSEN SUBGRADE / SURFACE SOIL TO A MINIMUM DEPTH OF 6 INCHES. APPLY SOIL AMENDMENTS AND FERTILIZERS AS REQUIRED BY THE SOIL TEST RESULTS TO ACHIEVE A HEALTHY GROWING MEDIA AND MIX THOROUGHLY INTO TOP 4 INCHES OF SOIL. SPREAD
- PLANTING SOIL MIX TO A DEPTH OF 6 INCHES BUT NOT LESS THAN REQUIRED TO MEET FINISH GRADES AFTER NATURAL SETTLEMENT. DO NOT SPREAD IF PLANTING SOIL OR SUBGRADE IS FROZEN, MUDDY, OR EXCESSIVELY WET.
 20. IF IMPORTED TOPSOIL IS REQUIRED, THE SUBGRADE SHALL BE SCARIFIED OR TILLED TO A DEPTH OF AT LEAST 6 INCHES PRIOR TO INSTALLATION OF IMPORTED TOPSOIL. FOLLOWING
- INSTALLATION OF IMPORTED TOPSOIL, THE TOPSOIL SHALL BE TILLED TO INTEGRATE THE SOIL PROFILES.

 21. PLANT MATERIALS ARE TO BE GUARANTEED FOR A PERIOD OF 12 MONTHS. PLANT MATERIALS WHICH REMAIN UNHEALTHY WILL BE REPLACED BY THE LANDSCAPE

DIRECTED BY THE OWNER'S REPRESENTATIVE OR LANDSCAPE ARCHITECT.

22. ALL TREE PLANTINGS SHALL BE MULCHED TO A DEPTH OF 3 INCHES, AND WITH A MINIMUM 3 FOOT RADIUS FROM BASE OF TREE OR TO DRIPLINE. MULCH SHALL BE FREE OF TRASH AND MAINTAINED WEED FREE. MULCH SHALL NOT COVER THE ROOT FLARE. CONFIRM

MULCH SPECIFICATIONS WITH OWNER'S REPRESENTATIVE OR LANDSCAPE ARCHITECT.

CONTRACTOR BEFORE THE EXPIRATION OF THE GUARANTEE PERIOD OR IMMEDIATELY IF SO

- 23. DO NOT PRUNE TREES AND SHRUBS BEFORE DELIVERY. PROTECT BARK, BRANCHES, AND ROOT SYSTEMS FROM SUN SCALD, DRYING, SWEATING, WHIPPING, AND OTHER HANDLING AND TYING DAMAGE. DO NOT BEND OR BIND-TIE TREES OR SHRUBS IN SUCH A MANNER AS TO DESTROY THEIR NATURAL SHAPE. PROVIDE PROTECTIVE COVERING OF EXTERIOR PLANTS DURING DELIVERY. DO NOT DROP EXTERIOR PLANTS DURING DELIVERY AND HANDLING.
- 24. DELIVER EXTERIOR PLANTS AFTER PREPARATIONS FOR PLANTING HAVE BEEN COMPLETED AND INSTALL IMMEDIATELY. IMMEDIATELY AFTER UNLOADING, STAND THE TREES UP TO REDUCE THE RISK OF SUN SCALD. PROPERLY STAGED TREES ARE STANDING, UNTIED AND SPACED. UNLESS IMMEDIATELY INSTALLED, SET EXTERIOR PLANTS AND TREES IN SHADE, PROTECT FROM WEATHER AND MECHANICAL DAMAGE, AND KEEP ROOTS MOIST.
- 25. SEE LANDSCAPE DETAILS FOR TREE STAKING REQUIREMENTS.
- 26. EXCAVATE EDGES OF ALL PLANTING BEDS TO 2 INCH DEPTH TO FORM A NEAT AND CRISP
- 27. CONTRACTOR SHALL REMOVE DEBRIS AND FINE GRADE ALL PLANTING AREAS PRIOR TO
- 28. REMOVE GUY WIRES AND STAKES AT END OF WARRANTY PERIOD OR ESTABLISHMENT.
- 29. FINISH GRADING: GRADE PLANTING AREAS TO A SMOOTH, UNIFORM SURFACE PLANE WITH LOOSE, UNIFORMLY FINE TEXTURE. GRADE TO WITHIN PLUS OR MINUS 1/2 INCH OF FINISH ELEVATION. ROLL AND RAKE, REMOVE RIDGES, AND FILL DEPRESSIONS TO MEET FINISH GRADES. LIMIT FINISHED GRADING TO AREAS THAT CAN BE PLANTED IN THE IMMEDIATE



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REVISIONS

NO. DATE

PLAN INFORMATION

PROJECT NO. LEN23026

FILENAME LEN23026-LP1

CHECKED BY SRD

DRAWN BY SMA

DRAWN BY SMA

SCALE AS SHOWN

DATE 07.01.2024

SHEET

LANDSCAPE NOTES AND DETAILS

L5.01



phone 919. 361. 5000 fax 919. 361. 2269


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REVISIONS

NO. DATE


PLAN INFORMATION

PROJECT NO. LEN23026 FILENAME CHECKED BY DRAWN BY SCALE DATE

SHEET

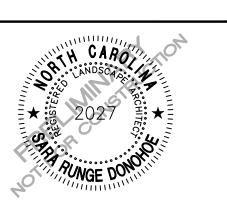AMENITY LIGHTING PLAN

L6.00

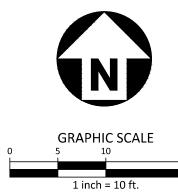

PRELIMINARY DRAWING - NOT RELEASED FOR CONSTRUCTION