

DEPARTMENT OF THE ARMY

U.S. ARMY CORPS OF ENGINEERS, WILMINGTON DISTRICT
WILMINGTON REGULATORY OFFICE
69 DARLINGTON AVENUE
WILMINGTON NORTH CAROLINA 28403

December 17, 2024

South Atlantic Division Regulatory Technical Regional Execution Center SAW-2008-00871 (NWP-EMP)

Bob Mishler
Ashton Raleigh Residential, LLC
900 Ridgefield Drive
Suite 335
Raleigh, North Carolina 27609
Sent Via email: bob.mishler@ashtonwoods.com

Dear Mr. Mishler:

This letter is in response to the Pre-Construction Notification (PCN) you submitted to the Wilmington District, Technical Regional Execution Center on September 25, 2024, for a Department of the Army Nationwide permit (NWP) verification. This project has been assigned the file number SAW-2008-00871 and is known as the Point South – Phase 3 project. This file number should be referenced in all correspondence concerning this project.

A review of the information provided indicates that the proposed work would include the construction of a road crossing over a stream, which includes the installation of a culvert and riprap fall for access to the southeastern portion of the property. Permanent impacts associated with this proposed project includes 109 linear feet of the stream (Harris Creek) present. The project area is located in Harris Creek; at the intersection of Louisburg Road and East Young Street, at Latitude 35.866150 and Longitude - 78.678600; in Raleigh, Wake County, North Carolina.

We have determined that the proposed work is authorized by NWP-29 (Residential Development) pursuant to authorities under Section 404 of the Clean Water Act (33 U.S.C § 1344). The proposed work must be accomplished in strict accordance with the general permit conditions, any regional conditions, the special conditions listed in this letter, the application materials, and the enclosed plans. If the extent of the project area and/or nature of the authorized impacts to waters are modified, a revised PCN must be submitted to this office for written approval before work is initiated. Any violation of permit conditions or deviation from your submitted plans may subject the permittee to enforcement action.

This verification is valid until **March 14, 2026**, unless prior to this date the subject NWP(s) is suspended, revoked, or is modified such that the activity no longer complies with the terms and conditions of this NWP. If you commence or are under contract to commence this activity before the date that the relevant NWP is modified or revoked, you will have 12 months from the date of the modification or revocation of the NWP to complete the activity under the present terms and conditions of this NWP.

Project Specific Special Conditions:

- 1. In order to compensate for impacts associated with this permit, mitigation shall be provided in accordance with the provisions outlined on the most recent version of the attached Compensatory Mitigation Responsibility Transfer Form. The requirements of this form, including any special conditions listed on this form, are hereby incorporated as special conditions of this permit authorization.
- 2. Suitable habitat for tricolored bat (*Perimyotis subflavus*) may be present at the site. On September 14, 2022, the USFWS published a proposal in the Federal Register to list the tricolored bat as endangered under the Endangered Species Act (ESA). The permittee understands and agrees that all work associated with the clearing and removal of trees and removal, or modification of culverts must be completed prior to the effective date of the final listing in the Federal Register. Work associated with the aforementioned activities not completed by that time must cease and the permittee must contact the Corps via Lyle Phillips by email at George.L.Phillips@usace.army.mil or by telephone at (919) 588-9200 to determine if additional coordination with the United States Fish and Wildlife Service is required under Section 7 of the Endangered Species Act prior to continuing work.

Activities subject to Section 404 (as indicated above) may also require an individual Section 401 Water Quality Certification. You should contact the NC Division of Water Resources (telephone 919-807-6300) to determine Section 401 requirements.

This NWP verification does not preclude the necessity to obtain any other Federal, State, or local permits, licenses, and/or certifications, which may be required.

If you have any questions related to this verification or have issues accessing documents referenced in this letter, please contact **Eric Parks** of the SAD Technical Regional Execution Center on behalf of the **Raleigh Field** Office at **(912) 856-7137**, by mail at 100 West Oglethorpe Street, Savannah, GA 31401, or by email at **Eric.M.Parks**@usace.army.mil. If you have any questions related to follow-up actions associated with this permit, such as compliance inspections, please contact **Lyle Phillips**, PM of the **Raleigh Regional** Office at **(919) 588-9200**, by mail at **3331 Heritage Trade Drive, Suite 105, Wake Forest, NC 27587**, or by email at **George.L.Phillips**@usace.army.mil. Please take a moment to complete our customer satisfaction survey located at https://regulatory.ops.usace.army.mil/ords/f?p=136:4.

Sincerely,

Cric Parks

Eric Parks Biologist SAD, Technical Regional Execution Center

Enclosures:

Compliance Certification
Mitigation Transfer Form
Nationwide Permit 29
Nationwide Permit General Conditions
Nationwide Permit Regional Conditions
Project Drawings

Cc (w/enclosures)
Jennifer Burdette, Natural Resource Consultants (via burdette@nrconsultnc.com)

Compliance Certification Form

File Number: SAW-2008-00871	County: Wake
Permittee: Ashton Raleigh Residential, LLC, B	Bob Mishler
Project Name: the Point South – Phase 3 proje	ect
Date Verification Issued: 12/17/2024	
Project Manager: Eric Parks	
Within 10 days of completion of the activity authorequired by the permit, sign this certification and i	
US ARMY CORPS OF I Wilmington Dis Attn: Eric Par Technical Regional Exe 100 West Oglethorp Savannah, Georgi or Eric.M.Parks@usace	strict rks cution Center be Avenue ia 31401
Please note that your permitted activity is subject Army Corps of Engineers representative. Failure of this authorization may result in the Corps suspauthorization and/or issuing a Class I administration appropriate legal action.	to comply with any terms or conditions ending, modifying or revoking the
I hereby certify that the work, and mitigation (if apreferenced permit has been completed in accordance the said permit including any general or specific of	ance with the terms and conditions of
Date Authorized Work Started:	Completed:
Describe any deviations from permit (attach draw	ing(s) depicting the deviations):
*Note: The description of any deviations on this form d	oes not constitute approval by the Corps.
Signature of Permittee	Date

<u>US Army Corps of Engineers – Wilmington District</u> Compensatory Mitigation Responsibility Transfer Form

Permittee: Bob Mishler Action ID: SAW-2008-00871

Project Name: The Point South – Phase 3 Project County: Wake

Instructions to Permittee: The Permittee must provide a copy of this form to the Mitigation Sponsor, either an approved Mitigation Bank or the North Carolina Division of Mitigation Services (NCDMS), who will then sign the form to verify the transfer of the mitigation responsibility. Once the Sponsor has signed this form, it is the Permittee's responsibility to ensure that Wilmington District Project Manager identified on page two is in receipt of a signed copy of this form before conducting authorized impacts, unless otherwise specified below. If more than one Mitigation Sponsor will be used to provide the mitigation associated with the permit, or if the impacts and/or the mitigation will occur in more than one 8-digit Hydrologic Unit Code (HUC), multiple forms will be attached to the permit, and the separate forms for each Sponsor and/or HUC must be provided to the appropriate Mitigation Sponsors.

Instructions to Sponsor: The Sponsor verifies that the mitigation requirements (credits) shown below have been released and are available at the identified site. By signing below, the Sponsor is accepting full responsibility for the identified mitigation, regardless of whether they have received payment from the Permittee. Once the form is signed, the Sponsor must update the bank ledger and provide a copy of the signed form and the updated ledger to the Permittee, the Project Manager who issued the permit, the Bank Project Manager, and the District Mitigation Office (see contact information on page 2). The Sponsor must also comply with all reporting requirements established in their authorizing instrument.

Permitted Impacts and Compensatory Mitigation Requirements

Permitted Impacts Requiring Mitigation*: 8-digit HUC and Basin: 03020201, Neuse River Basin

Stream Impact	s (linear feet)		Wetland Impacts (a	acres)		
Warm	Cool	Cold	Riparian Riverine	Riparian Non-Riverine	Non-Riparian	Coastal
81						

^{*}If more than one mitigation sponsor will be used for the permit, only include impacts to be mitigated by this sponsor.

Compensatory Mitigation Requirements: 0.20 8-digit HUC and Basin: 03020201, Neuse River Basin

Stream Mitigation	on (credits)		Wetland Mitigation	n (credits)		
Warm	Cool	Cold	Riparian Riverine	Riparian Non-Riverine	Non-Riparian	Coastal
162						

Mitigation Site Debited: NCDMS

(List the name of the bank to be debited. For umbrella banks, also list the specific site. For NCDMS, list NCDMS. If the NCDMS acceptance letter identifies a specific site, also list the specific site to be debited).

Section to be completed by the Mitigation Sponsor

Statement of Mitigation Liability Acceptance: I, the undersigned, verify that I am authorized to approve mitigation transactions for the Mitigation Sponsor shown below, and I certify that the Sponsor agrees to accept full responsibility for providing the mitigation identified in this document (see the table above), associated with the USACE Permittee and Action ID number shown. I also verify that released credits (and/or advance credits for NCDMS), as approved by the Wilmington District, are currently available at the mitigation site identified above. Further, I understand that if the Sponsor fails to provide the required compensatory mitigation, the USACE Wilmington District Engineer may pursue measures against the Sponsor to ensure compliance associated with the mitigation requirements.

Mitigation Sponsor Name:	
Name of Sponsor's Authorized Representative:	
Signature of Sponsor's Authorized Representative	Date of Signature

Conditions for Transfer of Compensatory Mitigation Credit:

- Once this document has been signed by the Mitigation Sponsor and the District is in receipt of the signed form, the Permittee is no longer responsible for providing the mitigation identified in this form, though the Permittee remains responsible for any other mitigation requirements stated in the permit conditions.
- Construction within jurisdictional areas authorized by the permit identified on page one of this form can begin only after the District is in receipt of a copy of this document signed by the Sponsor, confirming that the Sponsor has accepted responsibility for providing the mitigation requirements listed herein. When NCDMS provides mitigation for authorized impacts conducted by the North Carolina Department of Transportation (NCDOT), construction within jurisdictional areas may proceed upon permit issuance; however, a copy of this form signed by NCDMS must be provided to the District within 30 days of permit issuance. NCDOT remains fully responsible for the mitigation until the District has received this form, confirming that the Sponsor has accepted responsibility for providing the mitigation requirements listed herein.
- Signed copies of this document must be retained by the Permittee, Mitigation Sponsor, and in the USACE administrative records for both the permit and the Bank/ILF Instrument. It is the Permittee's responsibility to ensure that the District Project Manager (address below) is provided with a signed copy of this form.
- If changes are proposed to the type, amount, or location of mitigation after this form has been signed and returned to the District, the Sponsor must obtain case-by-case approval from the District Project Manager and/or North Carolina Interagency Review Team (NCIRT). If approved, higher mitigation ratios may be applied, as per current District guidance and a new version of this form must be completed and included in the District administrative records for both the permit and the Bank/ILF Instrument.

Comments/Additional Conditions:

A letter from NCDMS, confirming they are willing and able to accept the applicant's compensatory mitigation responsibility, dated December 6, 2024 was provided by the applicant.

This form is not valid unless signed below by the District Project Manager and by the Mitigation Sponsor on Page 1. Once signed, the Sponsor should provide copies of this form along with an updated bank ledger to: 1) the Permittee, 2) the District Project Manager at the address below, 3) the Bank Manager listed in RIBITS, and 4) the Wilmington District Mitigation Office, 3331 Heritage Trade Drive, Suite 105, Wake Forest, NC 27587 (or by email to SAWMIT@usace.army.mil). Questions regarding this form or any of the permit conditions may be directed to the District Mitigation Office.

USACE Project Manager:	Eric Parks	
USACE Field Office:	Technical Regional Execution Center	
	US Army Corps of Engineers	
	100 West Oglethorpe Avenue	
	Savannah, GA 31404	
Email:	Eric.M.Parks@usace.army.mil	
		Click here to enter a date
Wilmington [District Project Manager Signature	Date of Signature

Current Wilmington District mitigation guidance, including information on mitigation ratios, functional assessments, and mitigation bank location and availability, and credit classifications (including stream temperature and wetland groupings) is available at http://ribits.usace.army.mil.

THE POINT - PHASES 1, 2, 6 AND 9

15.4.5 - Streets

Type of Street Required All subdivision lots shall abut at least 20 feet on a public street. All public streets shall be dedicated to the Town of Rolesville, the State of North Carolina or the public as determined appropriate by the Board of Commissioners of the Town of Rolesville. All public streets shall be built to the standards of this ordinance and all other applicable standards of the Town of Rolesville and the North Carolina Department of Transportation. Public streets not dedicated to the Town which are eligible for acceptance into the State Highway System shall be constructed to the standards necessary to be put on the State Highway System or the standards in this ordinance, whichever is stricter, in regard to each particular item and shall be put on such system. Streets not dedicated to the Town which are not eligible to be put on the State Highway System because there are too few lots or residences shall, nevertheless, be dedicated to the public and shall be in accordance with the standards in this ordinance or the standards necessary to be put on the State Highway System, whichever is stricter in regard to each particular item, so as to be

later date. A written maintenance agreement with provisions for maintenance of the street until it is put on the State System shall be included with the final plat.

Subdivision Street Disclosure Statement All streets shown on the final plat shall be designated in accordance with G.S. § 136-102.6 and designation as public shall be conclusively presumed an offer of dedication to the public. Where streets are dedicated to the public but not accepted into a municipal or the State system, before lots are sold, a statement explaining the status of the street

P	ARCEL OWNER LIST	
PIN	OWNER	AREA
1768131851	ASHTON RALEIGH RESIDENTIAL, LLC 4025 LAKE BOONE TRAIL, SUITE 200 RALEIGH, NORTH CAROLINA 27607	31.13 AC.
1768254698	BROOKFIELD HOLDINGS (THE POINTE) LLC ANDREW BRAUSA 250 VESEY STREET FL 15 NEW YORK, NY 10281-1065	109.24 AC
1768347557	ASHTON RALEIGH RESIDENTIAL, LLC 4025 LAKE BOONE TRAIL, SUITE 200 RALEIGH, NORTH CAROLINA 27607	11.90 AC.
1758839170	ASHTON RALEIGH RESIDENTIAL, LLC 4025 LAKE BOONE TRAIL, SUITE 200 RALEIGH, NORTH CAROLINA 27607	47.53 AC.

SUBJECT PARCEL ZONED R & PUD PER WAKE COUNTY GIS.

NO CEMETERIES OBSERVED AS A RESULT OF THE SURVEY.

3720175800J & 3720176800J DATES 05/02/2006

AREAS COMPUTED BY COORDINATE METHOD.

BUILDINGS ARE AS SHOWN ON SURVEY.

SURVEY NOTES

______ BATEMAN CIVIL SURVEY COMPANY 2424 RELIANCE AVENUE, APEX, NC 27539 TOPOGRAPHIC DECEMBER 22, 2019 ALTA SURVEY DECEMBER 12, 2019 STEVEN P CARSON, PLS


NC LICENSE # 4752


EAST YOUNG STREET ROLESVILLE, NORTH CAROLINA

CONSTRUCTION DRAWINGS - PACKAGE 1

PROJECT NUMBER: AWH-20000

DATE: MARCH 21, 2022

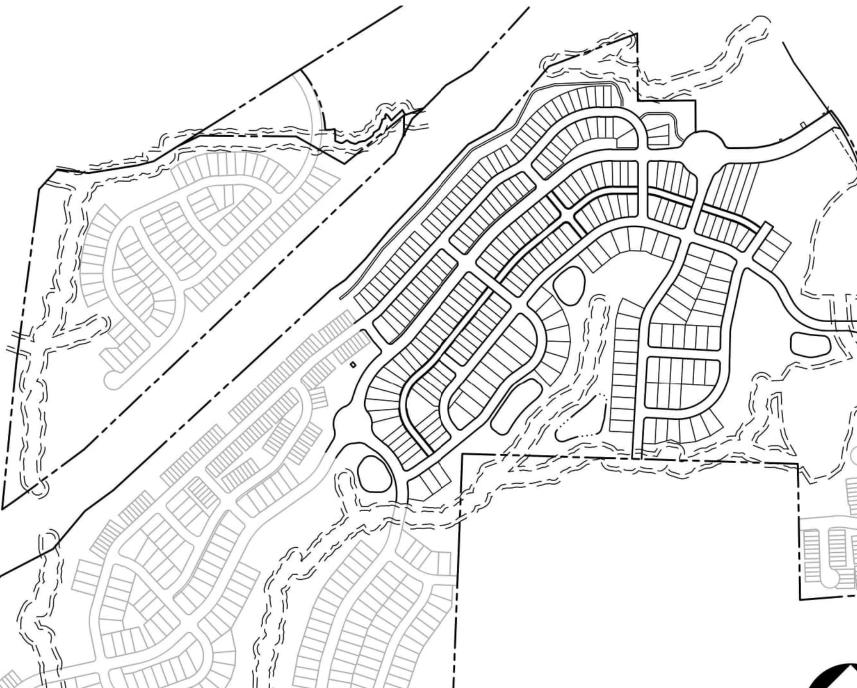

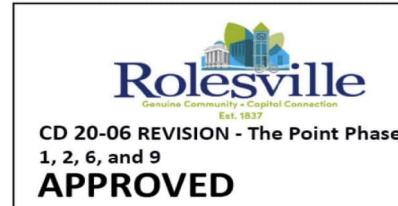

THE PROPERTY LIES IN ZONE "X" PER NATIONAL FLOOD INSURANCE PROGRAM RATE MAP

ALL DISTANCES ARE HORIZONTAL GROUND DISTANCES AND ALL BEARINGS ARE BASED ON


SURVEY WAS PREPARED BY BATEMAN CIVIL SURVEY COMPANY UNDER THE SUPERVISION OF


SANITARY SEWER LINE EASEMENT WAS CREATED BASED ON CENTER LINES ON MANHOLES

OBSERVED GPS CONTROL. NAD 83 / NSRS 2011 / STATE PLANE COORDINATES.

STEVEN P. CARSON, PLS. FIELD WORK WAS COMPLETED DEC 3 - 21, 2018.

Residential	Area	
Roadway=	929,695	sf
Grassed Right-of-ways=	2,457,724	sf
Driveway=	260,024	sf
Parking Lot=		sf
Roof=	910,084	sf
Sidewalk(includes Patio)=	507,854	sf
Lawn=	971,508	sf
Managed Pervious=	2,806	sf
Woods(not on lots)=	1,847,629	sf
Woods(on Lots)=	1,698	sf
	201 175	

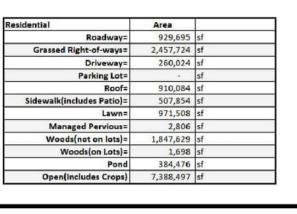

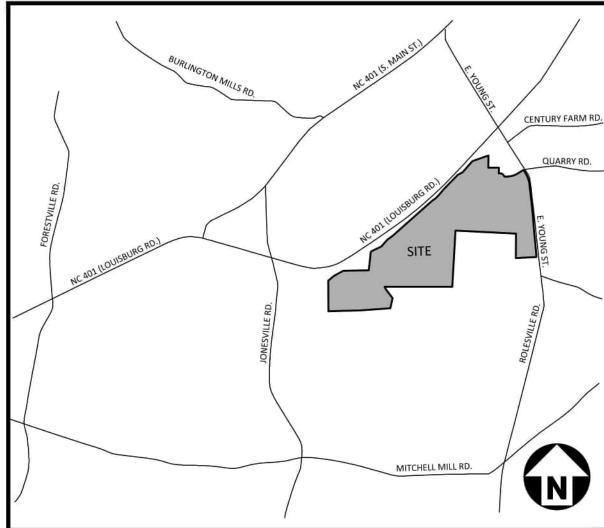

VICINITY MAP



CORPUD APPROVAL CONDITION:

BY AMERICAN ENGINEERING. THE PLAN SET IS TITLED HARRIS CREEK SANITARY SEWER REPLACEMENT AND WILL BE ASSIGNED PERMIT # S-5037. THE POINT SOUTH CD PACKAGE #1 LOTS WILL NOT BE RECORDED AND THE ONSITE WATER/SEWER UTILITIES WILL NOT BE ACCEPTED BY RALEIGH UNTIL THE HARRIS CREEK INTERCEPTOR IMPROVEMENTS UNDER PERMIT # S-5037 ARE APPROVED, INSTALLED, AND ACCEPTED BY RALEIGH FOR MAINTENANCE.

EROSION CONTROL, STORMWATER AND FLOODPLAIN MANAGEMENT **APPROVED** EROSION CONTROL S EC-049643-2020 STORMWATER MGMT. Swf-049645-2020 FLOOD STUDY S-Digitally signed by Janet Boyer Janet Boyer e=janet.boyer@wakegov.com, O=Wake County, OU=Watershed Management, CN=Janet Boyer ate: 2023.03.20 13:50:21-04'00' ENVIRONMENTAL CONSULTANT SIGNATURE

SITE PERMITTING APPROVAL

Rolesville

APPROVED FOR COMPLIANCE

Water and Sewer Permits (If applicable) The City of Raleigh consents to the connection and extension of the City's Public Sewer System as shown on this plan. The material and Construction methods used for this project shall conform to the standards and specifications of the City's Public Utilities Handbook. City of Raleigh Public Utilities Department Permit # _____S-5043

These plans have been approved for compliance with the Town Code of

ject to statements & conditions hereby incorporated by reference

Ordinance, UDO, and Standard Specifications & Construction Details, sub-

The City of Raleigh consents to the connection and extension of the City's Public Water System as shown on this plan. The material and Construction methods used for this project shall conform to the standards and specifications of the City's Public Utilities Handbook. City of Raleigh Public Utilities Department Permit # W-3927 The City of Raleigh consents to the connection to its public sewer system and extension of the private sewer collection

system as shown on this plan. The material and constructions methods used for this project shall conform to the standards and specifications of the City's Public Utilities Handbook. City of Raleigh Public Utilities Department Permit # _____ CITY OF RALEIGH - PLANS AUTHORIZED FOR CONSTRUCTION Electronic Approval: This approval is being issued electronically. This approval is valid only upon the signature of a City of

Raleigh Review Officer below. The City will retain a copy of the approved plans. Any work authorized by this approval must proceed in accordance with the plans kept on file with the City. This electronic approval may not be edited once issued. Any modification to this approval once issued will invalidate this approval.

Timothy Beasley City of Raleigh Development Approval ___

THIS IS A REVISION TO THE PREVIOUSLY APPROVED CD 20-06 CONSTRUCTION DRAWINGS. SINCE THE AMENITY SITE WAS IN THE PLANNING STAGE WHEN THE ORIGINAL CD 20-06 PACKAGE WAS APPROVED AND PERMITTED, THIS REVISION INCLUDES CHANGES TO INFRASTRUCTURE NECESSARY TO ACCOMMODATE THE AMENITY SITE. QUANTITIES: **OUARRY ROAD "1""** QUARRY ROAD "2" 2,322 LF **OUARRY ROAD "3"** 678 LF 2,454 LF MARVEL DRIVE 50' R/W 3,142 LF AFFABLE PLACE 50' R/W 211 LF 50' R/W 1,815 LF 50' R/W

JCUND STREET	50' R/W	1,566 LF	
AIETY WAY	50' R/W	518 LF	
ONTEMPO COURT	50' R/W	1,398 LF	
TCHING PLACE	60' R/W	436 LF	
DLLY LANE	34' PRIVATE ALLEY	2,756 LF	
UBLIC UTILITY	'IMPROVEMEN	TS QUANTITIES	
(CONSTRUCT	TION DRAWINGS -	PACKAGE 1)	
PHASE NUMBEI	R	ALL PHASES	
NUMBER OF LOTS	S	266	
OT MUINADEDC		1 222	

(CONSTRUCTION DRAWINGS	- PACKAGE 1)	(
PHASE NUMBER	ALL PHASES	{
NUMBER OF LOTS	266	(
LOT NUMBERS	1-266	`
6" PUBLIC WATER (LF)	603 LF	
8" PUBLIC WATER (LF)	5,817 LF	
12" PUBLIC WATER (LF)	9,240 LF	
8" PUBLIC SEWER (LF)	13,033 LF	
WATER SERVICE STUBS	267*	
SEWER SERVICE STUBS	266	
* INCLUDES DOGPARK		

LANDSCAPE PLAN AREA "C

LANDSCAPE PLAN AREA "E'

LANDSCAPE PLAN AREA "H

LANDSCAPE NOTES

LANDSCAPE PLAN AREA "I"

LANDSCAPE PLAN AREA "G"

PROJECT NOTES AND SITE DETAILS TYPICAL SECTIONS **OPEN SPACE PLAN** OVERALL EXISTING CONDITIONS **EXISTING CONDITIONS AND DEMOLITION PLAN** EXISTING CONDITIONS AND DEMOLITION PLAN EXISTING CONDITIONS AND DEMOLITION PLAN OVERALL SITE PLAN SITE PLAN - AREA "B" SITE PLAN - AREA "C SITE PLAN - AREA "D SITE PLAN - AREA "E SITE PLAN - AREA "G SITE PLAN - AREA "H' SITE PLAN - AREA "I" OVERALL GRADING AND STORM DRAINAGE PLAN GRADING AND STORM DRAINAGE PLAN - AREA "A" GRADING AND STORM DRAINAGE PLAN - AREA "C FINE GRADING AND STORM DRAINAGE PLAN - AREA "F FINE GRADING AND STORM DRAINAGE PLAN - AREA " OVERALL UTILITY PLAN UTILITY PLAN - AREA "A" UTILITY PLAN - AREA "B" UTILITY PLAN - AREA "C" UTILITY PLAN - AREA "D" UTILITY PLAN - AREA "E UTILITY PLAN - AREA "G" UTILITY PLAN - AREA "I" PLAN AND PROFILE - QUARRY ROAD "1 PLAN AND PROFILE - QUARRY ROAD "2" STA, 10+00.00 THRU STA, 17+00.00 PLAN AND PROFILE - QUARRY ROAD "2" STA. 17+00.00 THRU STA. 25+00.00 PLAN AND PROFILE - QUARRY ROAD "2" STA. 25+00.00 THRU STA. 33+50.00 PLAN AND PROFILE - QUARRY ROAD "3" PLAN AND PROFILE - QUARRY ROAD ROUNDAROUT "1" AND "2 PLAN AND PROFILE - SOLACE WAY STA. 31+00.00 THRU STA. 42+00.00 PLAN AND PROFILE - SOLACE WAY STA, 42+00.00 THRU STA, 54+00.00 PLAN AND PROFILE - SOLACE WAY STA. 54+00.00 THRU STA. 58+50.00 PLAN AND PROFILE - MARVEL DRIVE STA, 9+50,00 THRU STA, 22+00,00 PLAN AND PROFILE - MARVEL DRIVE STA, 22+00.00 THRU STA, 34+00.00 PLAN AND PROFILE - MARVEL DRIVE STA. 34+00.00 THRU STA. 42+00.00 PLAN AND PROFILE - AFFABLE PLACE PLAN AND PROFILE - POSTERITY PLACE STA. 9+50.00 THRU STA. 20+00.00 PLAN AND PROFILE - POSTERITY PLACE STA, 20+00.00 THRU STA, 28+50.00 PLAN AND PROFILE - LISSOME LANE PLAN AND PROFILE - JOCUND STREET STA. 10+00.00 THRU STA. 22+50.00 PLAN AND PROFILE - JOCUND STREET STA. 22+50.00 THRU STA. 26+00.00 PLAN AND PROFILE - GAIETY WAY PLAN AND PROFILE - CONTEMPO COURT STA. 9+50.00 THRU STA. 22+00.00 PLAN AND PROFILE - CONTEMPO COURT STA. 22+00.00 THRU STA. 28+00.00 PLAN AND PROFILE - FETCHING PLACE PLAN AND PROFILE - JOLLY LANE STA. 20+00.00 THRU STA. 29+00.00 PLAN AND PROFILE - JOLLY LANE STA. 29+00.00 THRU STA. 38+00.00 PLAN AND PROFILE - SS O/F "A" AND SS O/F "B" PLAN AND PROFILE - SS O/F "C", GREENWAY "4", AND SS O/F "J" PLAN AND PROFILE - GREENWAY "3" STA. 34+00.00 THRU STA. 45+00.00 EROSION CONTROL PLAN - STAGE 1 - AREA "A" EROSION CONTROL PLAN - STAGE 1 - AREA "B" EROSION CONTROL PLAN - STAGE 1 - AREA "C' EROSION CONTROL PLAN - STAGE 1 - AREA "D' EROSION CONTROL PLAN - STAGE 1 - AREA "E FROSION CONTROL PLAN - STAGE 1 - AREA "G EROSION CONTROL PLAN - STAGE 1 - AREA "H' EROSION CONTROL PLAN - STAGE 1 - AREA "I" EROSION CONTROL PLAN - STAGE 2 - AREA "A" EROSION CONTROL PLAN - STAGE 2 - AREA "B' EROSION CONTROL PLAN - STAGE 2 - AREA "C EROSION CONTROL PLAN - STAGE 2 - AREA "D' EROSION CONTROL PLAN - STAGE 2 - AREA "E" EROSION CONTROL PLAN - STAGE 2 - AREA "G" EROSION CONTROL PLAN - STAGE 2 - AREA "H' EROSION CONTROL PLAN - STAGE 2 - AREA "I" **EROSION CONTROL DETAILS** FROSION CONTROL DETAILS EROSION CONTROL DETAILS **EROSION CONTROL DETAILS** PAVEMENT MARKING AND SIGNAGE PLAN - AREA "A PAVEMENT MARKING AND SIGNAGE PLAN - AREA "B' PAVEMENT MARKING AND SIGNAGE PLAN - AREA "C PAVEMENT MARKING AND SIGNAGE PLAN - AREA "D PAVEMENT MARKING AND SIGNAGE PLAN - AREA "H SITE DETAILS STORM DRAINAGE DETAILS STORM DRAINAGE DETAILS WATER DETAILS SANITARY SEWER DETAIL SANITARY SEWER DETAILS STORMWATER CONTROL MEASURE "A" DETAILS STORMWATER CONTROL MEASURE "A" LANDSCAPE PLAN STORMWATER CONTROL MEASURE "C" PLAN VIEW TORMWATER CONTROL MEASURE "C" DETAILS STORMWATER CONTROL MEASURE "C" DETAILS STORMWATER CONTROL MEASURE "C" LANDSCAPE PLAN STORMWATER CONTROL MEASURE "D" PLAN VIEW STORMWATER CONTROL MEASURE "D" DETAILS STORMWATER CONTROL MEASURE "D" LANDSCAPE PLAN STORMWATER CONTROL MEASURE "E" PLAN VIEW STORMWATER CONTROL MEASURE "E" DETAILS STORMWATER CONTROL MEASURE "E" LANDSCAPE PLAN STORMWATER CONTROL MEASURE "F" PLAN VIEW STORMWATER CONTROL MEASURE "F" DETAILS STORMWATER CONTROL MEASURE "F" DETAILS STORMWATER CONTROL MEASURE "P" DETAILS STORMWATER CONTROL MEASURE "P" DETAILS STORMWATER CONTROL MEASURE "P" LANDSCAPE PLAN LANDSCAPE PLAN AREA "A" LANDSCAPE PLAN AREA "B

The John R. McAdams Company, Inc 2905 Meridian Parkway Durham, NC 27713

phone 919. 361. 5000 fax 919. 361. 2269 license number: C-0293, C-187

www.mcadamsco.com

CONTACT


MIKE SANCHEZ sanchez@mcadamsco.com PHONE: 919. 361. 5000

CLIENT

ASHTON RALEIGH RESIDENTIAL, LLC 900 RIDGEFIELD DRIVE, SUITE 335 RALEIGH, NORTH CAROLINA 27609 PHONE: 919. 422. 7663 CONTACT: BOB MISHLER



PROJECT DIRECTORY

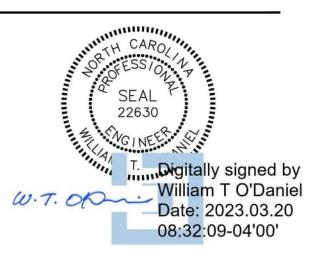

REVISIONS

FINAL DRAWING - RELEASED FOR CONSTRUCTION

NO. DATE 1 09. 20. 2022 ADDITIONAL LIMITS OF DISTURBANCE FOR SS OUTFALL "A"
2 03. 07. 2023 ADDED SCM "P"

CONSTRUCTION DRAWINGS **PACKAGE 1 FOR:**

THE POINT PHASES 1, 2, 6 AND 9 EAST YOUNG STREET ROLESVILLE, NORTH CAROLINA PROJECT NUMBER: AWH-20000

THE POINT - PHASES 3, 4, 5, 7 AND 10

15.4.5 - Streets

Type of Street Required All subdivision lots shall abut at least 20 feet on a public street. All public streets shall be dedicated to the Town of Rolesville, the State of North Carolina or the public as determined appropriate by the Board of Commissioners of the Town of Rolesville. All public streets shall be built to the standards of this ordinance and all other applicable standards of the Town of Rolesville and the North Carolina Department of Transportation. Public streets not dedicated to the Town which are eligible for acceptance into the State Highway System shall be constructed to the standards necessary to be put on the State Highway System or the standards in this ordinance, whichever is stricter, in regard to each particular item and shall be put on such system. Streets not dedicated to the Town which are not eligible to be put on the State Highway System because there are too few lots or residences shall, nevertheless, be dedicated to the public and shall be in accordance with the standards in this ordinance or the standards necessary to be put on the State Highway System, whichever is stricter in regard to each particular item, so as to be

later date. A written maintenance agreement with provisions for maintenance of the street until it is put on the State System shall be included with the final plat.

Subdivision Street Disclosure Statement All streets shown on the final plat shall be designated in accordance with G.S. § 136-102.6 and designation as public shall be conclusively presumed an offer of dedication to the public. Where streets are dedicated to the public but not accepted into a municipal or the State system, before lots are sold, a statement explaining the status of the street shall be included with the final plat.

PARCEL OWNER LIST			
PIN	OWNER	AREA	
1768131851	ASHTON RALEIGH RESIDENTIAL, LLC 4025 LAKE BOONE TRAIL, SUITE 200 RALEIGH, NORTH CAROLINA 27607	31.13 AC.	
1768254698	BROOKFIELD HOLDINGS (THE POINTE) LLC ANDREW BRAUSA 250 VESEY STREET FL 15 NEW YORK, NY 10281-1065	109.24 AC.	
1768347557	ASHTON RALEIGH RESIDENTIAL, LLC 4025 LAKE BOONE TRAIL, SUITE 200 RALEIGH, NORTH CAROLINA 27607	11.90 AC.	
1758839170	ASHTON RALEIGH RESIDENTIAL, LLC 4025 LAKE BOONE TRAIL, SUITE 200 RALEIGH, NORTH CAROLINA 27607	47.53 AC.	

SURVEY BY:

NC LICENSE # 4752


BATEMAN CIVIL SURVEY COMPANY 2424 RELIANCE AVENUE, APEX, NC 27539

TOPOGRAPHIC DECEMBER 22, 2019 ALTA SURVEY DECEMBER 12, 2019 STEVEN P CARSON, PLS

SURVEY NOTES

- THE PROPERTY LIES IN ZONE "X" PER NATIONAL FLOOD INSURANCE PROGRAM RATE MAP 3720175800J & 3720176800J DATES 05/02/2006.
- ALL DISTANCES ARE HORIZONTAL GROUND DISTANCES AND ALL BEARINGS ARE BASED ON OBSERVED GPS CONTROL. NAD 83 / NSRS 2011 / STATE PLANE COORDINATES.
- SUBJECT PARCEL ZONED R & PUD PER WAKE COUNTY GIS. SURVEY WAS PREPARED BY BATEMAN CIVIL SURVEY COMPANY UNDER THE SUPERVISION OF STEVEN P. CARSON, PLS. FIELD WORK WAS COMPLETED DEC 3 - 21, 2018.
- AREAS COMPUTED BY COORDINATE METHOD.
- SANITARY SEWER LINE EASEMENT WAS CREATED BASED ON CENTER LINES ON MANHOLES USING FIELD EVIDENCE.
- NO CEMETERIES OBSERVED AS A RESULT OF THE SURVEY. BUILDINGS ARE AS SHOWN ON SURVEY.

Total Areas For Lots					
SF-60=	0	sf			
SF-40=	0	sf			
SF-39=	0	sf			
SF-50=	1047229	sf			
TH-22	343630	sf			
Lot Assumptions Breakdown					
	Impervious	Roof(70% Imp.)	Sidewalk(10% Imp.)	Driveway(20% Imp.)	Pervious
5F-60	0.00	0.00	0.00	0.00	0.00
SF-40	0.00	0.00	0.00	0.00	0.00
SF-39	0.00	0.00	0.00	0.00	0.00
SF-50	617865	432505	61786	123573	429364
TH-22	312703	218892	31270	62541	30927
Totals(sf)=	930568	651398	93057	186114	46029
Residential	Area				
Residential Roadway=	Area 634819	sf			
107017000000		sf sf			
Roadway=	634819				
Roadway= Grassed Right-of-ways=	634819 4524384	sf sf			
Roadway= Grassed Right-of-ways= Driveway=	634819 4524384 186114	sf sf			
Roadway= Grassed Right-of-ways= Driveway= Parking Lot=	634819 4524384 186114	sf sf			
Roadway= Grassed Right-of-ways= Driveway= Parking Lot= Roof=	634819 4524384 186114 0 651398	sf sf sf			
Roadway= Grassed Right-of-ways= Driveway= Parking Lot= Roof= Sidewalk(includes Patio)=	634819 4524384 186114 0 651398 392258	sf sf sf sf sf sf sf			
Roadway= Grassed Right-of-ways= Driveway= Parking Lot= Roof= Sidewalk(includes Patio)= Lawn=	634819 4524384 186114 0 651398 392258 460291	sf sf sf sf sf sf			
Roadway= Grassed Right-of-ways= Driveway= Parking Lot= Roof- Sidewalk(includes Patio)= Lawn= Managed Pervious=	634819 4524384 186114 0 651398 392258 450291	sf sf sf sf sf sf sf sf			
Roadway= Grassed Right-of-ways= Driveway= Parking Lot= Roof= Sidewalk(includes Patio)= Lawn= Managed Pervious= Woods(not on lots)=	634819 4524384 186114 0 651398 392258 460291 0 3023652	sf sf sf sf sf sf sf sf			

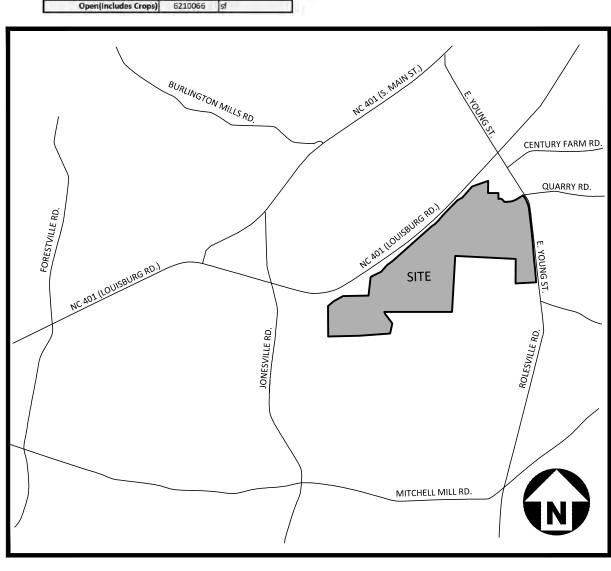


VICINITY MAP

EAST YOUNG STREET ROLESVILLE, NORTH CAROLINA

CONSTRUCTION DRAWINGS - PACKAGE 2

PROJECT NUMBER: AWH-20000 DATE: MAY 8, 2023

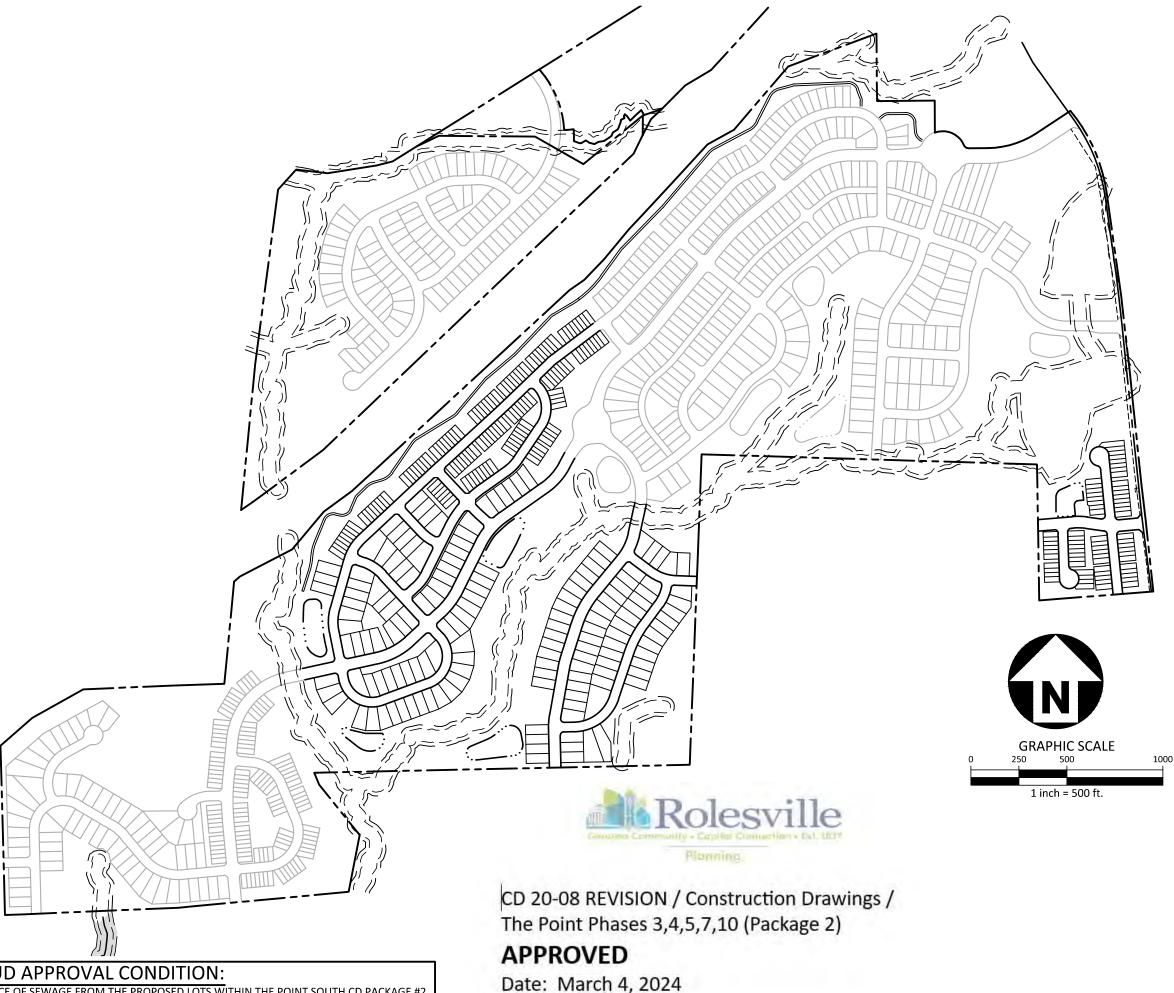

CORPUD APPROVAL CONDITION:

CONVEYANCE OF SEWAGE FROM THE PROPOSED LOTS WITHIN THE POINT SOUTH CD PACKAGE #2 WILL RELY ON IMPROVEMENTS TO THE HARRIS CREEK INTERCEPTOR THAT ARE BEING DESIGNED BY McADAMS AND AMERICAN ENGINEERING. THE PLAN SET BY McADAMS IS TITLED HARRIS CREEK INTERCEPTOR IMPROVEMENTS AND WILL BE ASSIGNED PERMIT # S-4979. THE PLAN SET BY AMERICAN ENGINEERING IS TITLED HARRIS CREEK SANITARY SEWER REPLACEMENT AND WILL BE ASSIGNED PERMIT # S-5037. THE POINT SOUTH CD PACKAGE #2 LOTS WILL NOT BE RECORDED AND THE ONSITE WATER/SEWER UTILITIES WILL NOT BE ACCEPTED BY RALEIGH UNTIL THE HARRIS CREEK INTERCEPTOR IMPROVEMENTS UNDER PERMITS # S-4979 AND # S-5037 ARE APPROVED, INSTALLED, AND ACCEPTED BY RALEIGH FOR MAINTENANCE.

EROSION CONTROL, STORMWATER AND FLOODPLAIN MANAGEMENT **APPROVED** EROSION CONTROL S-STORMWATER MGMT. ☐ S-FLOOD STUDY S-DATE

Town of Rolesville Planning Department

SITE PERMITTING APPROVAL

<u>Water and Sewer Permits (If applicable)</u> The City of Raleigh consents to the connection and extension of the City's Public Sewer System as shown on this plan. The material and Construction methods used for this project shall conform to the standards and specifications of the City's Public The City of Raleigh consents to the connection and extension of the City's Public Water System as shown on this plan. The

material and Construction methods used for this project shall conform to the standards and specifications of the City's Public The City of Raleigh consents to the connection to its public sewer system and extension of the private sewer collection system as shown on this plan. The material and constructions methods used for this project shall conform to the standards PUBLIC UTILITY IMPROVEMENTS QUANTITIES

and specifications of the City's Public Utilities Handbook. City of Raleigh Public Utilities Department Permit # _____

CITY OF RALEIGH - PLANS AUTHORIZED FOR CONSTRUCTION Electronic Approval: This approval is being issued electronically. This approval is valid only upon the signature of a City of Raleigh Review Officer below. The City will retain a copy of the approved plans. Any work authorized by this approval must proceed in accordance with the plans kept on file with the City. This electronic approval may not be edited once issued. Any modification to this approval once issued will invalidate this approval.

Timothy Beasley

Timothy Beasley

Timothy Beasley City of Raleigh Development Approval

QUANTITIE	S:	
STREETS		
QUARRY ROAD "1""	60' R/W	1,833 LF
ATHIRST WAY	50' R/W	418 LF
CHERUBIC WAY	50' R/W	305 LF
CHARM COURT	50' R/W	968 LF
FETCHING PLACE	60' R/W	1,484 LF
LINEAGE PLACE	50' R/W	410 LF
MIRTH COURT	50' R/W	724 LF
ROSY COURT	50' R/W	290 LF
PARAGON PLACE	50' R/W	544 LF
SANGUINE WAY	50' R/W	1,429 LF
STRIPS DRIVE	60' R/W	564 LF
SERAPHIC WAY	50' R/W	1,060 LF
SOLACE WAY	50' R/W	2,342 LF

(CONSTRUCTION DRAWINGS - PACKAGE 2)		
HASE NUMBER	ALL PHASES	
UMBER OF LOTS	357	
OT NUMBERS	267-623	
" PUBLIC WATER (LF)	616 LF	
" PUBLIC WATER (LF)	6,948 LF	
2" PUBLIC WATER (LF)	3,802 LF	
" PUBLIC SEWER (LF)	12,298 LF	
VATER SERVICE STUBS	357	
EWER SERVICE STUBS	357	

PROJECT NOTES AND SITE DETAILS TYPICAL SECTIONS OPEN SPACE PLAN OVERALL EXISTING CONDITIONS **EXISTING CONDITIONS AND DEMOLITION PLAN EXISTING CONDITIONS AND DEMOLITION PLAN** EXISTING CONDITIONS AND DEMOLITION PLAN EXISTING CONDITIONS AND DEMOLITION PLAN SITE PLAN - AREA "C SITE PLAN - AREA "F SITE PLAN - AREA "G SITE PLAN - AREA "I SITE PLAN - AREA "J' SITE PLAN - AREA "K' SITE PLAN - AREA "L SITE PLAN - AREA "O SITE PLAN - AREA "P' OVERALL GRADING AND STORM DRAINAGE PLAN GRADING AND STORM DRAINAGE PLAN - AREA "C" FINE GRADING AND STORM DRAINAGE PLAN - AREA " FINE GRADING AND STORM DRAINAGE PLAN - AREA "J FINE GRADING AND STORM DRAINAGE PLAN - AREA "I FINE GRADING AND STORM DRAINAGE PLAN - AREA "C FINE GRADING AND STORM DRAINAGE PLAN - AREA "F OVERALL UTILITY PLAN UTILITY PLAN - AREA "C UTILITY PLAN - AREA "F' UTILITY PLAN - AREA "G' UTILITY PLAN - AREA "I' UTILITY PLAN - ARFA "I UTILITY PLAN - AREA "K" UTILITY PLAN - AREA "L" UTILITY PLAN - AREA "O" UTILITY PLAN - AREA "P" PLAN AND PROFILE - QUARRY ROAD "1" STA. 23+00.00 THRU STA. 34+50.00 PLAN AND PROFILE - QUARRY ROAD "1" STA. 34+50.00 THRU STA. 43+00.00 PLAN AND PROFILE - ATHIRST WAY PLAN AND PROFILE - CHERUBIC WAY PLAN AND PROFILE - CHARM COURT PLAN AND PROFILE - FETCHING PLACE STA. 10+00.00 THRU STA. 20+00.00 PLAN AND PROFILE - FETCHING PLACE STA. 20+00.00 THRU STA. 25+00.00 PLAN AND PROFILE - LINEAGE PLACE PLAN AND PROFILE - MIRTH COURT PLAN AND PROFILE - ROSY COURT PLAN AND PROFILE - PARAGON PLACE PLAN AND PROFILE - SANGUINE WAY STA. 9+50.00 THRU STA. 21+00.00 PLAN AND PROFILE - SANGUINE WAY STA. 21+00.00 THRU STA. 24+50.00 PLAN AND PROFILE - STRIPS DRIVE PLAN AND PROFILE - SERAPHIC WAY PLAN AND PROFILE - SOLACE WAY STA. 9+50.00 THRU STA. 22+00.00 PLAN AND PROFILE - SOLACE WAY STA. 22+00.00 THRU STA. 34+00.00 PLAN AND PROFILE - SANITARY SEWER OUTFALL "G" AND "F" PLAN AND PROFILE - SANITARY SEWER OUTFALL "H" AND "I" PLAN AND PROFILE - GREENWAY "3" STA. 10+00.00 THRU STA. 22+00.00 PLAN AND PROFILE - GREENWAY "3" STA. 22+00.00 THRU STA. 34+50.00 FROSION CONTROL NOTES EROSION CONTROL PLAN - STAGE 1 - AREA "C" EROSION CONTROL PLAN - STAGE 1 - AREA "F" EROSION CONTROL PLAN - STAGE 1 - AREA "G" EROSION CONTROL PLAN - STAGE 1 - AREA "I' FROSION CONTROL PLAN - STAGE 1 - AREA "J EROSION CONTROL PLAN - STAGE 1 - AREA "K' EROSION CONTROL PLAN - STAGE 1 - AREA "L" EROSION CONTROL PLAN - STAGE 1 - AREA "O EROSION CONTROL PLAN - STAGE 1 - AREA "P" EROSION CONTROL PLAN - STAGE 2 - AREA "C EROSION CONTROL PLAN - STAGE 2 - AREA "F' EROSION CONTROL PLAN - STAGE 2 - AREA "G EROSION CONTROL PLAN - STAGE 2 - AREA "I' EROSION CONTROL PLAN - STAGE 2 - AREA "J" EROSION CONTROL PLAN - STAGE 2 - AREA "K EROSION CONTROL PLAN - STAGE 2 - AREA "L" EROSION CONTROL PLAN - STAGE 2 - AREA "O" EROSION CONTROL PLAN - STAGE 2 - AREA "P' EROSION CONTROL DETAILS **EROSION CONTROL DETAILS EROSION CONTROL DETAILS EROSION CONTROL DETAILS** PAVEMENT MARKING AND SIGNAGE PLAN - AREA "C' PAVEMENT MARKING AND SIGNAGE PLAN - AREA "F PAVEMENT MARKING AND SIGNAGE PLAN - AREA "G PAVEMENT MARKING AND SIGNAGE PLAN - AREA "I PAVEMENT MARKING AND SIGNAGE PLAN - AREA "J" PAVEMENT MARKING AND SIGNAGE PLAN - AREA "K PAVEMENT MARKING AND SIGNAGE PLAN - AREA "L" PAVEMENT MARKING AND SIGNAGE PLAN - AREA "O PAVEMENT MARKING AND SIGNAGE PLAN - AREA "P' SITE DETAILS SITE DETAILS STORM DRAINAGE DETAILS STORM DRAINAGE DETAILS WATER DETAILS WATER DETAILS SANITARY SEWER DETAILS SANITARY SEWER DETAILS STORMWATER CONTROL MEASURE "B" PLAN VIEW STORMWATER CONTROL MEASURE "B" DETAILS STORMWATER CONTROL MEASURE "B" DETAILS STORMWATER CONTROL MEASURE "B"LANDSCAPE PLAN STORMWATER CONTROL MEASURE "G" PLAN VIEW STORMWATER CONTROL MEASURE "G" DETAILS

STORMWATER CONTROL MEASURE "G" DETAILS

STORMWATER CONTROL MEASURE "H" DETAILS

STORMWATER CONTROL MEASURE "I" DETAILS

STORMWATER CONTROL MEASURE "I" DETAILS

STORMWATER CONTROL MEASURE "J" DETAILS

STORMWATER CONTROL MEASURE "I" DETAILS

OVERALL LANDSCAPE PLAN

LANDSCAPE PLAN AREA "C

LANDSCAPE PLAN AREA "F'

LANDSCAPE PLAN AREA "G

LANDSCAPE PLAN AREA "I

LANDSCAPE PLAN AREA "J

LANDSCAPE PLAN AREA "K

LANDSCAPE PLAN AREA "L'

LANDSCAPE PLAN AREA "O'

LANDSCAPE PLAN AREA "P" LANDSCAPE NOTES & CALCULATIONS

STORMWATER CONTROL MEASURE "H" PLAN VIEW STORMWATER CONTROL MEASURE "H" DETAILS

STORMWATER CONTROL MEASURE "I" PLAN VIEW

STORMWATER CONTROL MEASURE "G" LANDSCAPE PLAN

STORMWATER CONTROL MEASURE "H" LANDSCAPE PLAN

STORMWATER CONTROL MEASURE "I" LANDSCAPE PLAN

STORMWATER CONTROL MEASURE "J" LANDSCAPE PLAN

The John R. McAdams Company, Inc 2905 Meridian Parkway Durham, NC 27713

phone 919. 361. 5000 fax 919. 361. 2269 license number: C-0293, C-187

www.mcadamsco.com

CONTACT

MIKE SANCHEZ sanchez@mcadamsco.com PHONE: 919. 361. 5000

CLIENT

ASHTON RALEIGH RESIDENTIAL, LLC 900 RIDGEFIELD DRIVE, SUITE 335 RALEIGH, NORTH CAROLINA 27609 PHONE: 919. 422. 7663 **CONTACT: BOB MISHLER**

PROJECT DIRECTORY

CD 20-08




REVISIONS

1 02. 20. 2024 REV POND, STORM DRAINAGE AND ADD WALL


CONSTRUCTION DRAWINGS PACKAGE 1 FOR:

THE POINT **PHASES 1-10 AND 14 EAST YOUNG STREET** ROLESVILLE, NORTH CAROLINA PROJECT NUMBER: AWH-20000

FINAL DRAWING - RELEASED FOR CONSTRUCTION

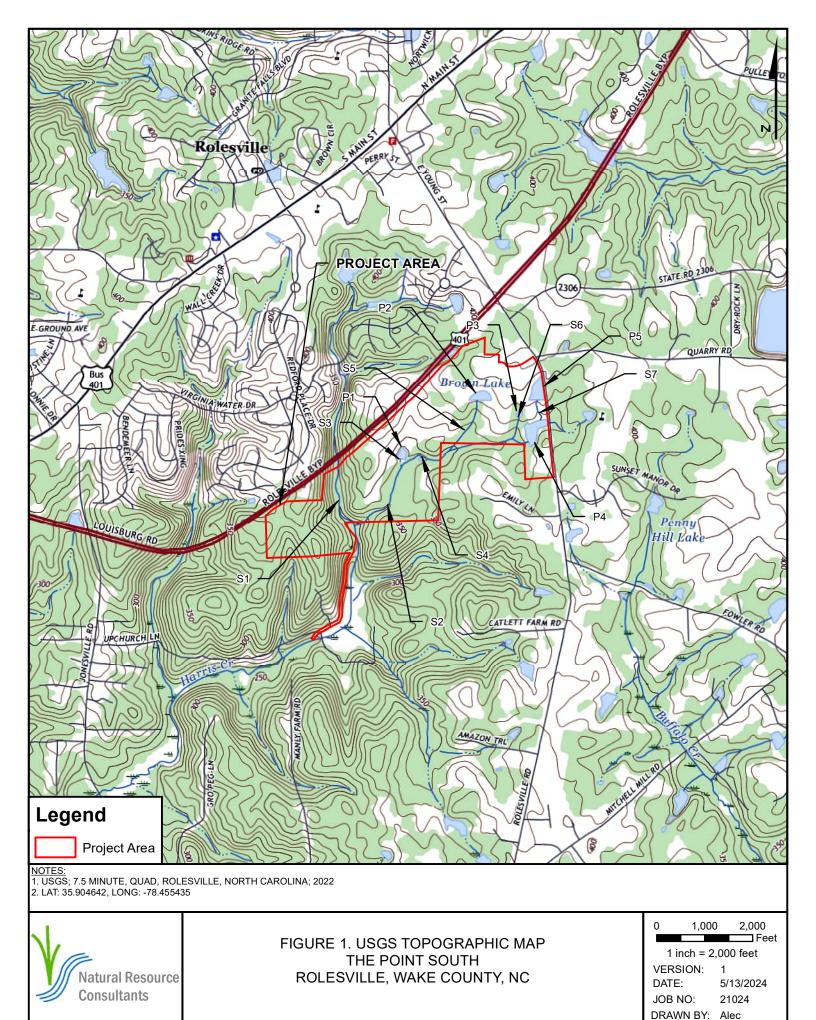

C:\Users\NRC\NRC Server\Projects\21024 Point S\GIS\Point S-Fig 1 USGS.mxd, 5/13/2024 1:51:18 PM, Alec

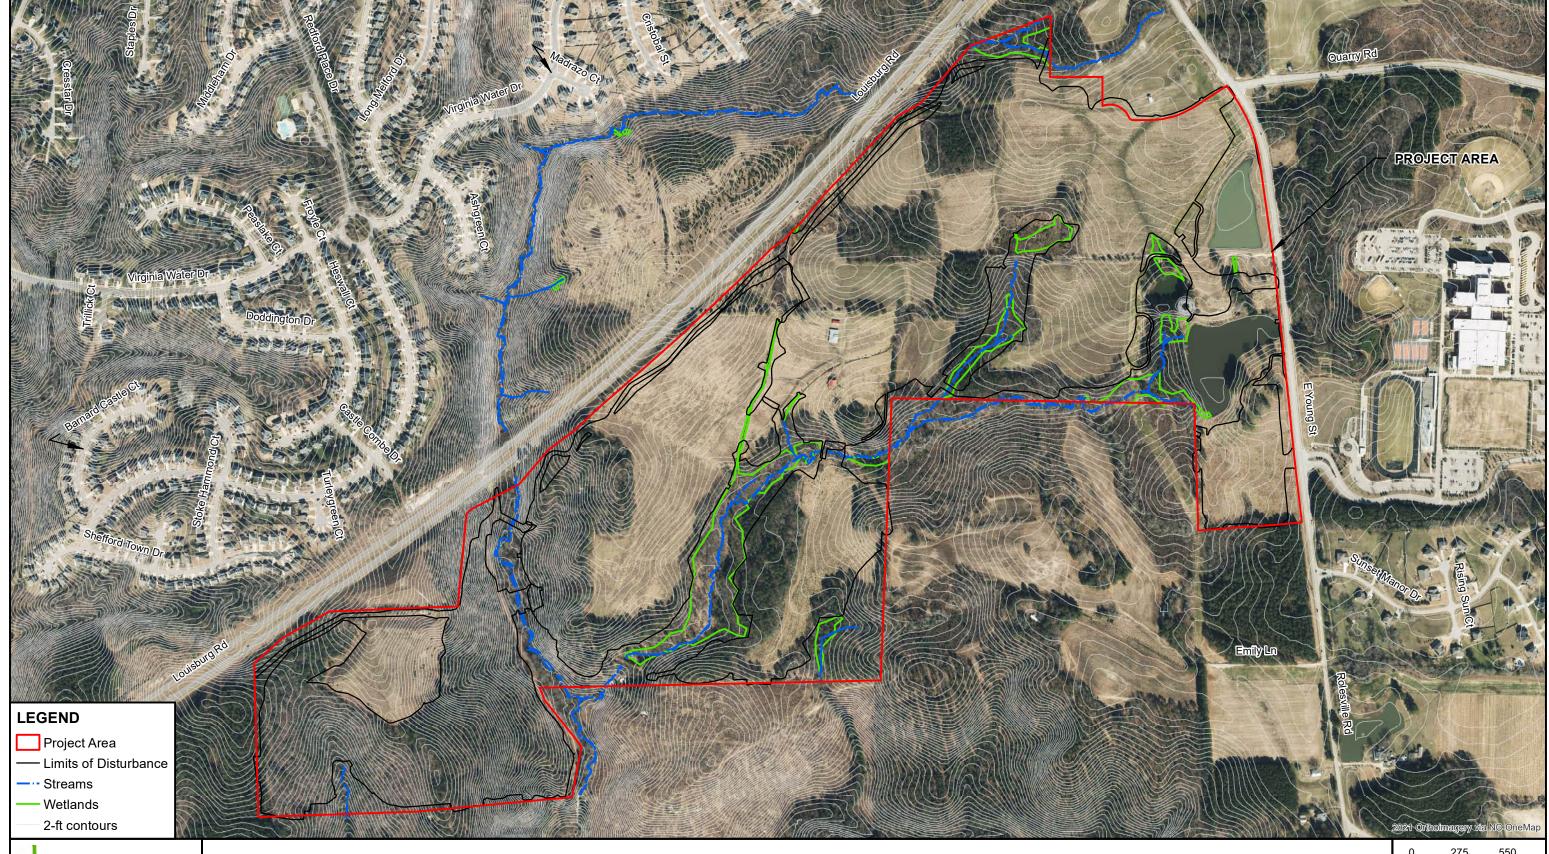

Natural Resource Consultants

FIGURE 3. AERIAL MAP THE POINT - SOUTH ROLESVILLE, WAKE COUNTY, NC


N	

	9,0			
0	275	550		
		Feet		
1 inch = 550 feet				
VERSI	ON: 1			

DATE: 5/10/2024

JOB NO: AWH-20000


DRAWN BY: Alec

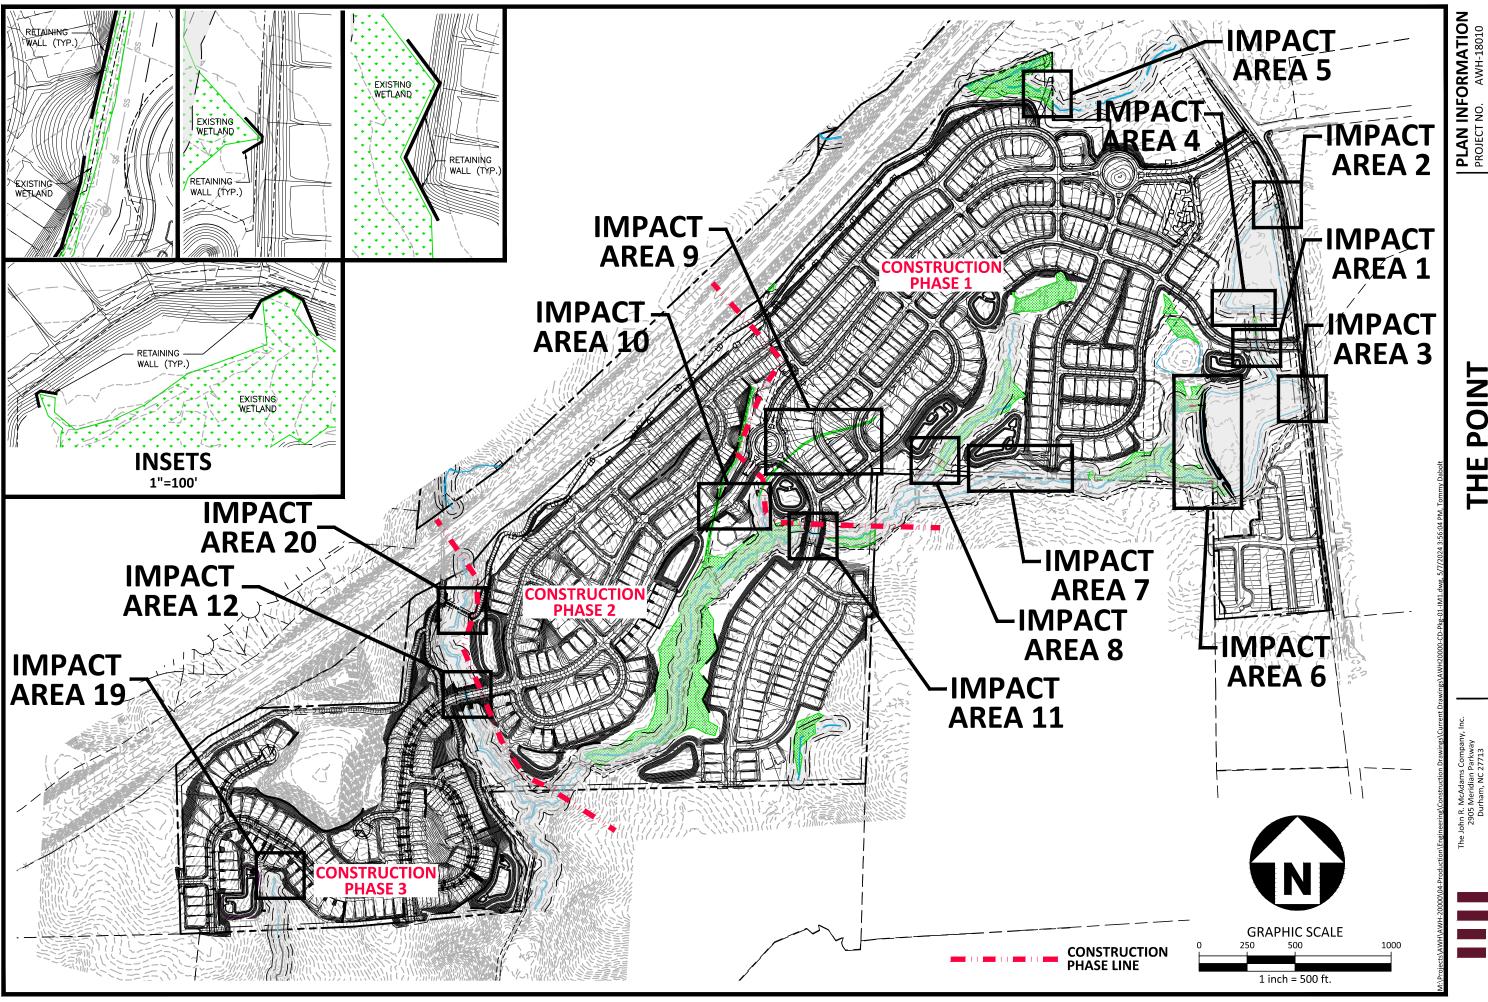

PLAN INFORMATION
PROJECT NO. AWH-18010
FILENAME AWH20000-CD-IM1
CHECKED BY JB
DRAWN BY SRW
SCALE 1"=500'
DATE 05. 07. 2024


PHASES 1-10 AND 14
OVERALL IMPACT EXHIBIT
TOWN OF ROLESVILLE, NORTH CAROLIN




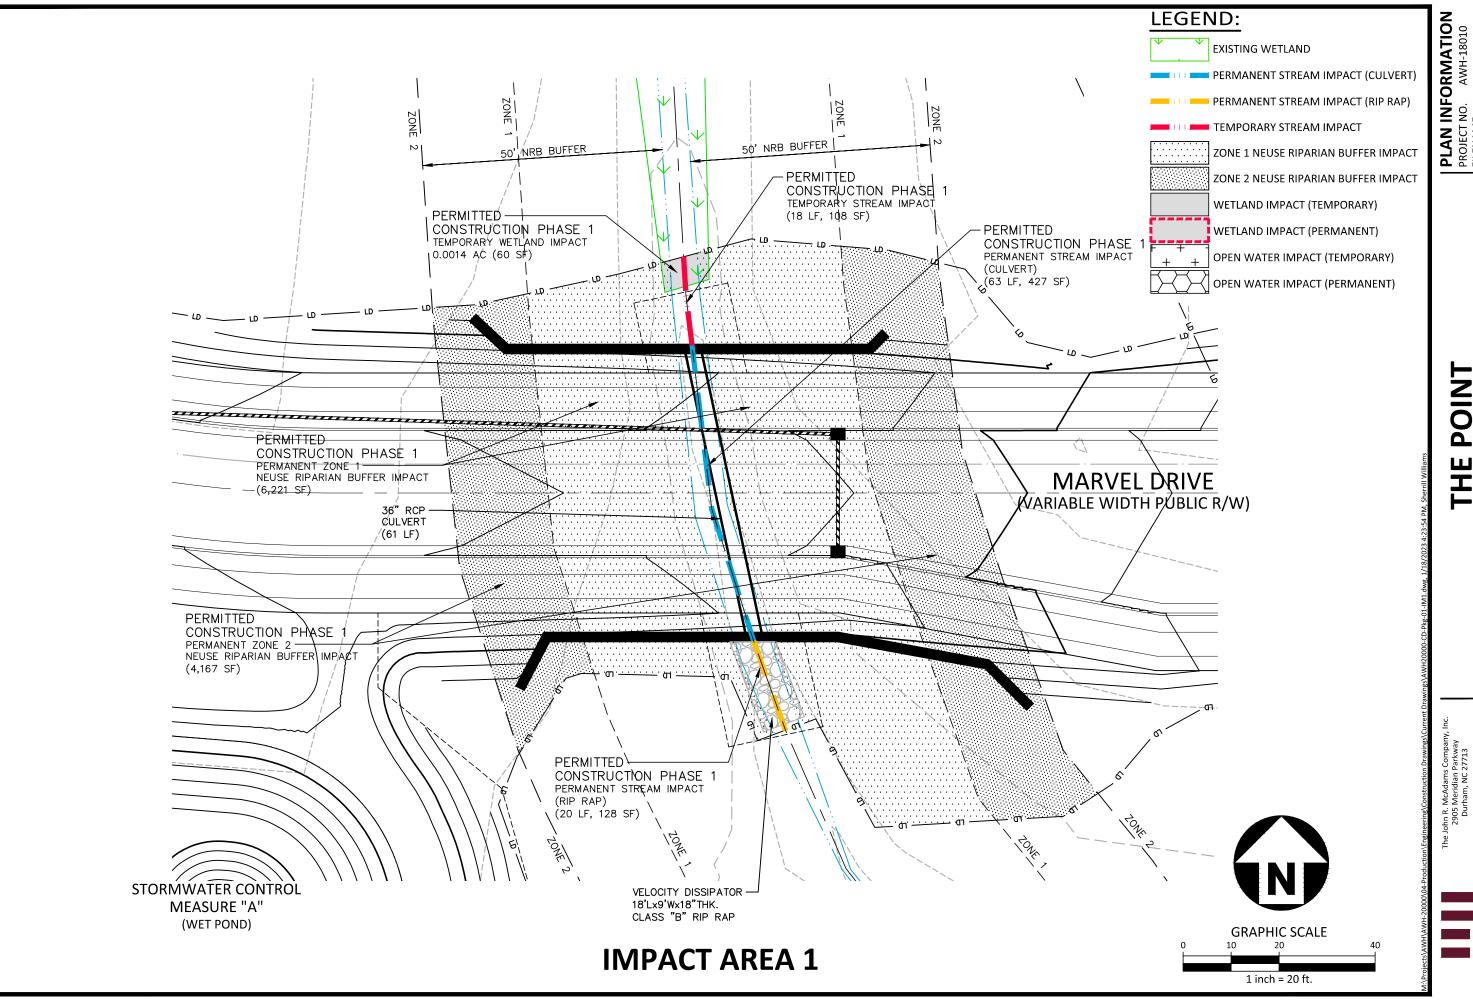

PROJECT NO. AWH-18010
FILENAME AWH20000-CD-IM1
CHECKED BY JB
DRAWN BY SRW
SCALE 1"=20'
DATE 01.19. 2023

THE POINT
PHASES 1-10 AND 14
IMPACT EXHIBIT - IMPACT AREA 1
TOWN OF ROLESVILLE, NORTH CAROLINA

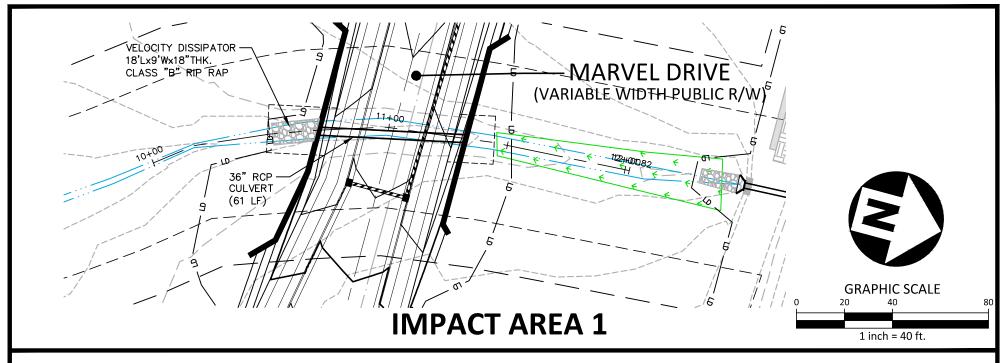

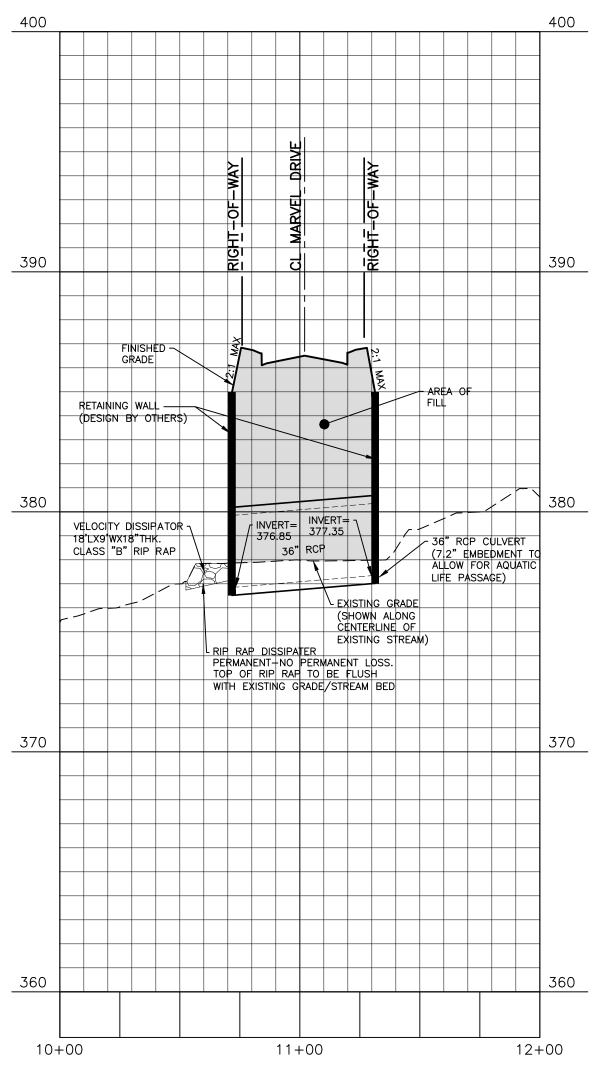



The John R. McAdams Company, Inc. 2905 Meridian Parkway Durham, NC 27713

Projects\AWH\AWH-20000\04-Production\Engineering\Construction Drawings\Current Drawings\AWH20000-CD-Pkg-01-IM1.dwg, 1/18/2023 4:31:42 PM, Sherrill Williams

phone 919. 361. 5000 fax 919. 361. 2269 license number: C-0293, C-187

www.mcadamsco.com

THE POINT


PHASES 1-10 AND 14 IMPACT EXHIBIT - CULVERT CROSS SECTION TOWN OF ROLESVILLE, NORTH CAROLINA

PLAN INFORMATION

PROJECT NO. AWH-18010 FILENAME **CHECKED BY** DRAWN BY SCALE


DATE


AWH20000-CD-IM1 JB SRW 1"=40'/1"=4' 01. 19. 2023

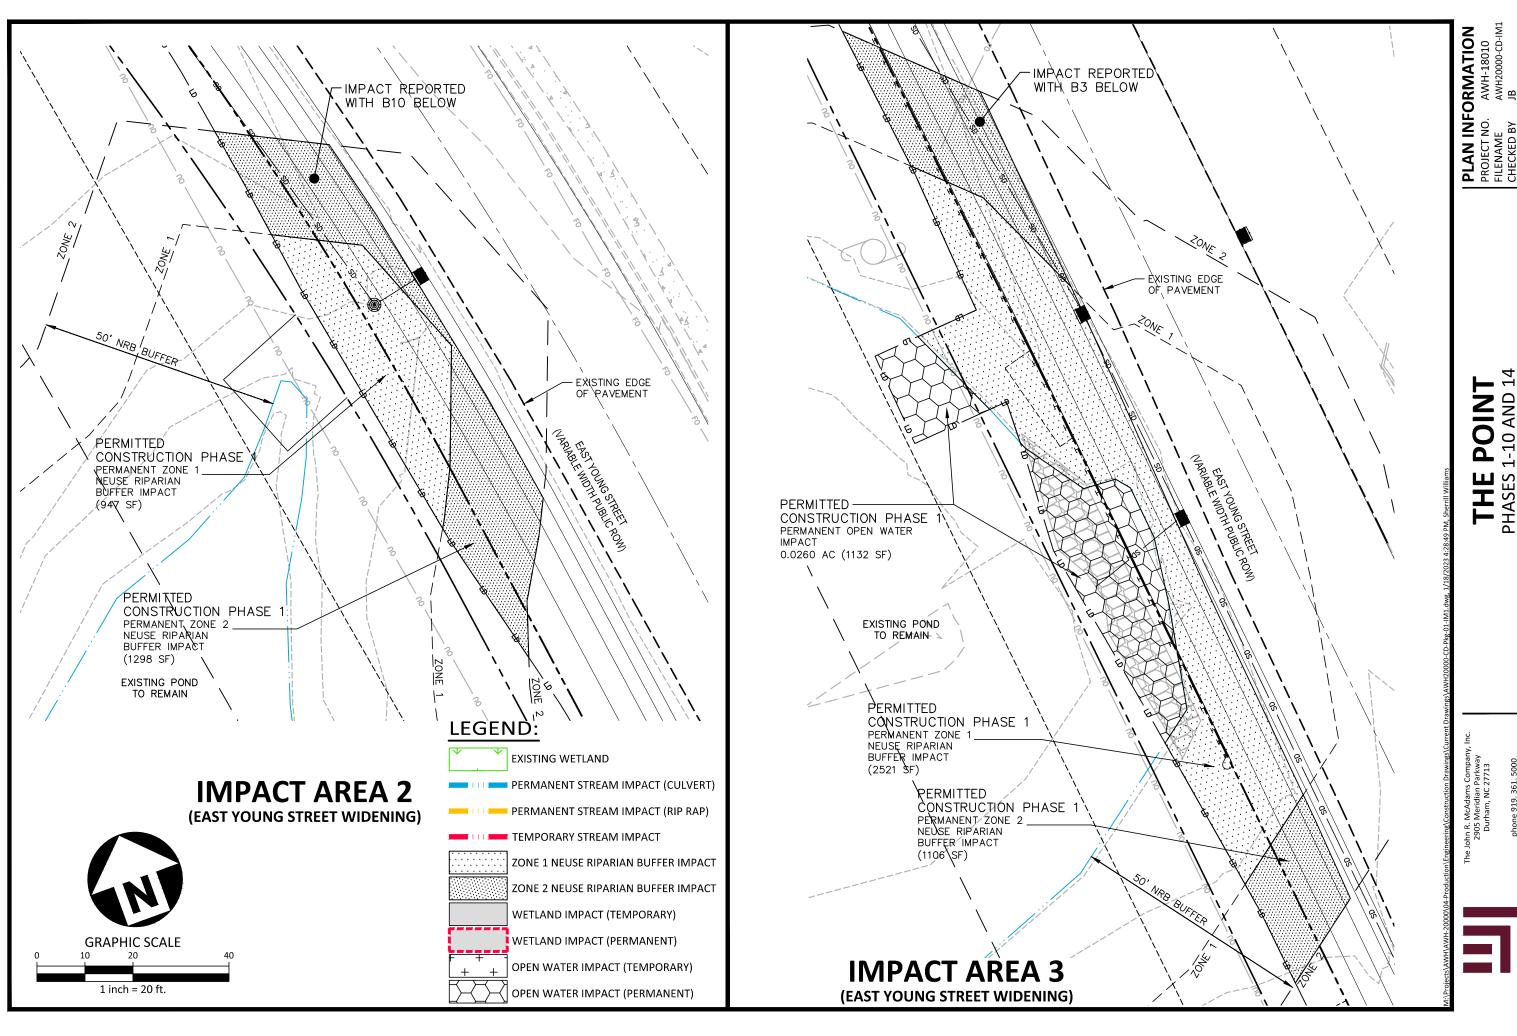


PHASES 1-10 AND 14 T EXHIBIT - IMPACT AREAS 2 TOWN OF ROLESVILLE, NORTH CAROLINA



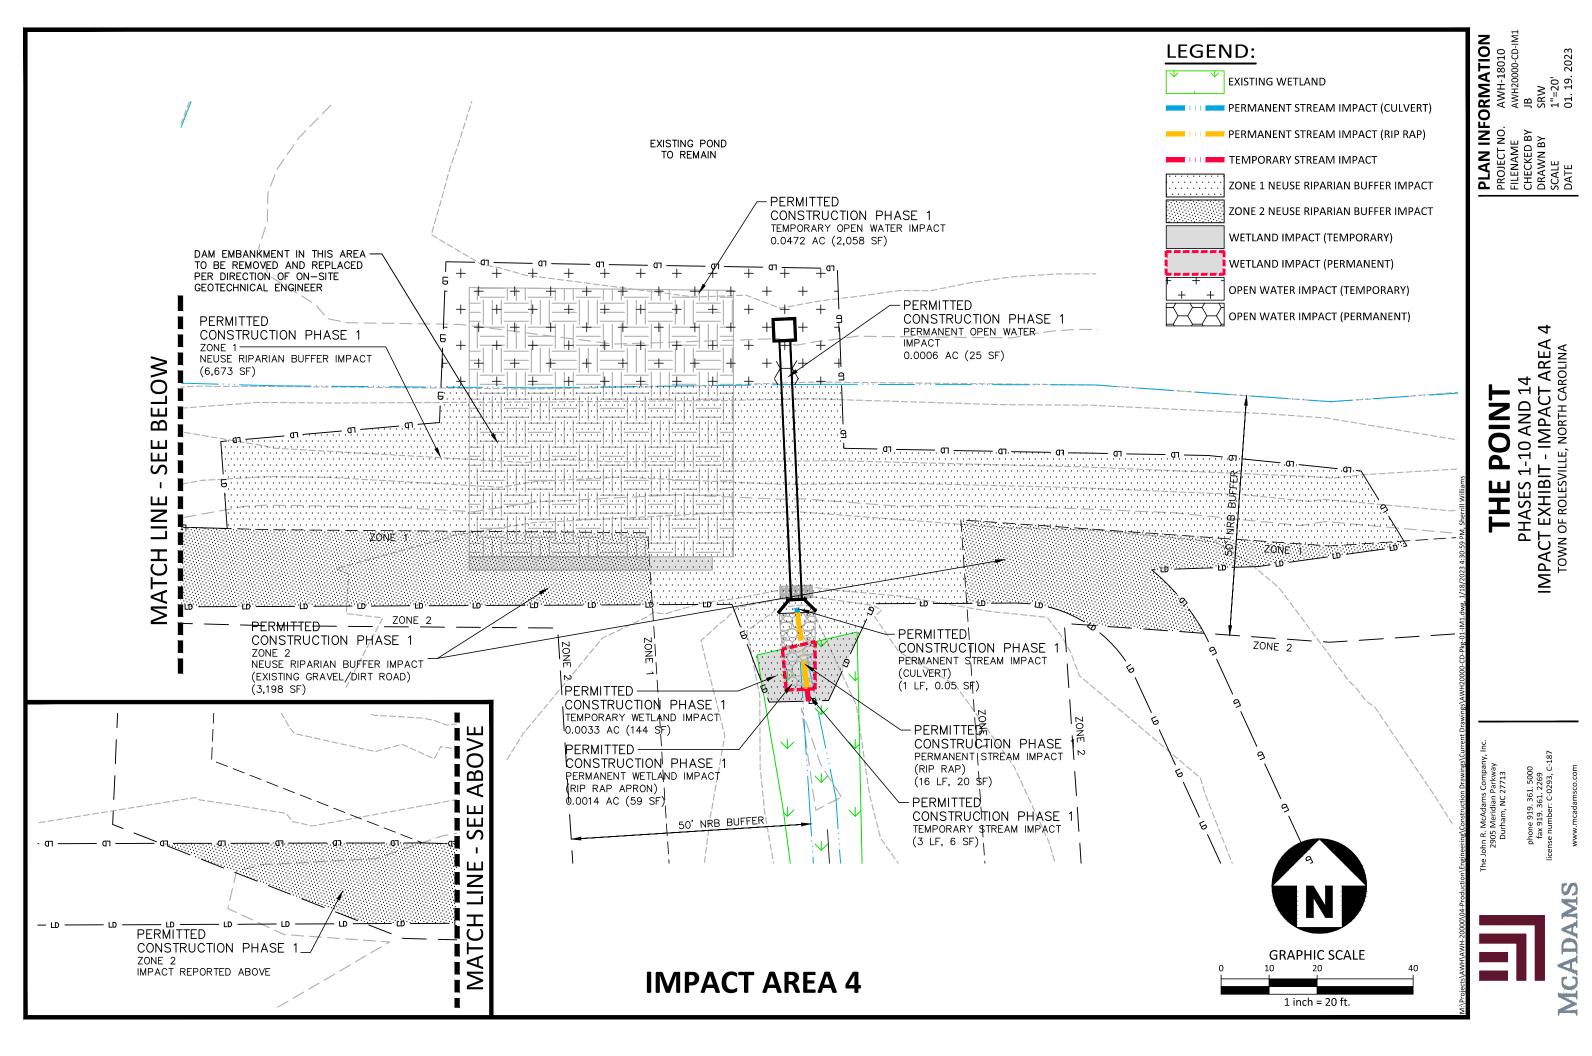

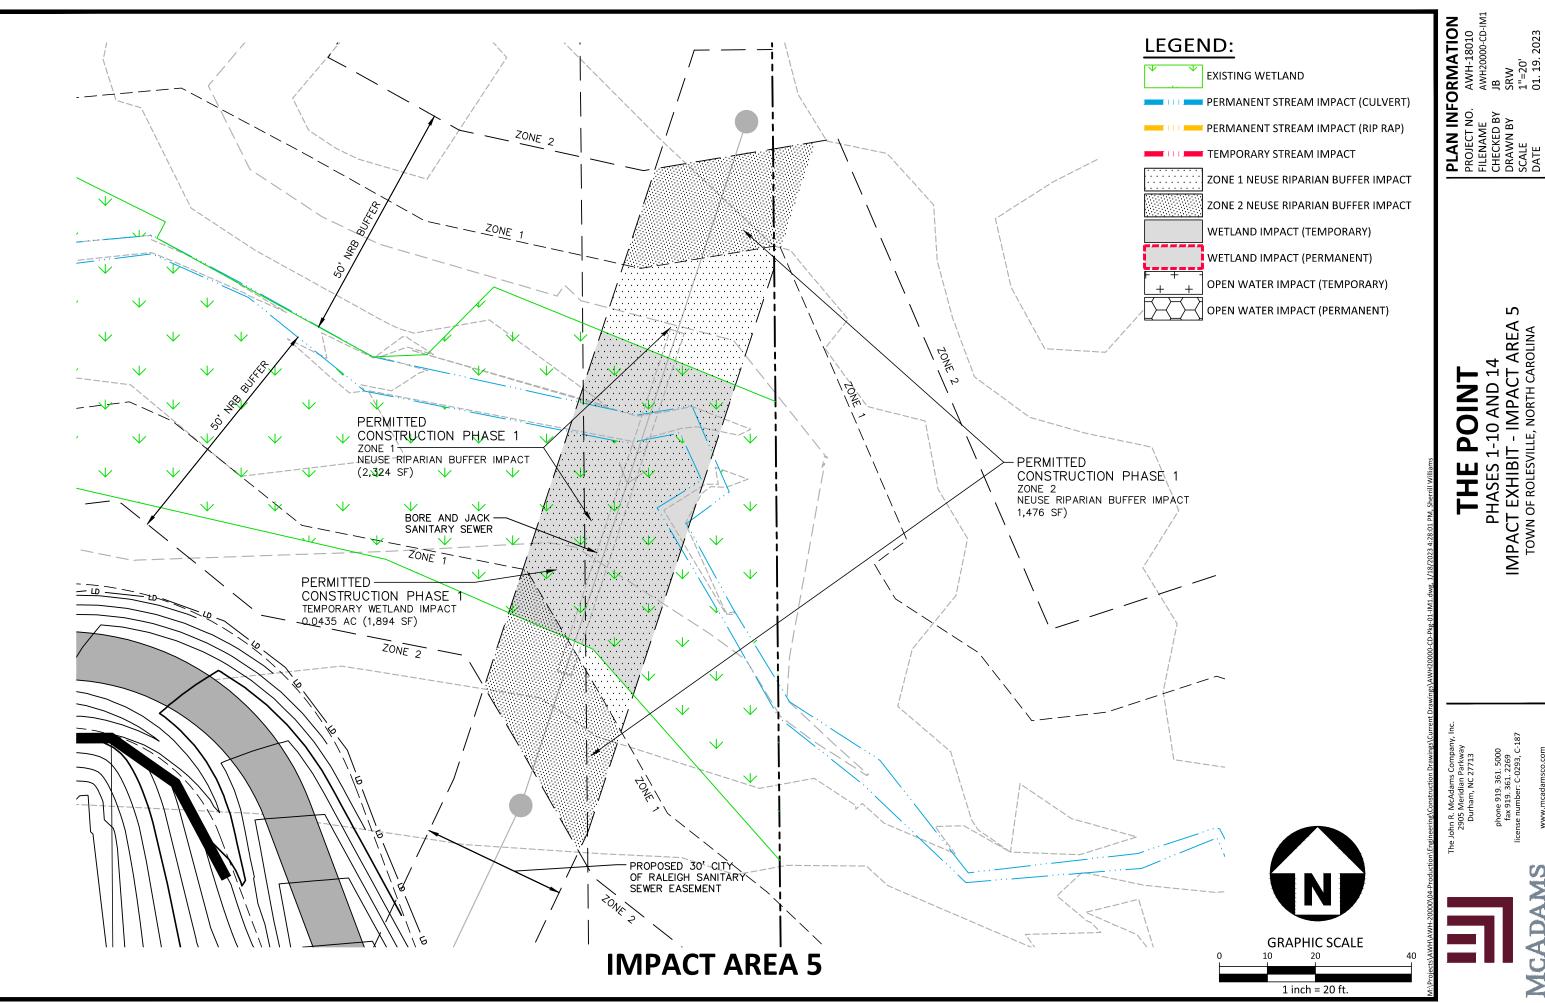




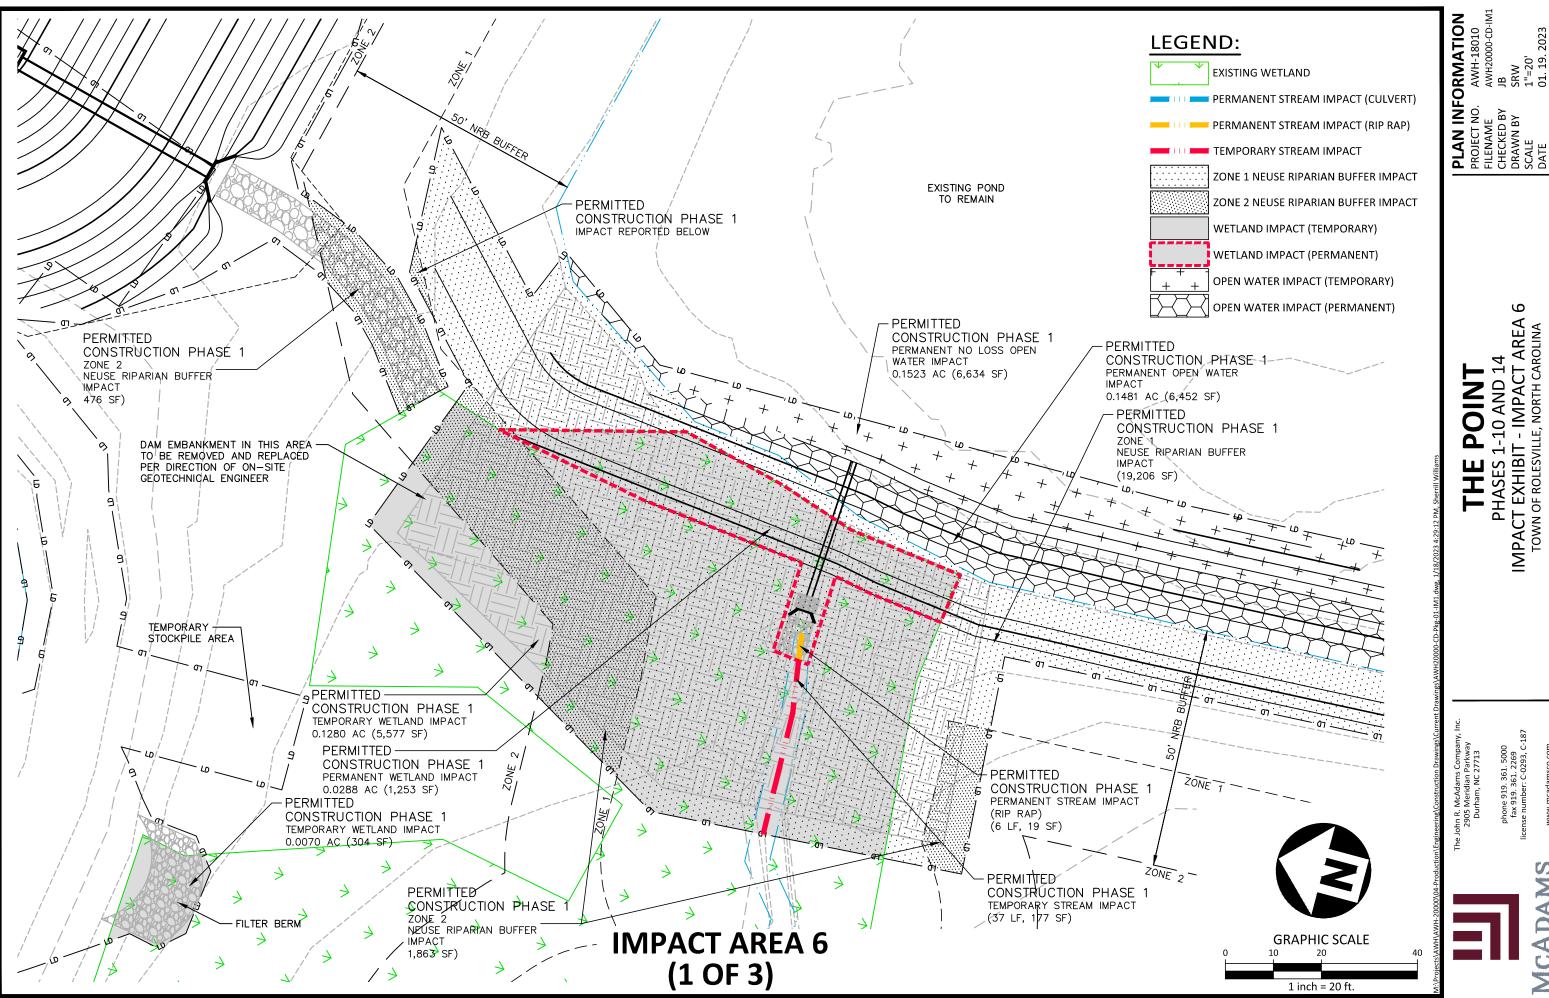

THE POINT
PHASES 1-10 AND 14
IMPACT EXHIBIT - IMPACT AREA 6
TOWN OF ROLESVILLE, NORTH CAROLINA




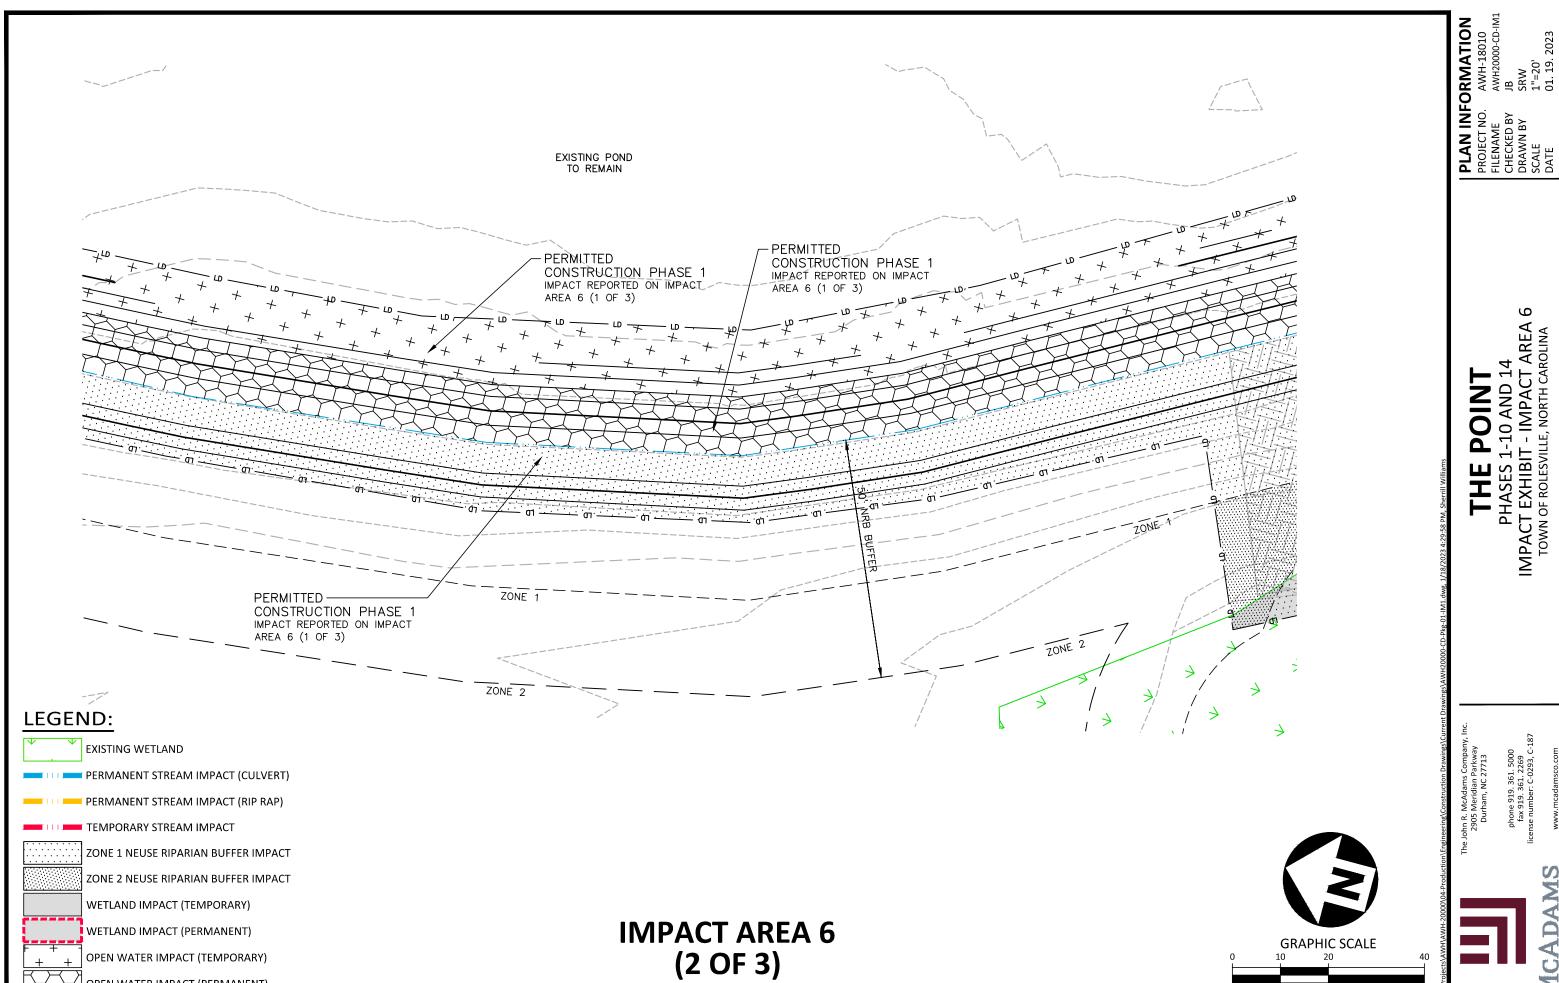


OPEN WATER IMPACT (PERMANENT)





1 inch = 20 ft.

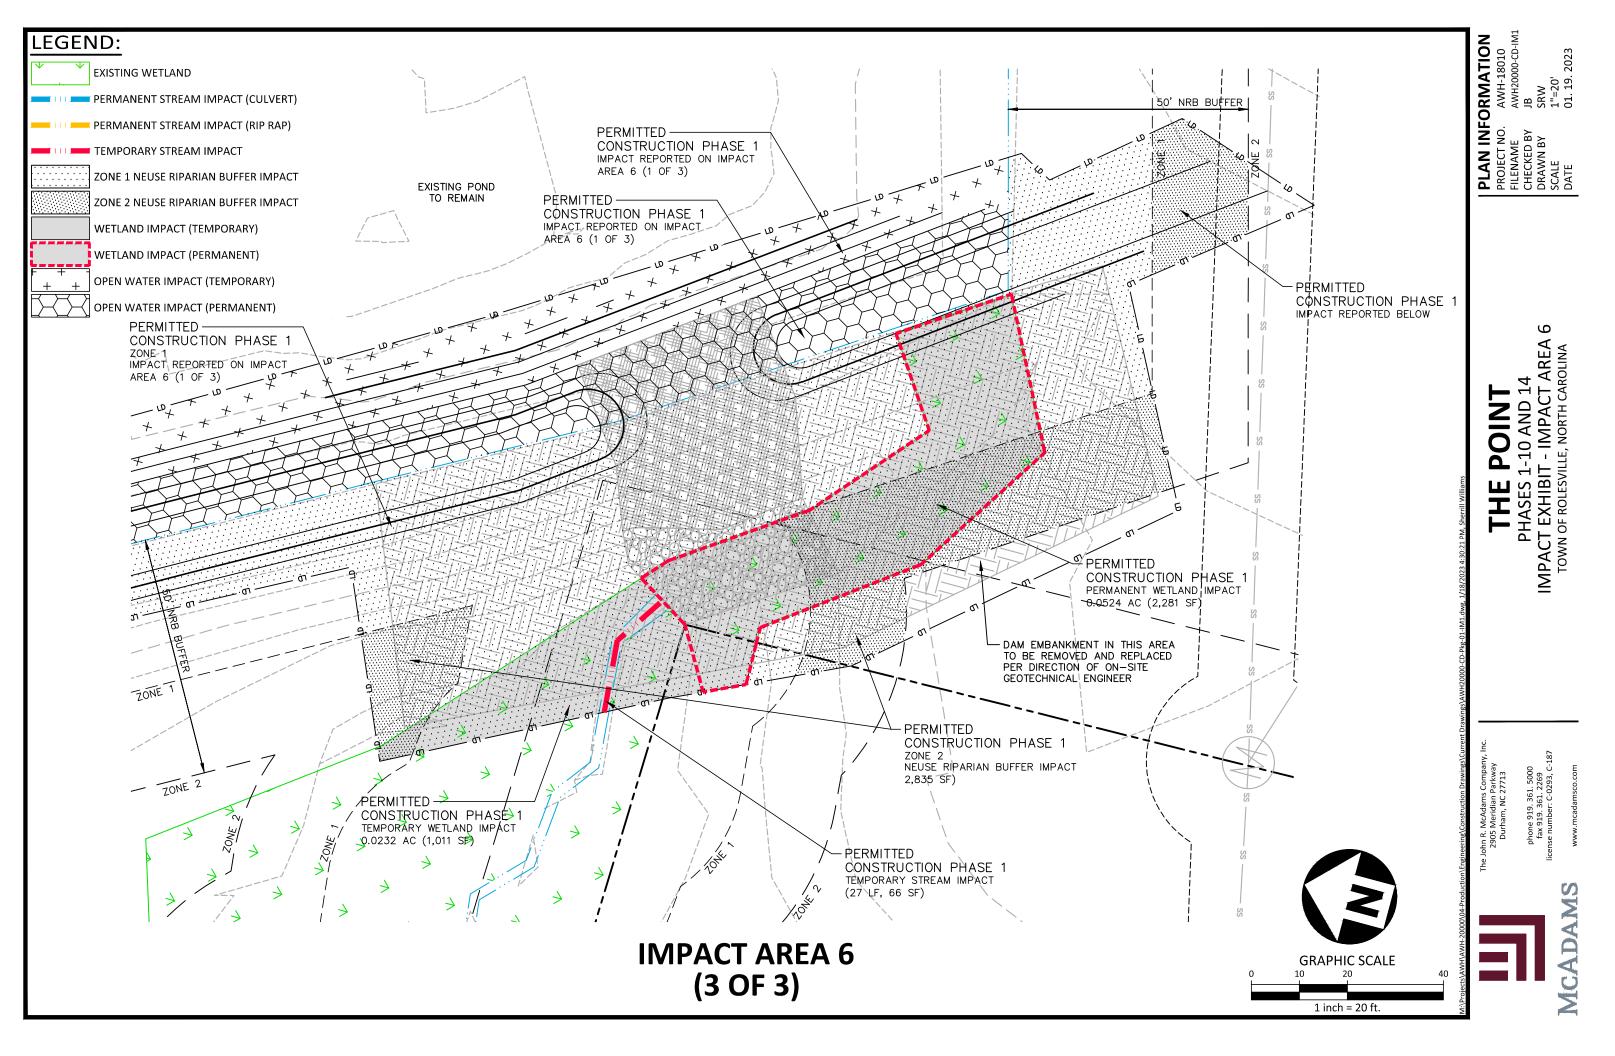


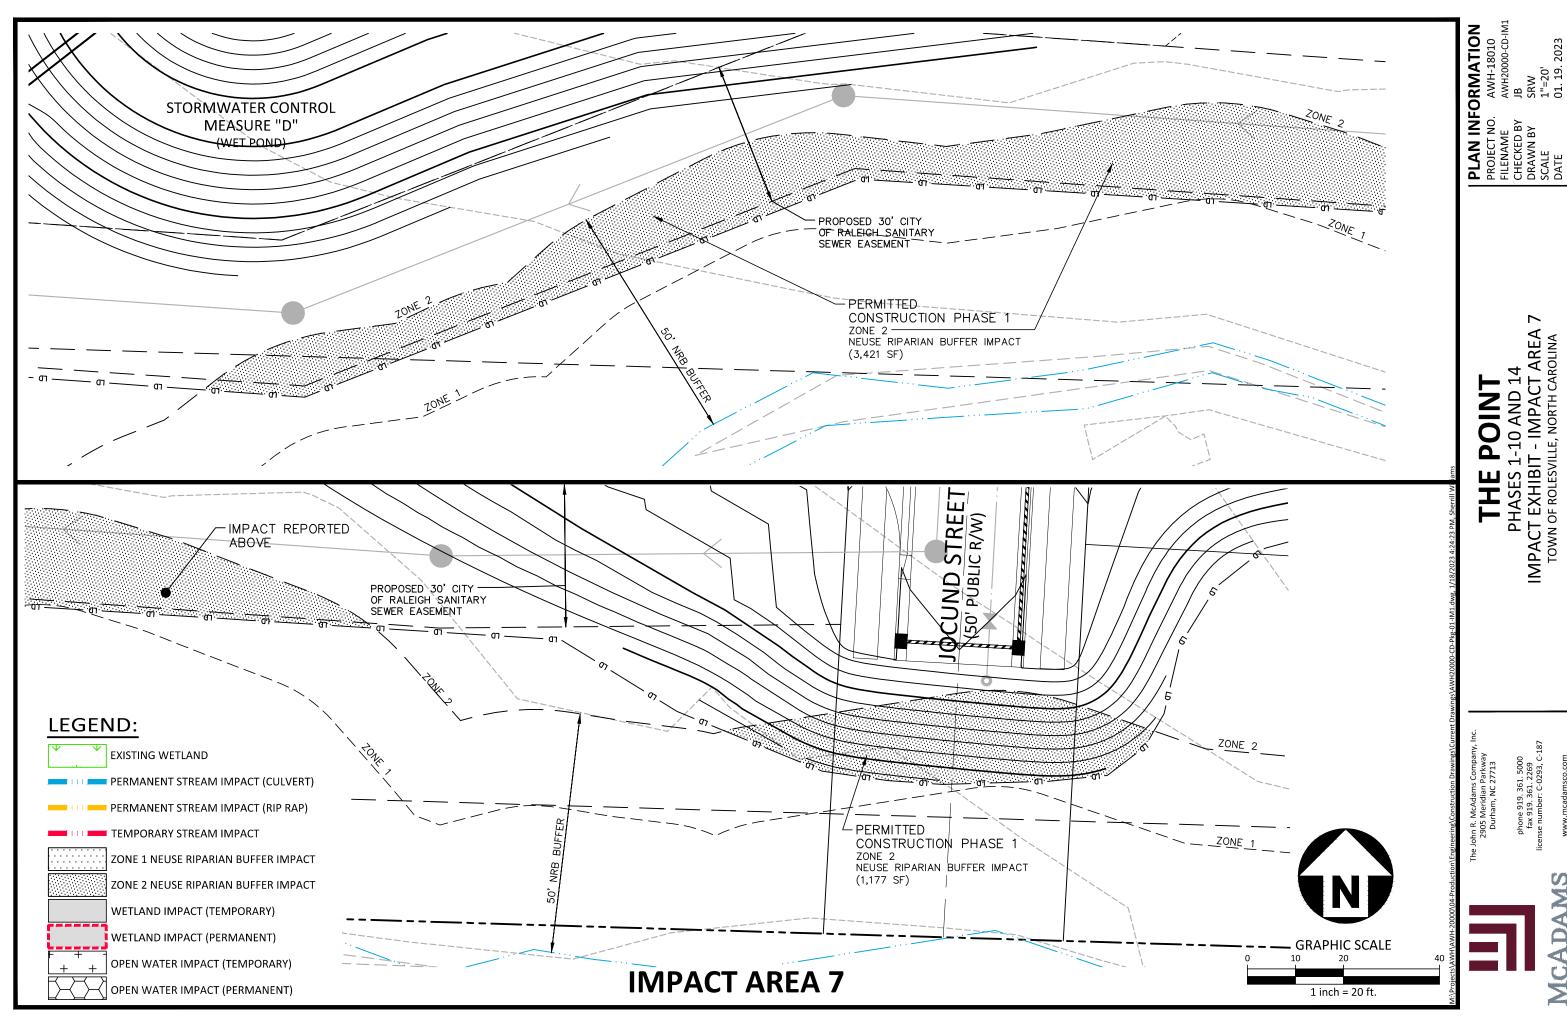





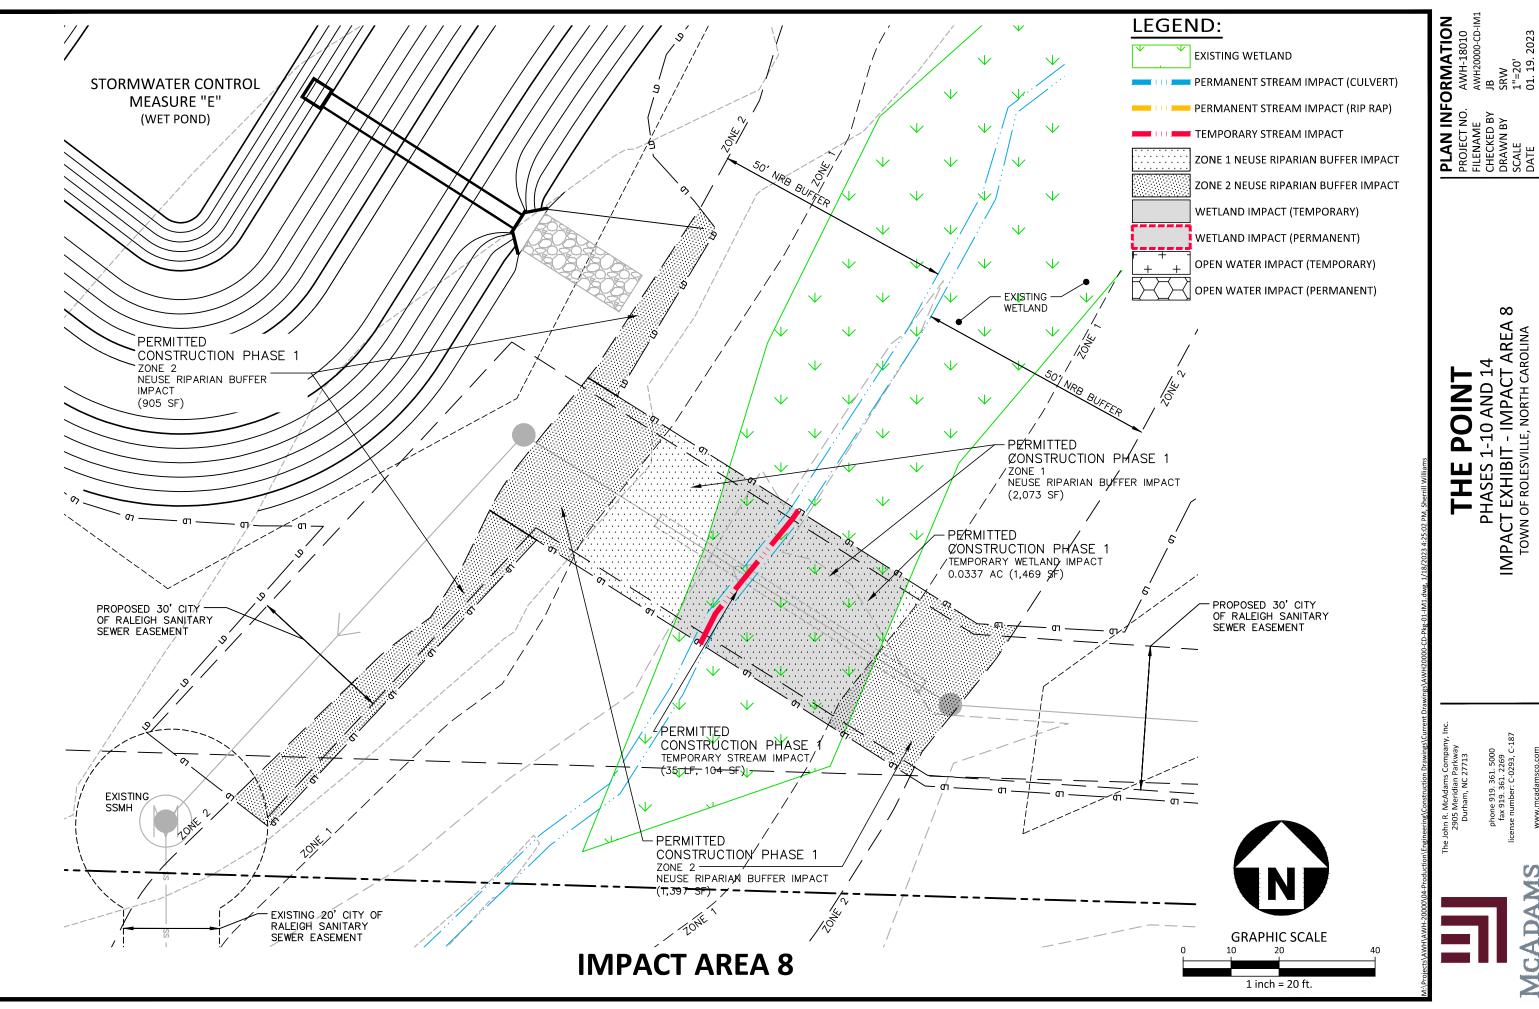

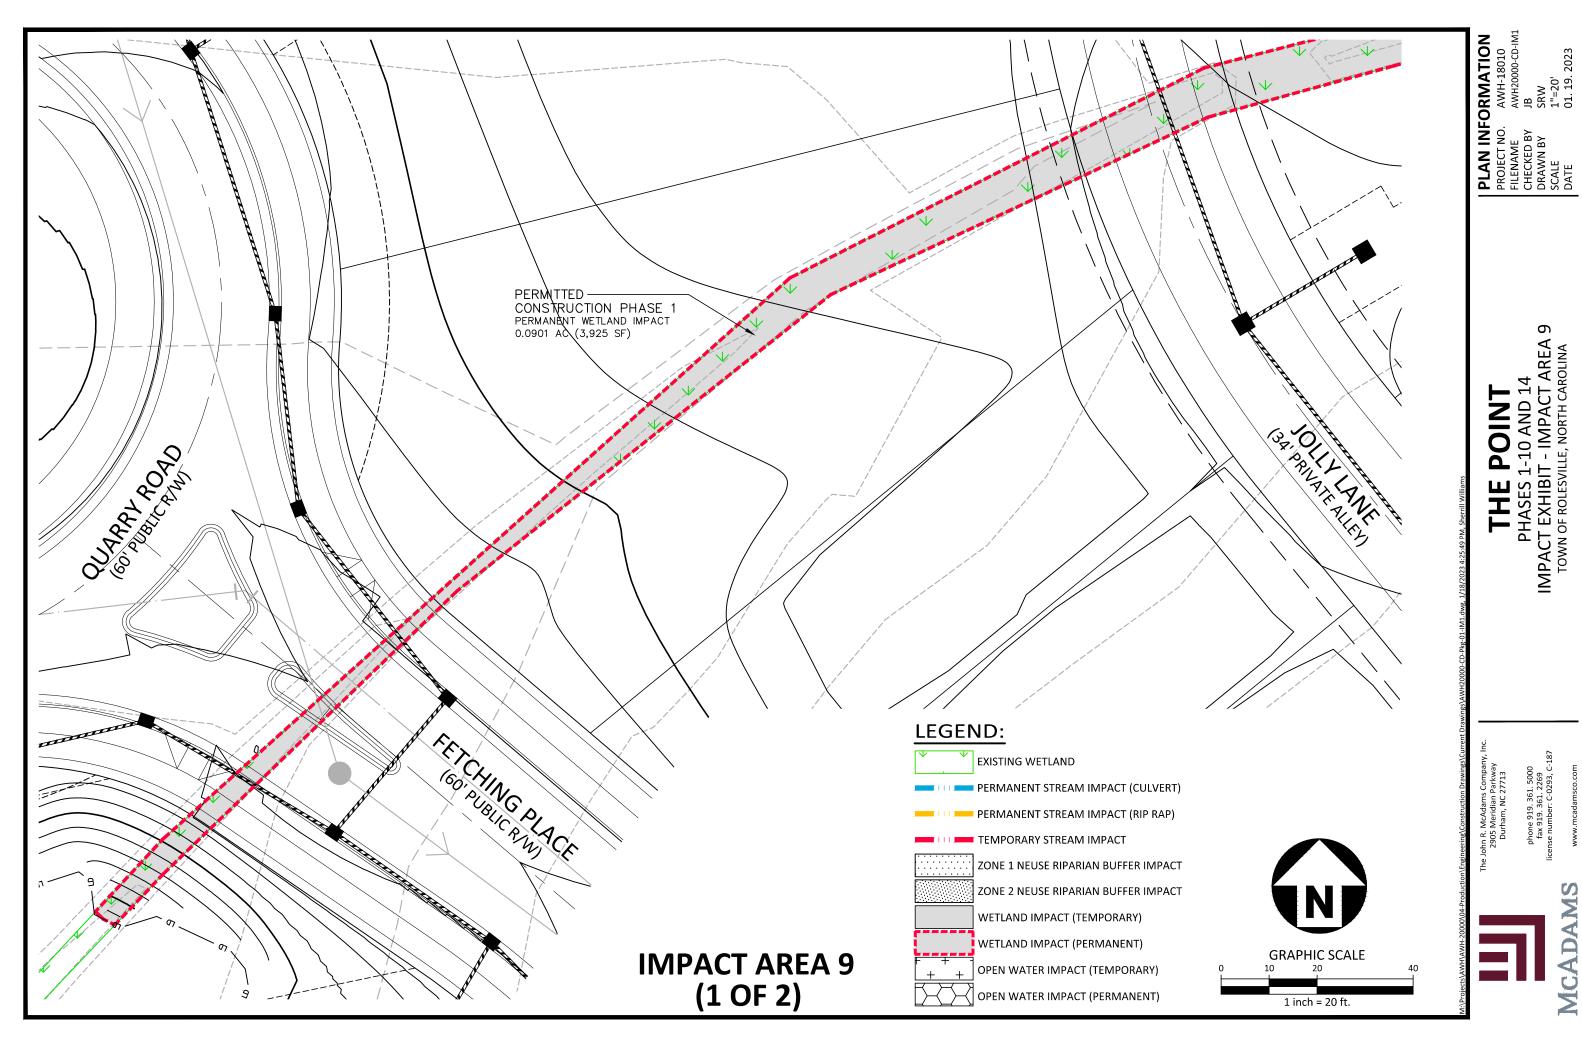

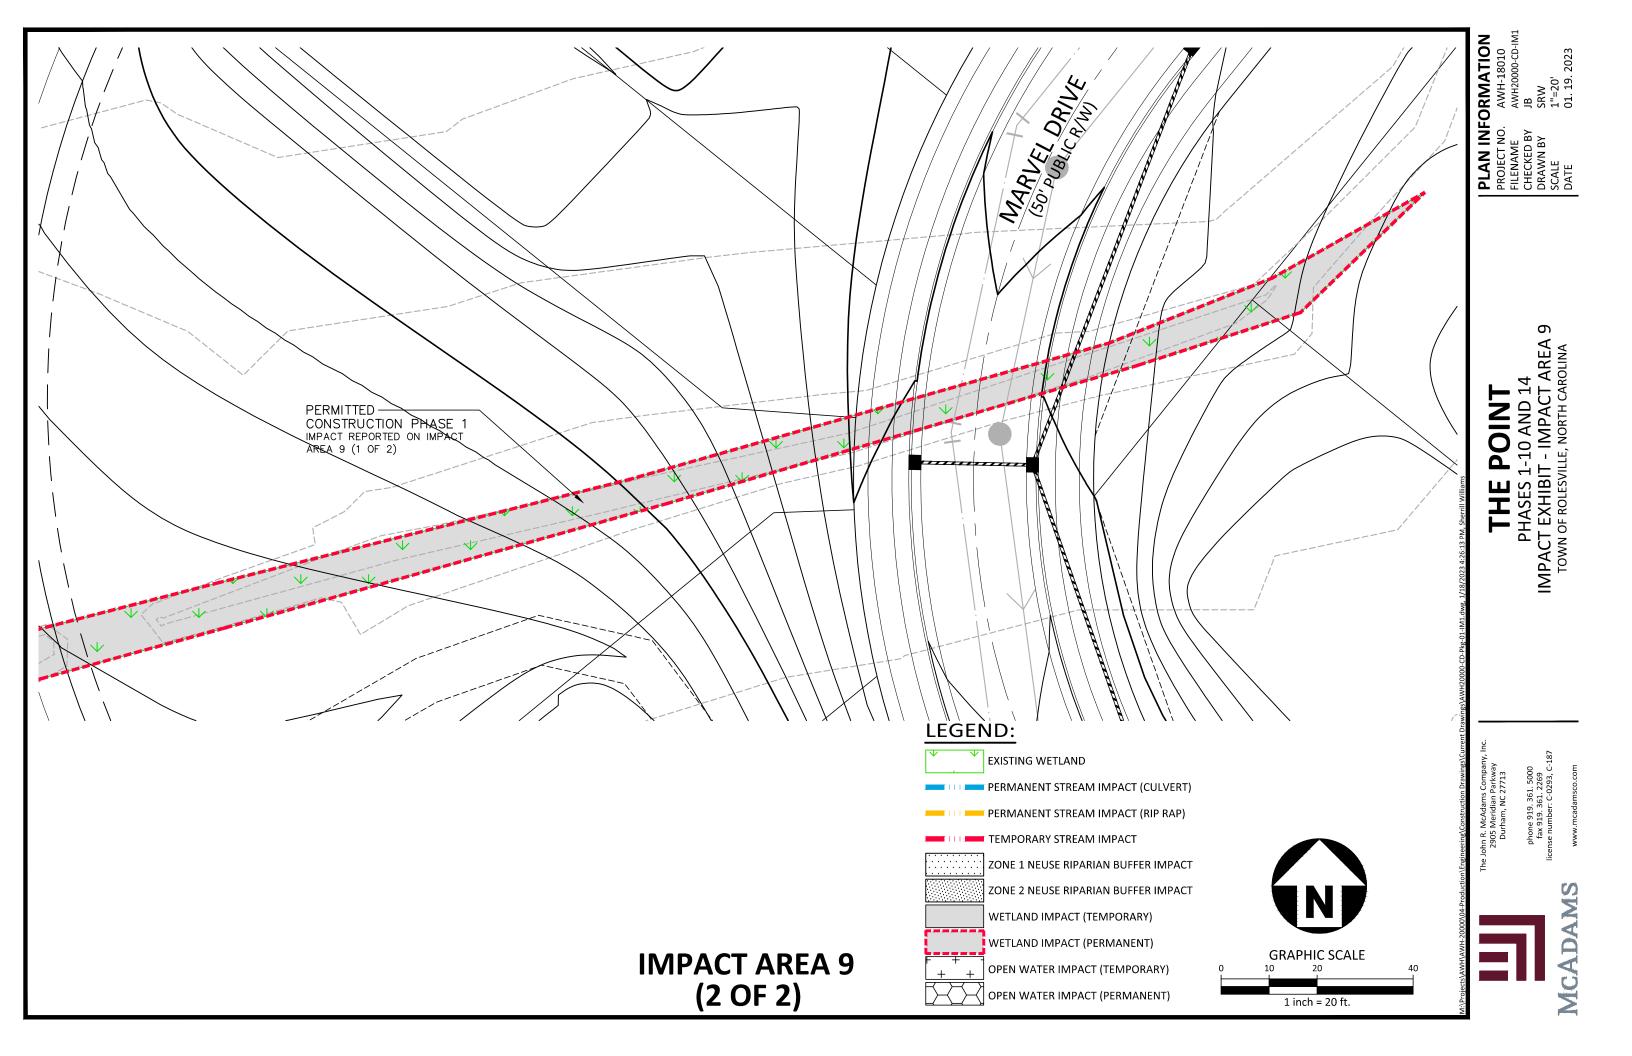

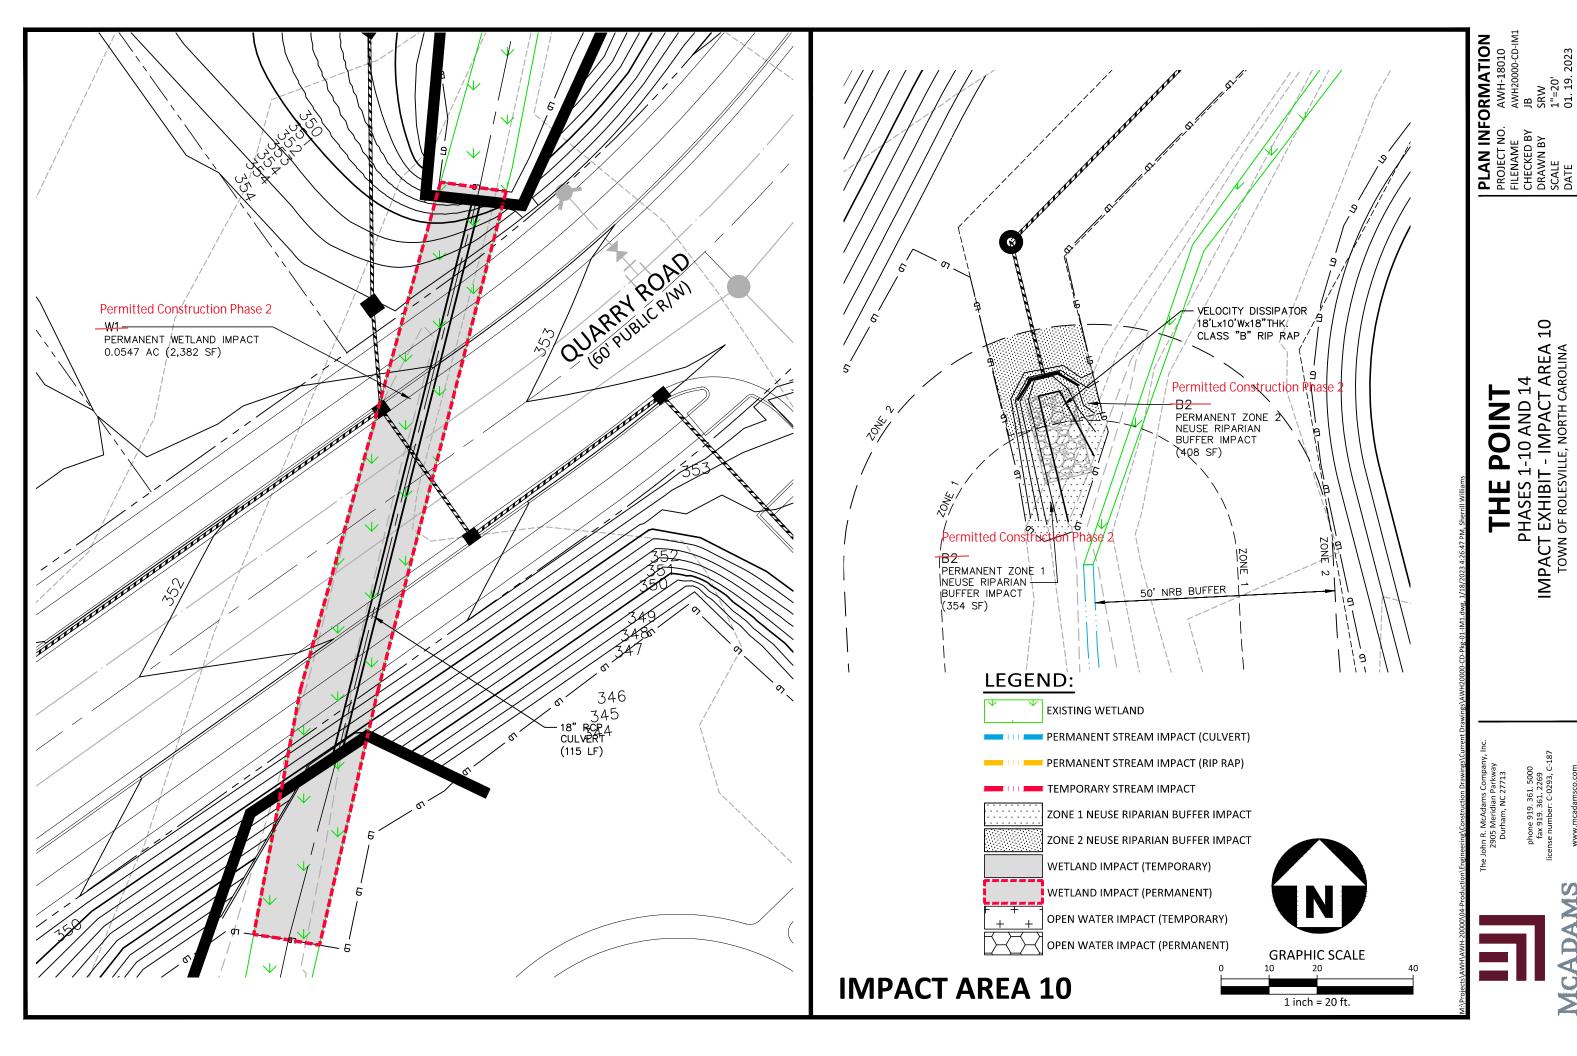

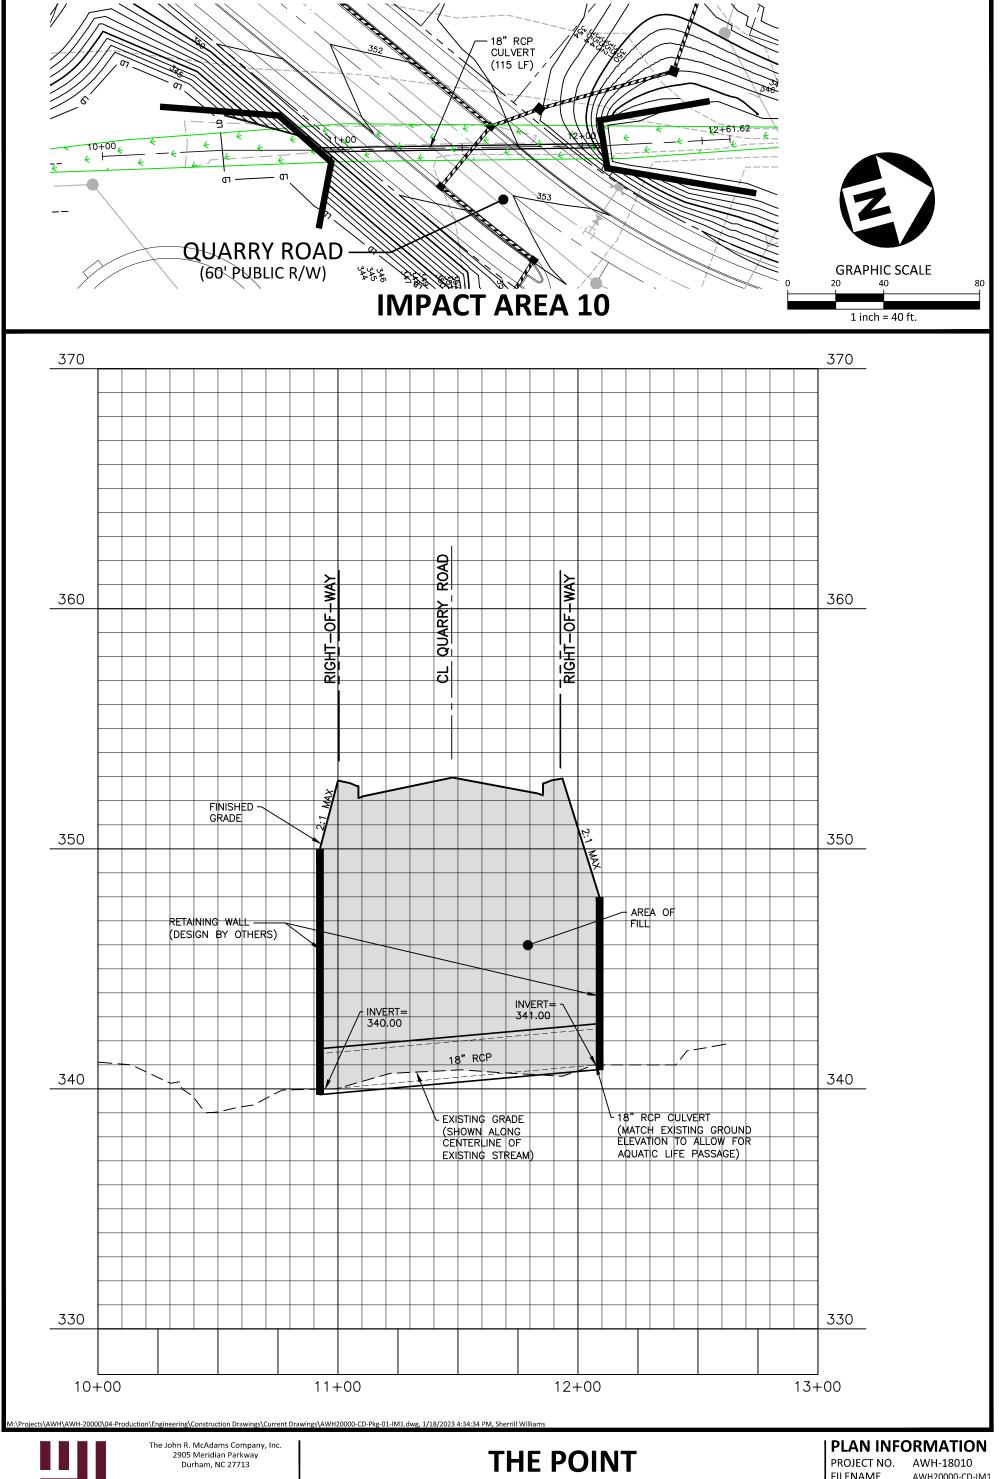



phone 919. 361. 5000 fax 919. 361. 2269 license number: C-0293, C-187


www.mcadamsco.com

PHASES 1-10 AND 14
IMPACT EXHIBIT - CULVERT CROSS SECTION
TOWN OF ROLESVILLE, NORTH CAROLINA

PROJECT NO. FILENAME CHECKED BY DRAWN BY SCALE

DATE


AWH20000-CD-IM1 JB SRW 1"=40'/1"=4' 01. 19. 2023

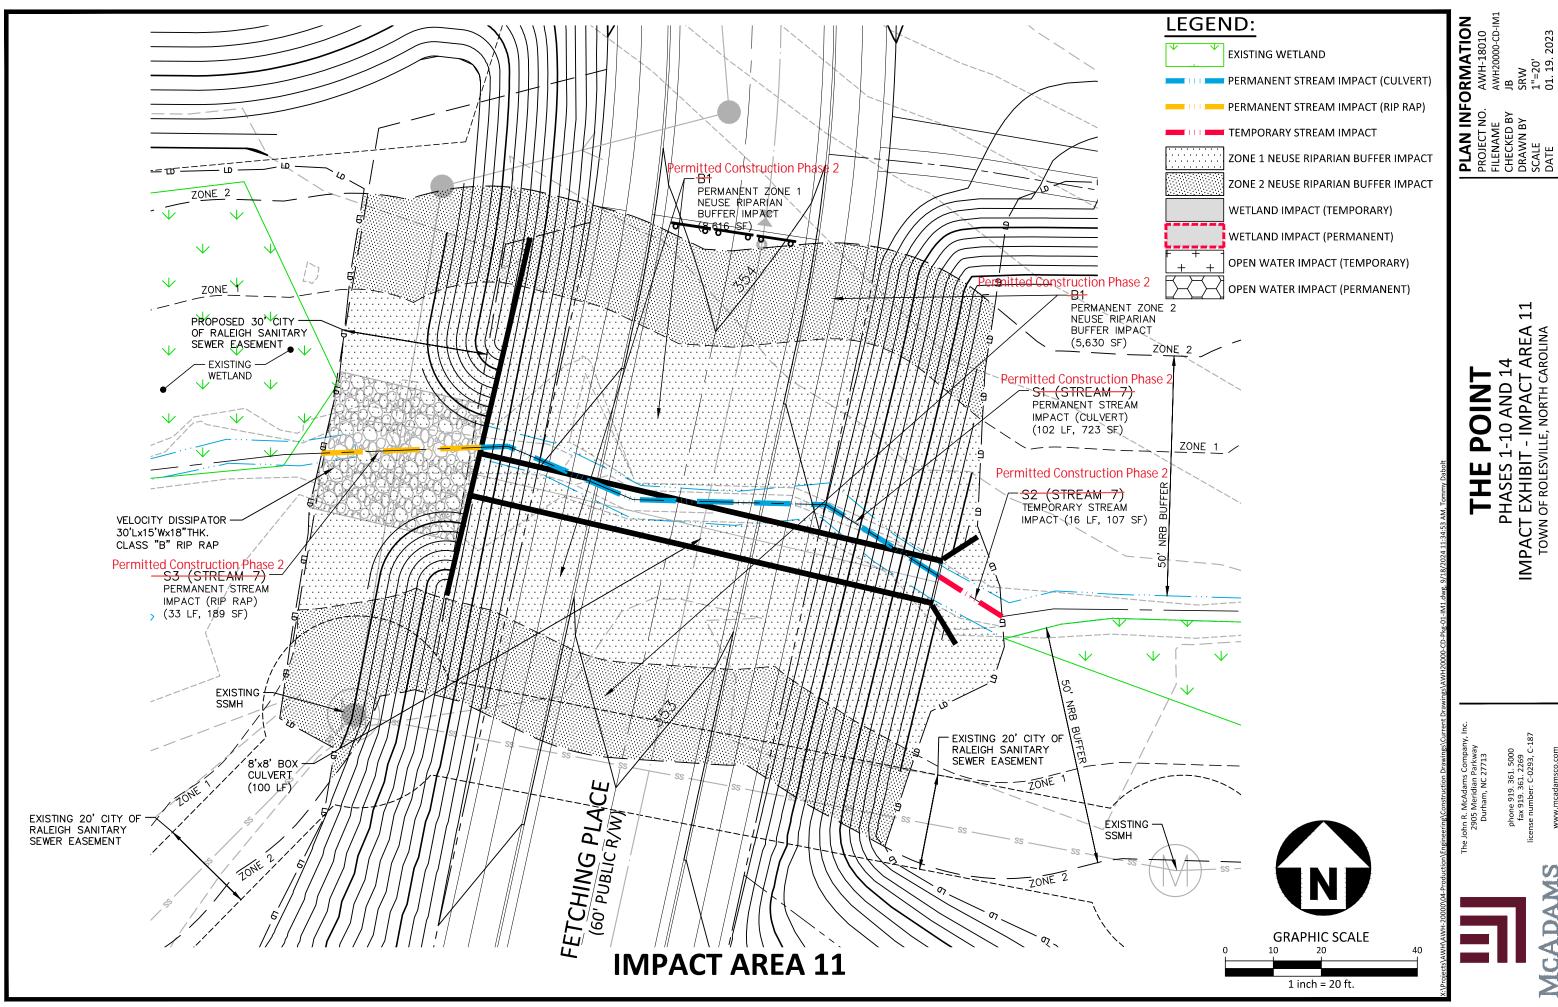

THE POINT
PHASES 1-10 AND 14
IMPACT EXHIBIT - IMPACT AREA 1.7
TOWN OF ROLESVILLE, NORTH CAROLINA

phone 919. 361. 5000 fax 919. 361. 2269 nse number: C-0293, C-1



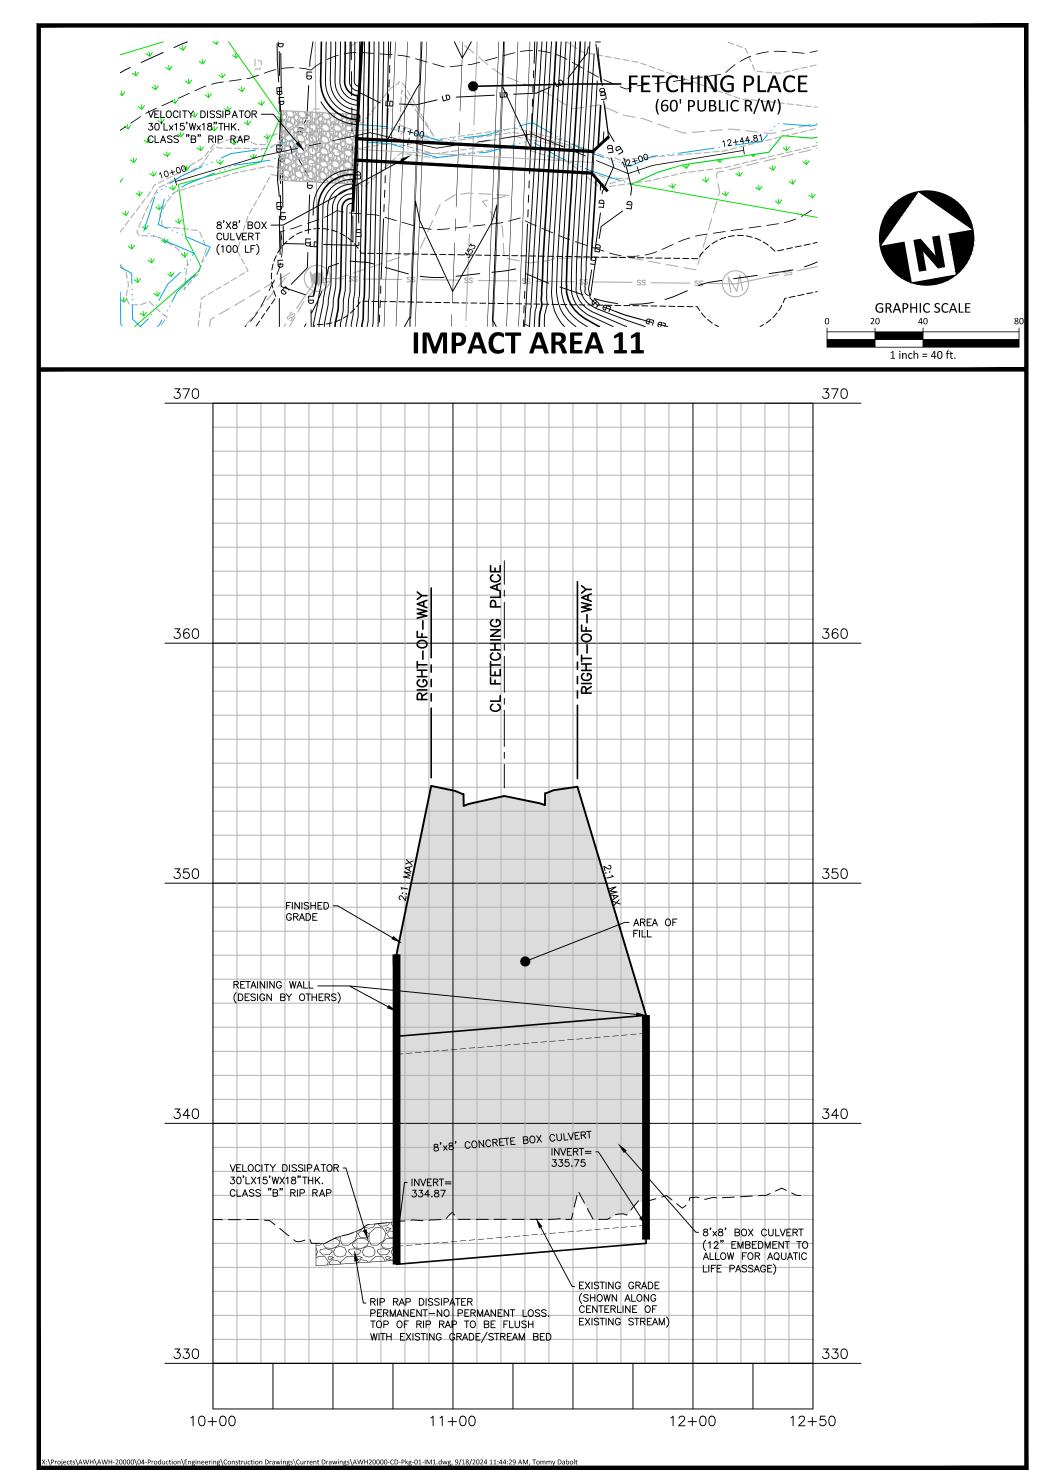



The John R. McAdams Company, Inc. 2905 Meridian Parkway Durham, NC 27713

phone 919. 361. 5000 fax 919. 361. 2269 license number: C-0293, C-187

www.mcadamsco.com

THE POINT

PHASES 1-10 AND 14
IMPACT EXHIBIT - CULVERT CROSS SECTION
TOWN OF ROLESVILLE, NORTH CAROLINA


PLAN INFORMATION

PROJECT NO. FILENAME CHECKED BY DRAWN BY SCALE


DATE

AWH20000-CD-IM1 JB SRW 1"=40'/1"=4' 01. 19. 2023

AWH-18010

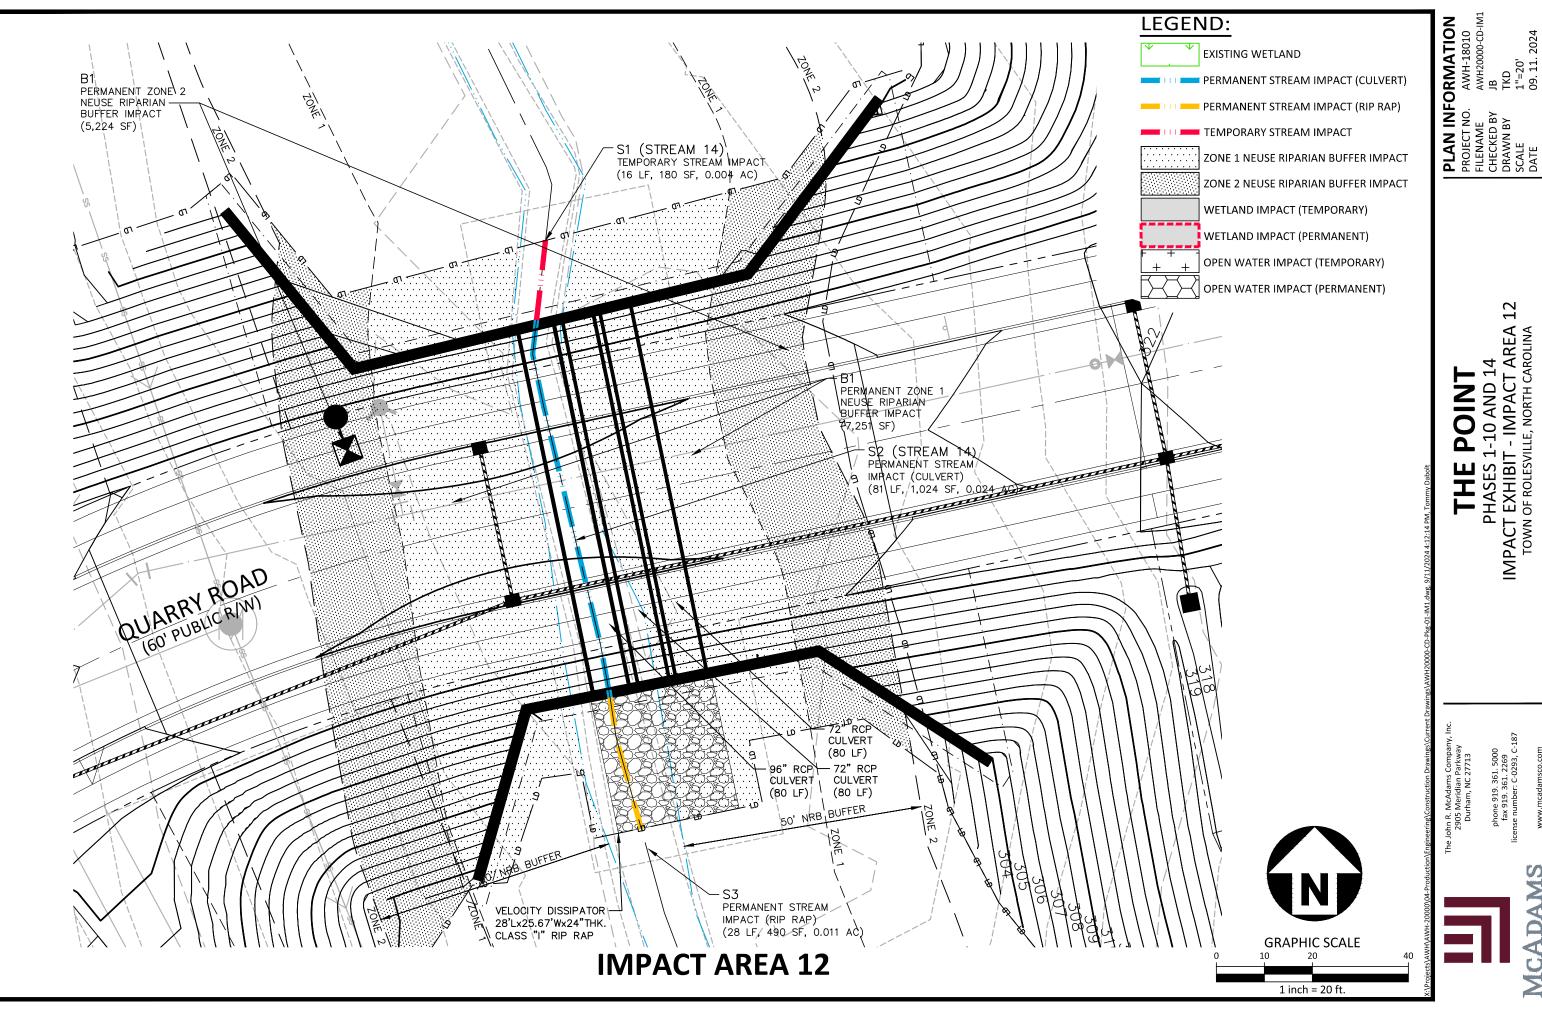

THE POINT
PHASES 1-10 AND 14
IMPACT EXHIBIT - IMPACT AREA 12
TOWN OF ROLESVILLE, NORTH CAROLINA

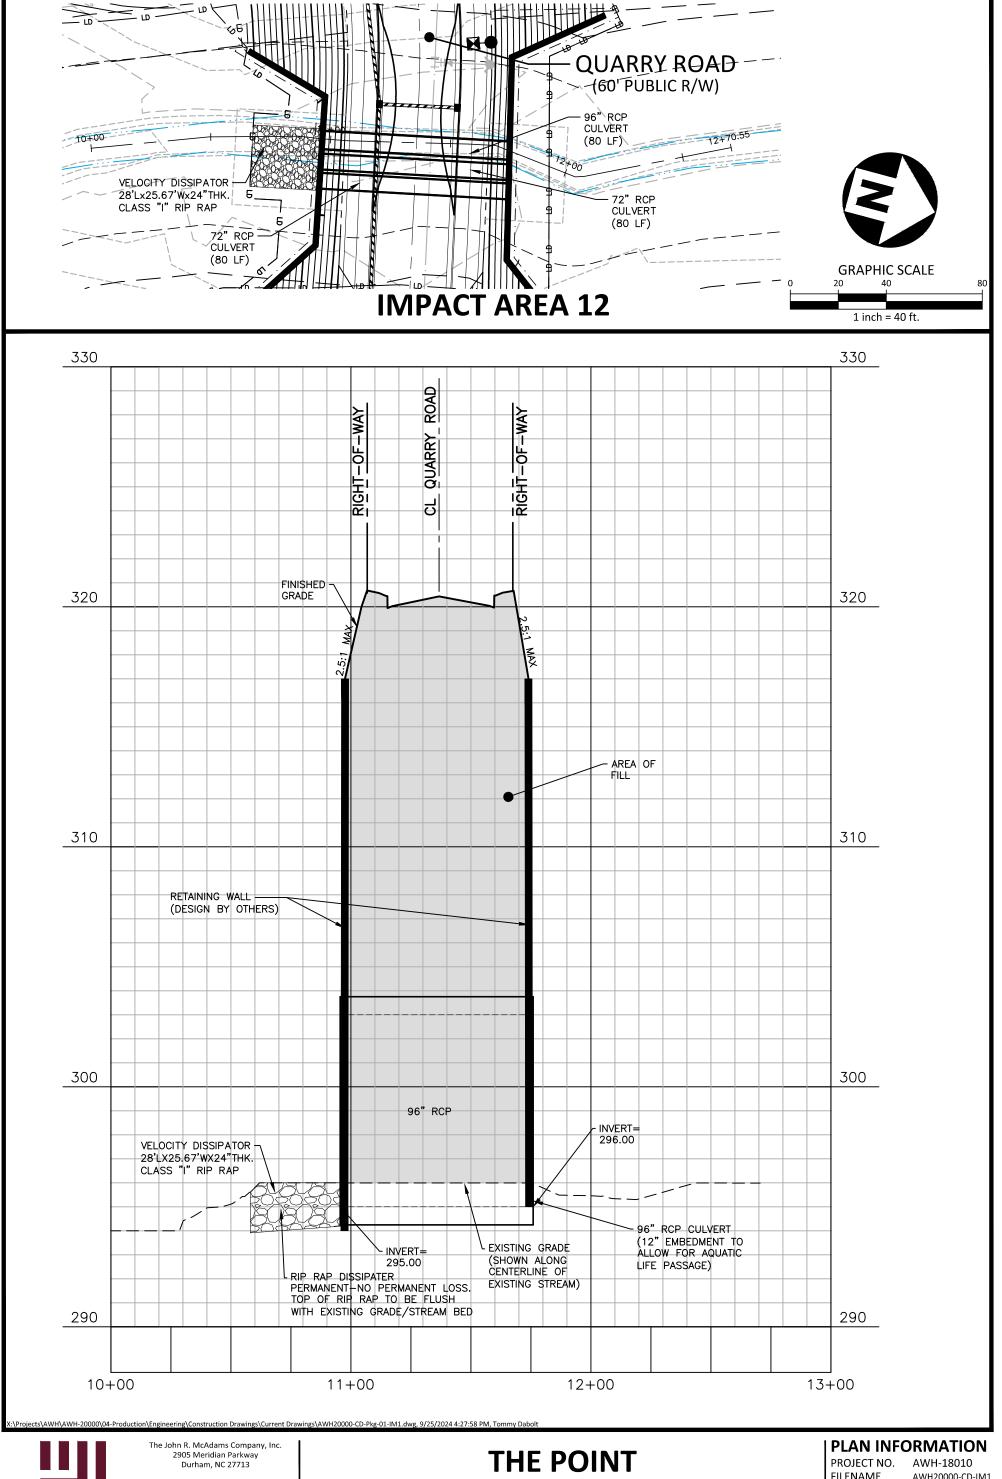



phone 919. 361. 5000 fax 919. 361. 2269 license number: C-0293, C-187


www.mcadamsco.com


PHASES 1-10 AND 14
IMPACT EXHIBIT - CULVERT CROSS SECTION
TOWN OF ROLESVILLE, NORTH CAROLINA

PROJECT NO FILENAME CHECKED BY DRAWN BY SCALE DATE

AWH-18010 AWH20000-CD-IM1 JB TKD 1"=40'/1"=4'

09. 11. 2024

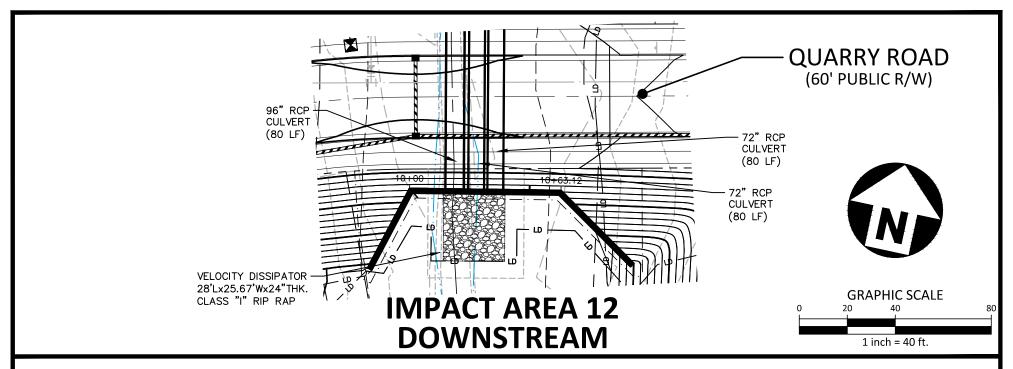

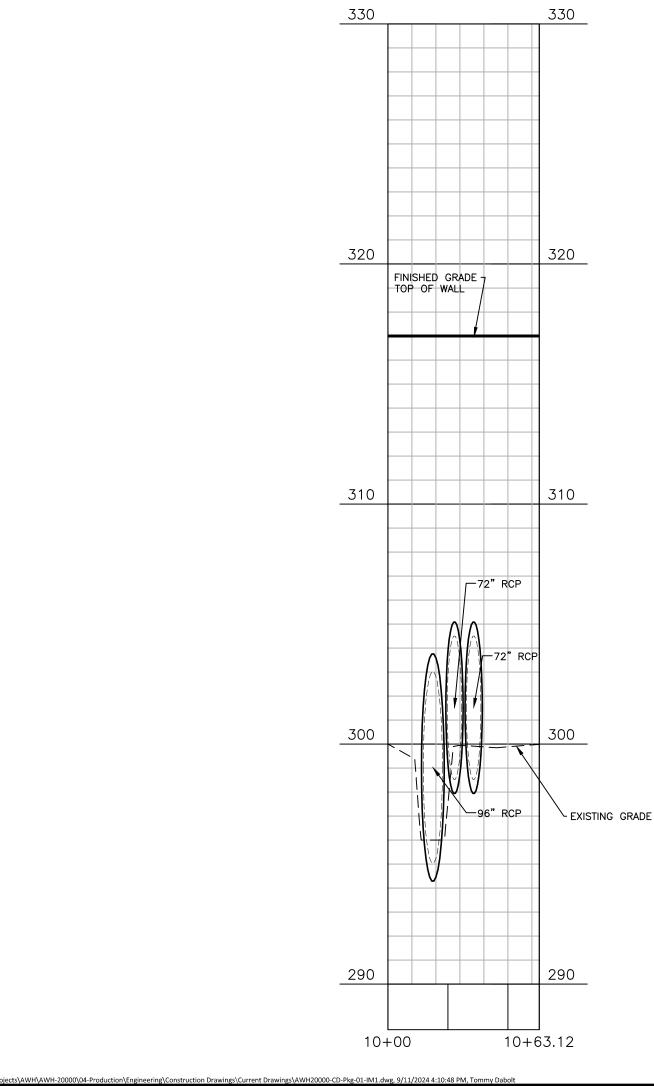



The John R. McAdams Company, Inc. 2905 Meridian Parkway Durham, NC 27713

phone 919. 361. 5000 fax 919. 361. 2269 license number: C-0293, C-187

www.mcadamsco.com

THE POINT

PHASES 1-10 AND 14 IMPACT EXHIBIT - CULVERT CROSS SECTION TOWN OF ROLESVILLE, NORTH CAROLINA


| PLAN INFORMATION

PROJECT NO. AWH-18010 FILENAME **CHECKED BY** DRAWN BY SCALE

DATE

AWH20000-CD-IM1 JB TKD 1"=40'/1"=4'

09. 11. 2024

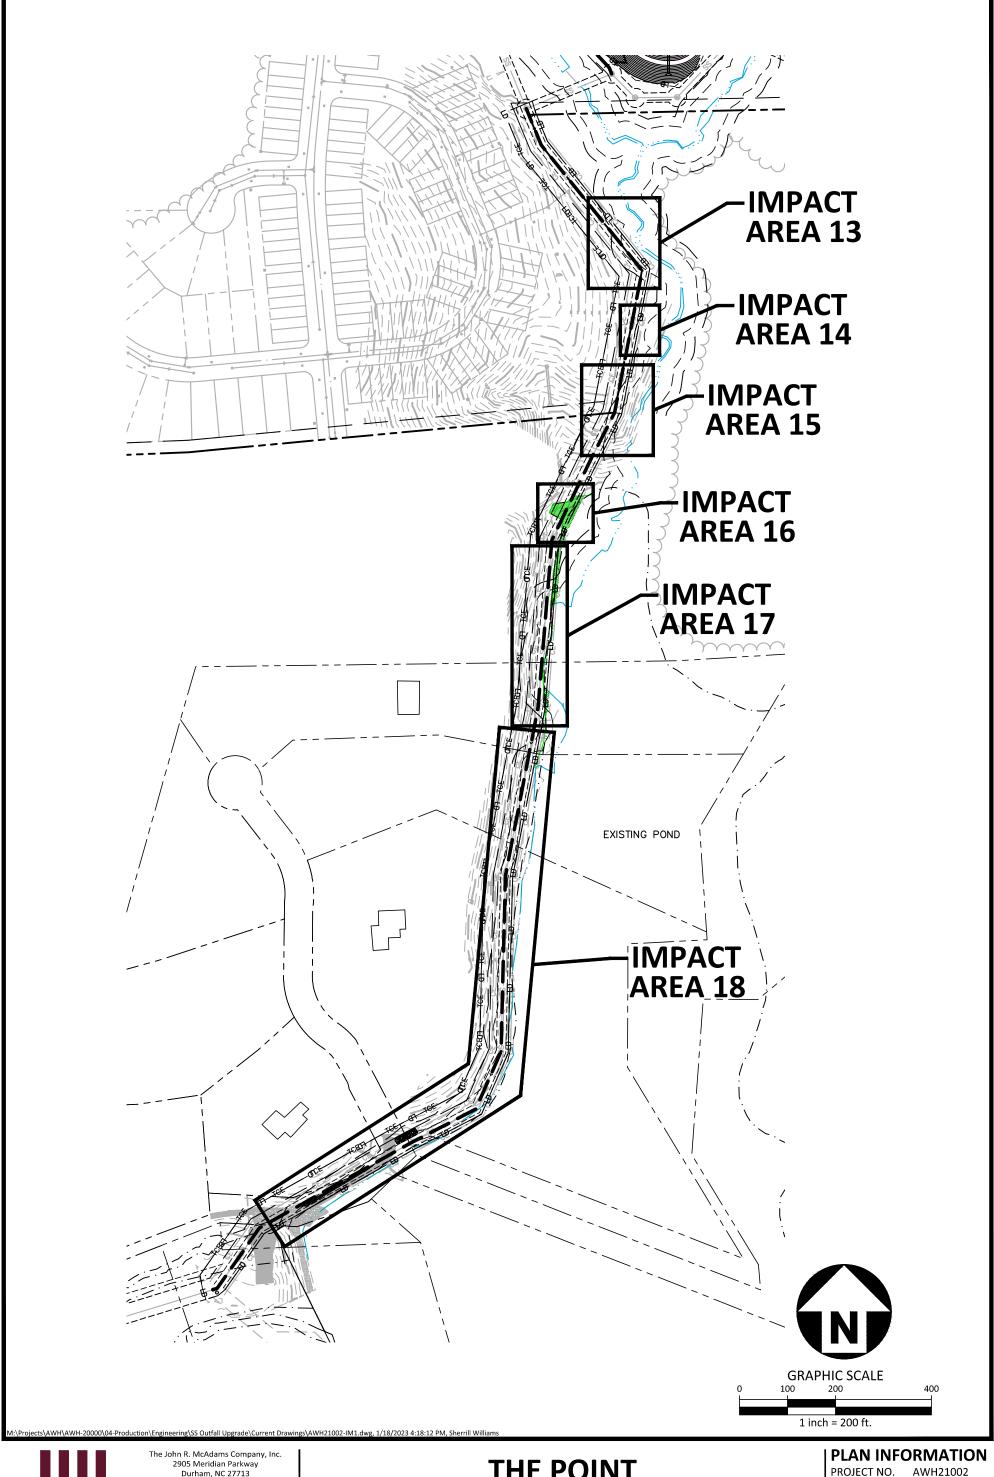



Durham, NC 27713

phone 919. 361. 5000 fax 919. 361. 2269 license number: C-0293, C-187


www.mcadamsco.com

THE POINT

HARRIS CREEK INTERCEPTOR **OVERALL IMPACT EXHIBIT** TOWN OF ROLESVILLE, NORTH CAROLINA

PROJECT NO. FILENAME CHECKED BY DRAWN BY SCALE

DATE

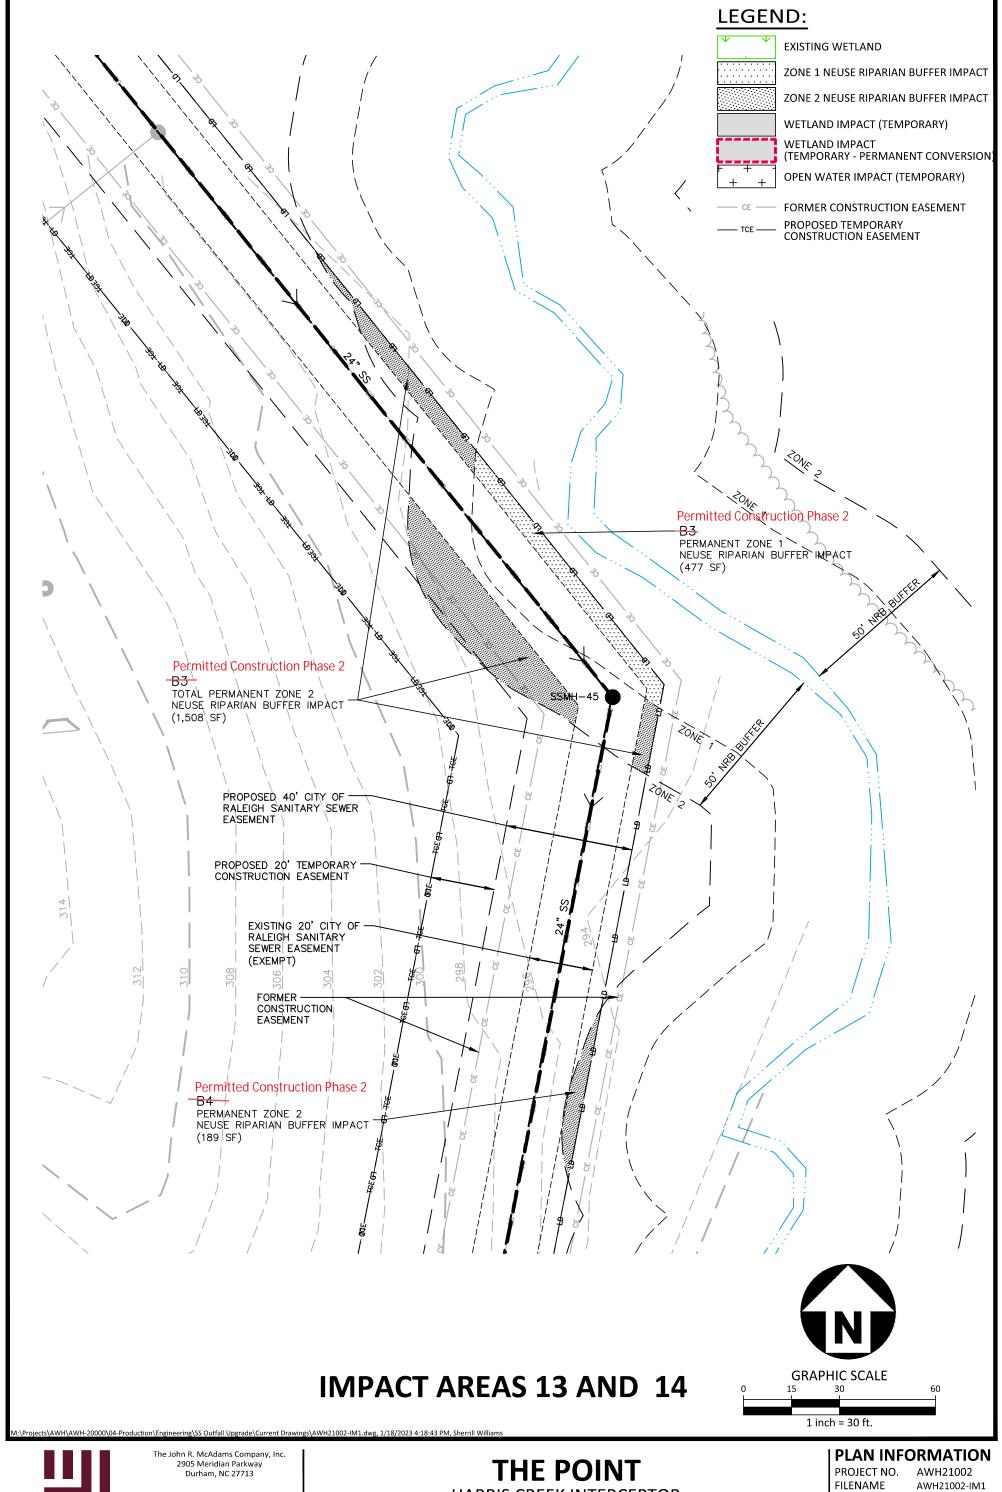



phone 919. 361. 5000 fax 919. 361. 2269 license number: C-0293, C-187


cense number: C-0293, C-1

HARRIS CREEK INTERCEPTOR
IMPACT EXHIBIT - IMPACT AREAS 13 AND 14
TOWN OF ROLESVILLE, NORTH CAROLINA

PROJECT NO. FILENAME CHECKED BY DRAWN BY SCALE

DATE

D BY JB BY SRW 1"=30' 01. 19. 2023

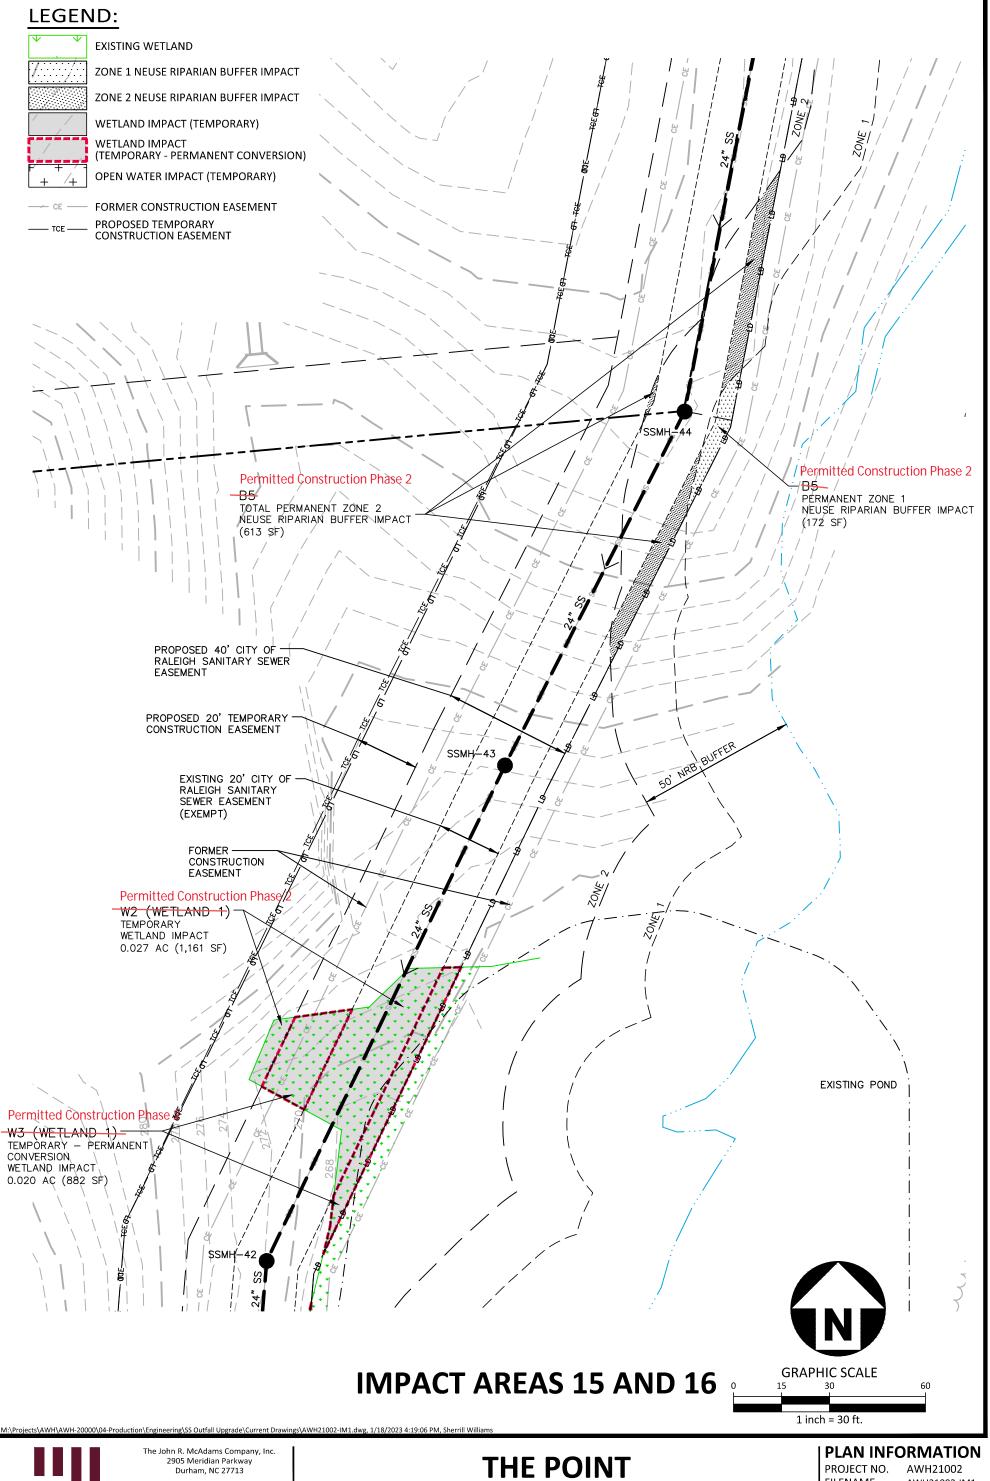




phone 919. 361. 5000

phone 919. 361. 5000 fax 919. 361. 2269 license number: C-0293, C-187

www.mcadamsco.com

HARRIS CREEK INTERCEPTOR
IMPACT EXHIBIT - IMPACT AREAS 15 AND 16
TOWN OF ROLESVILLE, NORTH CAROLINA

PROJECT NO FILENAME CHECKED BY DRAWN BY SCALE DATE

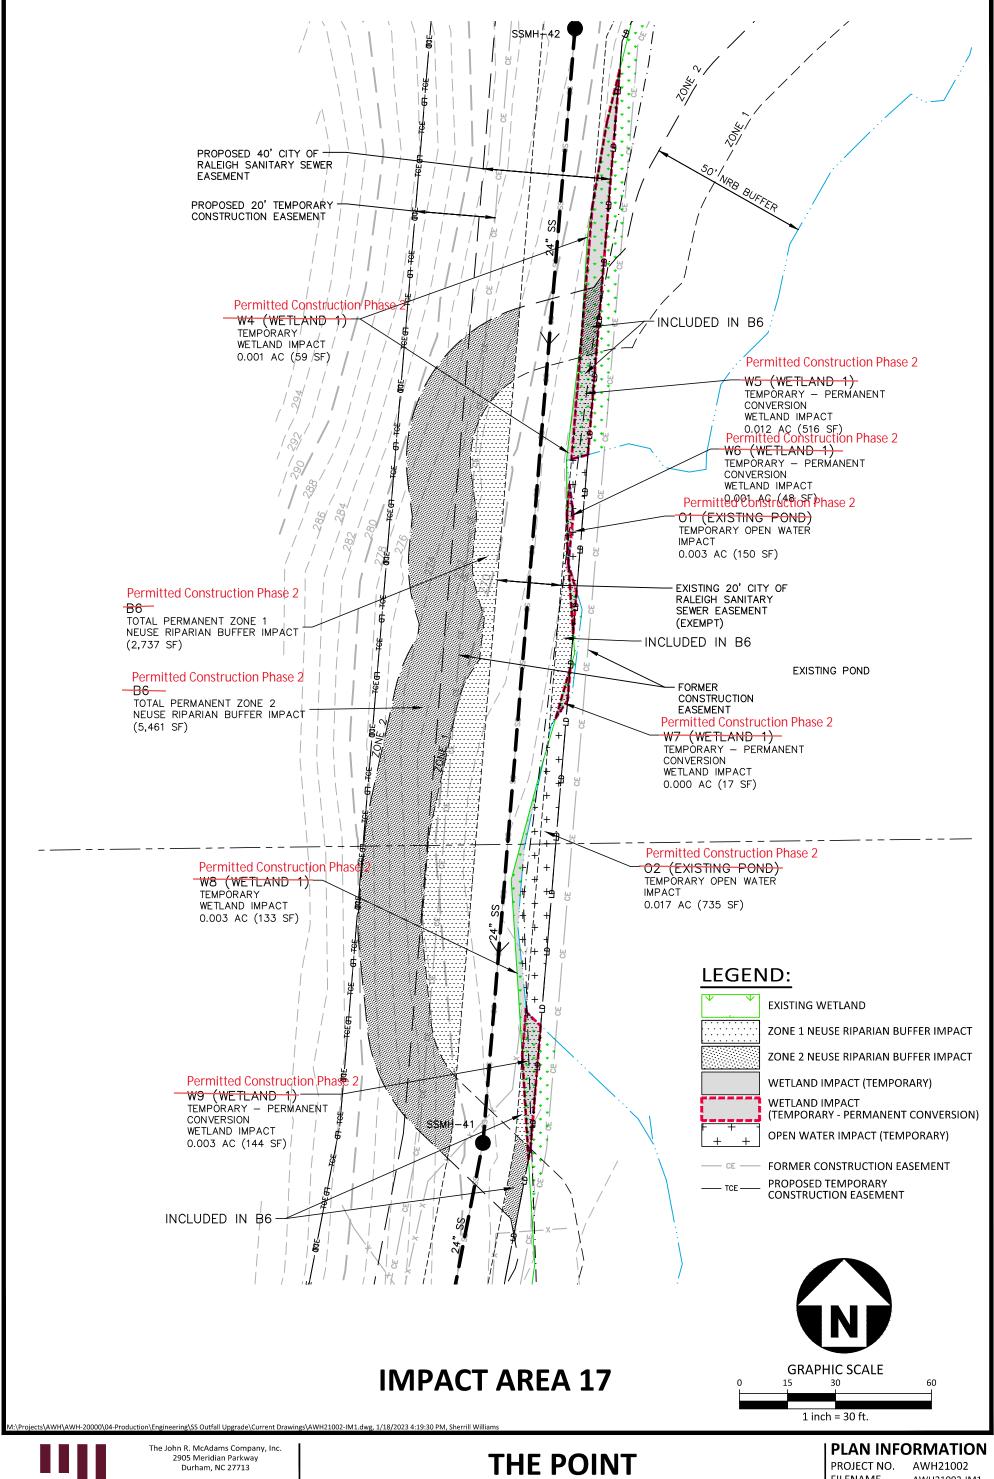



Durham, NC 27713


phone 919. 361. 5000 fax 919. 361. 2269 license number: C-0293, C-187

www.mcadamsco.com

HARRIS CREEK INTERCEPTOR **IMPACT EXHIBIT - IMPACT AREA 17** TOWN OF ROLESVILLE, NORTH CAROLINA

FILENAME CHECKED BY DRAWN BY SCALE

DATE

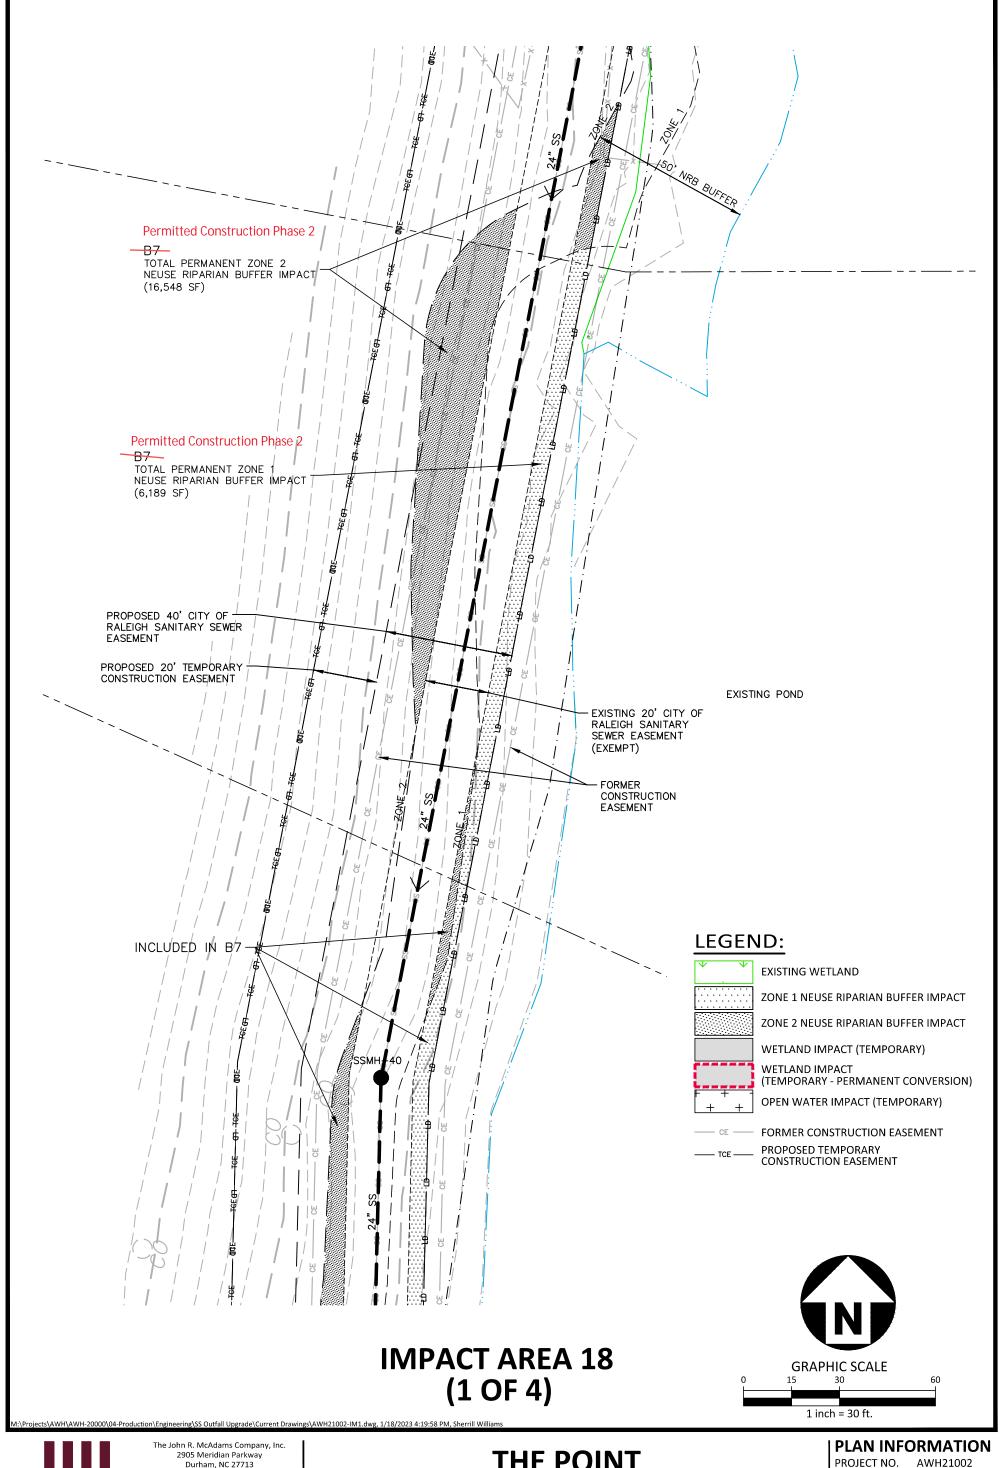



Durham, NC 27713

phone 919. 361. 5000 fax 919. 361. 2269 license number: C-0293, C-187


www.mcadamsco.com

THE POINT

HARRIS CREEK INTERCEPTOR **IMPACT EXHIBIT - IMPACT AREA 18** TOWN OF ROLESVILLE, NORTH CAROLINA

FILENAME **CHECKED BY** DRAWN BY SCALE

DATE

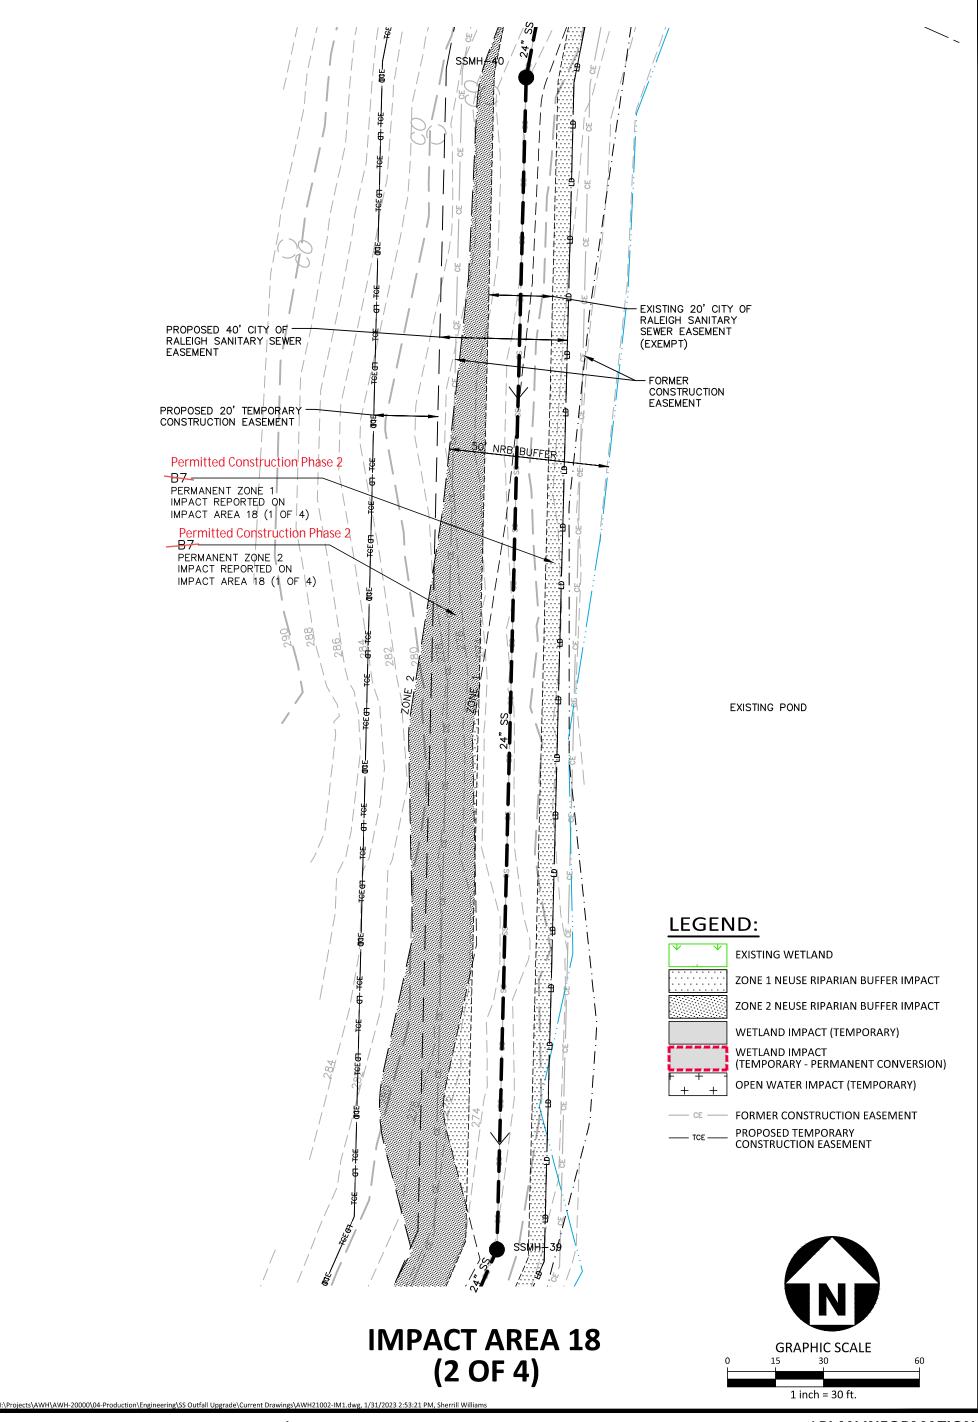



The John R. McAdams Company, Inc. 2905 Meridian Parkway Durham, NC 27713

phone 919. 361. 5000

fax 919. 361. 2269 license number: C-0293, C-187


THE POINT

HARRIS CREEK INTERCEPTOR **IMPACT EXHIBIT - IMPACT AREA 18** TOWN OF ROLESVILLE, NORTH CAROLINA

PLAN INFORMATION

PROJECT NO. AWH21002 FILENAME **CHECKED BY** DRAWN BY SCALE

DATE

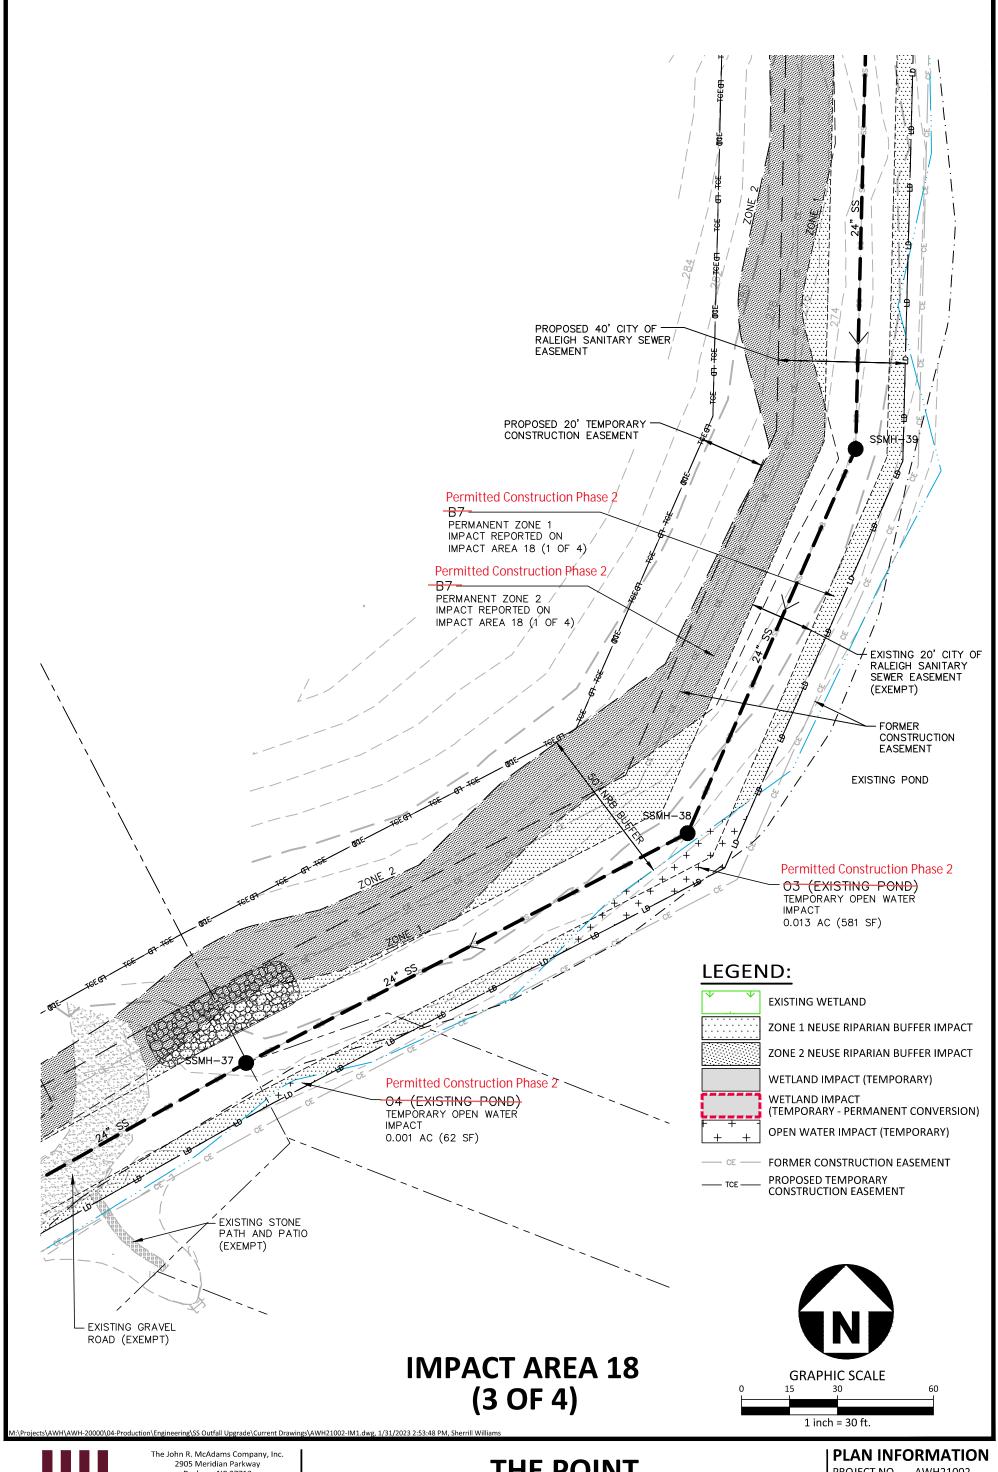



Durham, NC 27713

phone 919. 361. 5000 fax 919. 361. 2269 license number: C-0293, C-187


www.mcadamsco.com

THE POINT

HARRIS CREEK INTERCEPTOR **IMPACT EXHIBIT - IMPACT AREA 18** TOWN OF ROLESVILLE, NORTH CAROLINA

PROJECT NO. FILENAME **CHECKED BY** DRAWN BY SCALE DATE

AWH21002 AWH21002-IM1 JB SRW 1"=30' 01. 19. 2023

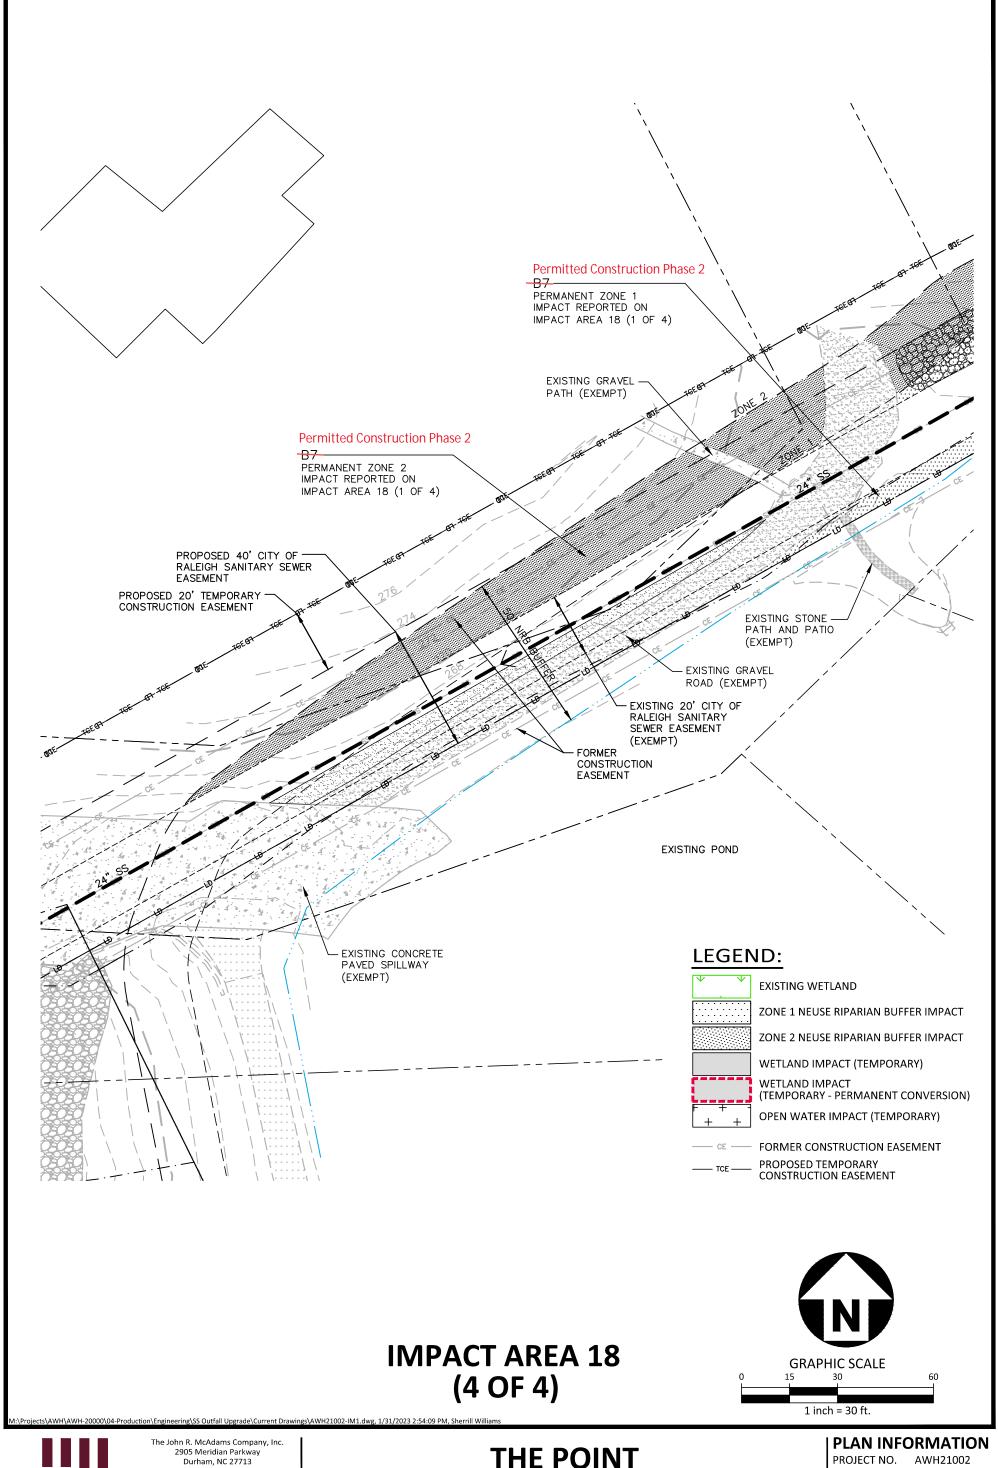



phone 919. 361. 5000 fax 919. 361. 2269 license number: C-0293, C-187


www.mcadamsco.com

THE POINT

HARRIS CREEK INTERCEPTOR **IMPACT EXHIBIT - IMPACT AREA 18** TOWN OF ROLESVILLE, NORTH CAROLINA

FILENAME CHECKED BY DRAWN BY SCALE

DATE

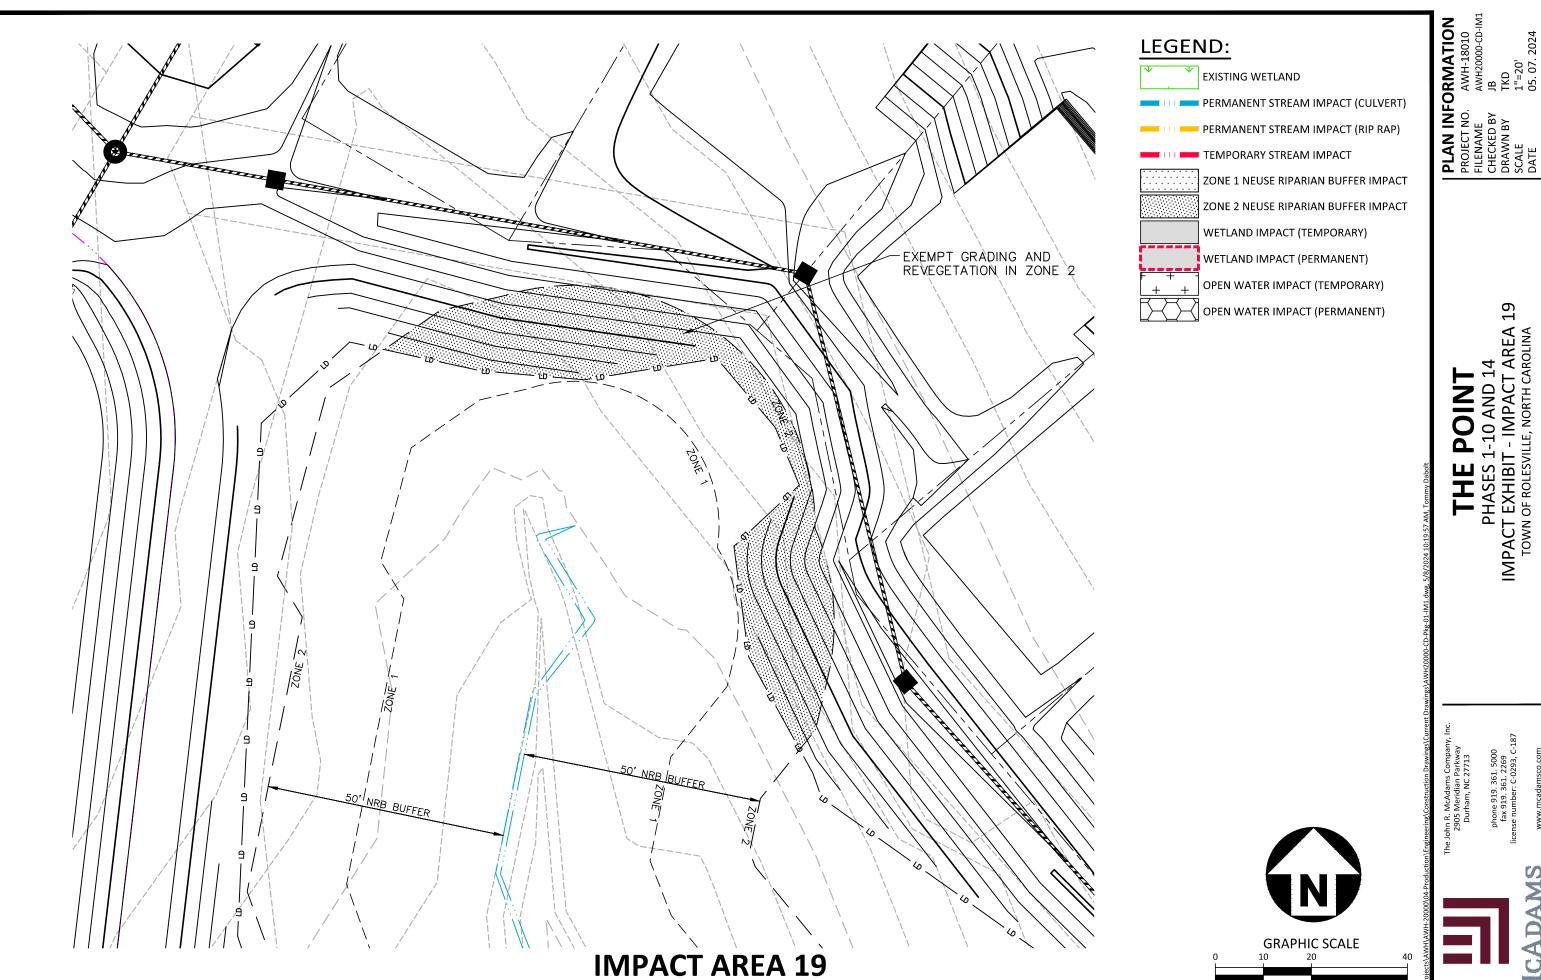


PHASES 1-10 AND 14
IMPACT EXHIBIT - IMPACT AREA 19
TOWN OF ROLESVILLE, NORTH CAROLINA THE POINT

: John R. McAdams Company 2905 Meridian Parkway Durham, NC 27713



1 inch = 20 ft.

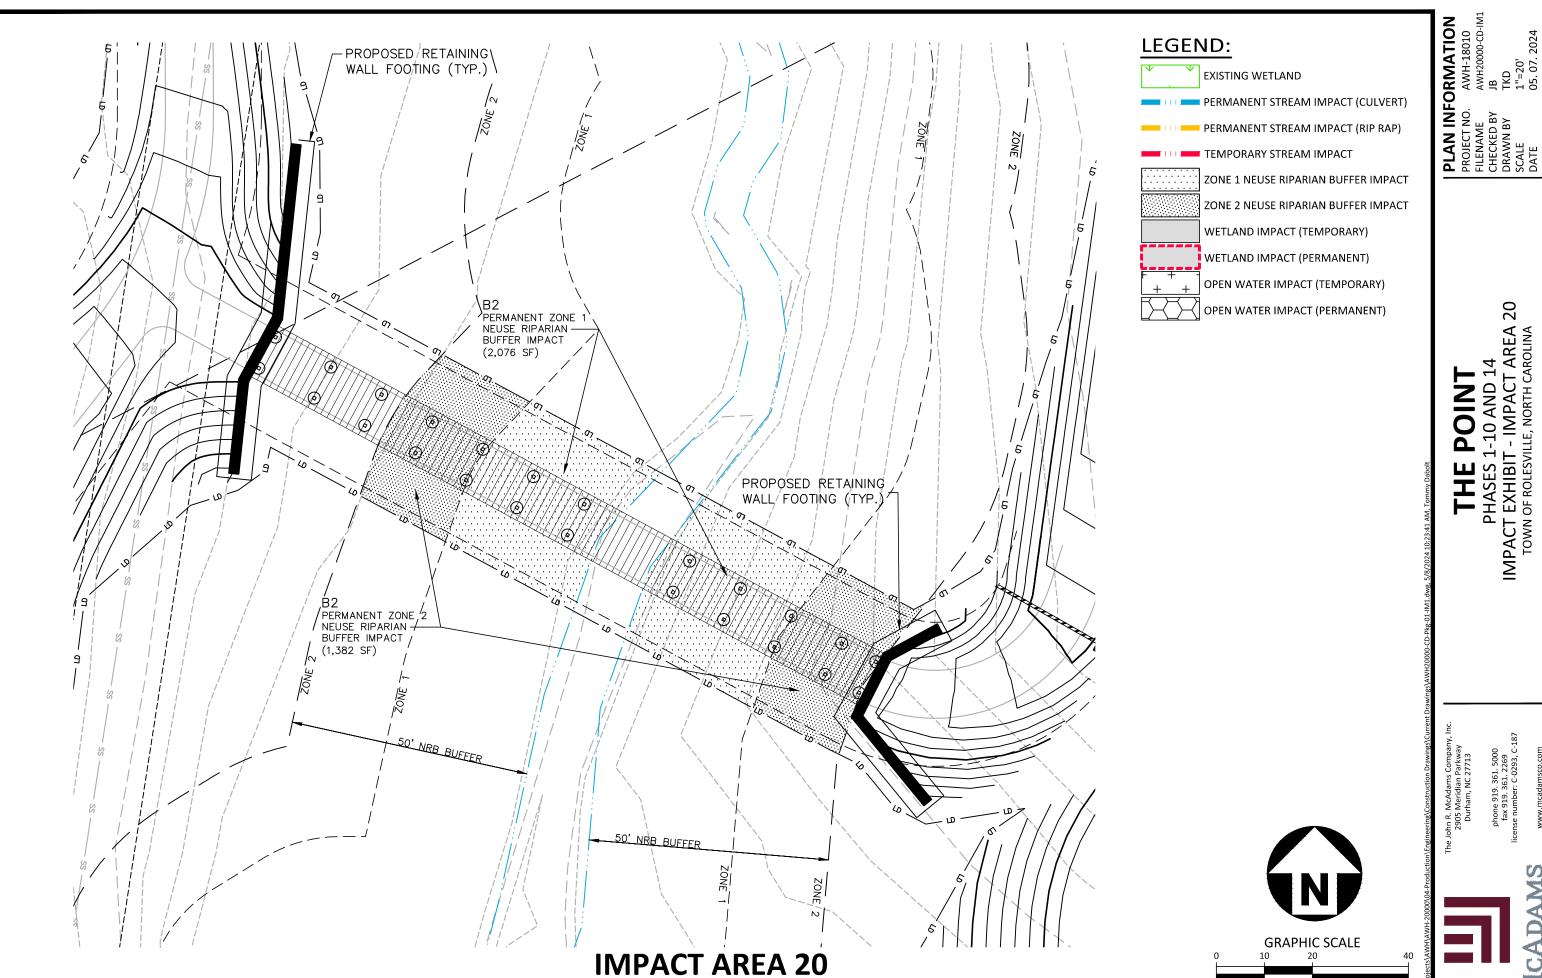





1 inch = 20 ft.