



# McAdam

The John R. McAdams Company, Inc. 621 Hillsborough Street Suite 500 Raleigh, NC 27603

phone 919. 361. 5000 fax 919. 361. 2269 license number: C-0293, C-187


www.mcadamsco.com

WALLBROOK LANDCO, LLC 3 KEEL STREET, SUITE 2 WRIGHTSVILLE BEACH, NORTH CAROLINA 28480-1709

WALLBROOK

ONSTRUCTION DRAWINGS

ROLESVILLE, NORTH CAROLINA

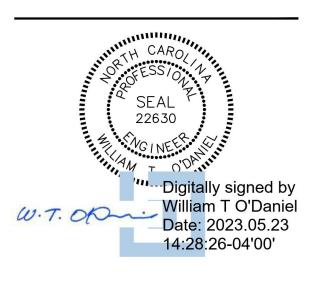

# REVISIONS

NO. DATE

# PLAN INFORMATION

PROJECT NO. CPR-19100

FILENAME CPR19100-CD-U1

CHECKED BY WTO


DRAWN BY JMS

SCALE 1"=40'

DATE 05. 22. 2023 **SHEET** 

UTILITY PLAN - AREA "B"

C4.02

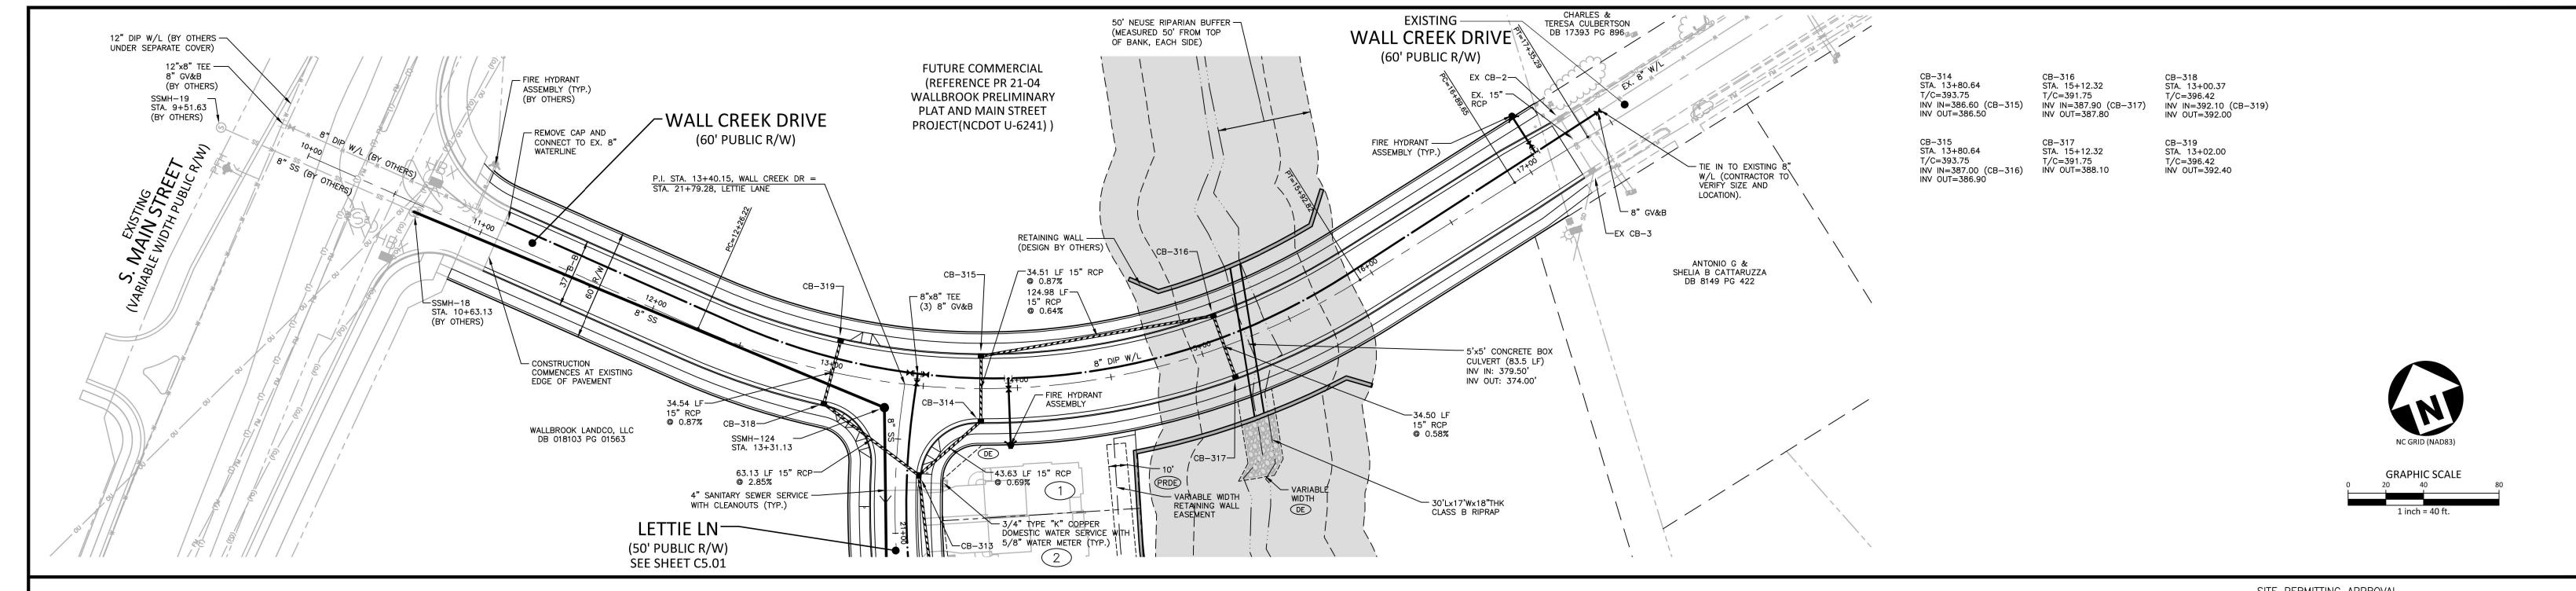

SITE PERMITTING APPROVAL

Water and Sewer Permits (If applicable) The City of Raleigh consents to the connection and extension of the City's Public Sewer System as shown on this plan. The material and Construction methods used for this project shall conform to the standards and specifications of the City's Public Utilities Handbook. City of Raleigh Public Utilities Department Permit # \_\_\_\_\_S-5230

The City of Raleigh consents to the connection and extension of the City's Public Water System as shown on this plan. The Electronic Approval: This approval is being issued electronically. This approval is valid only upon the signature of a City of material and Construction methods used for this project shall conform to the standards and specifications of the City's Public Raleigh Review Officer below. The City will retain a copy of the approved plans. Any work authorized by this approval must

Utilities Handbook. City of Raleigh Public Utilities Department Permit # W-4043

proceed in accordance with the plans kept on file with the City. This electronic approval may not be edited once issued. Any


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City of Raleigh Review Officer

CITY OF RALEIGH - PLANS AUTHORIZED FOR CONSTRUCTION

modification to this approval once issued will invalidate this approval.

Timothy Beasley

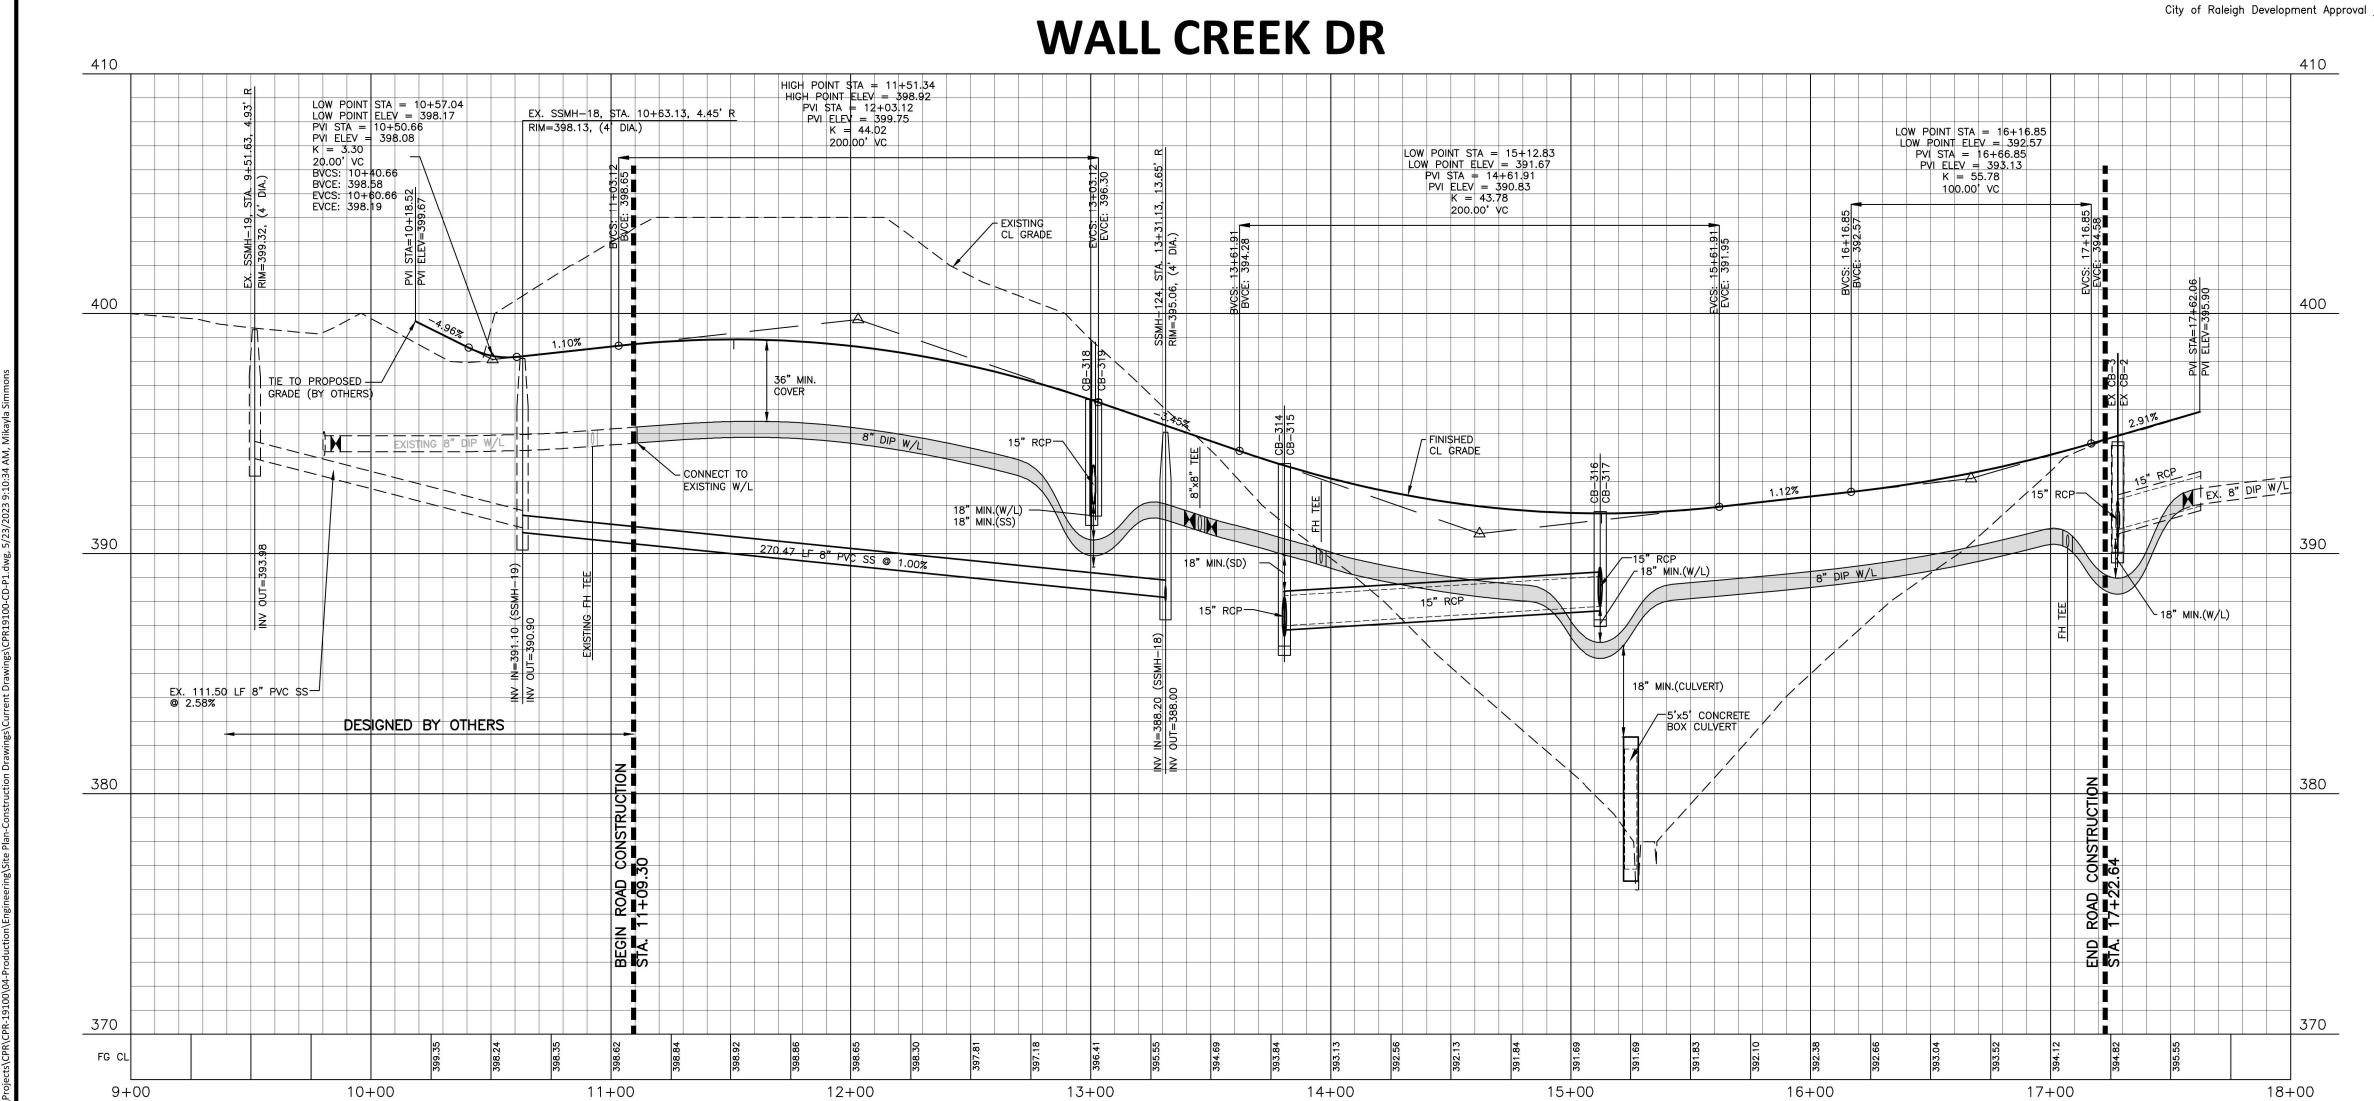

FINAL DRAWING - RELEASED FOR CONSTRUCTION

McAdams

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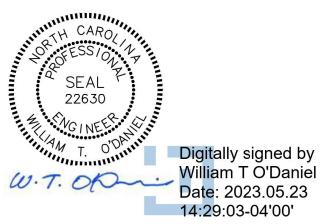
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**CLIENT** WALLBROOK LANDCO, LLC 3 KEEL STREET, SUITE 2 WRIGHTSVILLE BEACH, NORTH CAROLINA

28480-1709

**REVISIONS** NO. DATE



**WALLBROOK** CONSTRUCTION DRAWINGS ROLESVILLE, NORTH CAROLINA


PLAN INFORMATION


PROJECT NO. CPR-19100 CPR19100-CD-P1 **FILENAME** CHECKED BY DRAWN BY **SCALE** 1"=40'/1"=4'

05. 22. 2023

DATE

PLAN AND PROFILE WALL CREEK DR, STA. 9+00 THRU STA. 18+00

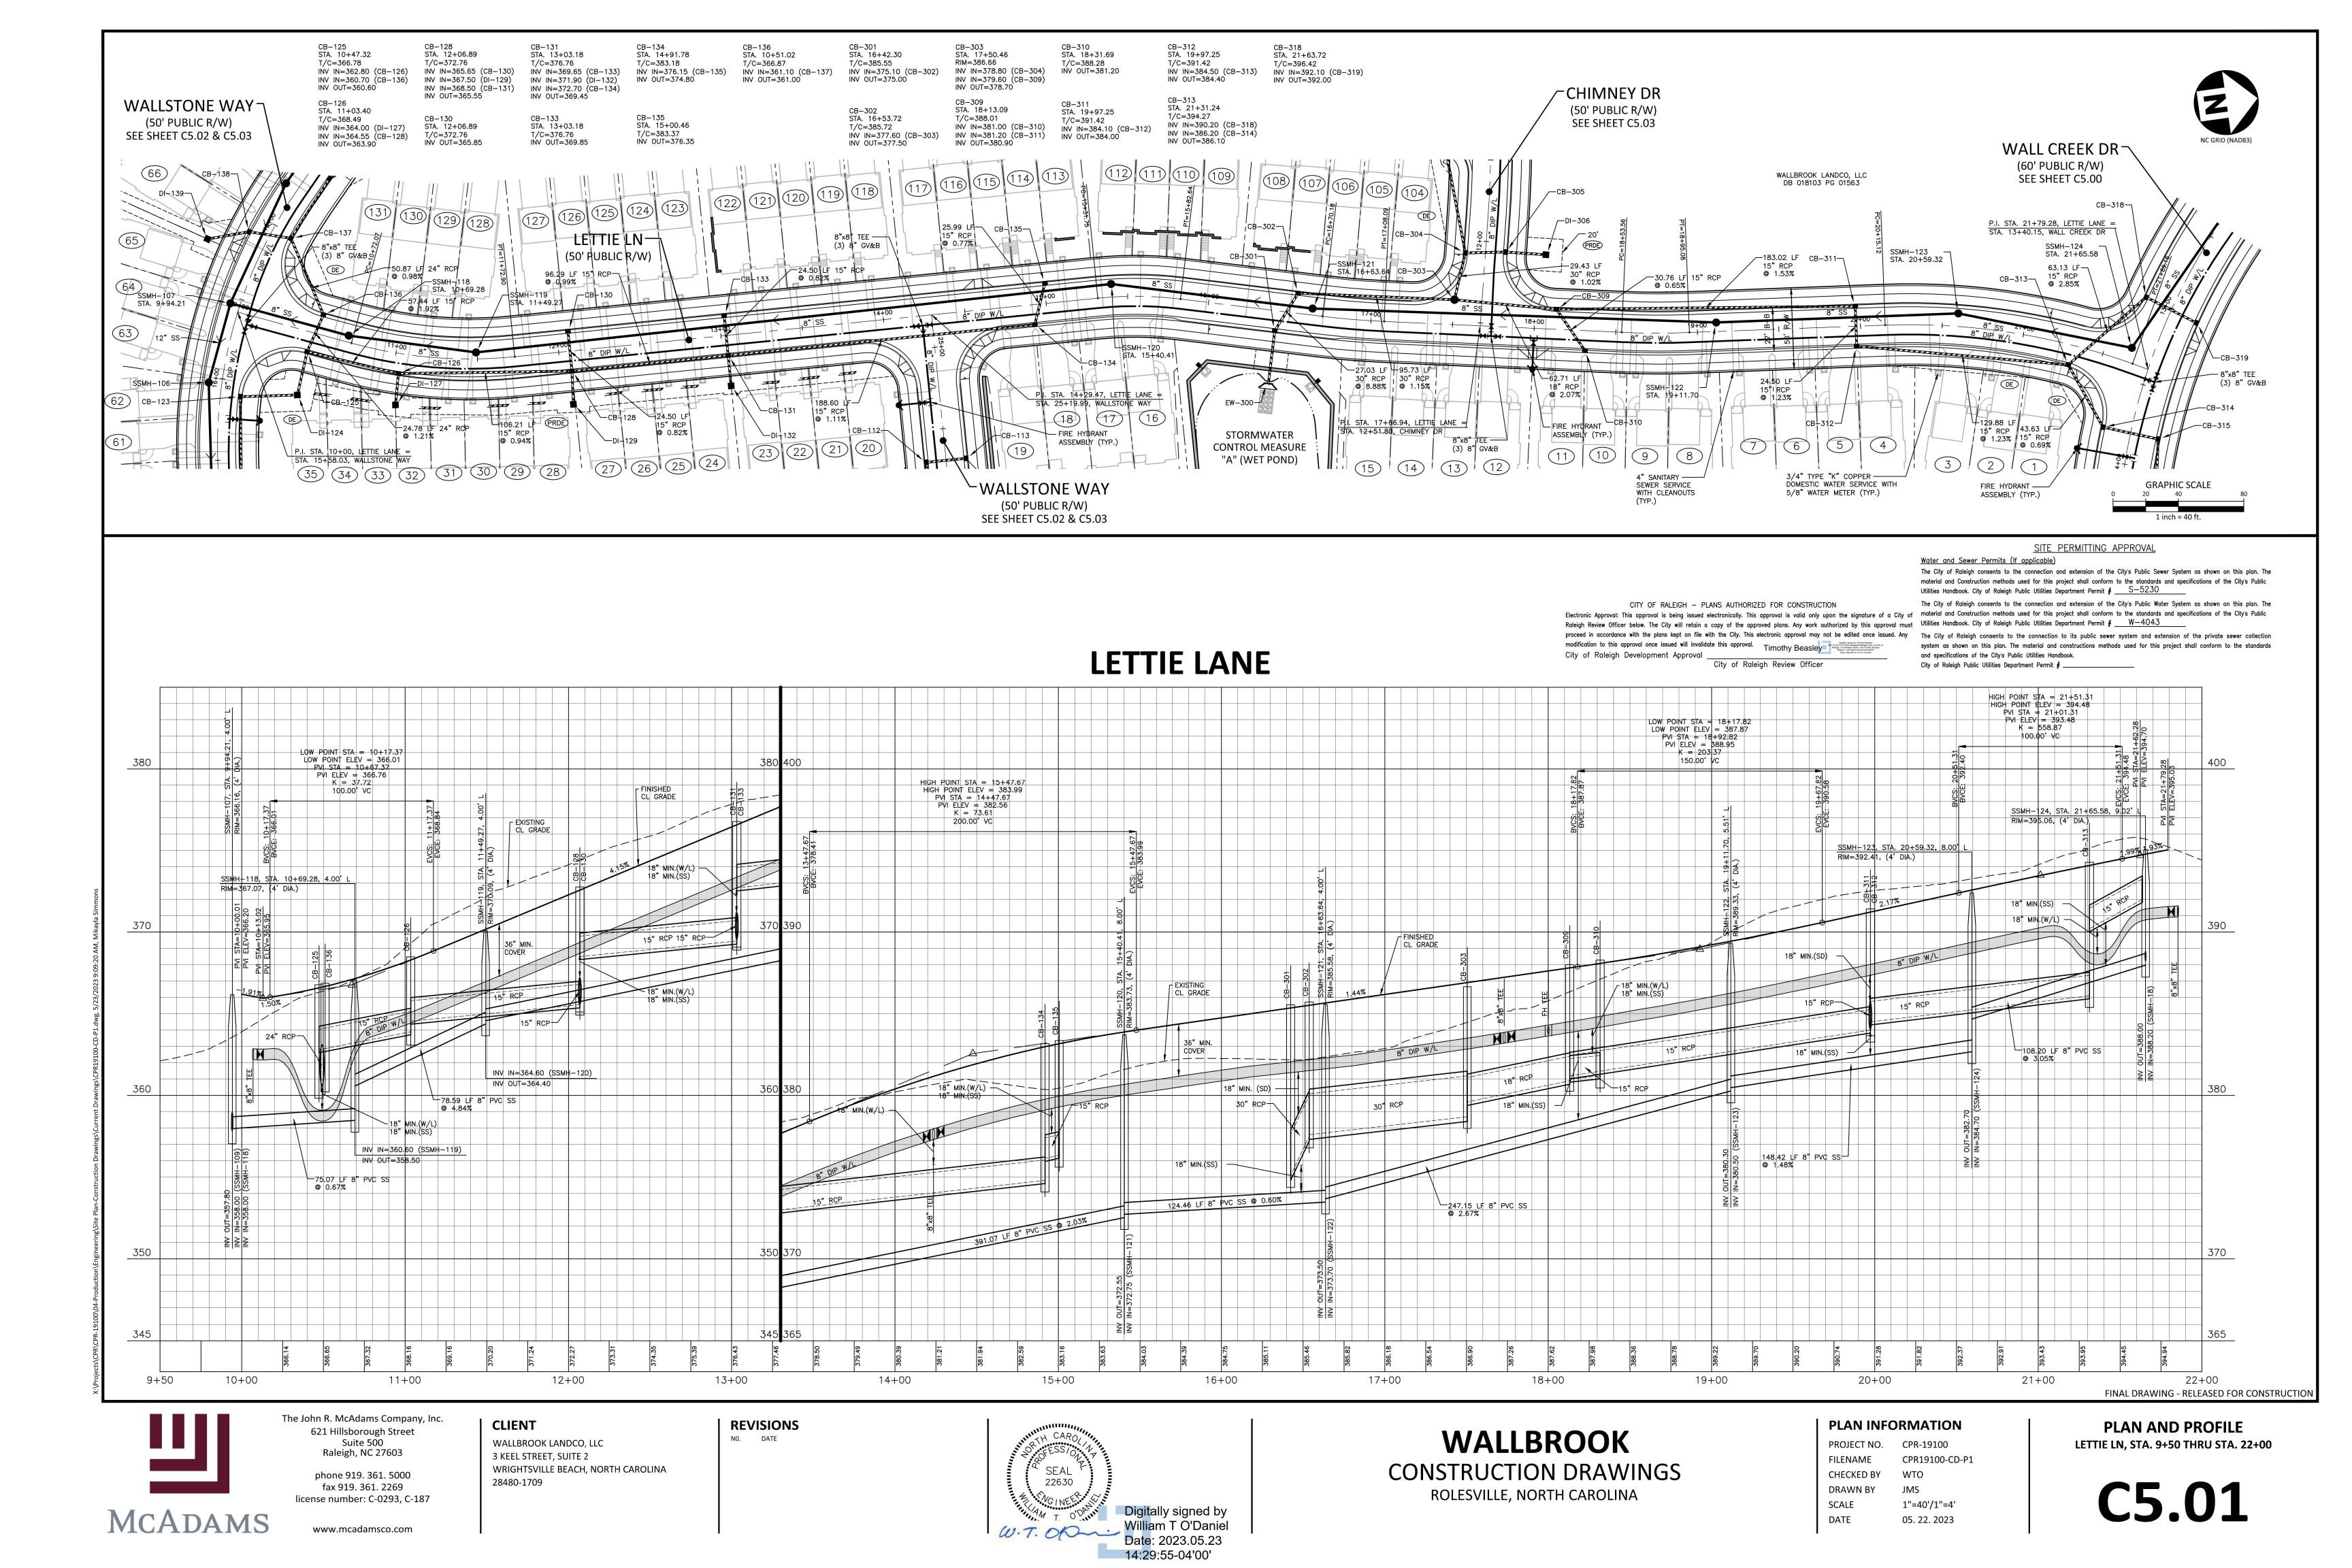

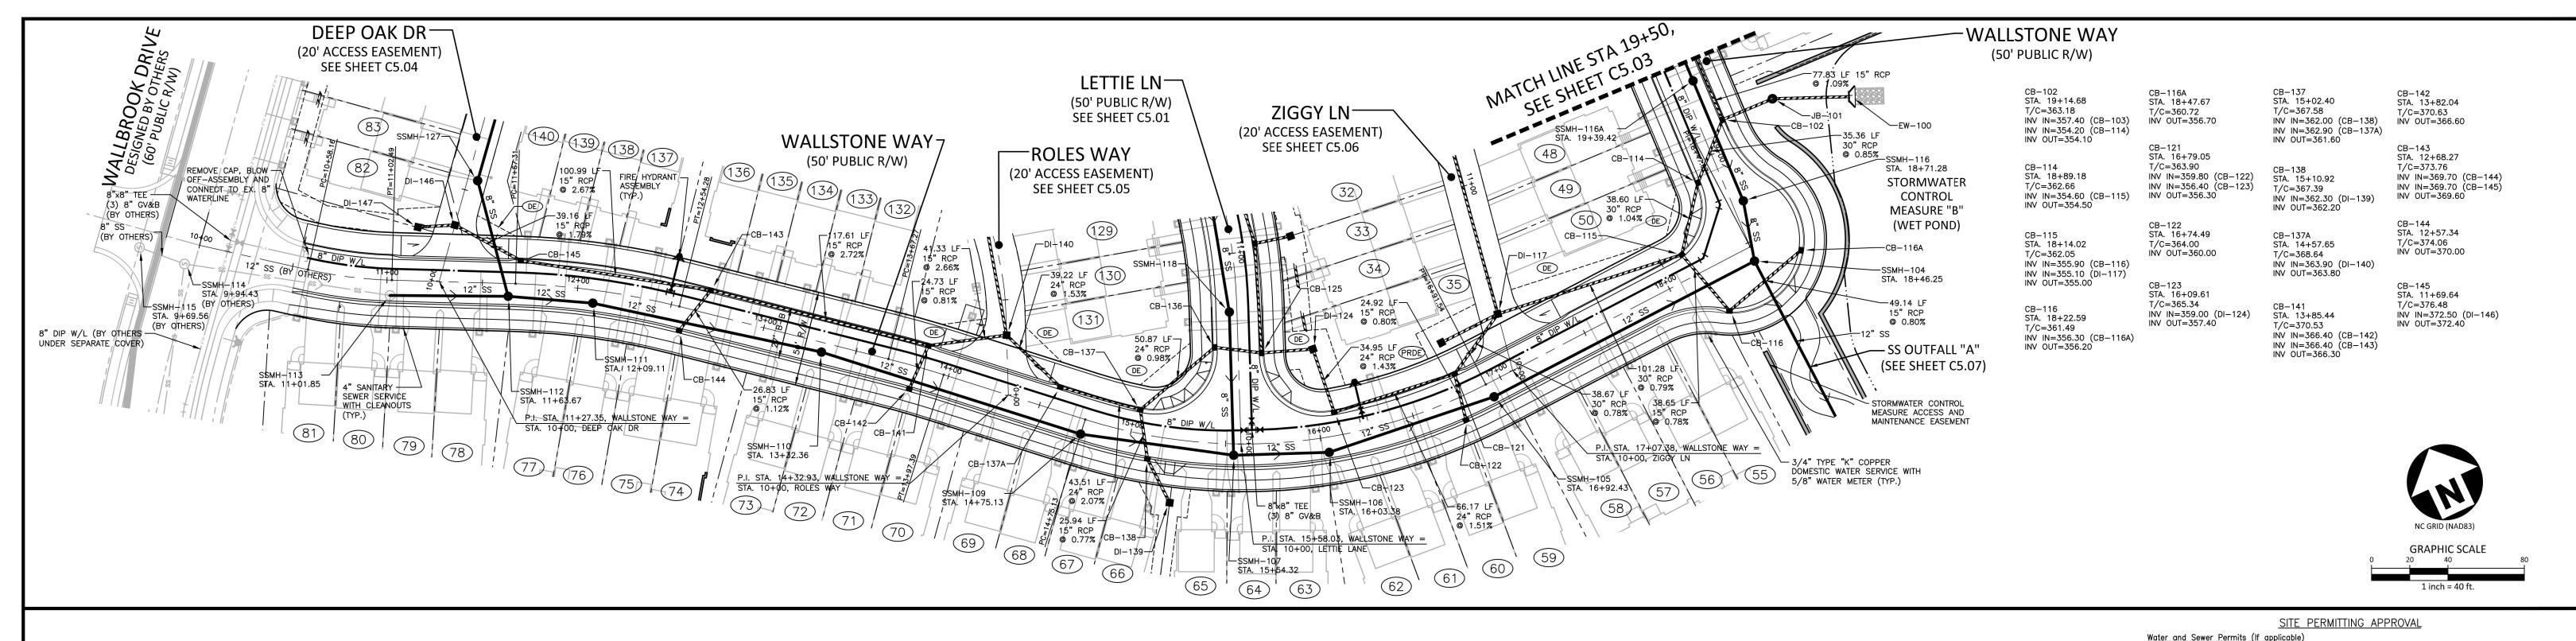


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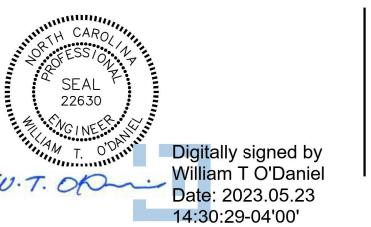
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**WALLBROOK** 

**CONSTRUCTION DRAWINGS** ROLESVILLE, NORTH CAROLINA

PLAN INFORMATION


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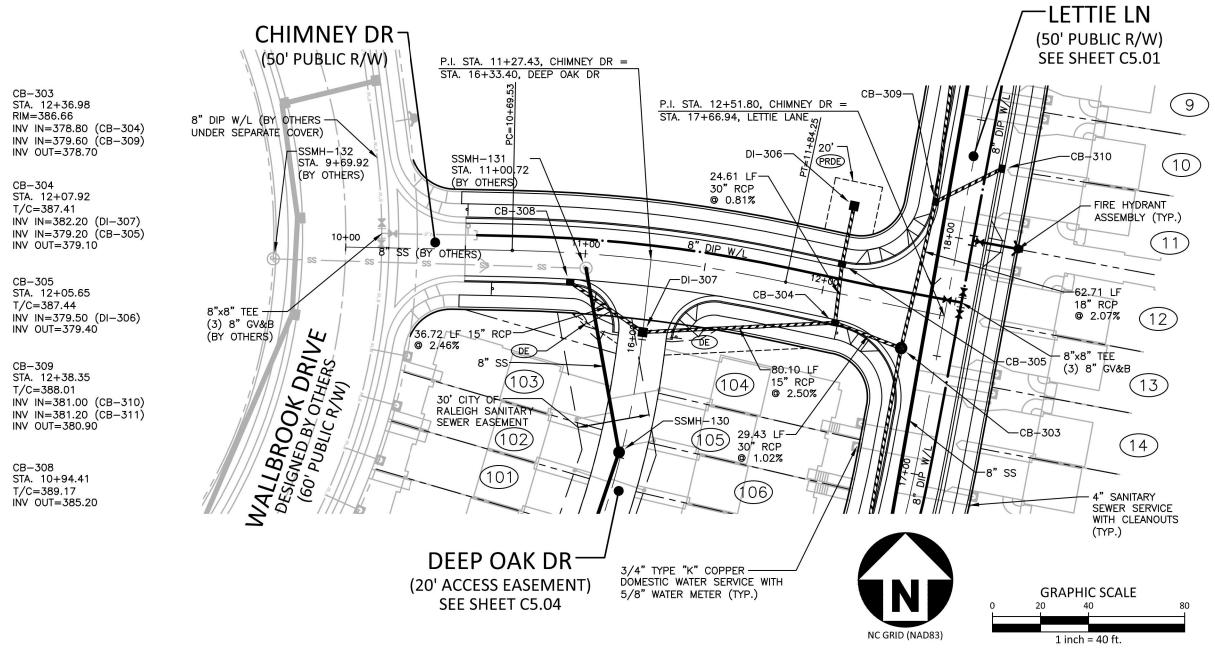
PROJECT NO. CPR-19100 CPR19100-CD-P1 CHECKED BY DRAWN BY **SCALE** 1"=40'/1"=4'


05. 22. 2023

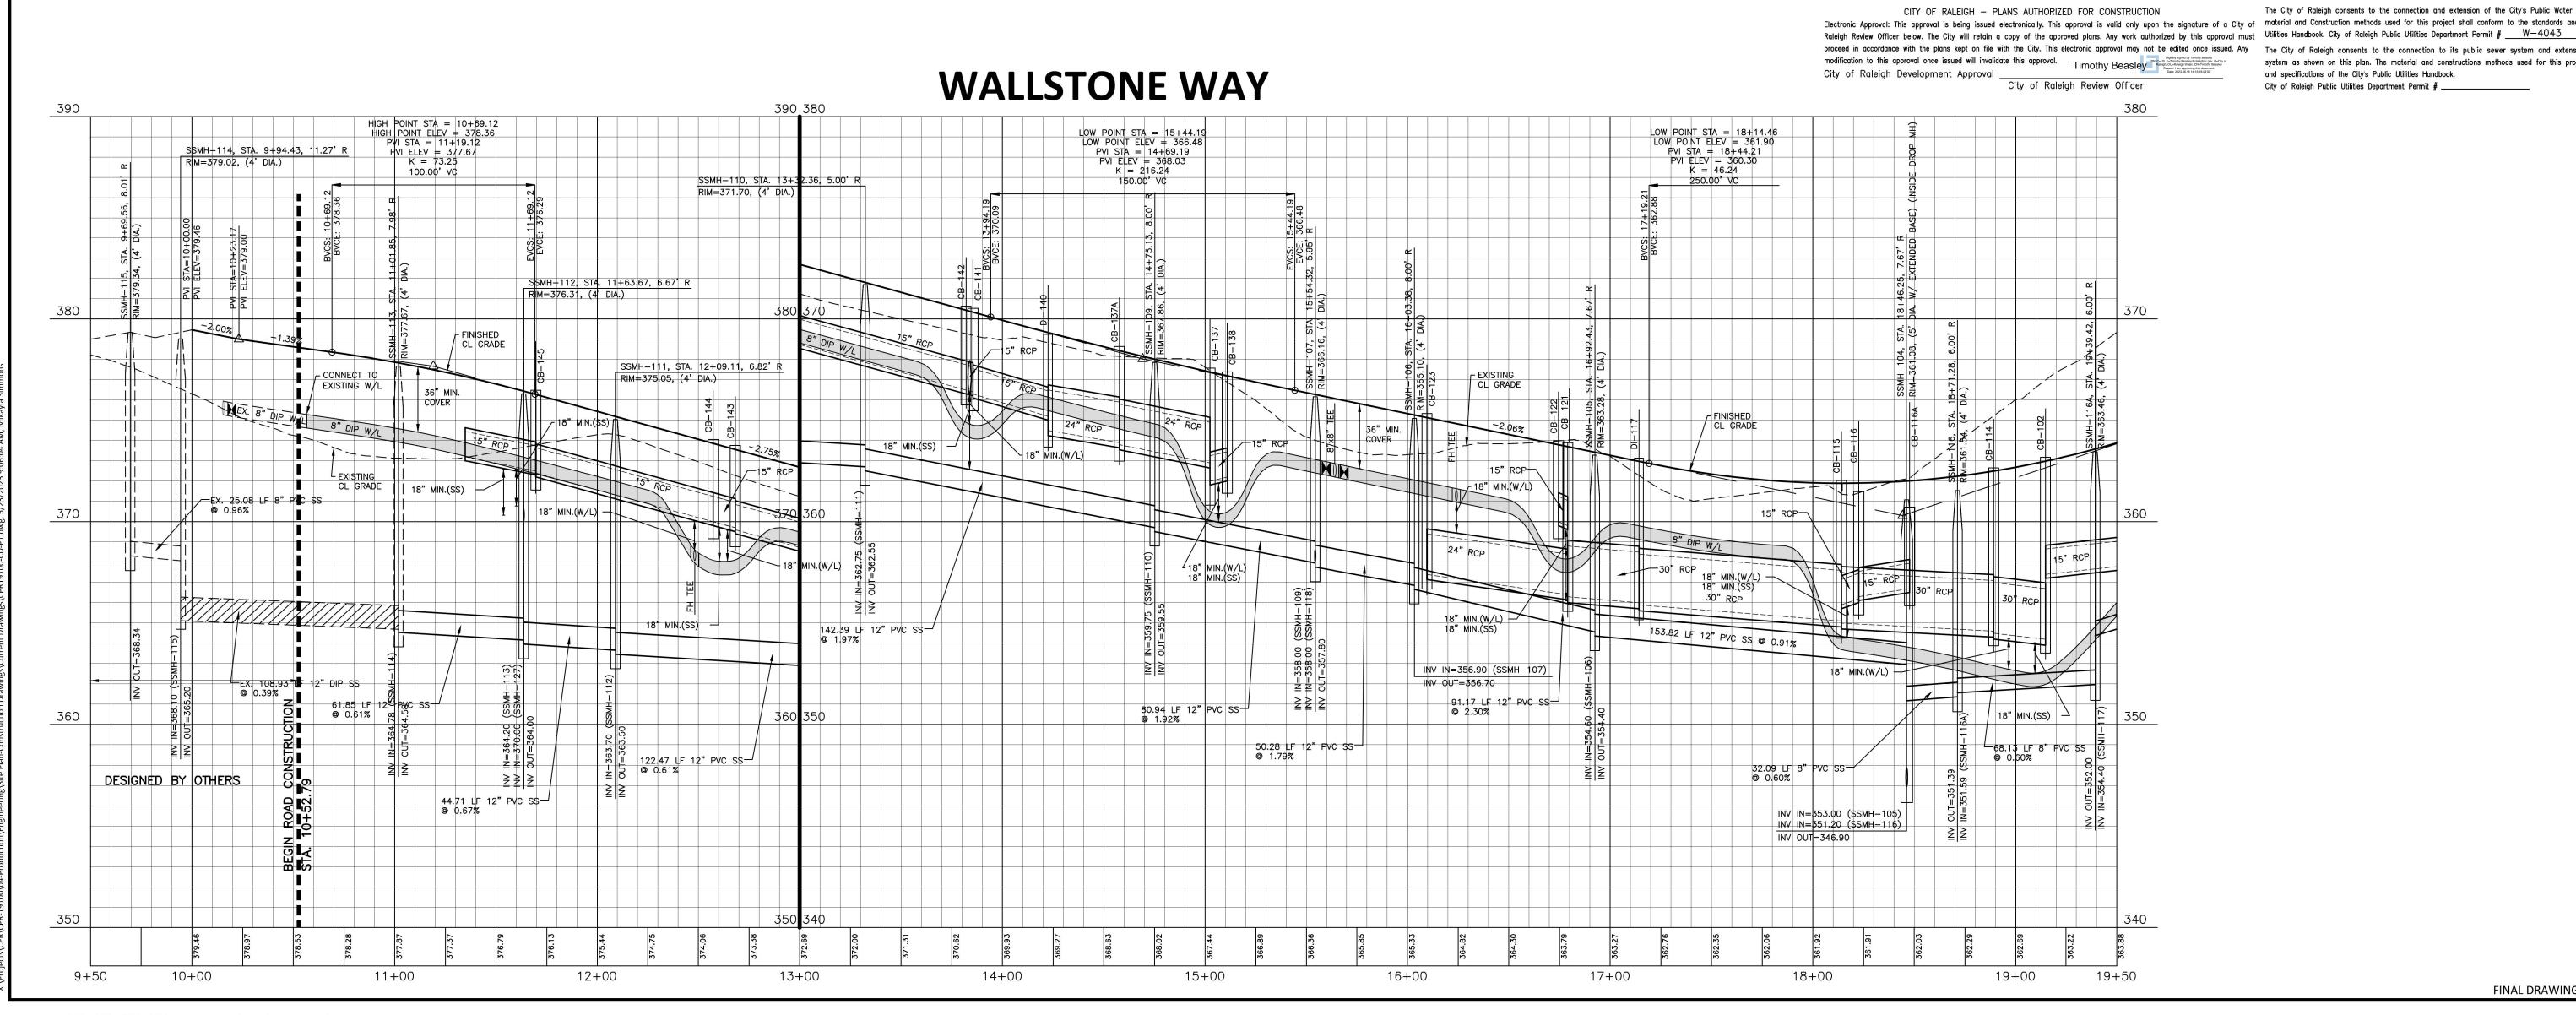**PLAN AND PROFILE** WALLSTONE WAY, STA. 9+50 THRU STA. 19+50

FINAL DRAWING - RELEASED FOR CONSTRUCTION



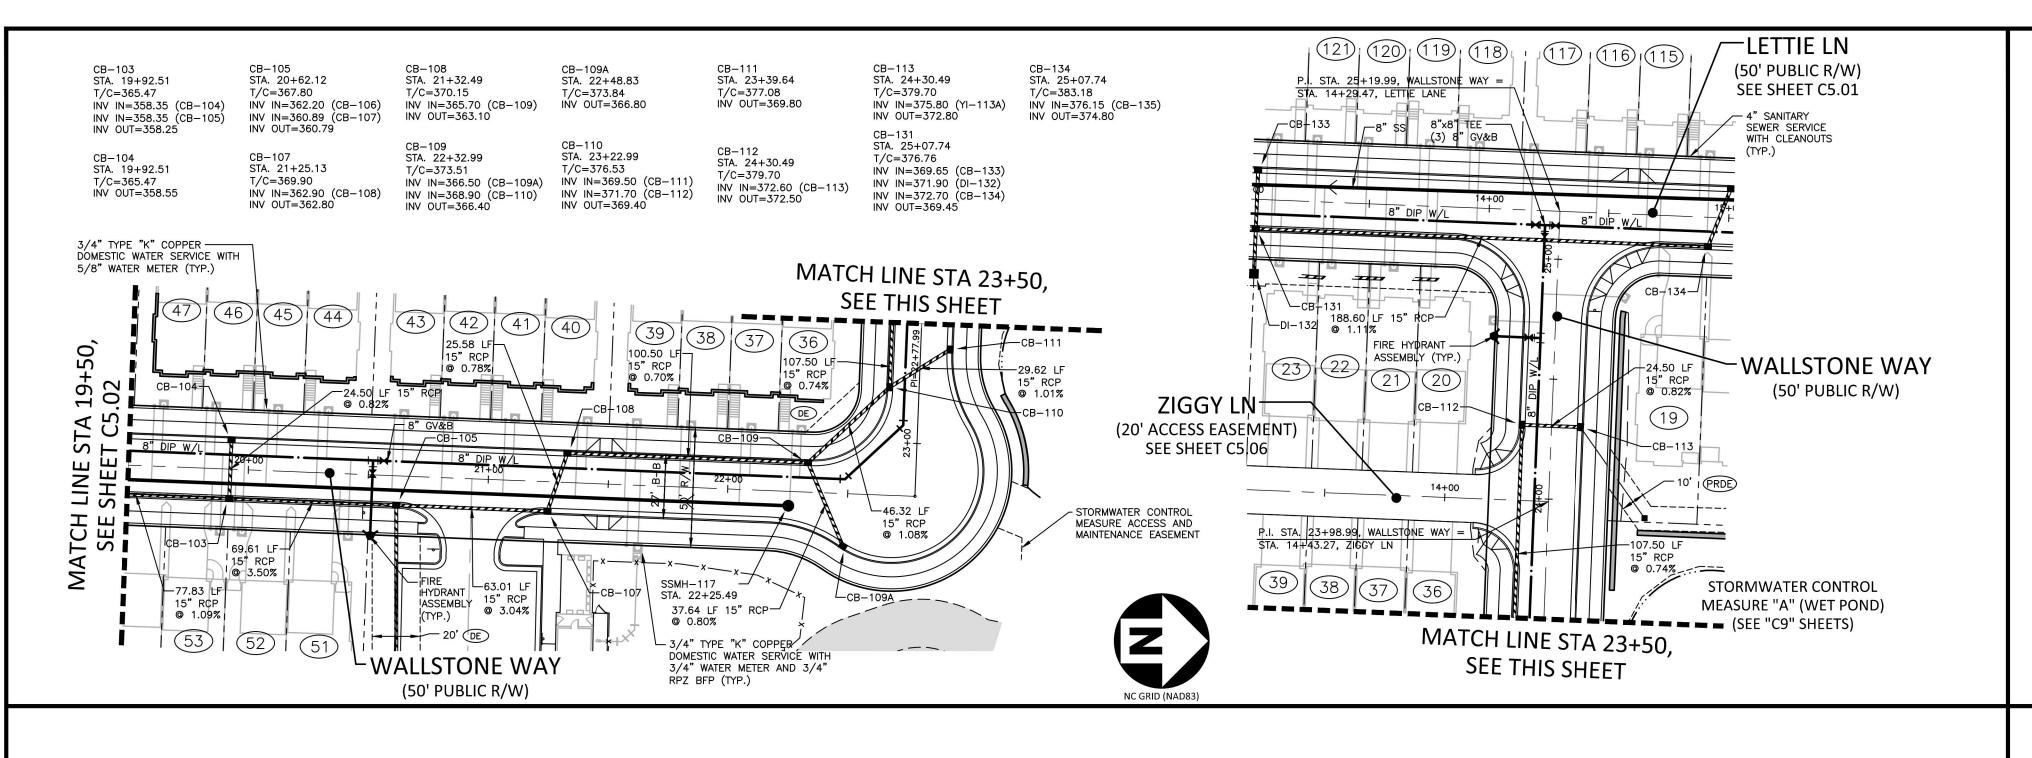

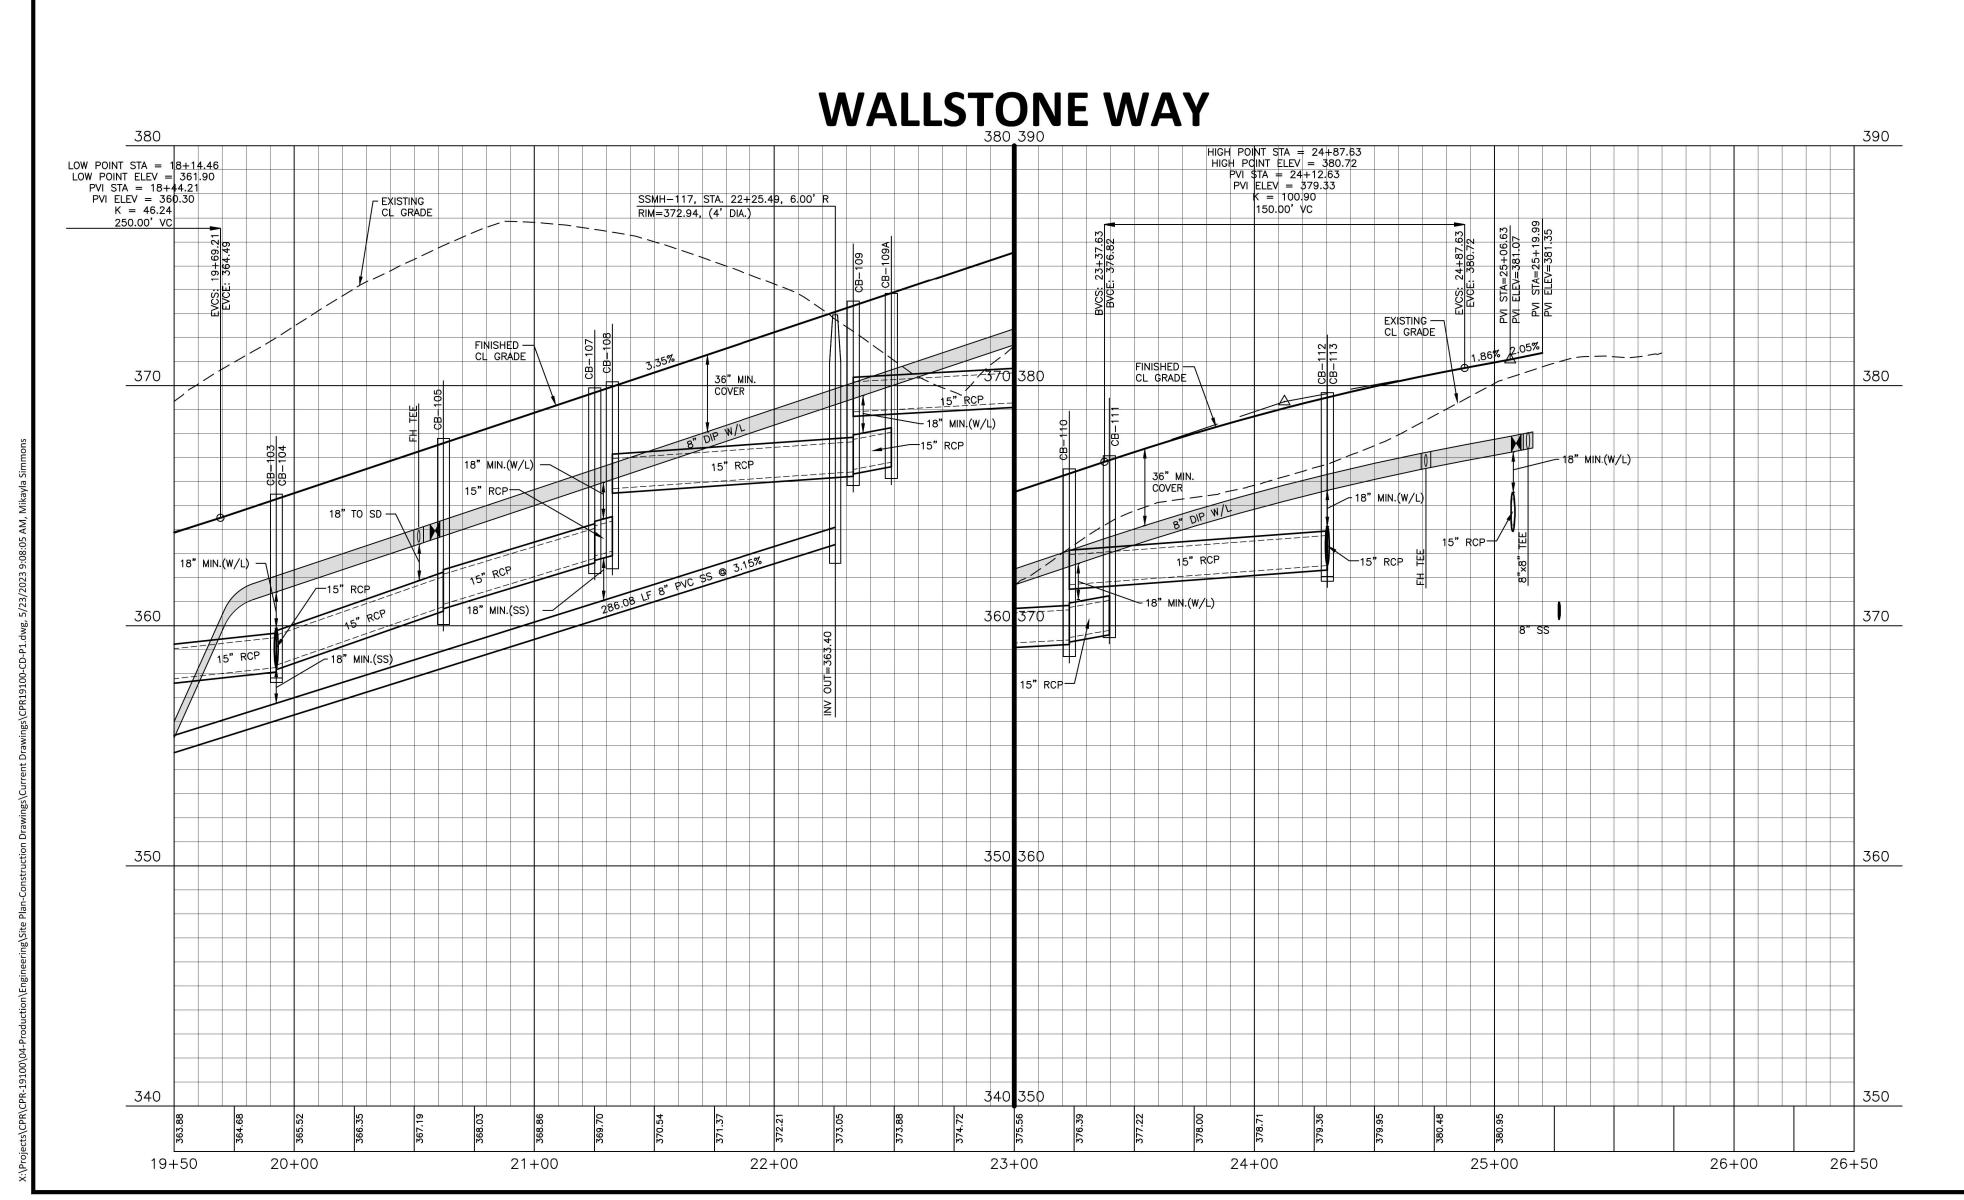

Utilities Handbook. City of Raleigh Public Utilities Department Permit #  $\frac{S-5230}{}$ CITY OF RALEIGH - PLANS AUTHORIZED FOR CONSTRUCTION Raleigh Review Officer below. The City will retain a copy of the approved plans. Any work authorized by this approval must

Utilities Handbook. City of Raleigh Public Utilities Department Permit # W-4043 modification to this approval once issued will invalidate this approval.

Timothy Beasley City of Raleigh Development Approval City of Raleigh Review Officer

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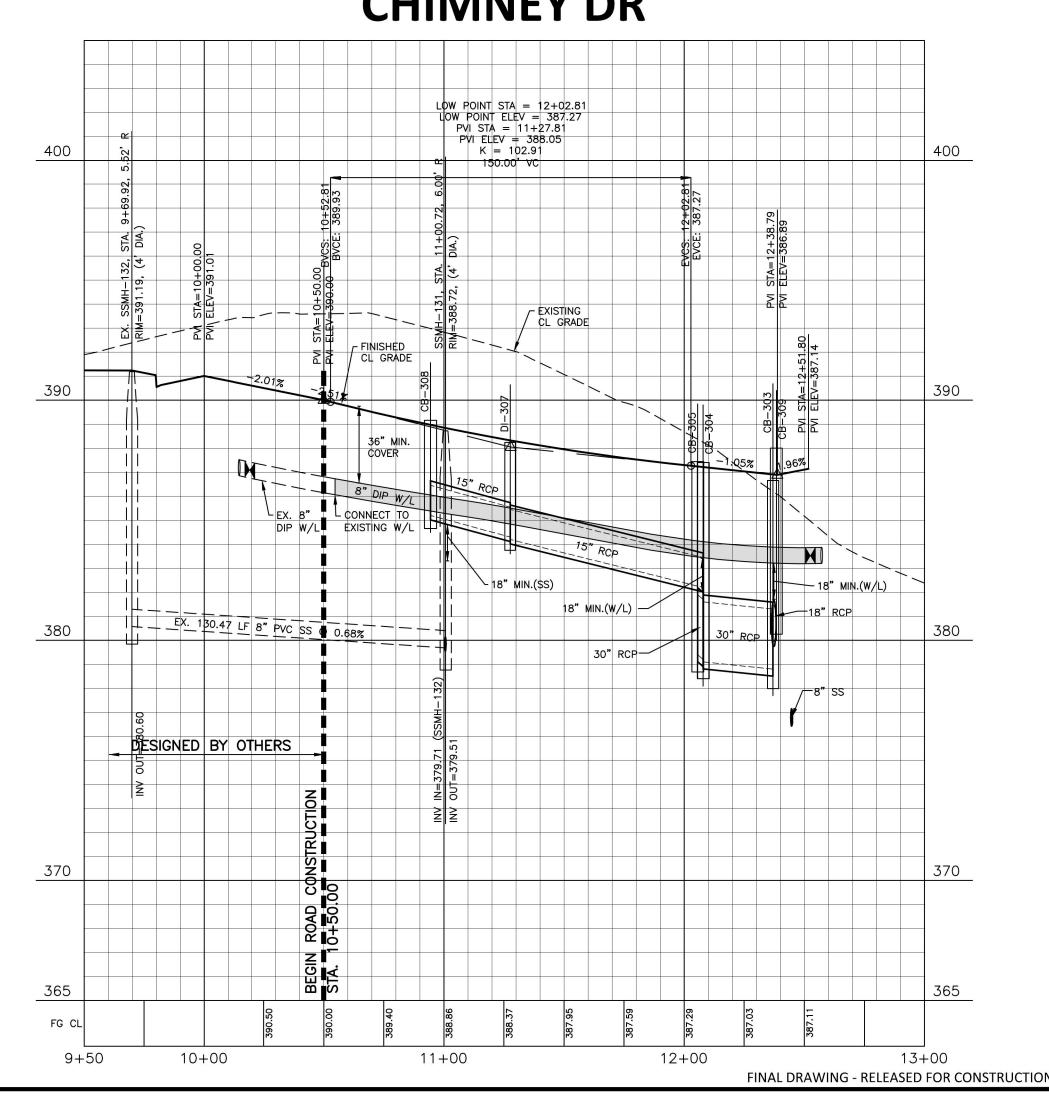
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SITE PERMITTING APPROVAL

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# **CHIMNEY DR**

Water and Sewer Permits (If applicable)





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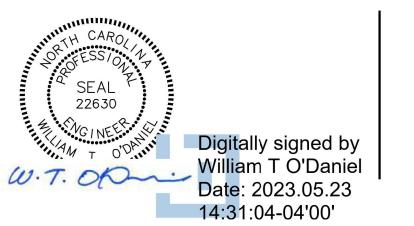
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**CLIENT** 

WALLBROOK LANDCO, LLC

**REVISIONS** NO. DATE





**WALLBROOK CONSTRUCTION DRAWINGS** ROLESVILLE, NORTH CAROLINA

PLAN INFORMATION


PROJECT NO. CPR-19100 CPR19100-CD-P1 **FILENAME** CHECKED BY DRAWN BY **SCALE** 1"=40'/1"=4' DATE 05. 22. 2023

**PLAN AND PROFILE** WALLSTONE WAY, STA. 19+50 THRU STA. 26+50 CHIMNEY DR, STA. 9+50 THRU STA. 13+00

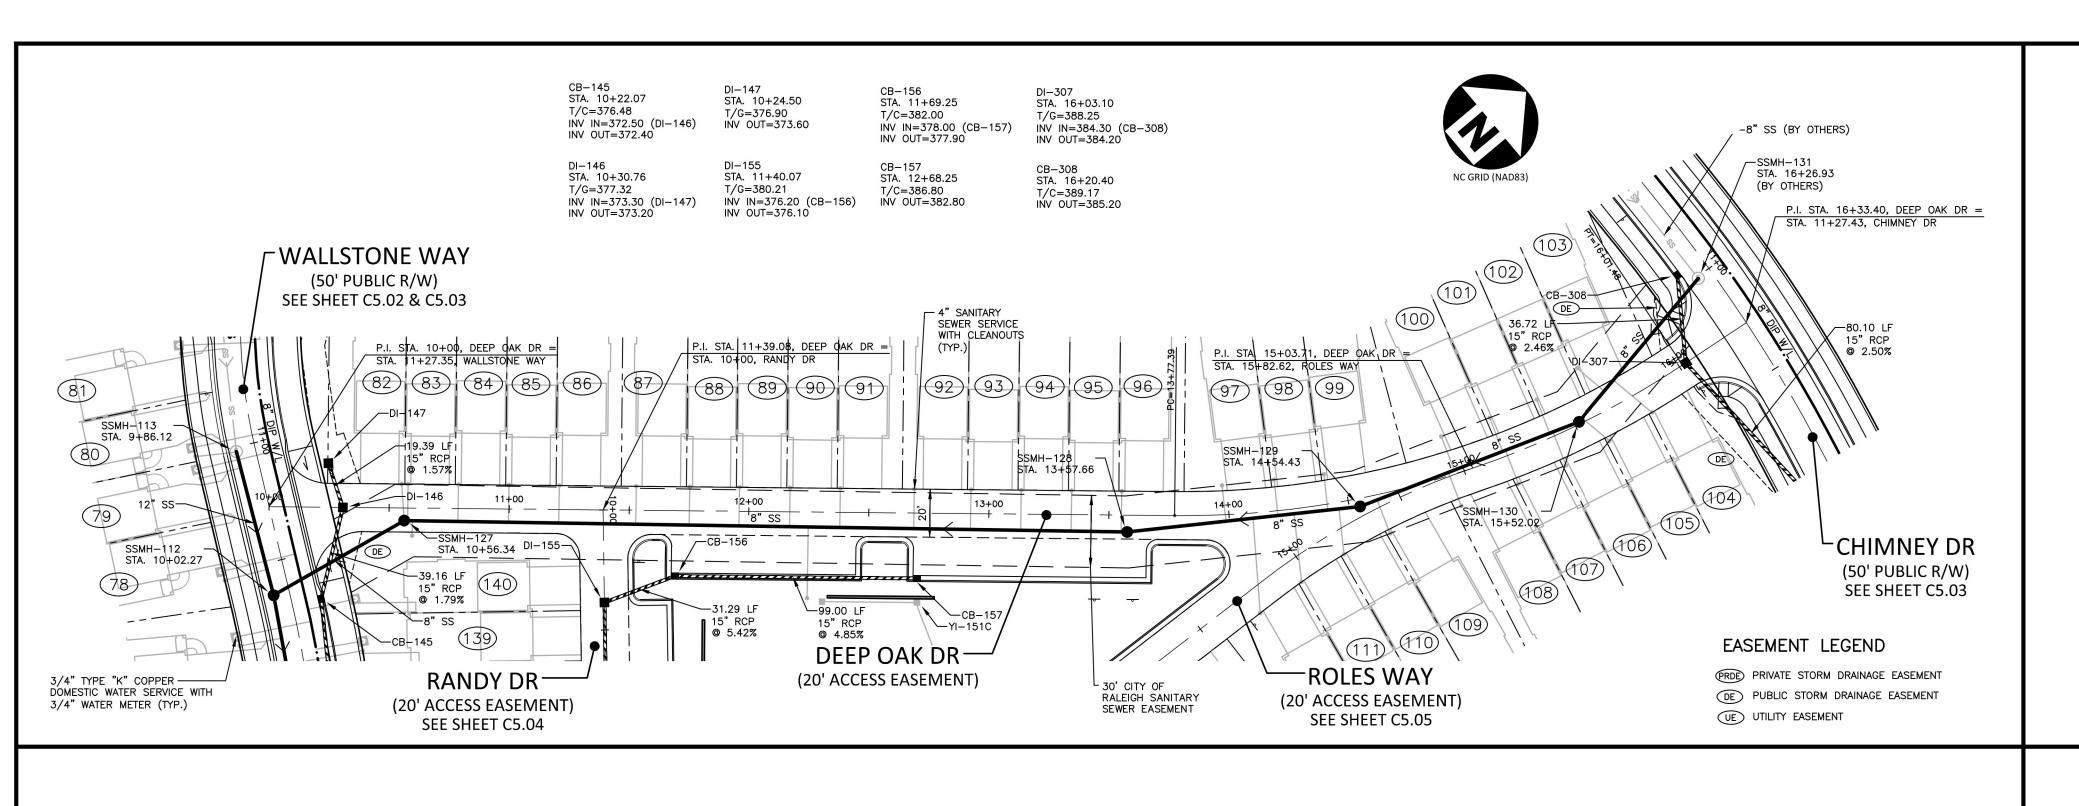

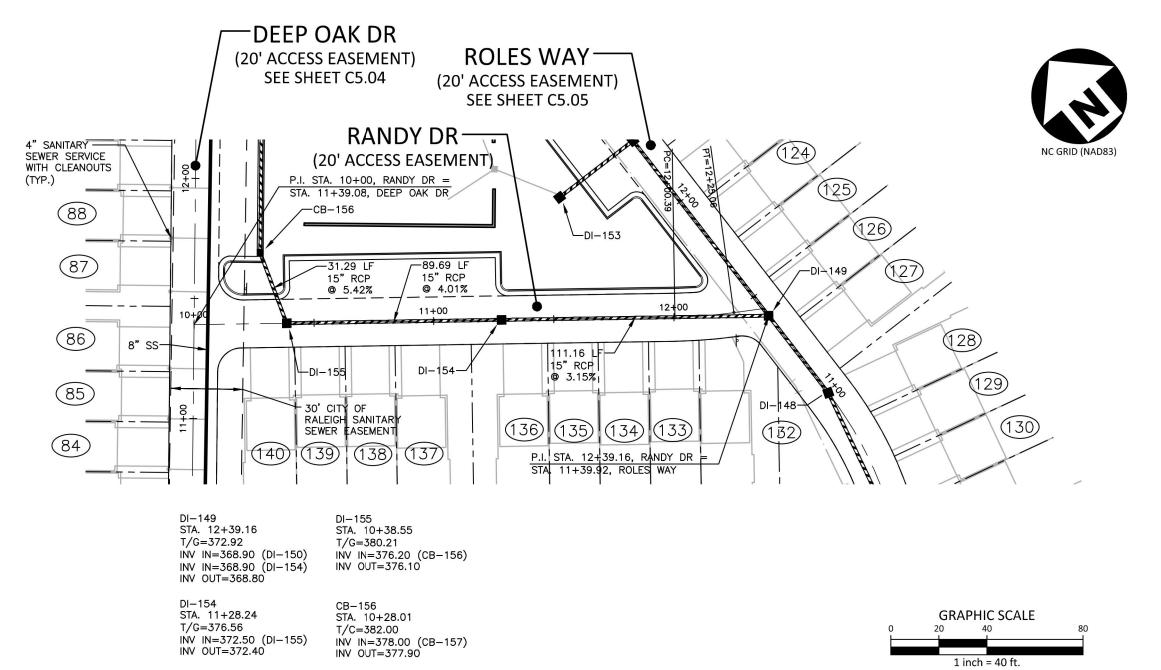



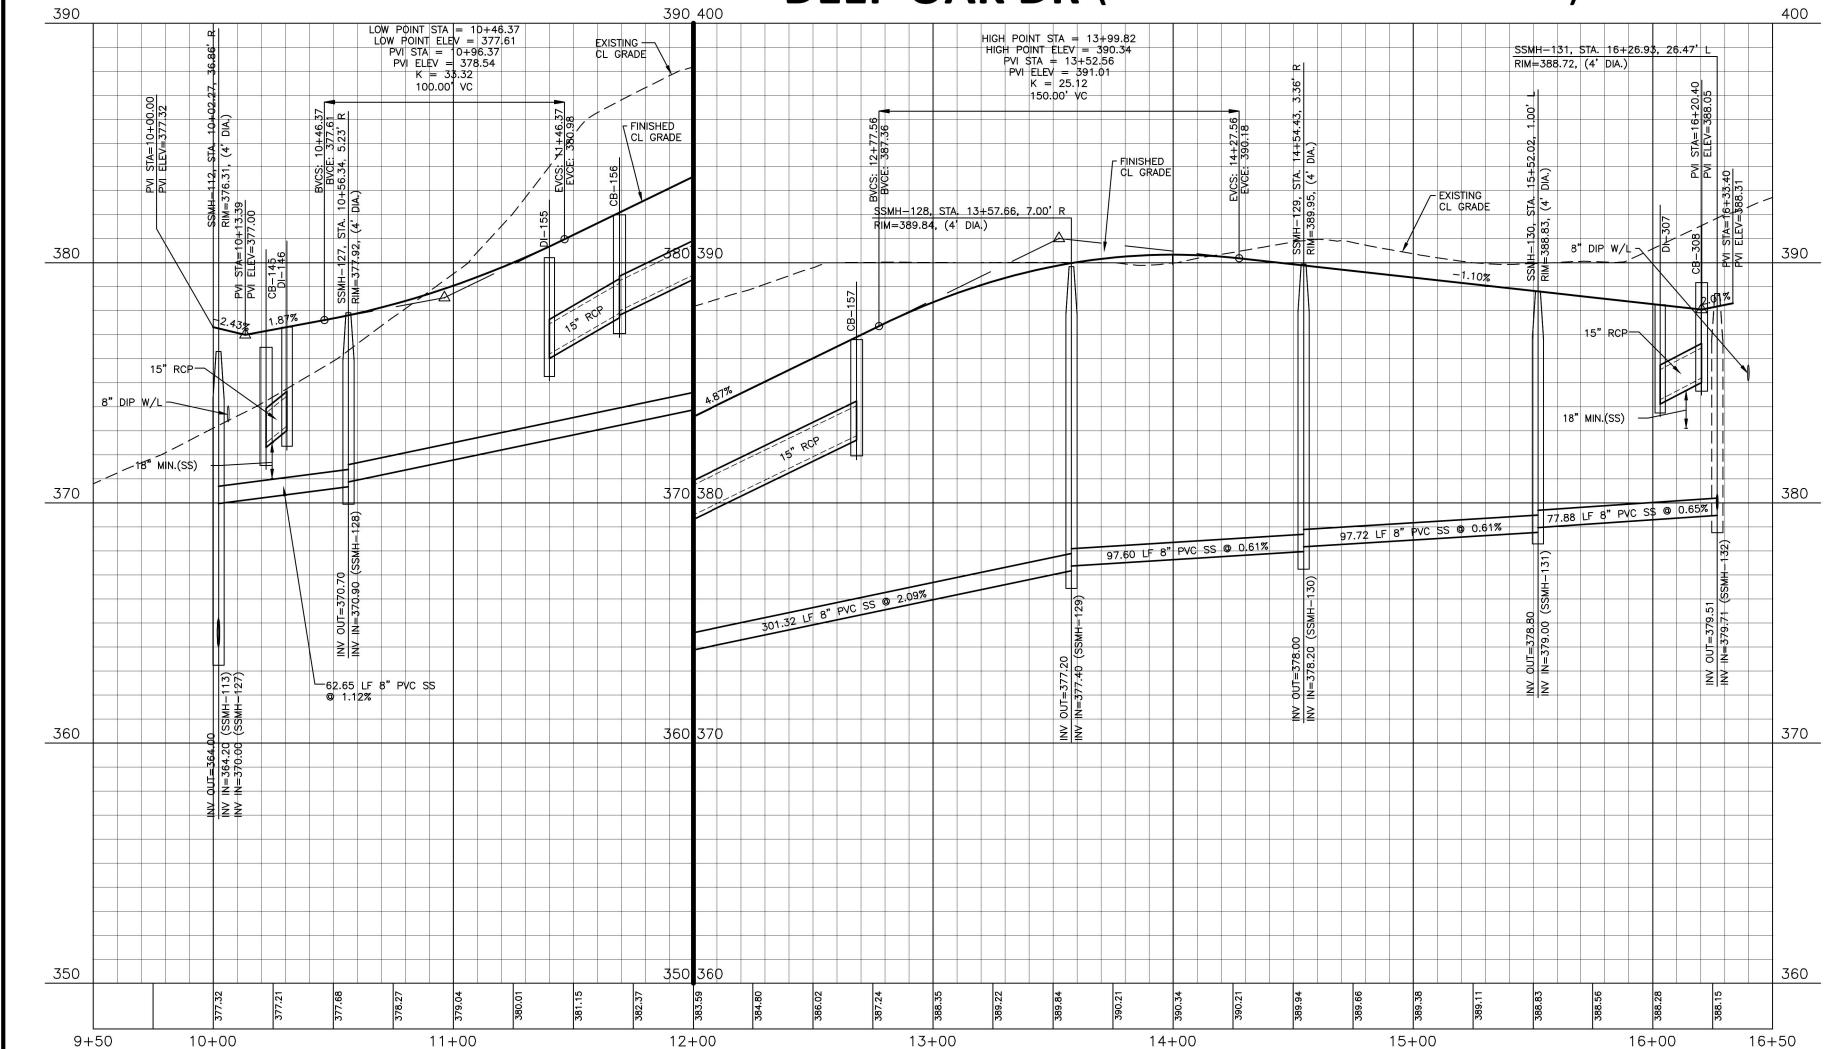

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Timothy Beasley

City of Raleigh Review Officer

City of Raleigh Development Approval

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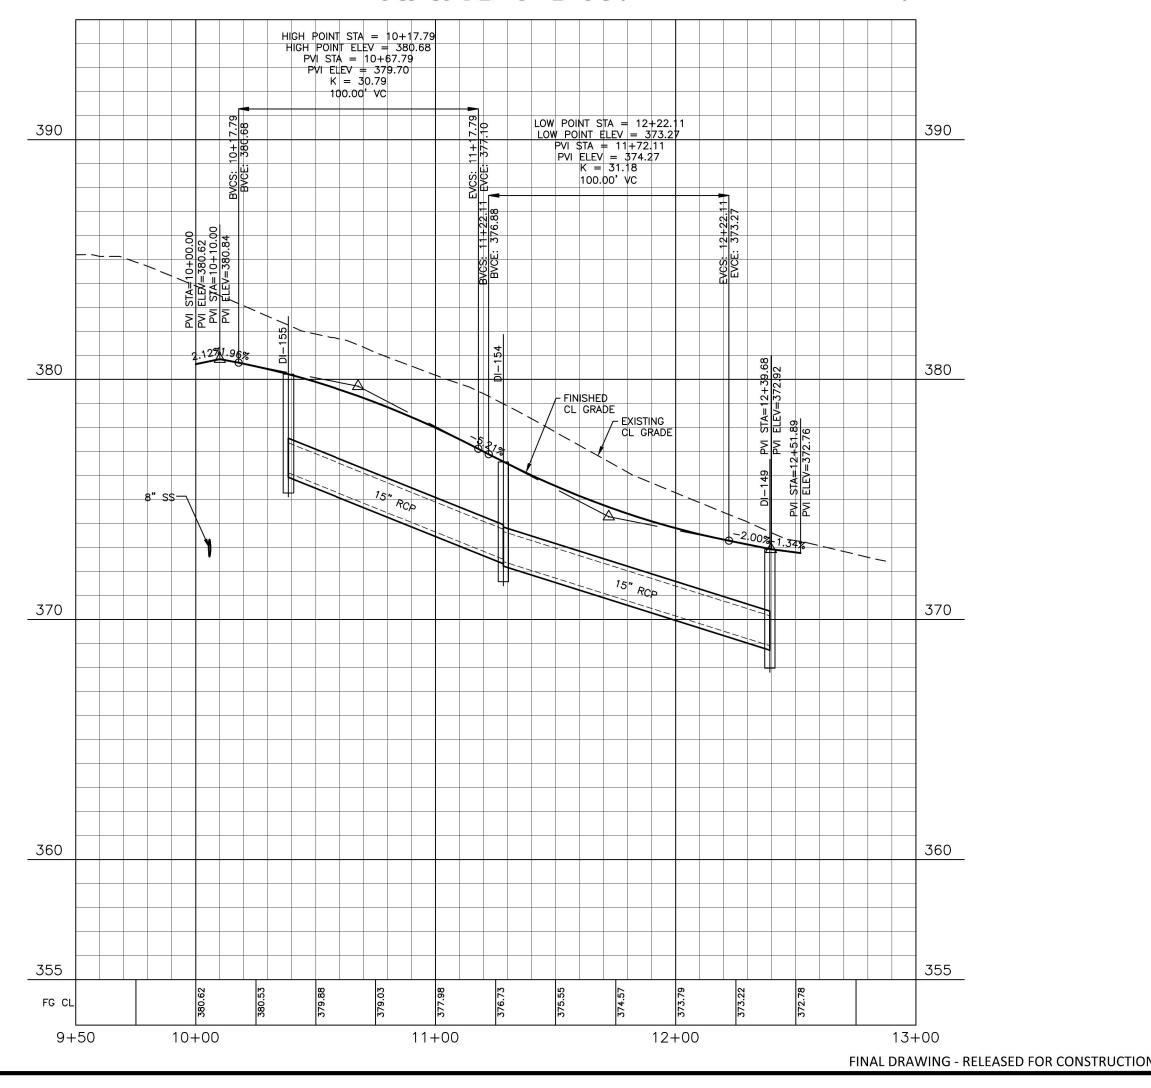
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# RANDY DR (POSTED SPEED LIMIT 15 MPH)

Water and Sewer Permits (If applicable)





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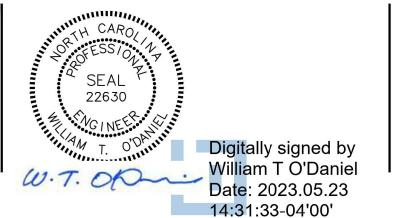
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28480-1709

**REVISIONS** NO. DATE




**WALLBROOK CONSTRUCTION DRAWINGS** ROLESVILLE, NORTH CAROLINA

PLAN INFORMATION

PROJECT NO. CPR-19100

CPR19100-CD-P2 **FILENAME** CHECKED BY DRAWN BY **SCALE** 1"=40'/1"=4' DATE 05. 22. 2023

**PLAN AND PROFILE** DEEP OAK DR, STA. 9+50 THRU STA. 16+50 RANDY DR, STA. 9+50 THRU STA. 13+00

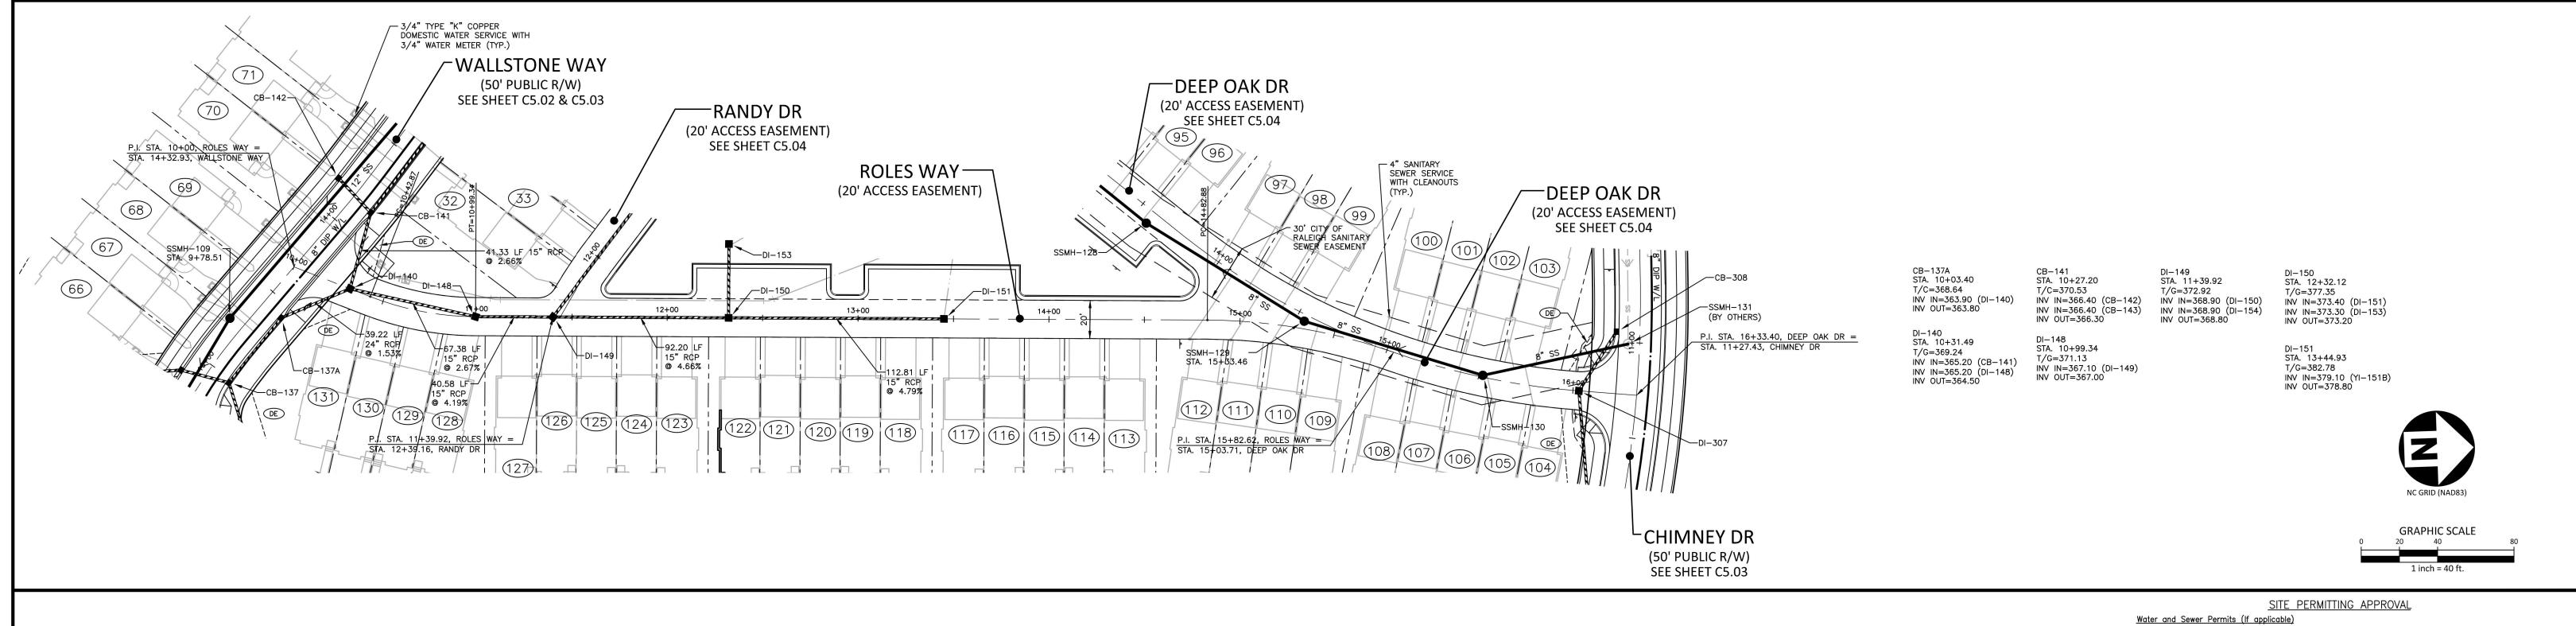

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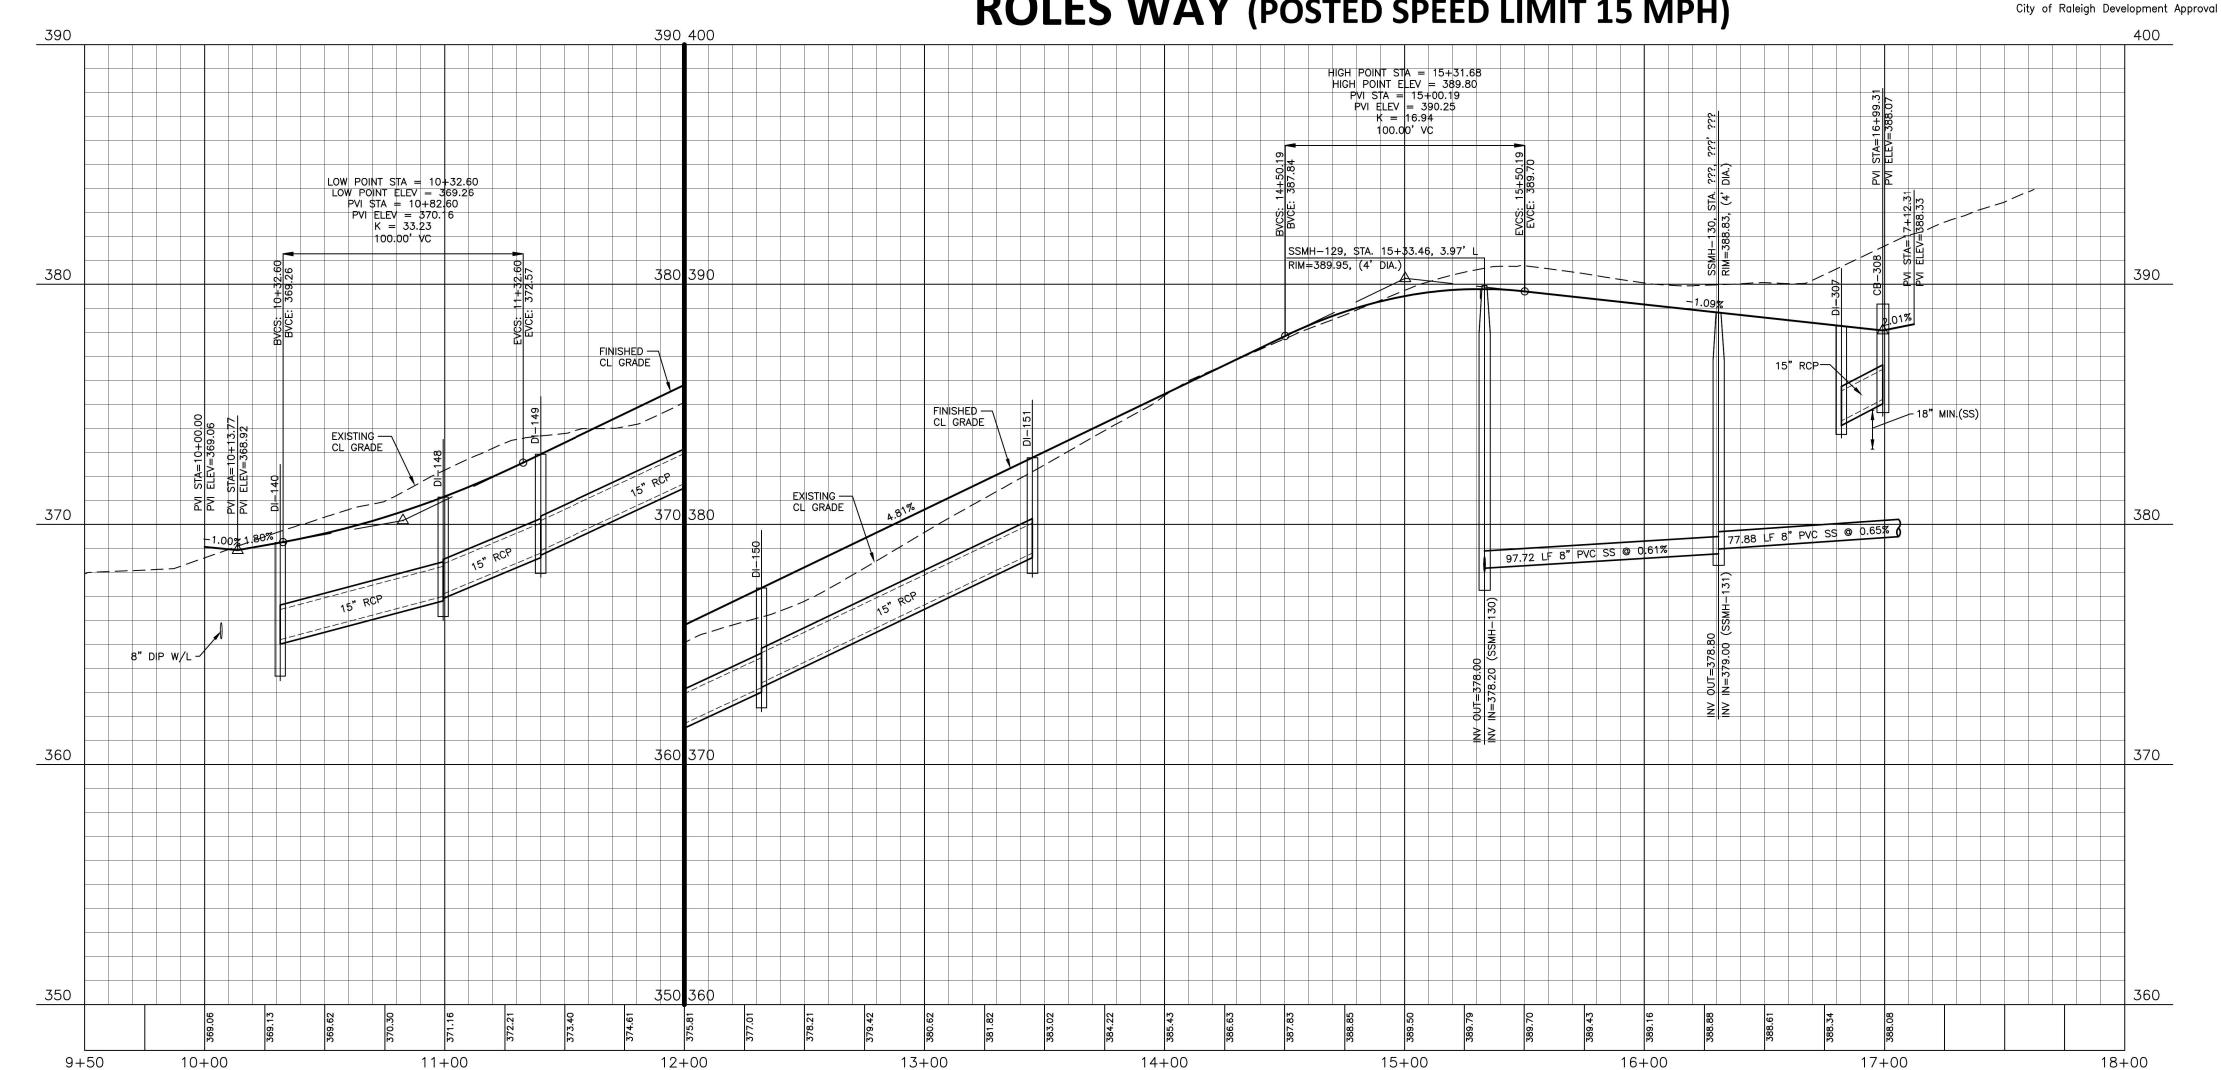
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# ROLES WAY (POSTED SPEED LIMIT 15 MPH)



FINAL DRAWING - RELEASED FOR CONSTRUCTION



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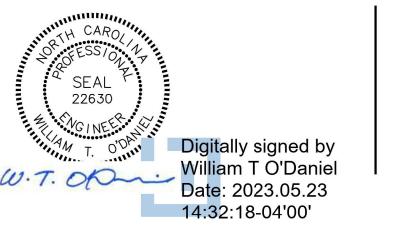
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WALLBROOK LANDCO, LLC

NO. DATE

**REVISIONS** 



**WALLBROOK** CONSTRUCTION DRAWINGS ROLESVILLE, NORTH CAROLINA

**PLAN INFORMATION** 

CITY OF RALEIGH - PLANS AUTHORIZED FOR CONSTRUCTION

City of Raleigh Review Officer


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PLAN AND PROFILE ROLES WAY, STA. 9+50 THRU STA. 16+50





SITE PERMITTING APPROVAL

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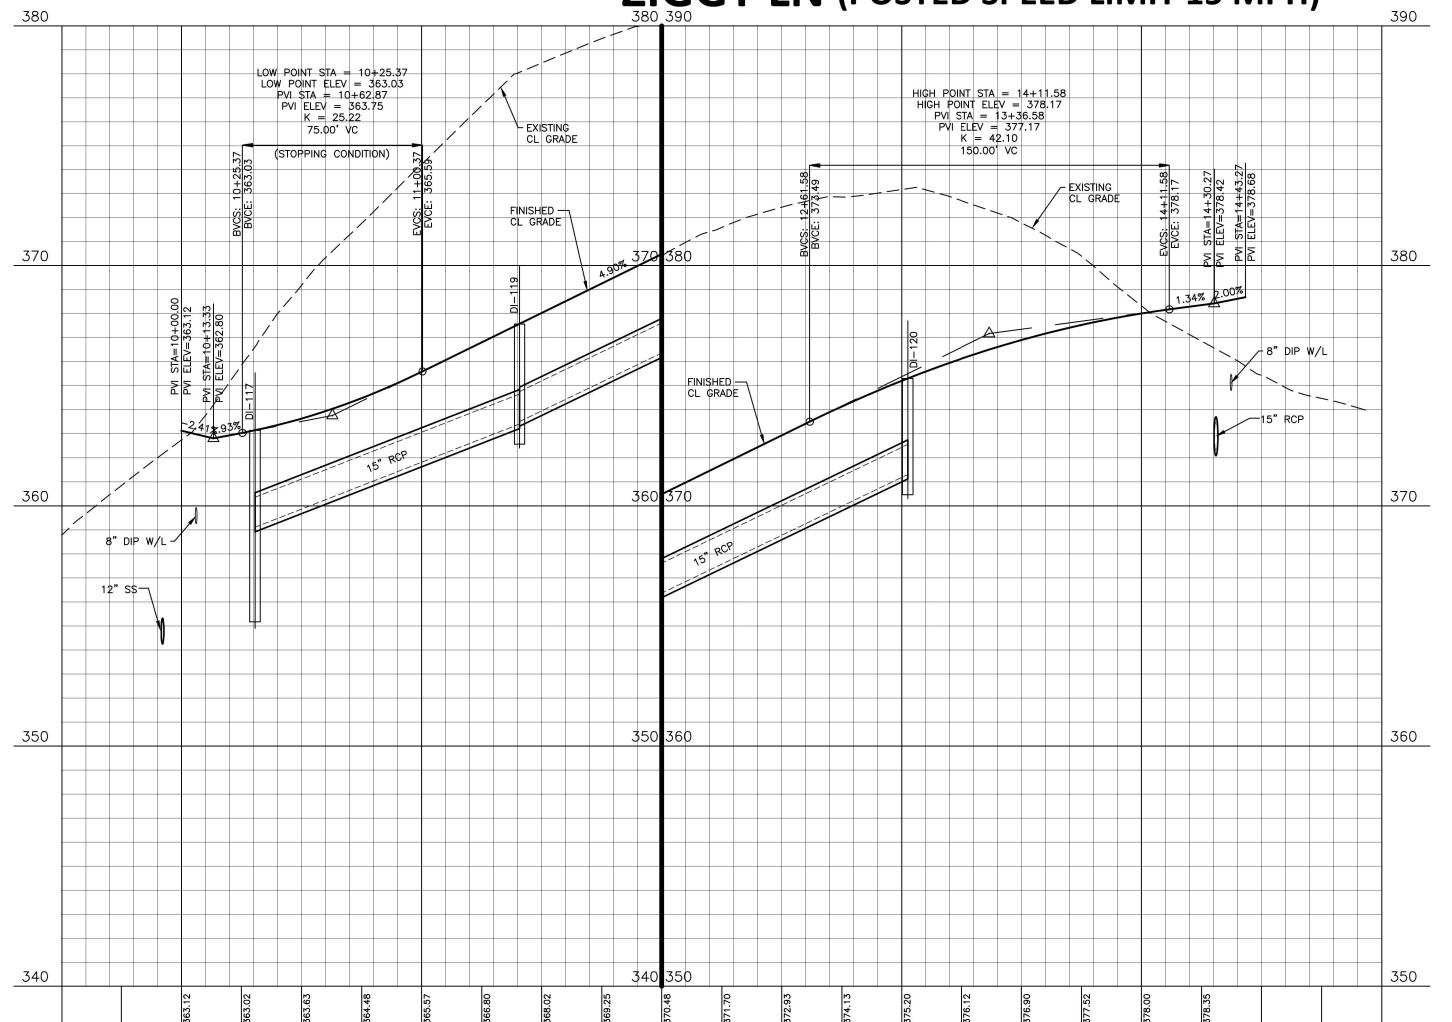
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**ZIGGY LN** (POSTED SPEED LIMIT 15 MPH)

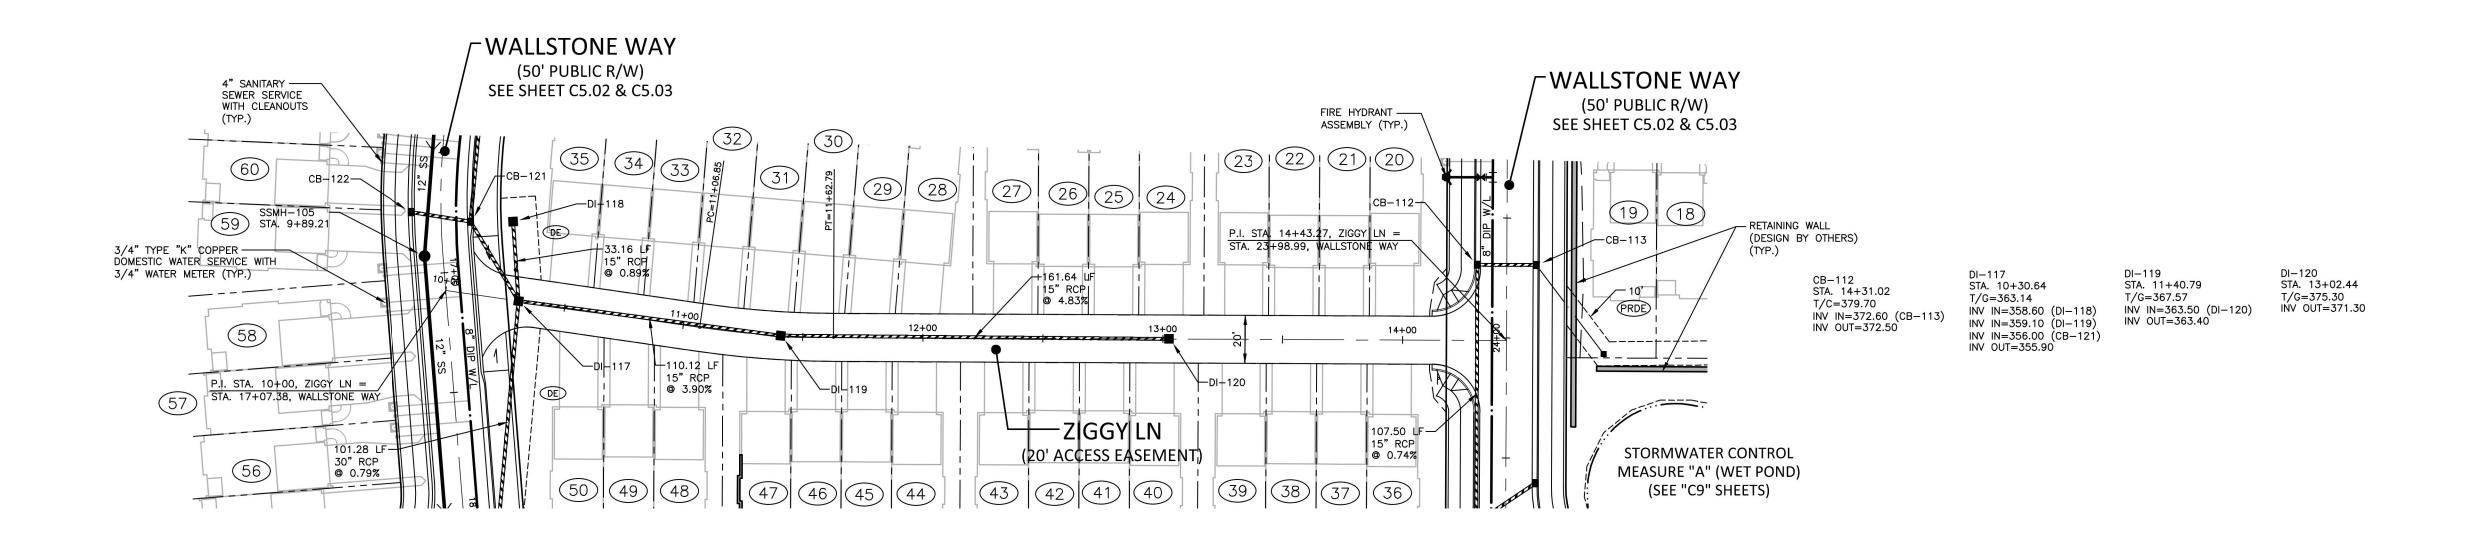

12+00

CITY OF RALEIGH - PLANS AUTHORIZED FOR CONSTRUCTION

City of Raleigh Review Officer

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City of Raleigh Development Approval

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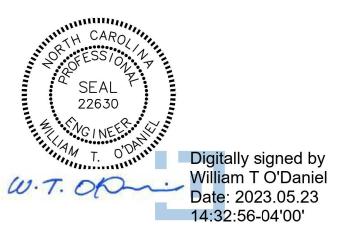
10+00

9+50

28480-1709

**REVISIONS** NO. DATE

11 + 00



13+00

14+00

**WALLBROOK CONSTRUCTION DRAWINGS** ROLESVILLE, NORTH CAROLINA

15+00


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PLAN AND PROFILE ZIGGY LN, STA. 9+50 THRU STA. 15+00



# SS OUTFALL A

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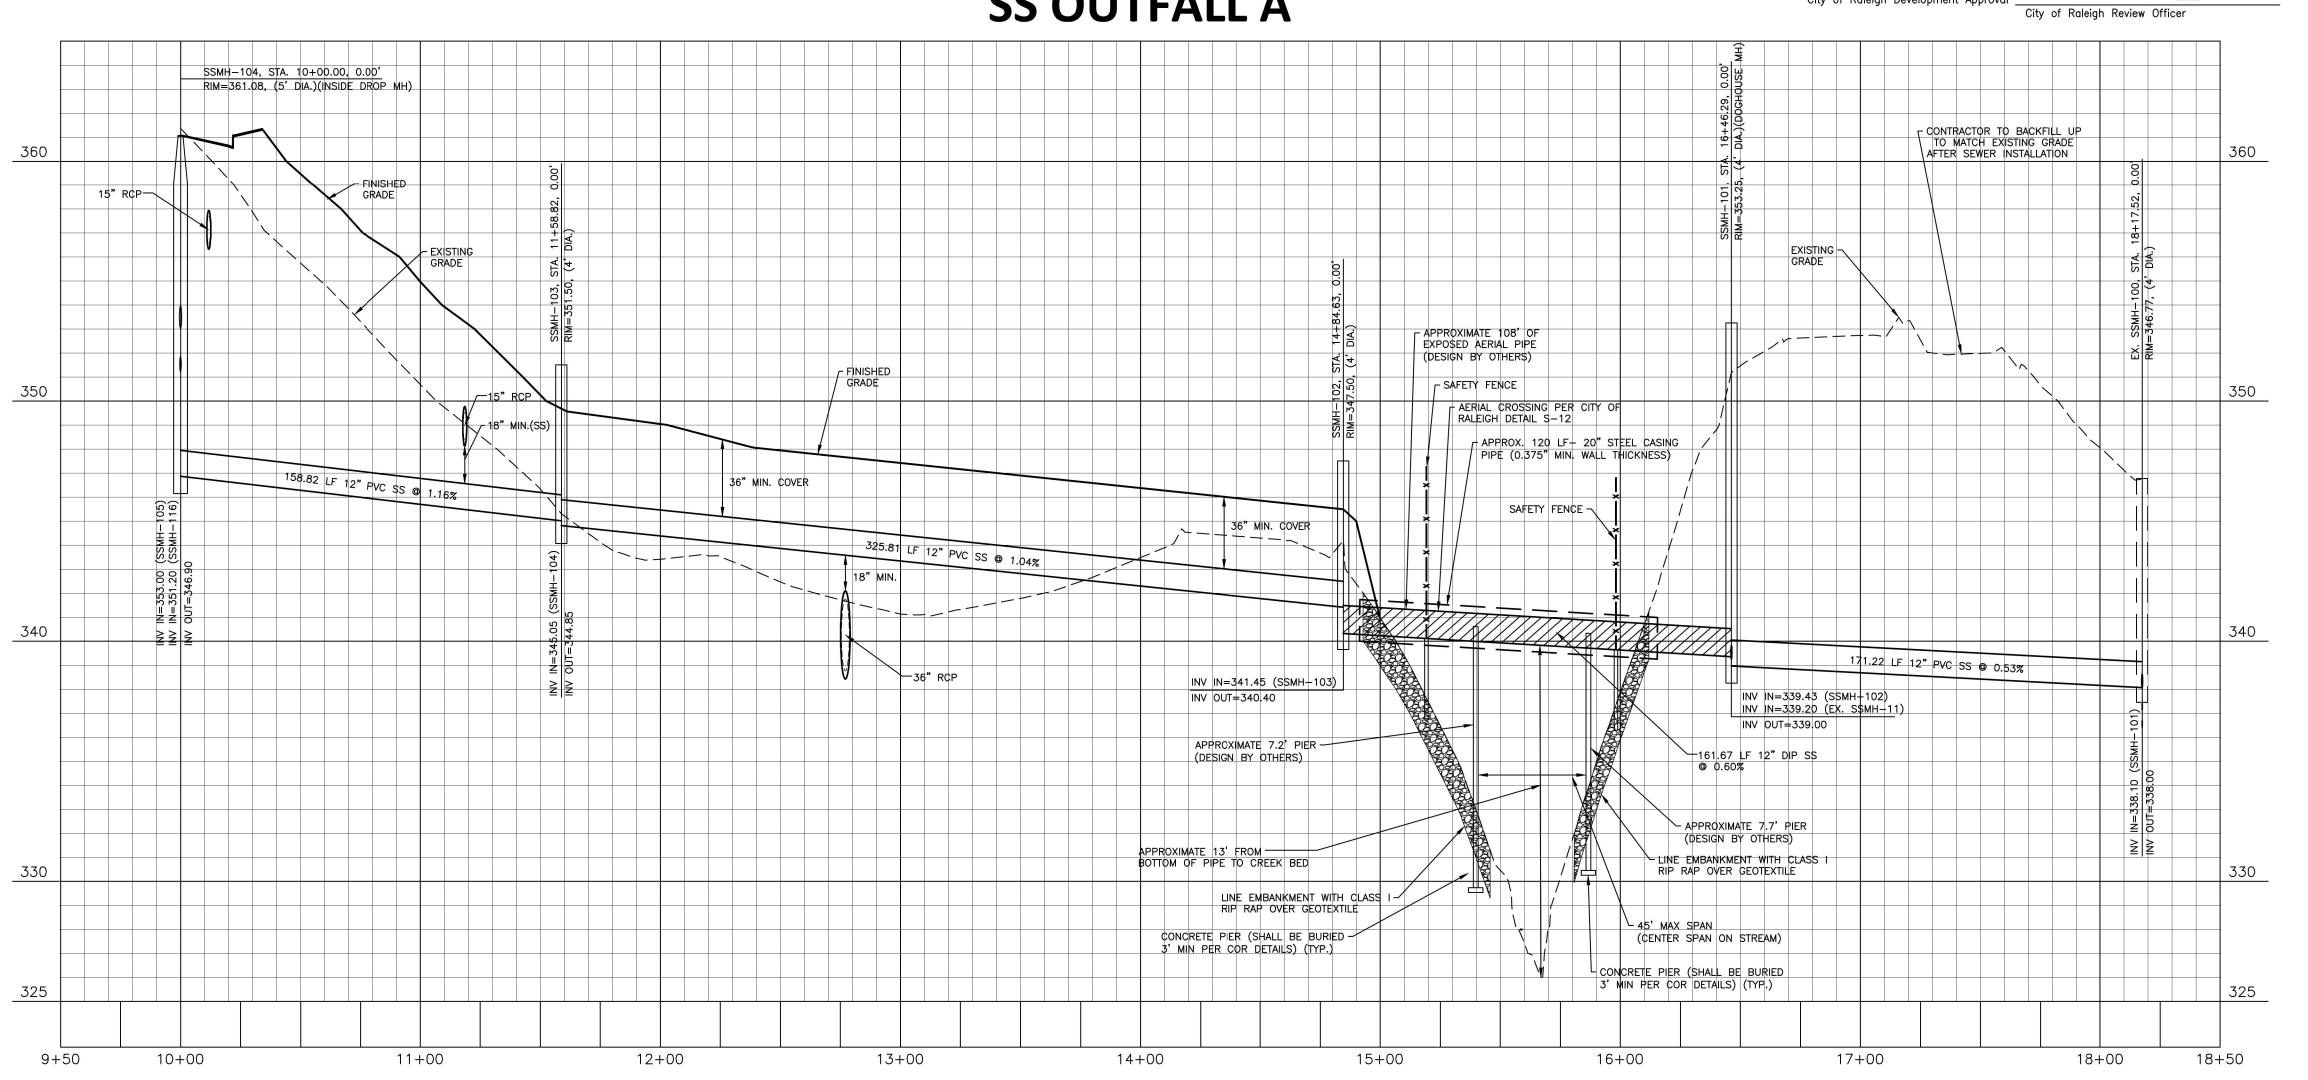
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**CLIENT** 

WALLBROOK LANDCO, LLC

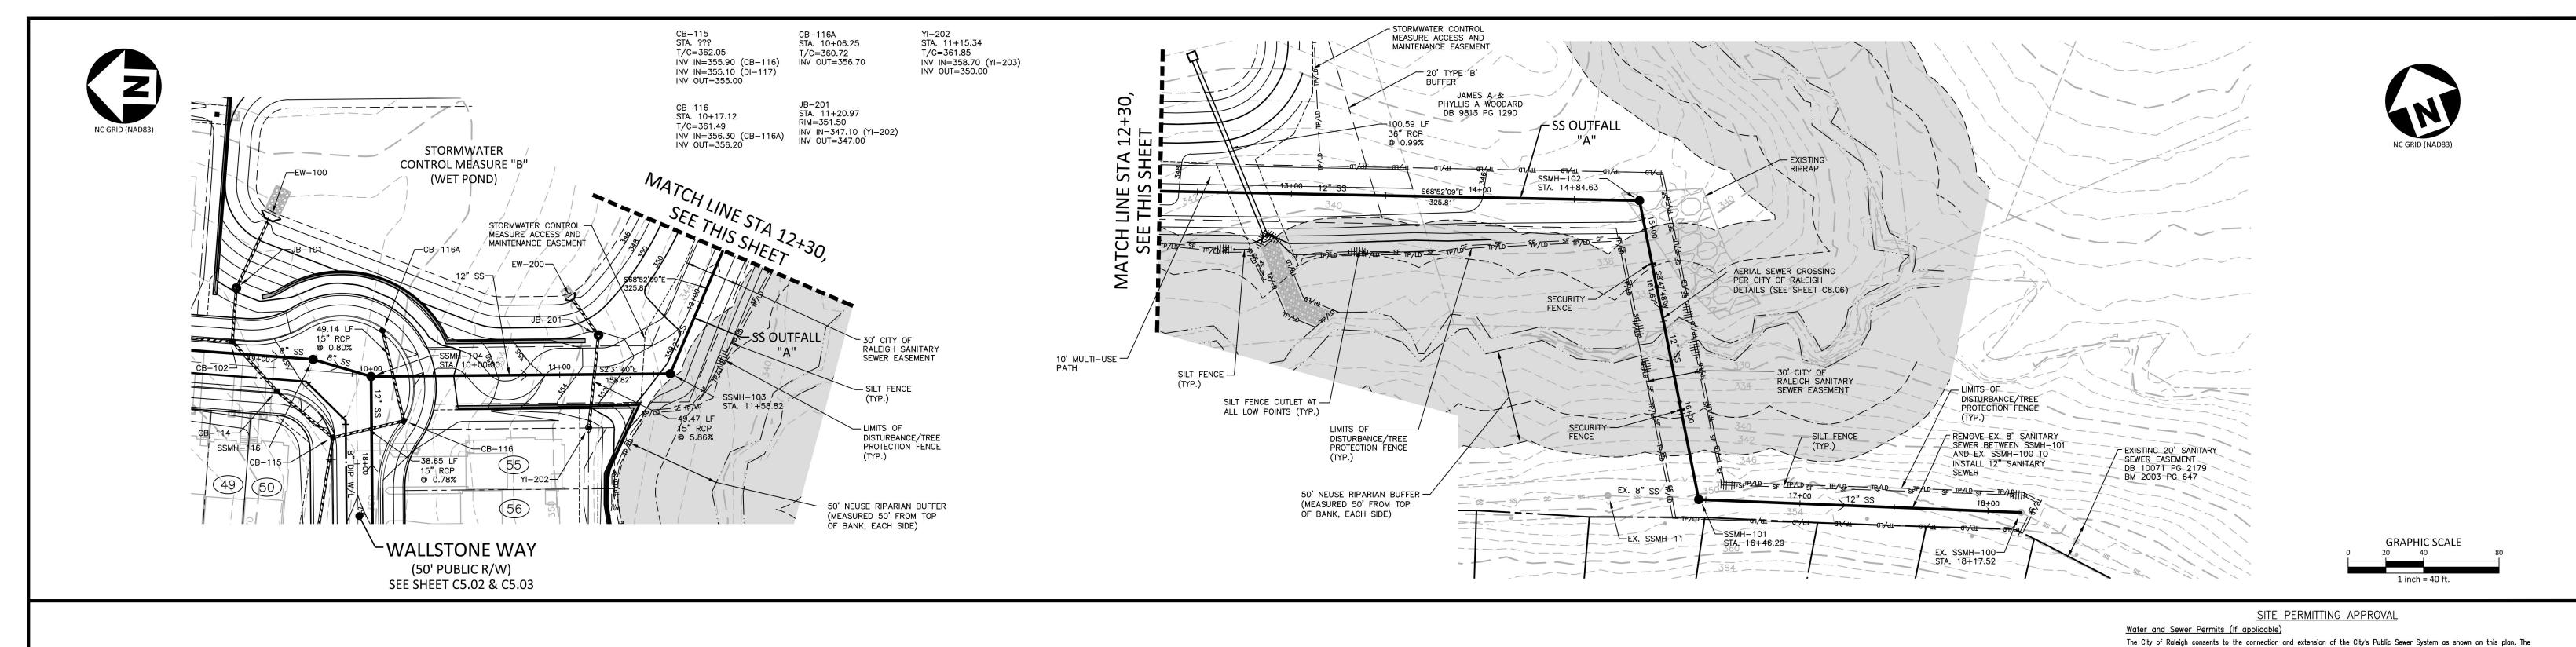**REVISIONS** NO. DATE

22630 Digitally signed by William T O'Daniel Date: 2023.05.23 14:33:28-04'00'

**WALLBROOK CONSTRUCTION DRAWINGS** ROLESVILLE, NORTH CAROLINA

PLAN INFORMATION

PROJECT NO. CPR-19100 CPR19100-CD-P2 **FILENAME** CHECKED BY DRAWN BY **SCALE** 1"=40'/1"=4' DATE 05. 22. 2023

PLAN AND PROFILE SS OUTFALL "A", STA. 9+50 THRU STA. 18+50

FINAL DRAWING - RELEASED FOR CONSTRUCTION

### **EROSION CONTROL NOTES**

- 1. ALL CONSTRUCTION SHALL CONFORM TO THE LATEST TOWN OF ROLESVILLE, WAKE COUNTY, AND NCDOT STANDARDS, SPECIFICATIONS AND DETAILS.
- 2. GRADING AND EROSION CONTROL METHODS SHALL ADHERE TO THE WAKE COUNTY SOIL AND EROSION CONTROL STANDARDS AND SPECIFICATIONS.
- 3. GRADING AND EROSION CONTROL METHODS SHALL ADHERE TO THE NORTH CAROLINA DEPARTMENT OF NATURAL RESOURCES DIVISION OF WATER QUALITY (DWQ) STANDARDS AND SPECIFICATIONS. WHERE DIFFERENT FROM WAKE COUNTY STANDARDS, THE MORE STRINGENT METHOD SHALL BE APPLIED.
- 4. FAILURE TO FOLLOW THE APPROVED PLAN SEQUENCE AND DETAILS COULD SUBJECT THE CONTRACTOR TO FINES AND PENALTIES ISSUED BY EITHER THE WAKE COUNTY EROSION CONTROL DEPARTMENT OR THE DWO.
- 5. FOR ANY LAND-DISTURBING ACTIVITY WHERE GRADING ACTIVITIES HAVE BEEN COMPLETED. TEMPORARY OR PERMANENT GROUND COVER SUFFICIENT TO RESTRAIN EROSION SHALL BE PROVIDED AS SOON AS PRACTICAL, BUT IN NO CASE LATER THAN SEVEN (7) DAYS AFTER COMPLETING THE WORK. STABILIZATION IS THE BEST FORM OF EROSION CONTROL. TEMPORARY SEEDING IS NECESSARY TO ACHIEVE EROSION CONTROL ON LARGE DENUDED AREAS AND ESPECIALLY WHEN SPECIFICALLY REQUIRED AS PART OF THE CONSTRUCTION SEQUENCE ON THE PLAN.
- 6. NO DEBRIS SHALL BE TRACKED ONTO PUBLIC RIGHT OF WAY. IF THE SITUATION OCCURS WHERE MUD, ROCK AND DEBRIS IS TRACKED ONTO PAVEMENT, THE CONTRACTOR SHALL CLEAN THE PAVEMENT AND INSTALL ADDITIONAL MEASURES TO PREVENT THE FUTURE OCCURRENCE
- 7. THE EROSION CONTROL INSPECTOR MAY REQUIRE ADDITIONAL FIELD MEASURES AS NECESSARY TO PROVIDE ADEQUATE PROTECTION FROM RECEIVING WATER COURSES.
- 8. EROSION AND SEDIMENT CONTROL DEVICES MUST BE INSTALLED AND INSPECTED PRIOR TO ANY GRADING ON SITE. THE CONTRACTOR SHALL CALL FOR AN INSPECTION BY WAKE COUNTY SEDIMENTATION AND EROSION CONTROL (SEC) ONCE INITIAL MEASURES ARE IN PLACE. (SEE CONSTRUCTION SEQUENCES)
- 9. CONTRACTOR SHALL INSPECT AND REPAIR ALL SEDIMENT/EROSION CONTROL DEVICES AT LEAST ONCE A WEEK AND AFTER EACH RAINFALL EVENT. GRADING ACTIVITY SHALL BE PROHIBITED IN THE AREAS OF THE SEDIMENT CONTROL DEVICES/SEDIMENT TRAPS UNTIL THE AREAS UPSTREAM OF THESE DEVICES HAVE BEEN STABILIZED AND APPROVED. ALL SKIMMER BASINS SHALL BE DE-SILTED AFTER THE END OF EVERY MAJOR RAIN EVENT.
- 10. A COPY OF THE APPROVED EROSION CONTROL PLAN MUST BE ON FILE AT THE JOB SITE AT ALL TIMES.
- 11. CONSTRUCTION, MAINTENANCE, AND REMOVAL OF ALL EROSION CONTROL DEVICES ARE THE RESPONSIBILITY OF THE GRADING CONTRACTOR UNLESS OTHERWISE NOTED.

RECOMMENDED BY THE GEOTECHNICAL ENGINEER.

- 12. ANY GRADING BEYOND THE DENUDED LIMITS SHOWN ON THE PLAN IS A VIOLATION OF THE TOWN/COUNTY EROSION CONTROL ORDINANCE AND IS SUBJECT TO A FINE
- 13. ADDITIONAL MEASURES TO CONTROL EROSION AND SEDIMENT MAY BE REQUIRED BY A REPRESENTATIVE OF THE TOWN/COUNTY ENGINEERING DEPARTMENT AND ARE THE RESPONSIBILITY OF THE CONTRACTOR.
- 14. PROTECTION OF EXISTING VEGETATION: AT THE START OF GRADING INVOLVING THE STRIPPING OF TOPSOIL OR LOWERING OF EXISTING GRADE AROUND A TREE, A CLEAN, SHARP, VERTICAL CUT SHALL BE MADE AT THE EDGE OF THE TREE SAVE AREA AT THE SAME TIME AS OTHER EROSION CONTROL MEASURES ARE INSTALLED. THE TREE PROTECTION FENCING SHALL BE INSTALLED ON THE SIDE OF THE CUT FARTHEST AWAY FROM THE TREE TRUNK AND SHALL REMAIN IN PLACE UNTIL ALL CONSTRUCTION IN THE VICINITY OF THE TREES IS COMPLETE. NO STORAGE OF MATERIALS, FILL, OR EQUIPMENT AND NO TRESPASSING SHALL BE ALLOWED WITHIN THE BOUNDARY OF THE PROTECTED AREA AND SHALL BE POSTED ON THE PROTECTION FENCE. A PROTECTION FENCE CONSTRUCTED OF MATERIAL RESISTANT TO DEGRADATION BY SUN. WIND. AND MOISTURE FOR THE DURATION OF THE CONSTRUCTION, SHALL BE INSTALLED AT THE SAME TIME AS THE EROSION CONTROL MEASURES AND SHALL BE IN PLACE UNTIL ALL CONSTRUCTION IN THE VICINITY OF THE TREES IS COMPLETE.
- 15. CONSTRUCTION SEQUENCES HAS BEEN PROVIDED. INSTALLATION OF ALL PROPOSED SEDIMENTATION & EROSION CONTROL MEASURES IN THE SEQUENCE(S) PROVIDED AND MAINTENANCE OF THOSE DEVICES IS REQUIRED. THE CONTRACTOR MAY BE ALLOWED, WITH PRIOR APPROVAL FROM THE OWNER, TO COORDINATE CHANGES TO THE PLAN WITH THE ON-SITE SEDIMENTATION & EROSION CONTROL INSPECTOR AND THE ENGINEER.
- 16. PROVIDE INLET PROTECTION AROUND ALL SITE STORM INLETS. PROTECT OPEN PIPES UNDER CONSTRUCTION WITH EITHER PLYWOOD OR WITH MESH AND GRAVEL WEIRS. RUNOFF SHALL NOT BE ALLOWED IN ANY OPEN TRENCH.
- 17. CONTRACTOR WILL FIELD LOCATE SILT FENCE OUTLETS AT LOW POINTS IN SILT FENCE AS REQUIRED TO PROVIDE RELIEF FROM CONCENTRATED FLOWS
- 18. TEMPORARY DIVERSIONS SHALL BE MAINTAINED DAILY BY CONTRACTOR SO THAT THEY ARE FUNCTIONAL AT THE END OF EACH WORKDAY AND WHEN STOPPING WORK FOR RAIN.
- 19. ALL DIMENSIONS AND GRADES SHOWN ON THE PLANS SHALL BE FIELD VERIFIED BY THE CONTRACTOR PRIOR TO CONSTRUCTION. CONTRACTOR SHALL NOTIFY THE OWNER AND ENGINEER IF ANY DISCREPANCIES EXIST PRIOR TO PROCEEDING WITH CONSTRUCTION FOR NECESSARY PLAN OR GRADE CHANGES. NO EXTRA COMPENSATION SHALL BE PAID TO THE CONTRACTOR FOR ANY WORK DONE DUE TO DIMENSIONS OR GRADES SHOWN INCORRECTLY ON THESE PLANS IF SUCH NOTIFICATION HAS NOT BEEN
- 20. DISTURBANCE OUTSIDE OF THE SITE PROPERTY LIMITS OR PUBLIC RIGHT-OF-WAY SHALL ONLY BE AS ALLOWED BY SIGNED GRADING AGREEMENTS AND/OR EASEMENTS BETWEEN THE DEVELOPER AND THE OFFSITE PROPERTY OWNER.
- 21. THE CONTRACTOR IS RESPONSIBLE TO MAINTAIN SAFE OPEN ACCESS TO ALL PROPERTIES ALONG ADJACENT PROPERTIES DURING CONSTRUCTION PERIOD FOR IMPROVEMENTS.
- 22. OCCUPATIONAL SAFETY AND HEALTH ADMINISTRATION (OSHA) STANDARDS FOR EXCAVATIONS FINAL RULE 29CFR PART 1926, SUBPART "P" APPLIES TO ALL EXCAVATIONS EXCEEDING FIVE (5) FEET IN DEPTH. EXCAVATION EXCEEDING TWENTY (20) FEET IN DEPTH REQUIRES THE DESIGN OF A TRENCH SAFETY SYSTEM BY A REGISTERED PROFESSIONAL ENGINEER, PROVIDED BY THE CONTRACTOR RESPONSIBLE FOR EXCAVATION.
- 23. EQUIPMENT AND PRODUCTS OTHER THAN THOSE SPECIFIED MAY BE USED PROVIDED APPROVAL HAS BEEN OBTAINED FROM THE OWNER IN WRITING PRIOR TO ORDERING OR INSTALLATION. THE CONTRACTOR SHALL WAIVE ANY CLAIM FOR ADDITIONAL COST RELATED TO THE SUBSTITUTION OF ALTERNATIVE EQUIPMENT.
- 24. EXISTING IMPROVEMENTS DAMAGED DURING CONSTRUCTION SHALL BE REPLACED/RESTORED TO THEIR ORIGINAL CONDITION OR TO THE SATISFACTION OF THE OWNER BY THE CONTRACTOR RESPONSIBLE FOR THE DAMAGE.
- 25. SOIL UNDER BUILDINGS AND PAVED AREAS SHALL BE COMPACTED TO STANDARD PROCTOR 98% MAXIMUM DRY DENSITY OR AS
- 26. THE CONTRACTOR SHALL NOTE THAT THE DRAWINGS MAY NOT SHOW EVERY OFFSET, TRANSITION, FITTING, ETC THAT MAY BE REQUIRED. THE CONTRACTOR SHALL INSTALL SUCH STANDARD APPURTENANCES AS REQUIRED TO CLOSELY FOLLOW THE GRADES AND ALIGNMENTS DEPICTED ON THE PLANS.
- 27. CONTRACTOR SHALL NOTIFY NC 811 AT 811 OR (1-800-632-4949) AT LEAST 3 FULL BUSINESS DAYS PRIOR TO BEGINNING CONSTRUCTION OR EXCAVATION TO HAVE EXISTING UTILITIES LOCATED. CONTRACTOR TO CONTACT ANY LOCAL UTILITIES THAT PROVIDE THEIR OWN LOCATOR SERVICES INDEPENDENT OF NC 811. REPORT ANY DISCREPANCIES TO THE ENGINEER IMMEDIATELY.
- 28. CONTRACTOR IS RESPONSIBLE FOR COORDINATING CONSTRUCTION ACTIVITIES WITH THE APPROPRIATE UTILITY COMPANIES FOR ANY REQUIRED RELOCATION (I.E., POWER POLES, TELEPHONE PEDESTALS, WATER METERS, ETC.).
- 29. EXISTING UTILITIES SHOWN ARE BASED ON FIELD SURVEYS AND THE BEST AVAILABLE RECORD DRAWINGS. THE CONTRACTOR SHALL VERIFY CONDITIONS PRIOR TO BEGINNING CONSTRUCTION. ANY DISCREPANCIES BETWEEN ACTUAL FIELD CONDITIONS AND THE PLANS SHALL BE REPORTED TO THE ENGINEER IMMEDIATELY.
- 30. PRIOR TO STARTING CONSTRUCTION, THE GENERAL CONTRACTOR SHALL HOLD A PRE-CONSTRUCTION CONFERENCE WITH THE GRADING CONTRACTOR, ENGINEER, CONSTRUCTION INSPECTOR & OWNER.

# **EROSION CONTROL MAINTENANCE PLAN**

- ALL EROSION AND SEDIMENT CONTROL MEASURES SHALL BE CHECKED BY THE SITE CONTRACTOR FOR STABILITY AND OPERATION FOLLOWING EVERY RUNOFF-PRODUCING RAINFALL BUT IN NO CASE LESS THAN ONCE EVERY WEEK. ANY NEEDED REPAIRS SHALL BE MADE IMMEDIATELY TO MAINTAIN ALL MEASURES AS DESIGNED
- THE SEDIMENT BASINS SHALL BE INSPECTED REGULARLY DURING LAND DISTURBING ACTIVITIES AND AFTER EACH RUNOFF-PRODUCING RAINFALL. SEDIMENT SHALL BE REMOVED AND THE BASIN RESTORED TO ITS ORIGINAL DIMENSIONS WHEN SEDIMENT HAS ACCUMULATED TO ONE-HALF THE DESIGN DEPTH OF EACH BASIN. PORTIONS OF THE BASIN'S GRAVEL FACING THAT ARE CONTAMINATED BY SEDIMENT SHALL BE REPLACED WITH FRESH GRAVEL DURING EACH SEDIMENT REMOVAL EPISODE
- SEDIMENT FENCES SHALL BE INSPECTED AT LEAST ONCE A WEEK AND AFTER EACH RAINFALL. REPAIRS SHALL BE MADE MMEDIATELY. SEDIMENT DEPOSITS SHALL BE REMOVED AS NEEDED TO PROVIDE ADEQUATE STORAGE VOLUME FOR THE NEXT RAINFALL EVENT, AND TO REDUCE PRESSURE ON THE FENCE. FENCING MATERIALS AND SEDIMENT DEPOSITS SHALL BE REMOVED, AND THE AREA BROUGHT TO GRADE FOLLOWING STABILIZATION OF UPGRADE DISTURBED AREAS.
- DIVERSION DITCHES MUST REMAIN IN PLACE UNTIL THE AREA CONVEYED BY THE DIVERSION DITCH IS STABILIZED. PERMISSION FOR REMOVAL SHALL BE GIVEN B THE EROSION CONTROL INSPECTOR.

### STAGE 1 SPECIFIC CONSTRUCTION SEQUENCE

- OBTAIN A LAND DISTURBING PERMIT FROM WAKE COUNTY AND SCHEDULE A PRE-CONSTRUCTION CONFERENCE WITH A WAKE
- COUNTY ENVIRONMENTAL CONSULTANT (JEEVAN NEUPANE AT 919-819-8907)
- INSTALL TREE PROTECTION FENCING AND TEMPORARY CONSTRUCTION ENTRANCES ACCORDING TO THE EROSION CONTROL PLAN. INSTALL TEMPORARY STREAM CHANNEL CROSSING WITH TIMBER MAT OR LOG MAT BOARDS BUTTED TOGETHER ON BOTH CROSSINGS. INSTALL SIDE BOARDS TO PREVENT SEDIMENT OVER EDGES AND UNDERLAY BOARDS WITH GEOTEXTILE MATTING TO
- 4. DURING EXTENDED DRY WEATHER CONDITIONS, CONSTRUCT CREEK DIVERSION CHANNELS FOR THE PERMANENT STREAM
- 4.1. EXCAVATE THE DIVERSION CHANNEL WITHOUT DISTURBING THE EXISTING CHANNEL
- 4.2. PLACE IMPERVIOUS MAT LINER IN DIVERSION CHANNEL.

PREVENT SEDIMENT FROM DRAINING BETWEEN LOG BOARDS.

- CONNECT THE DOWNSTREAM DIVERSION CHANNEL INTO THE DOWNSTREAM EXISTING CHANNEL AND SECURE THE IMPERVIOUS MAT LINER AT THE CONNECTION. INSTALL VELOCITY DISSIPATOR OVER THE IMPERVIOUS MATTING
- 4.4. CONNECT THE UPSTREAM DIVERSION CHANNEL INTO THE UPSTREAM EXISTING CHANNEL AND SECURE THE IMPERVIOUS MAT
- 4.5. CONSTRUCT A COFFER DAM IN THE EXISTING CHANNEL AT THE UPSTREAM SIDE TO DIVERT FLOW INTO THE DIVERSION
- 4.6. CONSTRUCT A COFFER DAM IN THE EXISTING CHANNEL AT THE DOWNSTREAM SIDE TO ISOLATE THE WORK AREA.
- 4.7. INSTALL PUMP AND SILT BAG TO DE-WATER WORK AREA PRIOR TO INSTALLATION OF PERMANENT CULVERT PIPE AND HEADWALLS AS SHOWN ON SHEET C6.02.
- 5. INSTALL SEDIMENT BASINS AND RUNOFF CONVEYANCE ON ALL FOUR CORNERS OF THE CROSSING.
- INSTALL SILT FENCING. AND SILT FENCE OUTLETS AS SHOWN ON APPROVED STAGE 1 EROSION CONTROL PLANS. GRADE ONLY AS NECESSARY TO INSTALL THESE DEVICES. INSTALL SILT FENCE OUTLETS AT LOW POINTS IN THE SILT FENCING AS NEEDED TO PREVENT BLOWOUTS. INSTALL SILT FENCE ALONG STREAM BANKS AT THE END OF THE WORK DAY TO MINIMIZE IMPACTS.
- INSTALL DIVERSION DITCHES AND SKIMMER BASINS AS SHOWN ON APPROVED STAGE 1 EROSION CONTROL PLAN. CLEAR ONLY AS NECESSARY TO INSTALL THESE DEVICES.
- STABILIZE ALL DISTURBED AREAS, INCLUDING DIVERSION DITCHES AND SKIMMER BASINS, IMMEDIATELY UPON INSTALLATION. SEE DETAIL ON SEEDING SCHEDULE. TEMPORARILY SEED AND MULCH ANY DISTURBED AREAS IN A TIMEFRAME COMPLIANT WITH NPDES STABILIZATION GUIDELINES
- SEDIMENT BASINS "SB-A" AND "SB-B" ARE UTILIZING THE PROPOSED STORMWATER PONDS AS TEMPORARY RISER BASINS. THE PERMANENT OPENINGS IN THE RISERS MUST BE PLUGGED DURING THE EROSION CONTROL STAGES. SEE THE CONSTRUCTION DETAILS ON THE "SW" SHEETS FOR INFORMATION TO INSTALL BERM AND SLOPES FOR THE SKIMMER SEDIMENT BASINS SEDIMENT BASINS "SB-A" AND "SB-B" MUST INCLUDE STORM DRAINAGE OUTFALLS AND VELOCITY DISSIPATORS AS SHOWN ON THE "C9.A1-C9.A4" AND "C9.B1-C9.B4" SHEETS AS THEY ARE INSTALLED.
- MAINTAIN EROSION CONTROL DEVICES WEEKLY, AND FOLLOWING EVERY RAIN EVENT. MONITOR EROSION CONTROL USING THE STANDARD NPDES REPORT AFTER EVERY RAIN FALL. REPORTS SHALL BE STORED ON SITE IN THE EVENT THE DEPARTMENT OF WATER QUALITY PERFORMS AN ON-SITE INSPECTION.
- STABILIZE GRADED AREAS AS THEY ARE CLEARED, PER THE NPDES GROUND STABILIZATION TIMELINE. ONCE FINAL GRADE HAS BEEN ACHIEVED. PAVE OR PERMANENTLY SEED ALL AREAS AND SLOPES PER NC DEO'S EROSION SEDIMENT CONTROL PLANNING AND DESIGN MANUAL CURRENT VERSION, SECTION 6.10 AND 6.11.
- 12. CALL THE WAKE COUNTY ENVIRONMENTAL CONSULTANT (JEEVAN NEUPANE AT 919-819-8907) FOR AN ON-SITE INSPECTION AND OBTAIN A CERTIFICATE OF COMPLIANCE. ONCE APPROVED, CONTINUE TO THE STAGE 2 SPECIFIC CONSTRUCTION SEQUENCE.

### STAGE 2 SPECIFIC CONSTRUCTION SEQUENCE

- 1. CLEAR AND GRUB REMAINDER OF SITE AND BEGIN EARTHWORK ACTIVITY FOLLOWING STAGE 2 EROSION CONTROL PLANS.
- 2. AS THE SITE IS BROUGHT UP TO GRADE. THE CONTRACTOR SHALL RAISE AND/OR RELOCATE ALL DIVERSION DITCHES TO MAINTAIN A POSITIVE SEDIMENT LADEN FLOW TO ALL SEDIMENT BASINS. SIMILARLY, SEDIMENT BASIN EMBANKMENTS SHALL BE RAISED WITH GRADING ACTIVITIES IF/AND WHEN NECESSARY
- 3. INSTALL STORM COLLECTION SYSTEM WITH INLET PROTECTION ON ALL STRUCTURES ACCEPTING FLOW, BEGINNING WITH MAIN TRUNK LINES THAT CONVEY RUNOFF TO THE SEDIMENT BASINS.
- 4. INSTALL APPROVED IN FT PROTECTION AS IN FTS ARE INSTALLED. TEMPORARY FROSION CONTROL MEASURES ARE TO REMAIN UNTIL SUCH MEASURES HAVE BEEN APPROVED FOR REMOVAL BY THE ENVIRONMENTAL CONSULTANT (JEEVAN NEUPANE AT 919-819-8907) AND EROSION CONTROL INSPECTOR. ADDITIONAL MEASURES MAY BE REQUIRED BY THE INSPECTOR DEPENDING ON FIELD CONDITIONS
- MAINTAIN EROSION CONTROL MEASURES WEEKLY AND AFTER EACH RAIN EVENT THROUGHOUT CONSTRUCTION. MONITOR EROSION CONTROL USING THE STANDARD NPDES REPORT AFTER EVERY RAIN FALL. REPORTS SHALL BE STORED ON SITE IN THE EVENT THE DEPARTMENT OF WATER QUALITY PERFORMS AN ON-SITE INSPECTION.
- STABILIZE GRADED AREAS AS THEY ARE CLEARED, PER THE NPDES GROUND STABILIZATION TIMELINE. ONCE FINAL GRADE HAS BEEN ACHIEVED. PAVE OR PERMANENTLY SEED ALL AREAS AND SLOPES PER NC DEO'S EROSION SEDIMENT CONTROL PLANNING AND DESIGN MANUAL CURRENT VERSION, SECTION 6.10 AND 6.11

NPDES Stormwater Discharge Permit for Construction Activities (NCGO1)

7. CALL THE WAKE COUNTY ENVIRONMENTAL CONSULTANT (JEEVAN NEUPANE AT 919-819-8907) FOR AN ON-SITE INSPECTION AND OBTAIN A CERTIFICATE OF COMPLIANCE. ONCE APPROVED, CONTINUE TO THE STAGE 3 SPECIFIC CONSTRUCTION SEQUENCE.

# STAGE 3 SPECIFIC CONSTRUCTION SEQUENCE

- CONTINUE EARTHWORK ACTIVITY AND MAINTAIN INLET PROTECTION ON ALL STRUCTURE ACCEPTING FLOW, AS SITE IS BROUGHT UP TO FINAL GRADE.
- TEMPORARY EROSION CONTROL MEASURES ARE TO REMAIN UNTIL SUCH MEASURES HAVE BEEN APPROVED FOR REMOVAL BY THE ENVIRONMENTAL CONSULTANT (JEEVAN NEUPANE AT 919-819-8907) AND EROSION CONTROL INSPECTOR. ADDITIONAL MEASURES MAY BE REQUIRED BY THE INSPECTOR DEPENDING ON FIELD CONDITIONS.
- MAINTAIN FROSION CONTROL MEASURES WEEKLY AND AFTER EACH RAIN EVENT THROUGHOUT CONSTRUCTION. MONITOR EROSION CONTROL USING THE STANDARD NPDES REPORT AFTER EVERY RAIN FALL. REPORTS SHALL BE STORED ON SITE IN THE EVENT THE DEPARTMENT OF WATER QUALITY PERFORMS AN ON-SITE INSPECTION.
- 4. STABILIZE GRADED AREAS AS THEY ARE BROUGHT TO FINAL GRADE, PER THE NPDES GROUND STABILIZATION TIMELINE. ONCE FINAL GRADE HAS BEEN ACHIEVED, PERMANENTLY SEED ALL AREAS AND SLOPES PER NCDENR'S EROSION SEDIMENT CONTROL PLANNING AND DESIGN MANUAL VERSION 5/13, CHAPTER 6.ii.6.10 AND 6.ii.6.11. SEE THIS SHEETS FOR SEEDING SPECIFICATIONS.
- UPON APPROVAL OF PERMANENT STABILIZATION, REMOVE BALANCE OF EROSION CONTROL MEASURES, AND CONVERT SB-A AND SB-B TO PERMANENT STORMWATER MANAGEMENT FACILITIES. REFER TO "C9.A1 - C9.A4 AND C9.B1 - C9.B4" SHEETS FOR

### STOCKPILING NOTES

THE TEMPORARY STOCKPILING OF MATERIALS IS PERMITTED SUBJECT TO THE FOLLOWING STANDARDS:

- 1. THE STOCKPILED MATERIAL SHALL NOT EXCEED 25 FEET IN HEIGHT ABOVE THE ORIGINAL NATURAL GRADE
- 2. THE FOOTPRINT OF THE STOCKPILING AREA SHALL BE LOCATED AT LEAST 25 FEET FROM ADJOINING PROPERTY LINES.
- 3. THE SIDE SLOPE OF THE STOCKPILED MATERIALS SHALL NOT EXCEED A 3:1 RATIO
- 4. STOCKPILED MATERIALS SHALL BE LIMITED TO DIRT, FILL, AND/OR GRAVEL.
- 5. STOCKPILED MATERIALS SHALL BE SEEDED OR COVERED WITH TARPS OR MULCH. TARPS SHALL BE KEYED IN AT THE TOP OF THE SLOPE TO KEEP WATER FROM RUNNING UNDERNEATH THE PLASTIC.
- 6. ANY CONCENTRATED FLOW LIKELY TO AFFECT THE STOCKPILE SHALL BE DIVERTED TO AN APPROVED BMP.
- 7. IF A STOCKPILE IS TO REMAIN FOR FUTURE USE AFTER THE PROJECT IS COMPLETE (BUILDERS, ETC.), THE FINANCIAL RESPONSIBLE PARTY MUST NOTIFY WAKE COUNTY OF A NEW RESPONSIBLE PARTY FOR THAT STOCKPILE.
- 8. THE APPROVED PLAN SHALL PROVIDE FOR THE USE OF STAGED SEEDING AND MULCHING ON A CONTINUAL BASIS WHILE THE STOCKPILE IS IN USE. 9. ESTABLISH AND MAINTAIN A VEGETATIVE BUFFER AT THE TOE OF THE SLOPE (WHERE PRACTICAL)

## REQUIRED WAKE COUNTY BASIN REMOVAL SEQUENCE

WAKE COUNTY OR JURISDICTIONAL MUNICIPALITY MUST GRANT PERMISSION TO CONVERT SEDIMENT BASINS OVER TO STORMWATER USE PRIOR TO COMPLETING ANY RELATED WORK. 1. SCHEDULE A SITE MEETING WITH THE ENVIRONMENTAL CONSULTANT TO DETERMINE IF A BASIN CAN BE REMOVED. INSTALL SILT FENCING OR OTHER TEMPORARY EROSION CONTROL MEASURES AS NEEDED PRIOR TO REMOVAL OF THE BASIN

- 2. REMOVE BASIN(S) AND ASSOCIATED TEMPORARY DIVERSION DITCHES. IF CULVERT PIPES NEED TO BE EXTENDED, PERFORM THIS OPERATION AT THIS TIME, FINE GRADE AREA IN PREPARATION FOR SEEDING.
- 3. PERFORM SEEDBED PREPARATION, SEED, MULCH AND ASPHALT TACK ANY RESULTING BARE AREAS IMMEDIATELY.
- 4. INSTALL VELOCITY DISSIPATORS AND/OR LEVEL SPREADERS AS REQUIRED ON THE EROSION CONTROL PLAN.
- WHEN SITE IS FULLY STABILIZED. CALL ENVIRONMENTAL CONSULTANT FOR APPROVAL OF REMOVING REMAINING TEMPORARY EROSION CONTROL MEASURES AND ADVICE ON WHEN SITE CAN BE ISSUED A CERTIFICATE OF COMPLETION. NOTE: A MEETING SHOULD ALSO BE SCHEDULED WITH THE ENVIRONMENTAL CONSULTANT TO DETERMINE WHEN A BASIN MAY BE CONVERTED FOR STORMWATER USE. SOME MUNICIPALITIES MAY ALSO

### TEMPORARY AND PERMANENT SEEDING NOTES

- I. TEMPORARY SEEDING: MUST PLANT OR OTHERWISE PROVIDE A TEMPORARY COVER SUFFICIENT TO RESTRAIN EROSION AFTER ANY GRADED AREA REMAINS UNDISTURBED, AS ILLUSTRATED ON THE NPDES GROUND STABILIZATION TABLE THIS SHEET.
- PERMANENT SEEDING: MUST PLANT OR OTHERWISE PROVIDE A PERMANENT GROUND COVER SUFFICIENT TO RESTRAIN EROSION UPON COMPLETION OF CONSTRUCTION OR DEVELOPMENT IN A TIMEFRAME COMPLIANT WITH THE NPDES GROUND STABILIZATION GUIDELINES.

## SEEDBED PREPARATION

- 1. CHISEL COMPACTED AREAS AND SPREAD TOPSOIL THREE INCHES DEEP OVER ADVERSE SOIL CONDITIONS, IF AVAILABLE.
- 2. RIP THE ENTIRE AREA TO SIX INCHES DEEP.
- 3. REMOVE ALL LOOSE ROCK, ROOTS AND OTHER OBSTRUCTIONS, LEAVING SURFACE REASONABLY SMOOTH AND UNIFORM.
- 4. APPLY AGRICULTURAL LIME, FERTILIZER AND SUPERPHOSPHATE UNIFORMLY AND MIX WITH SOIL.
- 5. CONTINUE TILLAGE UNTIL A WELL-PULVERIZED, FIRM, REASONABLY UNIFORM SEEDBED IS PREPARED FOUR TO SIX INCHES DEEP.
- SEED ON A FRESHLY PREPARED SEEDBED AND COVER SEED LIGHTLY WITH SEEDING EQUIPMENT OR CULTIPACK AFTER SEEDING.
- 7. MULCH IMMEDIATELY AFTER SEEDING AND ANCHOR MULCH.
- 8 INSPECT ALL SEEDED AREAS AND MAKE NECESSARY REPAIRS OR RESEEDINGS WITHIN THE PLANTING SEASON, IE POSSIBLE, IE STAND SHOULD BE MORE THAN 60% DAMAGED, RE-ESTABLISH FOLLOWING THE ORIGINAL LIME, FERTILIZER AND SEEDING RATES.
- 9. CONSULT S&EC ENVIRONMENTAL CONSULTANTS ON MAINTENANCE TREATMENT AND FERTILIZATION AFTER PERMANENT COVER

NCDENR/Division of Energy, Mineral and Land Resources

STABILIZATION TIMEFRAMES (Effective Aug. 3, 2011)							
	SITE AREA DESCRIPTION	STABILIZATION	TIMEFRAME EXCEPTIONS				
	Perimeter dikes, swales, ditches, slopes	7 days	None				
	High Quality Water (HQW) Zones	7 days	None				
	Slopes steeper than 3:1	7 days	If slopes are 10' or less in length and are not steeper than 2:1, 14 days are allowed.				
	Slopes 3:1 or flatter	14 days	7 days for slopes greater than 50' in length.				
	All other areas with slopes flatter than 4:1	14 days	None, except for perimeters and HQW Zones.				



TEMPORARY DIVERSION DITCH SUMMARY DESIGN TABLE						
TEMPORARY DIVERSION ID	TD-1	TD-2	TD-3			
MINIMUM DEPTH (FT)	0.89	0.84	1.32			
MINIMUM BOTTOM WIDTH (FT)	0.00	0.00	0.00			
CALCULATED VELOCITY	2.86	3.42	4.29			
ALLOWABLE VELOCITY (W/O LINER)	5.00	8.00	6.00			
CALCULATED SHEAR STRESS	1.38	1.76	1.66			
ALLOWABLE SHEAR STRESS	1.55	2.00	1.75			
TEMPORARY LINER SPECIFICATION*	ERONET DS75	ERONET SC150	ERONET DS150			

\* ALL SPECIFICATIONS ARE NORTH AMERICAN GREEN ROLLMAX PRODUCTS OR EQUAL

CONTRACTOR SHALL NOTIFY "NC811" (811) OR (1-800-632-4949) AT LEAST 3 FULL BUSINESS DAYS PRIOR TO BEGINNING CONSTRUCTION OR EXCAVATION TO HAVE EXISTING UTILITIES LOCATED. CONTRACTOR SHALL CONTACT ANY LOCAL UTILITIES THAT PROVIDE THEIR OWN LOCATOR SERVICES INDEPENDENT OF "NC811".

Drainage Area (AC.) 4.79 7.20 10.82 11.42 Disturbed Area (AC.) 4.79 7.20 10.82 11.42 Flow Q25 (CFS) 23.80 35.00 50.70 55.70 344.00 Bottom Elevation (FT) 370.00 370.00 344.00 3.00 3.50 3.50 Sediment Depth (FT) 3.00 Freeboard (from 2.00 2.50 2.50 Sediment Depth) Depth to Crest of Riser 3.50 3.50 Depth to Crest of N/A Emergency Spillway (FT) Side Slopes 3.0H:1V 3.0H:1V 3.0H:1V 3.0H:1V Spillway Length (FT) 5X5 RISER 5X5 RISER 6X6 RISER 6X6 RISER Height of Berm (FT) 6.0 @ 350.00 5.0 @ 375.00 | 5.0 @ 375.00 6.0 @ 350.00 Top of Basin Length 236 236 259 259 Top of Basin Width (FT) 116 116 134 134 8,622 12,960 19,476 20,556 Required (FT<sup>3</sup>) Storage Volume Prov'd. 61,260 61,260 88,680 88,680 Sediment Surface Area 9,030 13,260 19,170 21,120 Req'd (FT<sup>2</sup>) Sediment Surface Area 23,270 23,270 29,010 29,010 Prov'd (FT<sup>2</sup>) Number of Skimmers 2.0 2.5 3.0 3.0 Skimmer Size (IN) Skimmer Orifice Size 2.4 2.5 SEE SEE SEE SEE "C9.A1-9A4" Anti-Flotation Block C9.A1-9A4 "C9.B1-B4 "C9.B1-B4" SHEETS SHEETS SHEETS SHEETS SFF SFF SFF Riser Diameter (IN) C9.A1-9A4 "C9.A1-9A4" "C9.B1-B4" "C9.B1-B4" SHEETS SHEETS SHEETS SHEETS Barrel Diameter (IN) "C9.A1-9A4" "C9.A1-9A4" "C9.B1-B4" "C9.B1-B4" SHEETS SHEETS SHEETS SHEETS . Side slopes pertain only for the vertical height from the base to the top

SEDIMENT BASIN SUMMARY DESIGN TABLE

(STAGE 3)

(STAGE 1

SEDIMENT BASIN ID

of berm, 2H:1V above that.

2. See details on silt fence baffle

3. Irregular shape — see plan

SB-B

(STAGE 3)

(STAGE 1

TEMPORARY DIVERSION DITCH SUMMARY DESIGN TABLE						
TEMPORARY DIVERSION ID	TD-1	TD-2	TD-3			
MINIMUM DEPTH (FT)	0.89	0.84	1.32			
MINIMUM BOTTOM WIDTH (FT)	0.00	0.00	0.00			
CALCULATED VELOCITY	2.86	3.42	4.29			
ALLOWABLE VELOCITY (W/O LINER)	5.00	8.00	6.00			
CALCULATED SHEAR STRESS	1.38	1.76	1.66			
ALLOWABLE SHEAR STRESS	1.55	2.00	1.75			
TEMPORARY LINER SPECIFICATION*	ERONET DS75	ERONET SC150	ERONET DS150			

REPORT ANY DISCREPANCIES TO THE ENGINEER IMMEDIATELY.

03. 31. 2023 **EROSION CONTROL** 

CPR19100-CD-EC-N1

**REVISIONS** 

PLAN INFORMATION

PROJECT NO. CPR-19100

NO. DATE

**FILENAME** 

CHECKED BY

DRAWN BY

**SCALE** 

SHEET

cn=William T O'Daniel, c=US

2023.03.31 13:14:04 -04'00'

621 Hillsborough Street

Suite 500

Raleigh, NC 27603

phone 919. 361. 5000

fax 919. 361. 2269

license number: C-0293, C-187

www.mcadamsco.com


WRIGHTSVILLE BEACH, NORTH CAROLINA

WALLBROOK LANDCO, LLC

3 KEEL STREET, SUITE 2

28480-1709

FINAL DRAWING - RELEASED FOR CONSTRUCTION

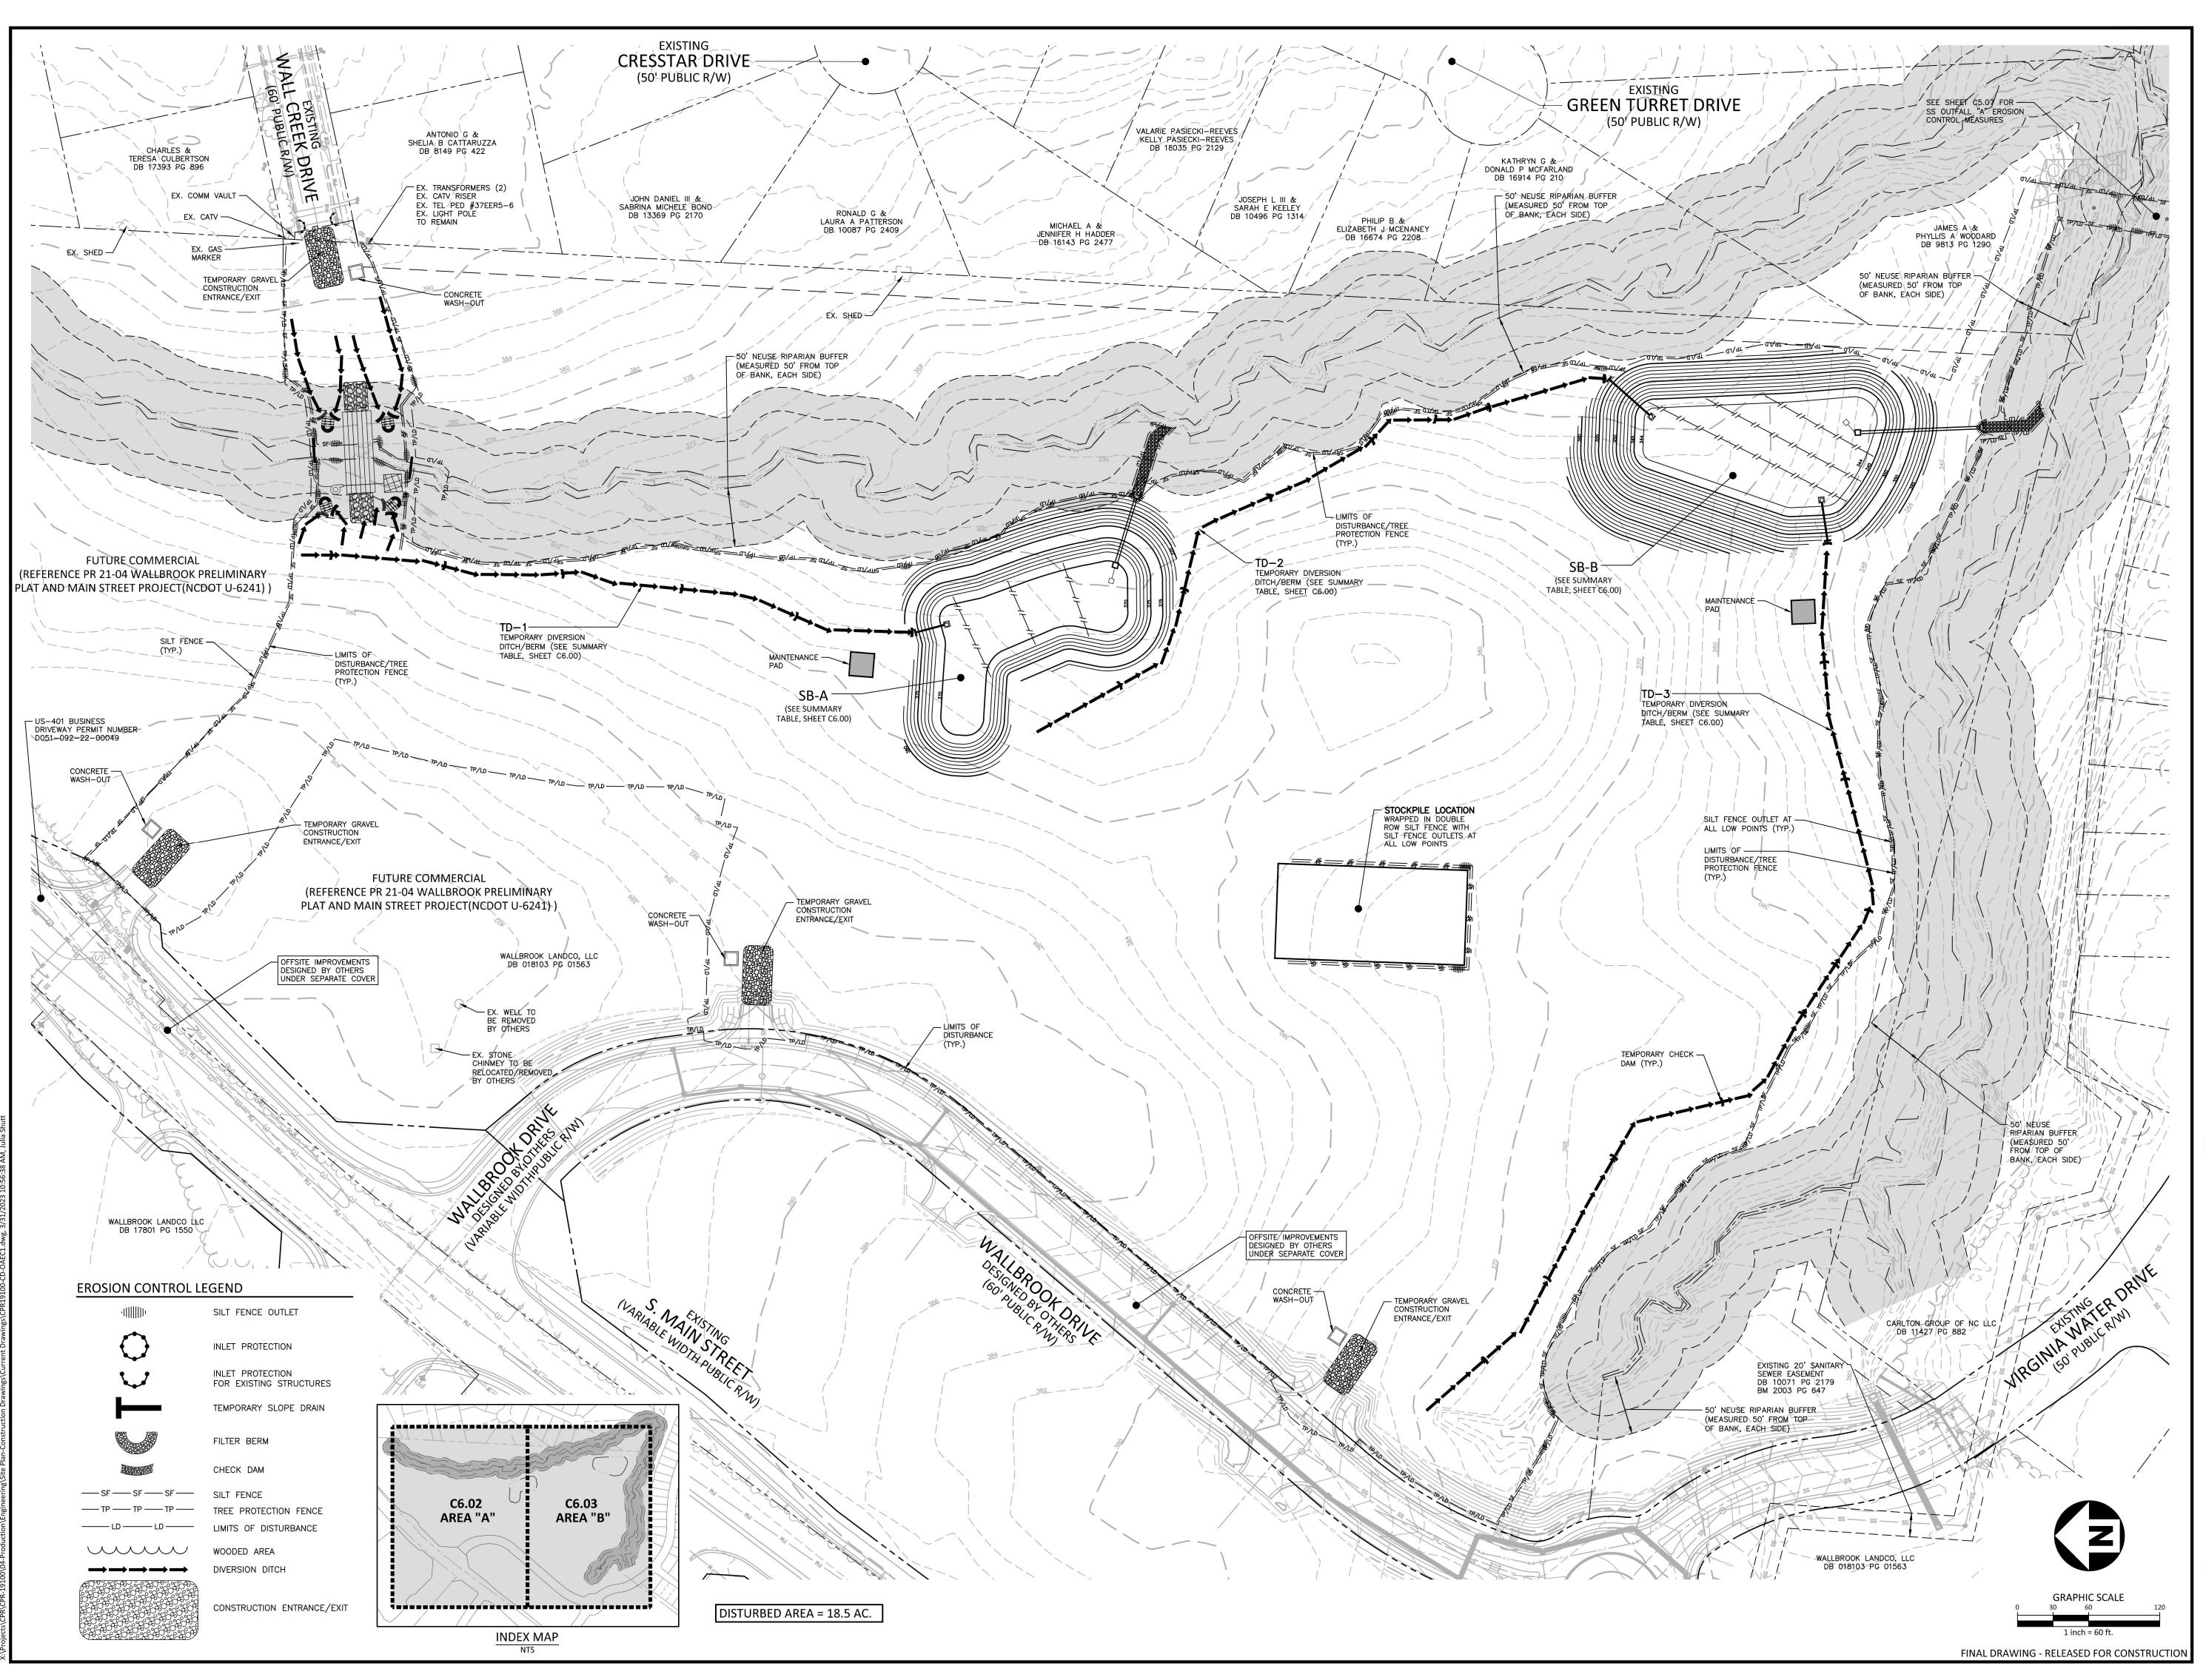



# McAdam


The John R. McAdams Company, Inc. 621 Hillsborough Street Suite 500 Raleigh, NC 27603

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WALLBROOK LANDCO, LLC 3 KEEL STREET, SUITE 2 WRIGHTSVILLE BEACH, NORTH CAROLINA 28480-1709

# WALLBROOK ONSTRUCTION DRAWINGS ROLESVILLE, NORTH CAROLINA



# **REVISIONS**

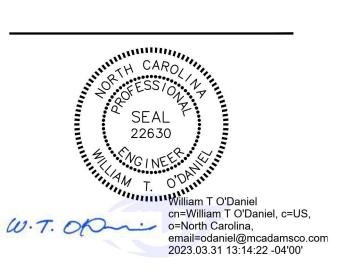DATE

# **PLAN INFORMATION**

PROJECT NO. CPR-19100

FILENAME CPR19100-CD-OAEC1


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DRAWN BY JMS

SCALE 1"=60'
DATE 03. 31. 2023

SHEET

OVERALL EROSION CONTROL PLAN - STAGE 1



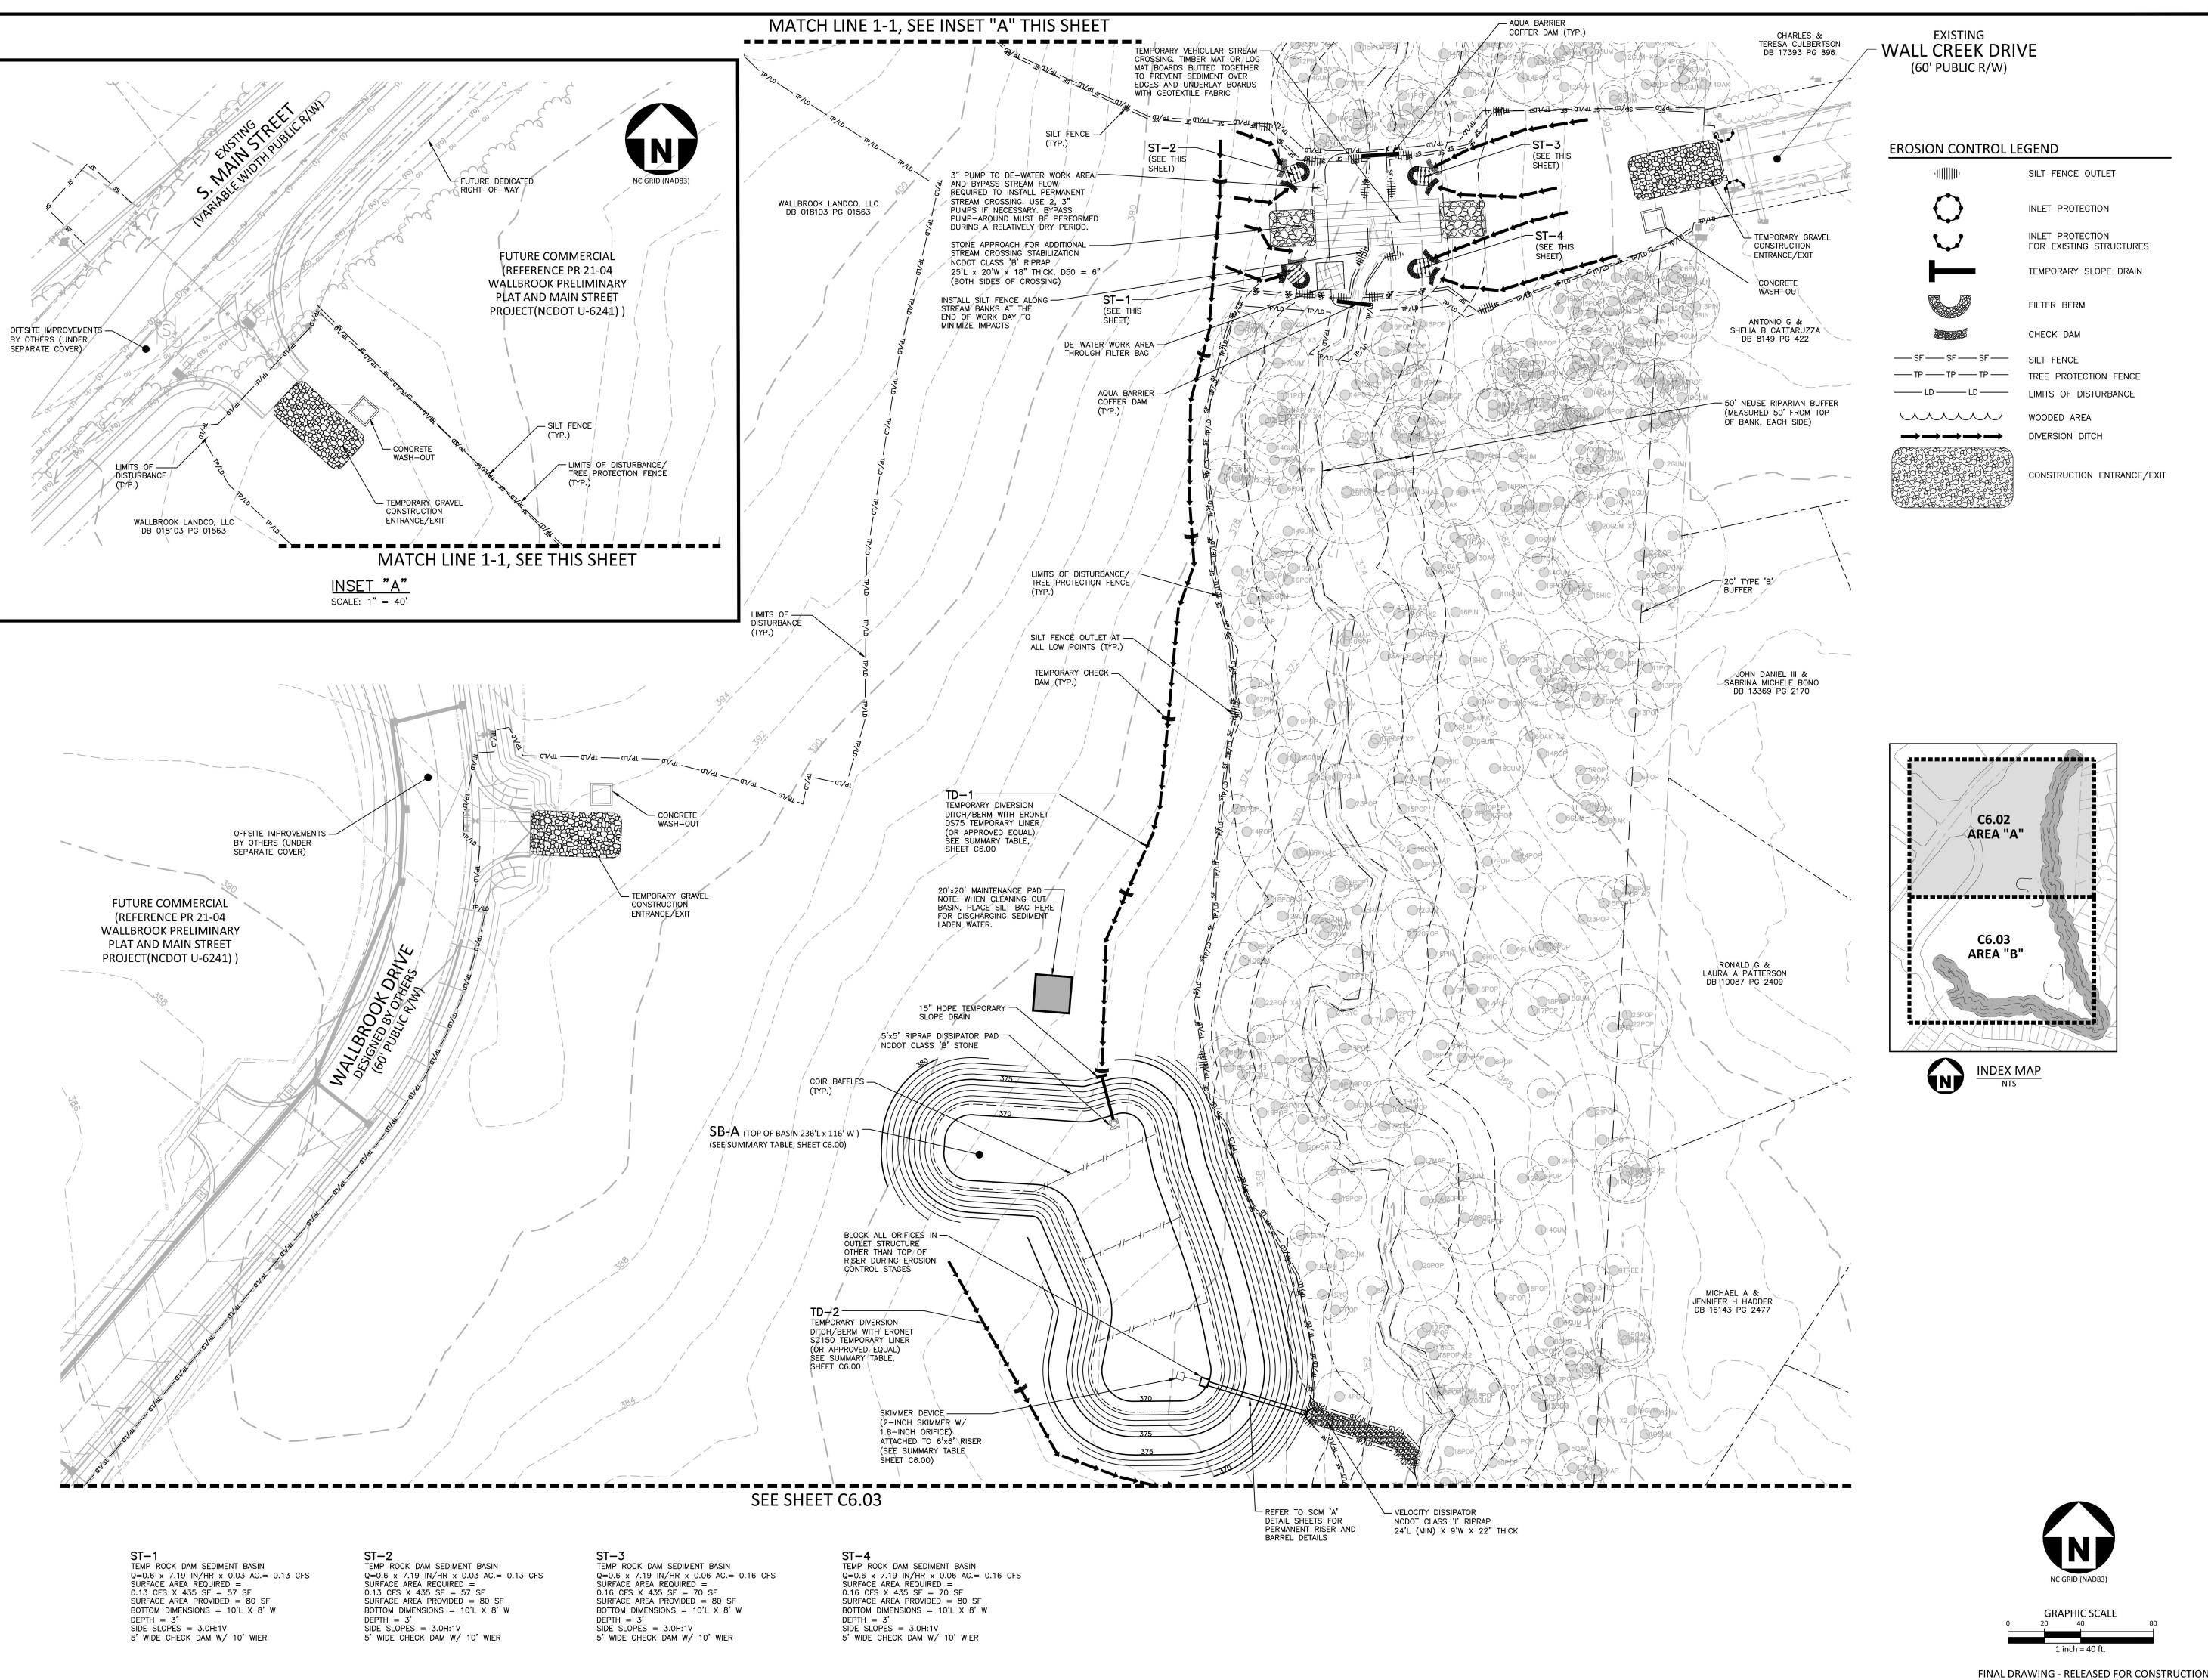

# McAdam:

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LON DRAWINGS
NORTH CAROLINA



# REVISIONS

NO. DATE

# PLAN INFORMATION

PROJECT NO. CPR-19100

FILENAME CPR19100-CD-EC1

CHECKED BY WTO

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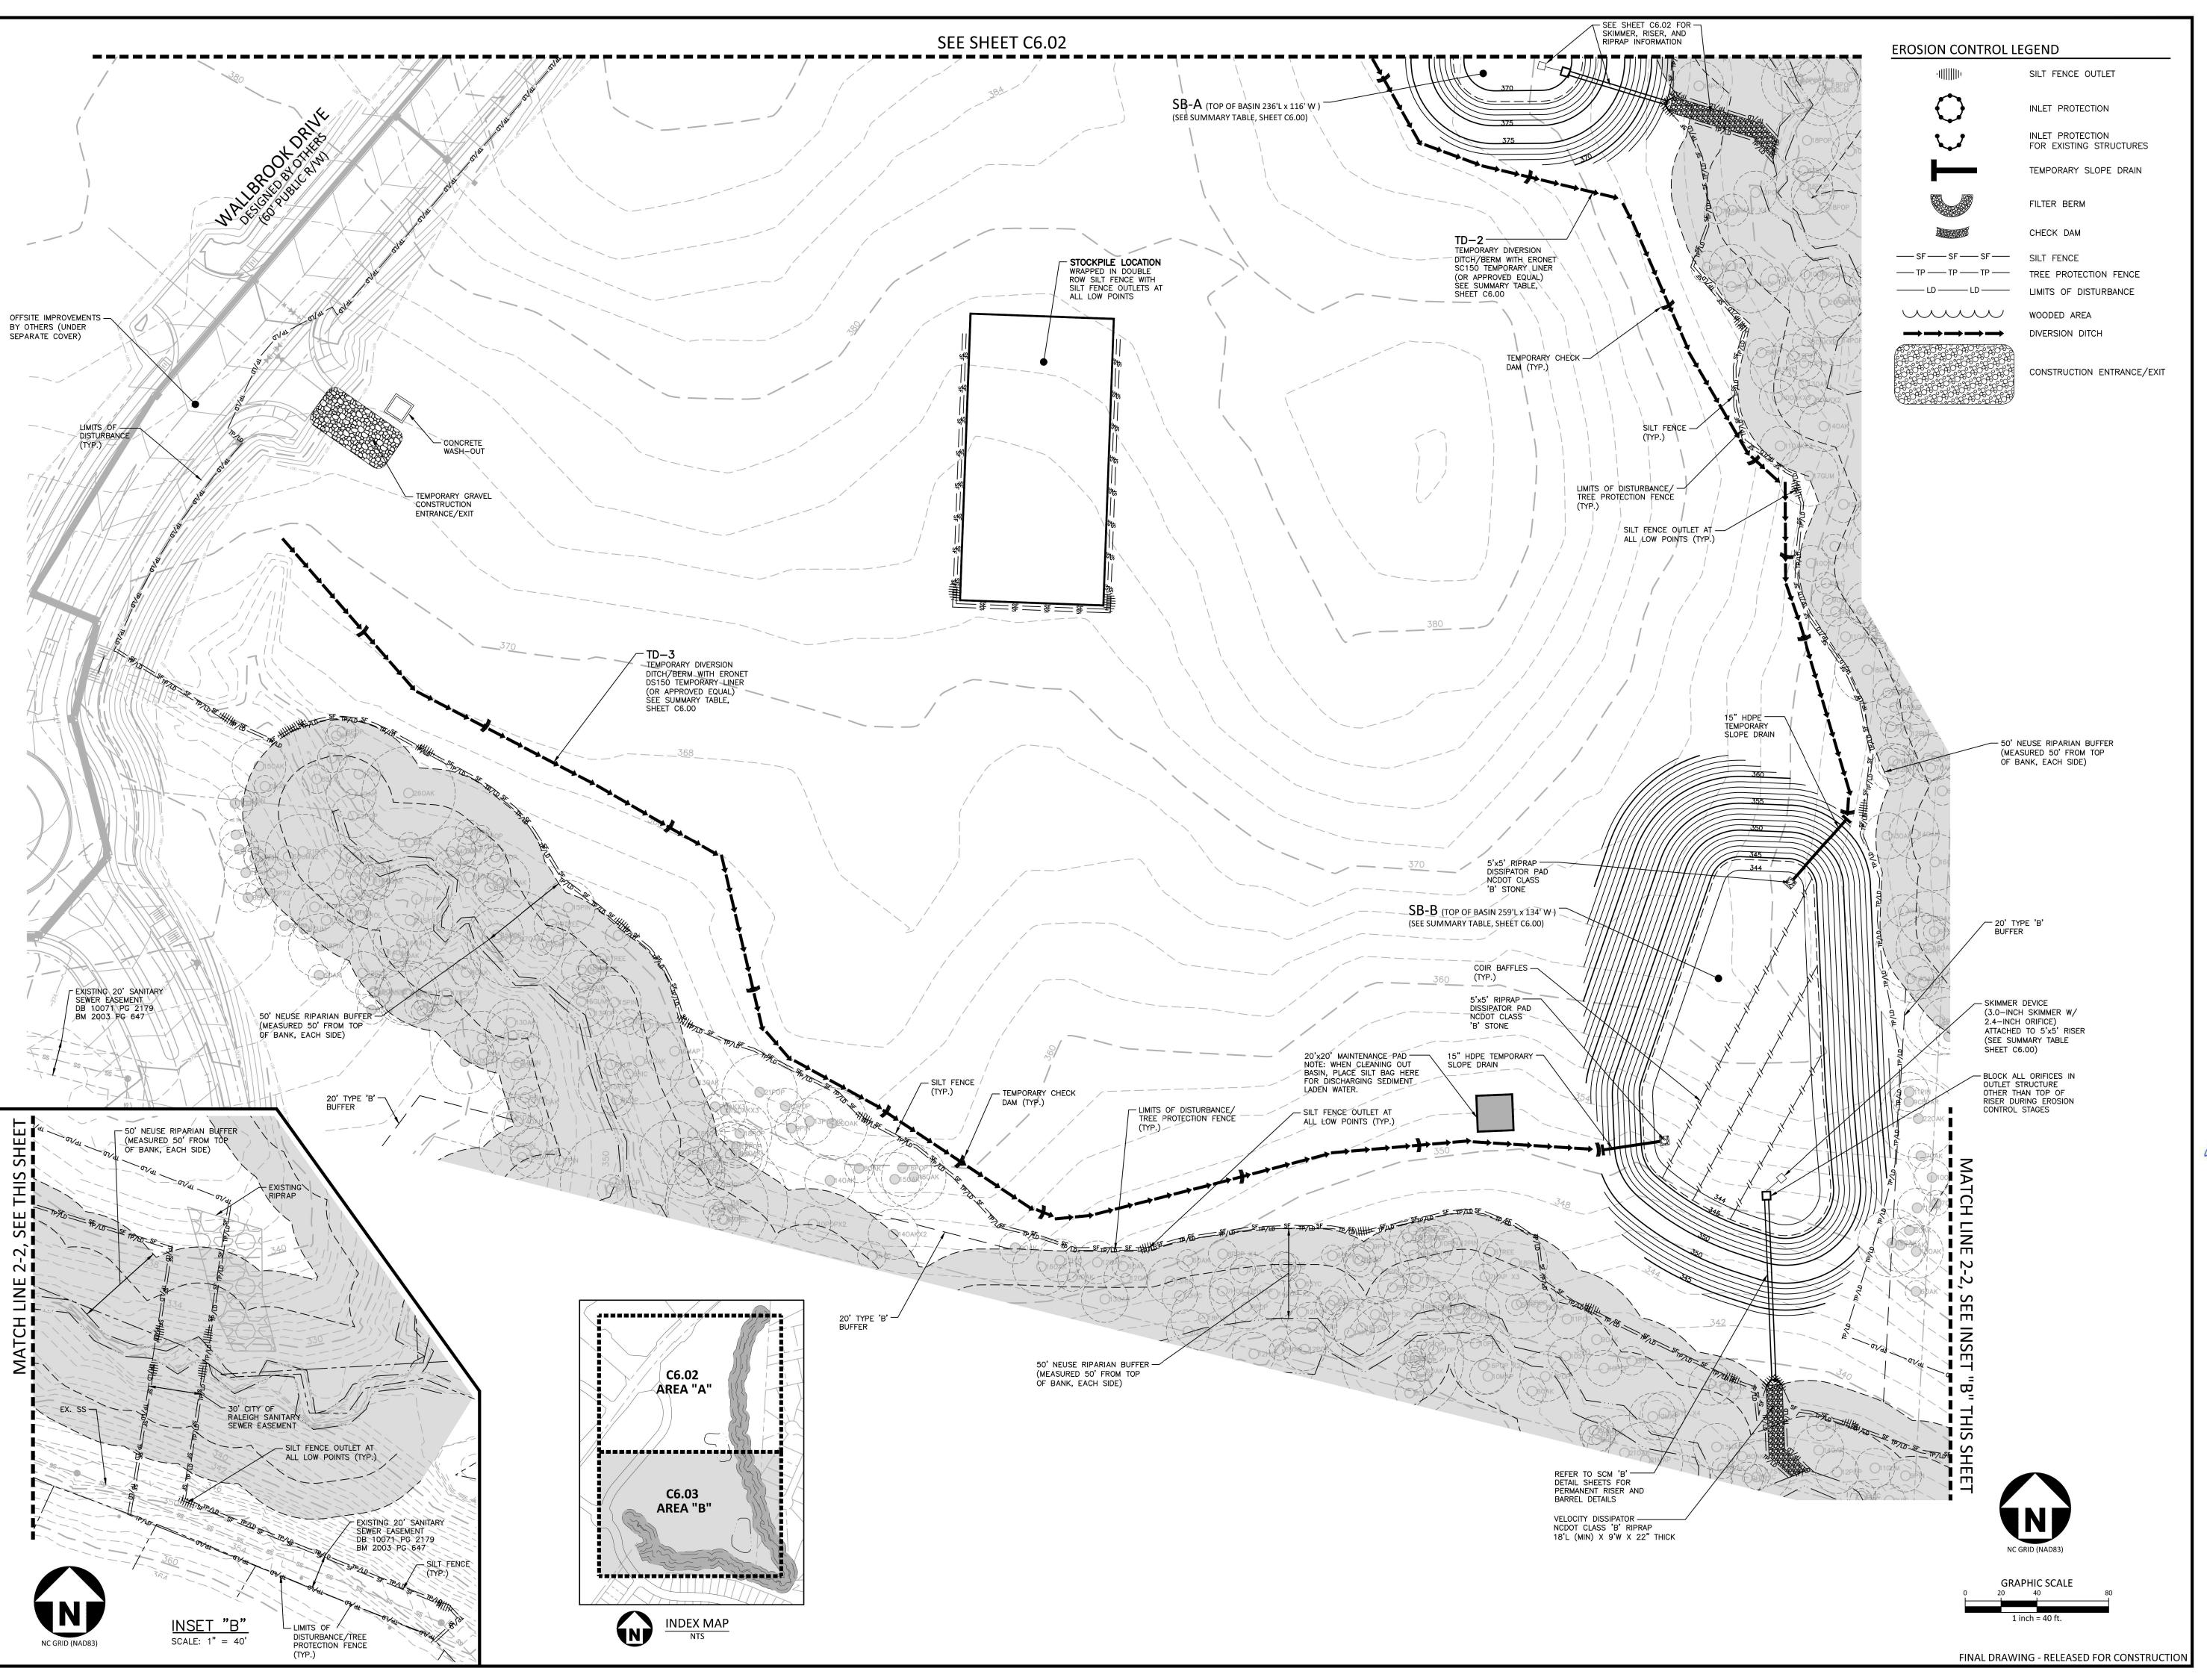
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 JMS

 SCALE
 1"=40'

 DATE
 05. 22. 2023

SHEET

EROSION CONTROL PLAN -STAGE 1 - AREA "A"





# McAdams

The John R. McAdams Company, Inc. 621 Hillsborough Street Suite 500 Raleigh, NC 27603


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WALLBROOK LANDCO, LLC 3 KEEL STREET, SUITE 2 WRIGHTSVILLE BEACH, NORTH CAROLINA 28480-1709

# SONSTRUCTION DRAWINGS ROLESVILLE, NORTH CAROLINA



# REVISIONS

NO. DATE
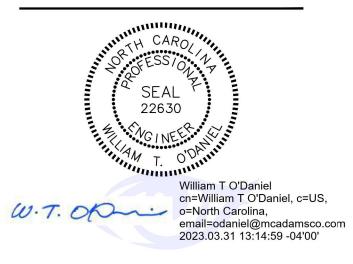
# **PLAN INFORMATION**

PROJECT NO. CPR-19100

FILENAME CPR19100-CD-EC1

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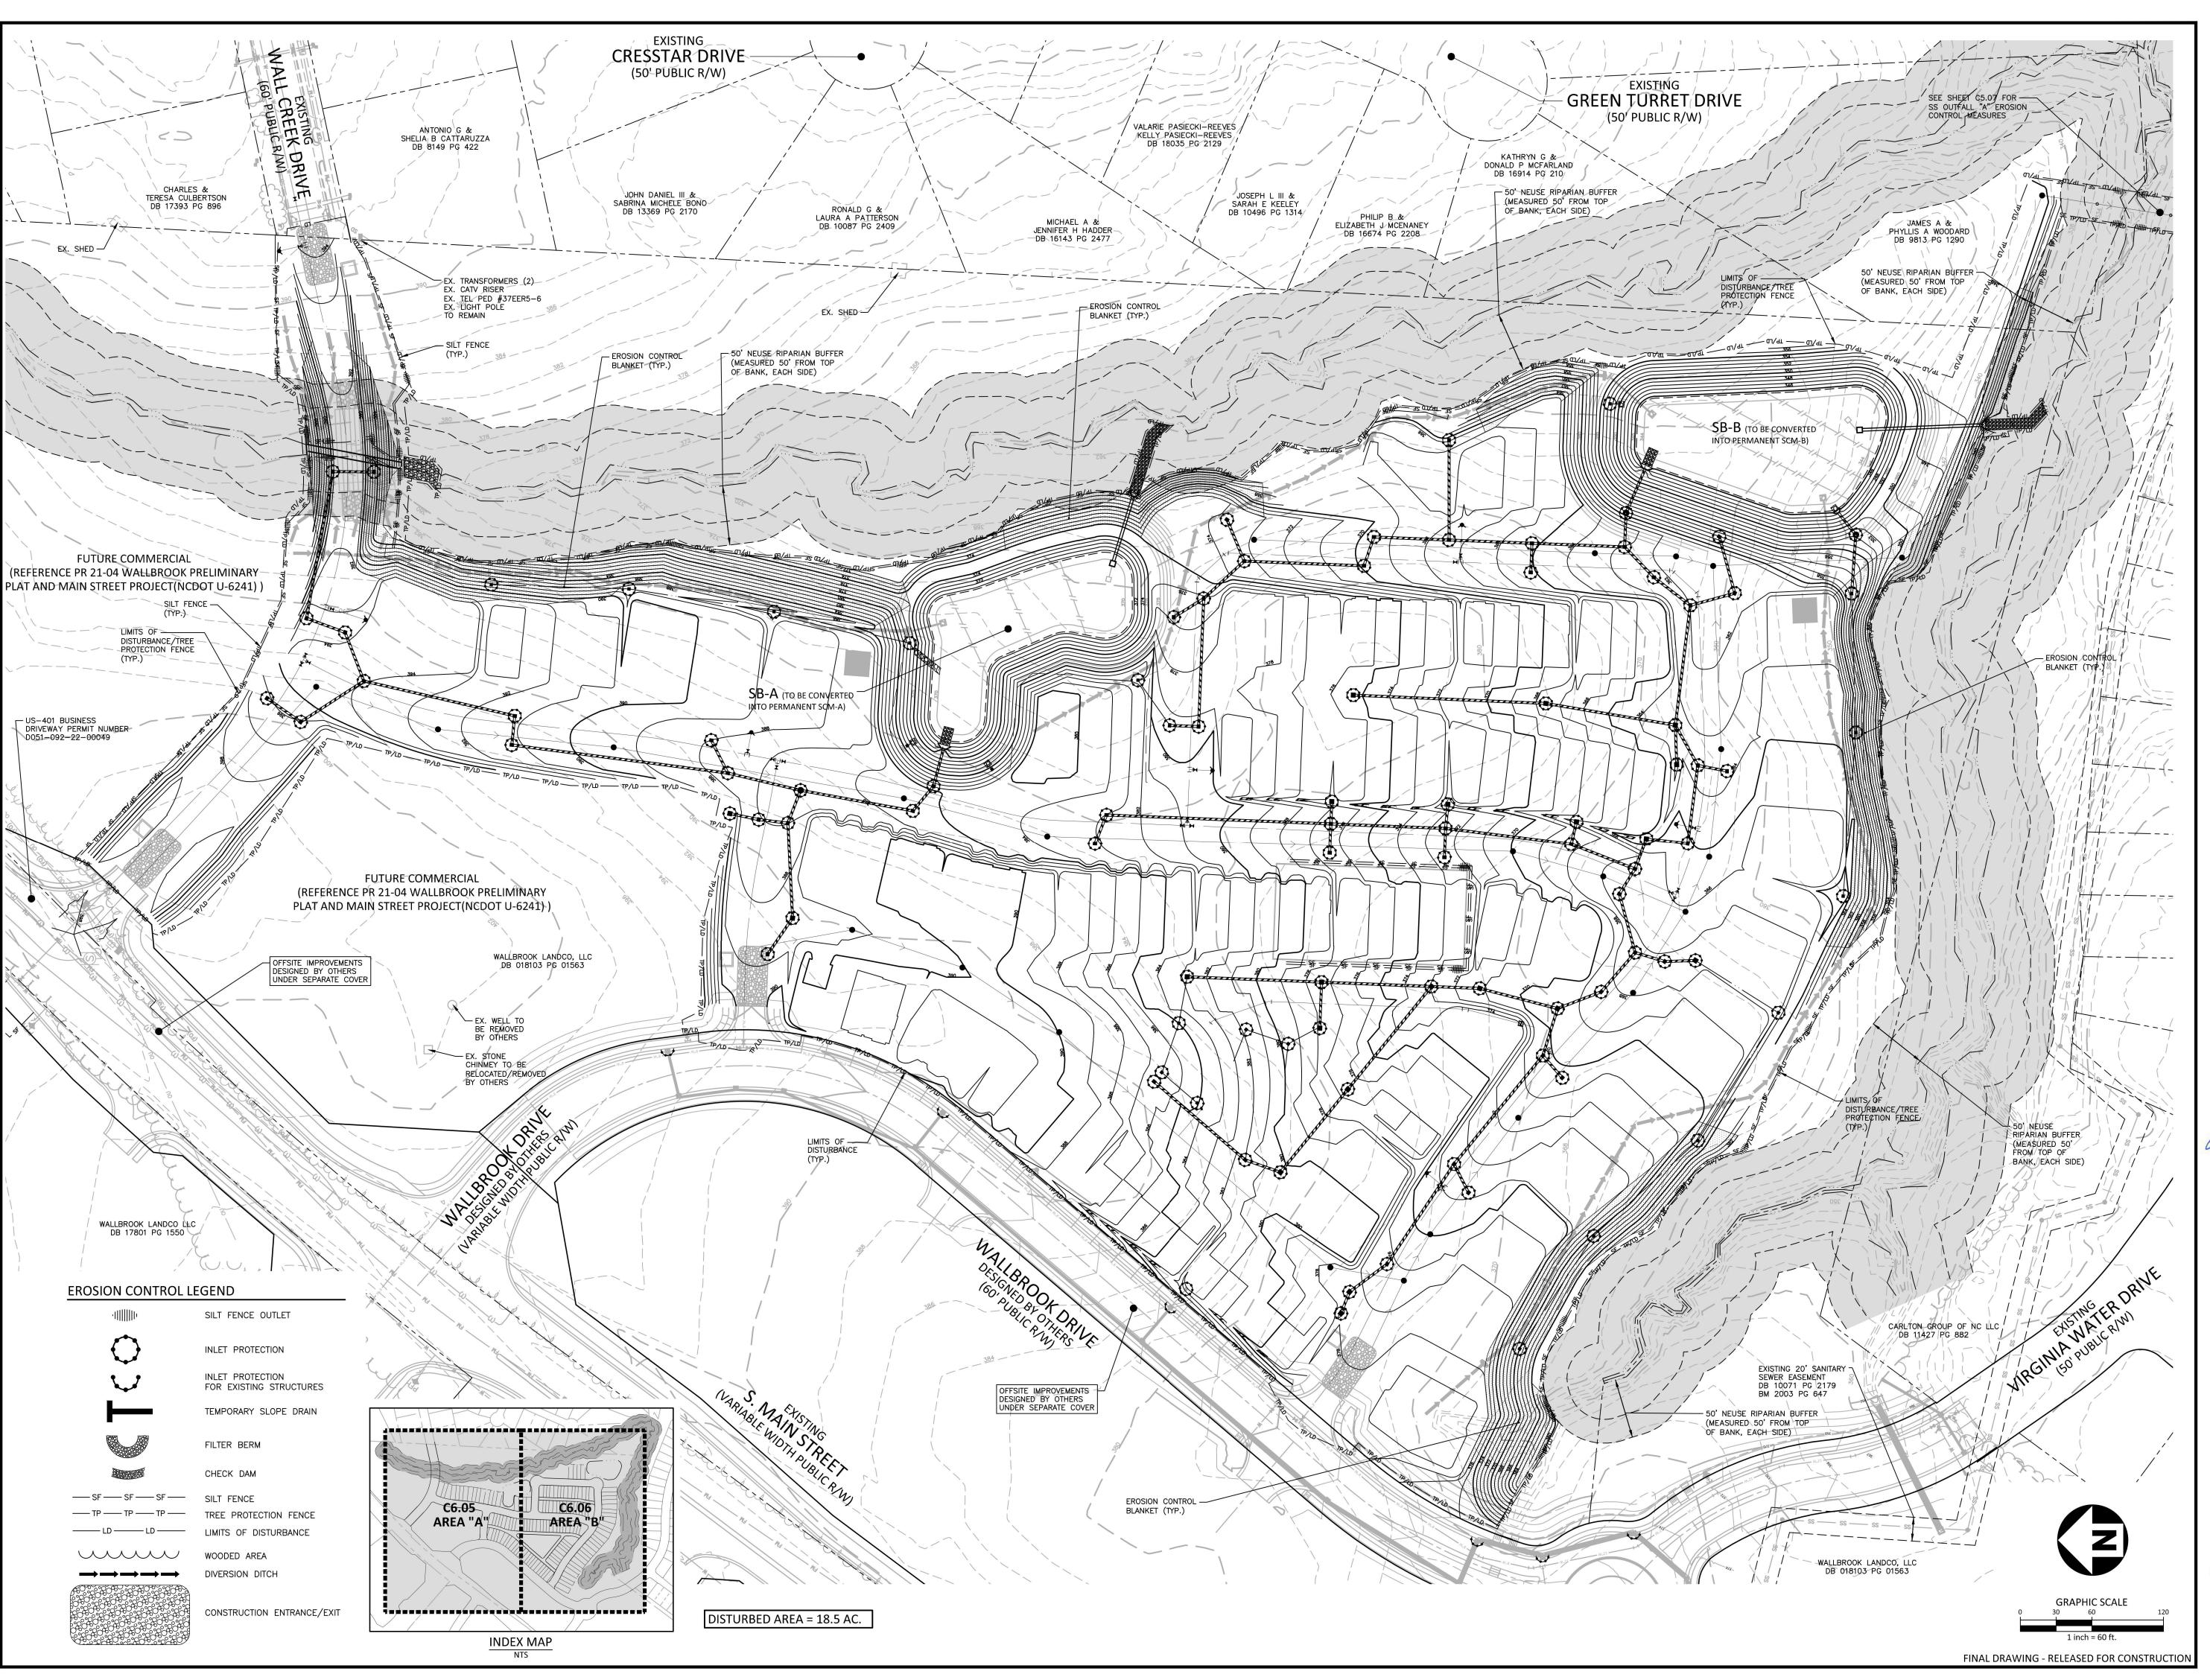
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SCALE 1"=40'

DATE 03. 31. 2023

SHEET

EROSION CONTROL PLAN -STAGE 1 - AREA "B"





# McAdam


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# WALLBROOK ONSTRUCTION DRAWINGS ROLESVILLE, NORTH CAROLINA



# REVISIONS

NO. DATE

# PLAN INFORMATION

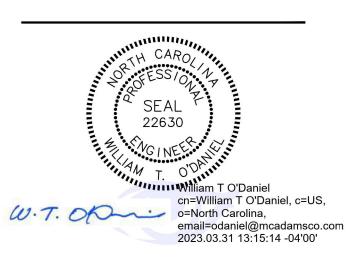PROJECT NO. CPR-19100

FILENAME CPR19100-CD-OAEC2


CHECKED BY WTO

DRAWN BY JMS

SCALE 1"=60'
DATE 03. 31. 2023

SHEET

OVERALL EROSION CONTROL PLAN - STAGE 2

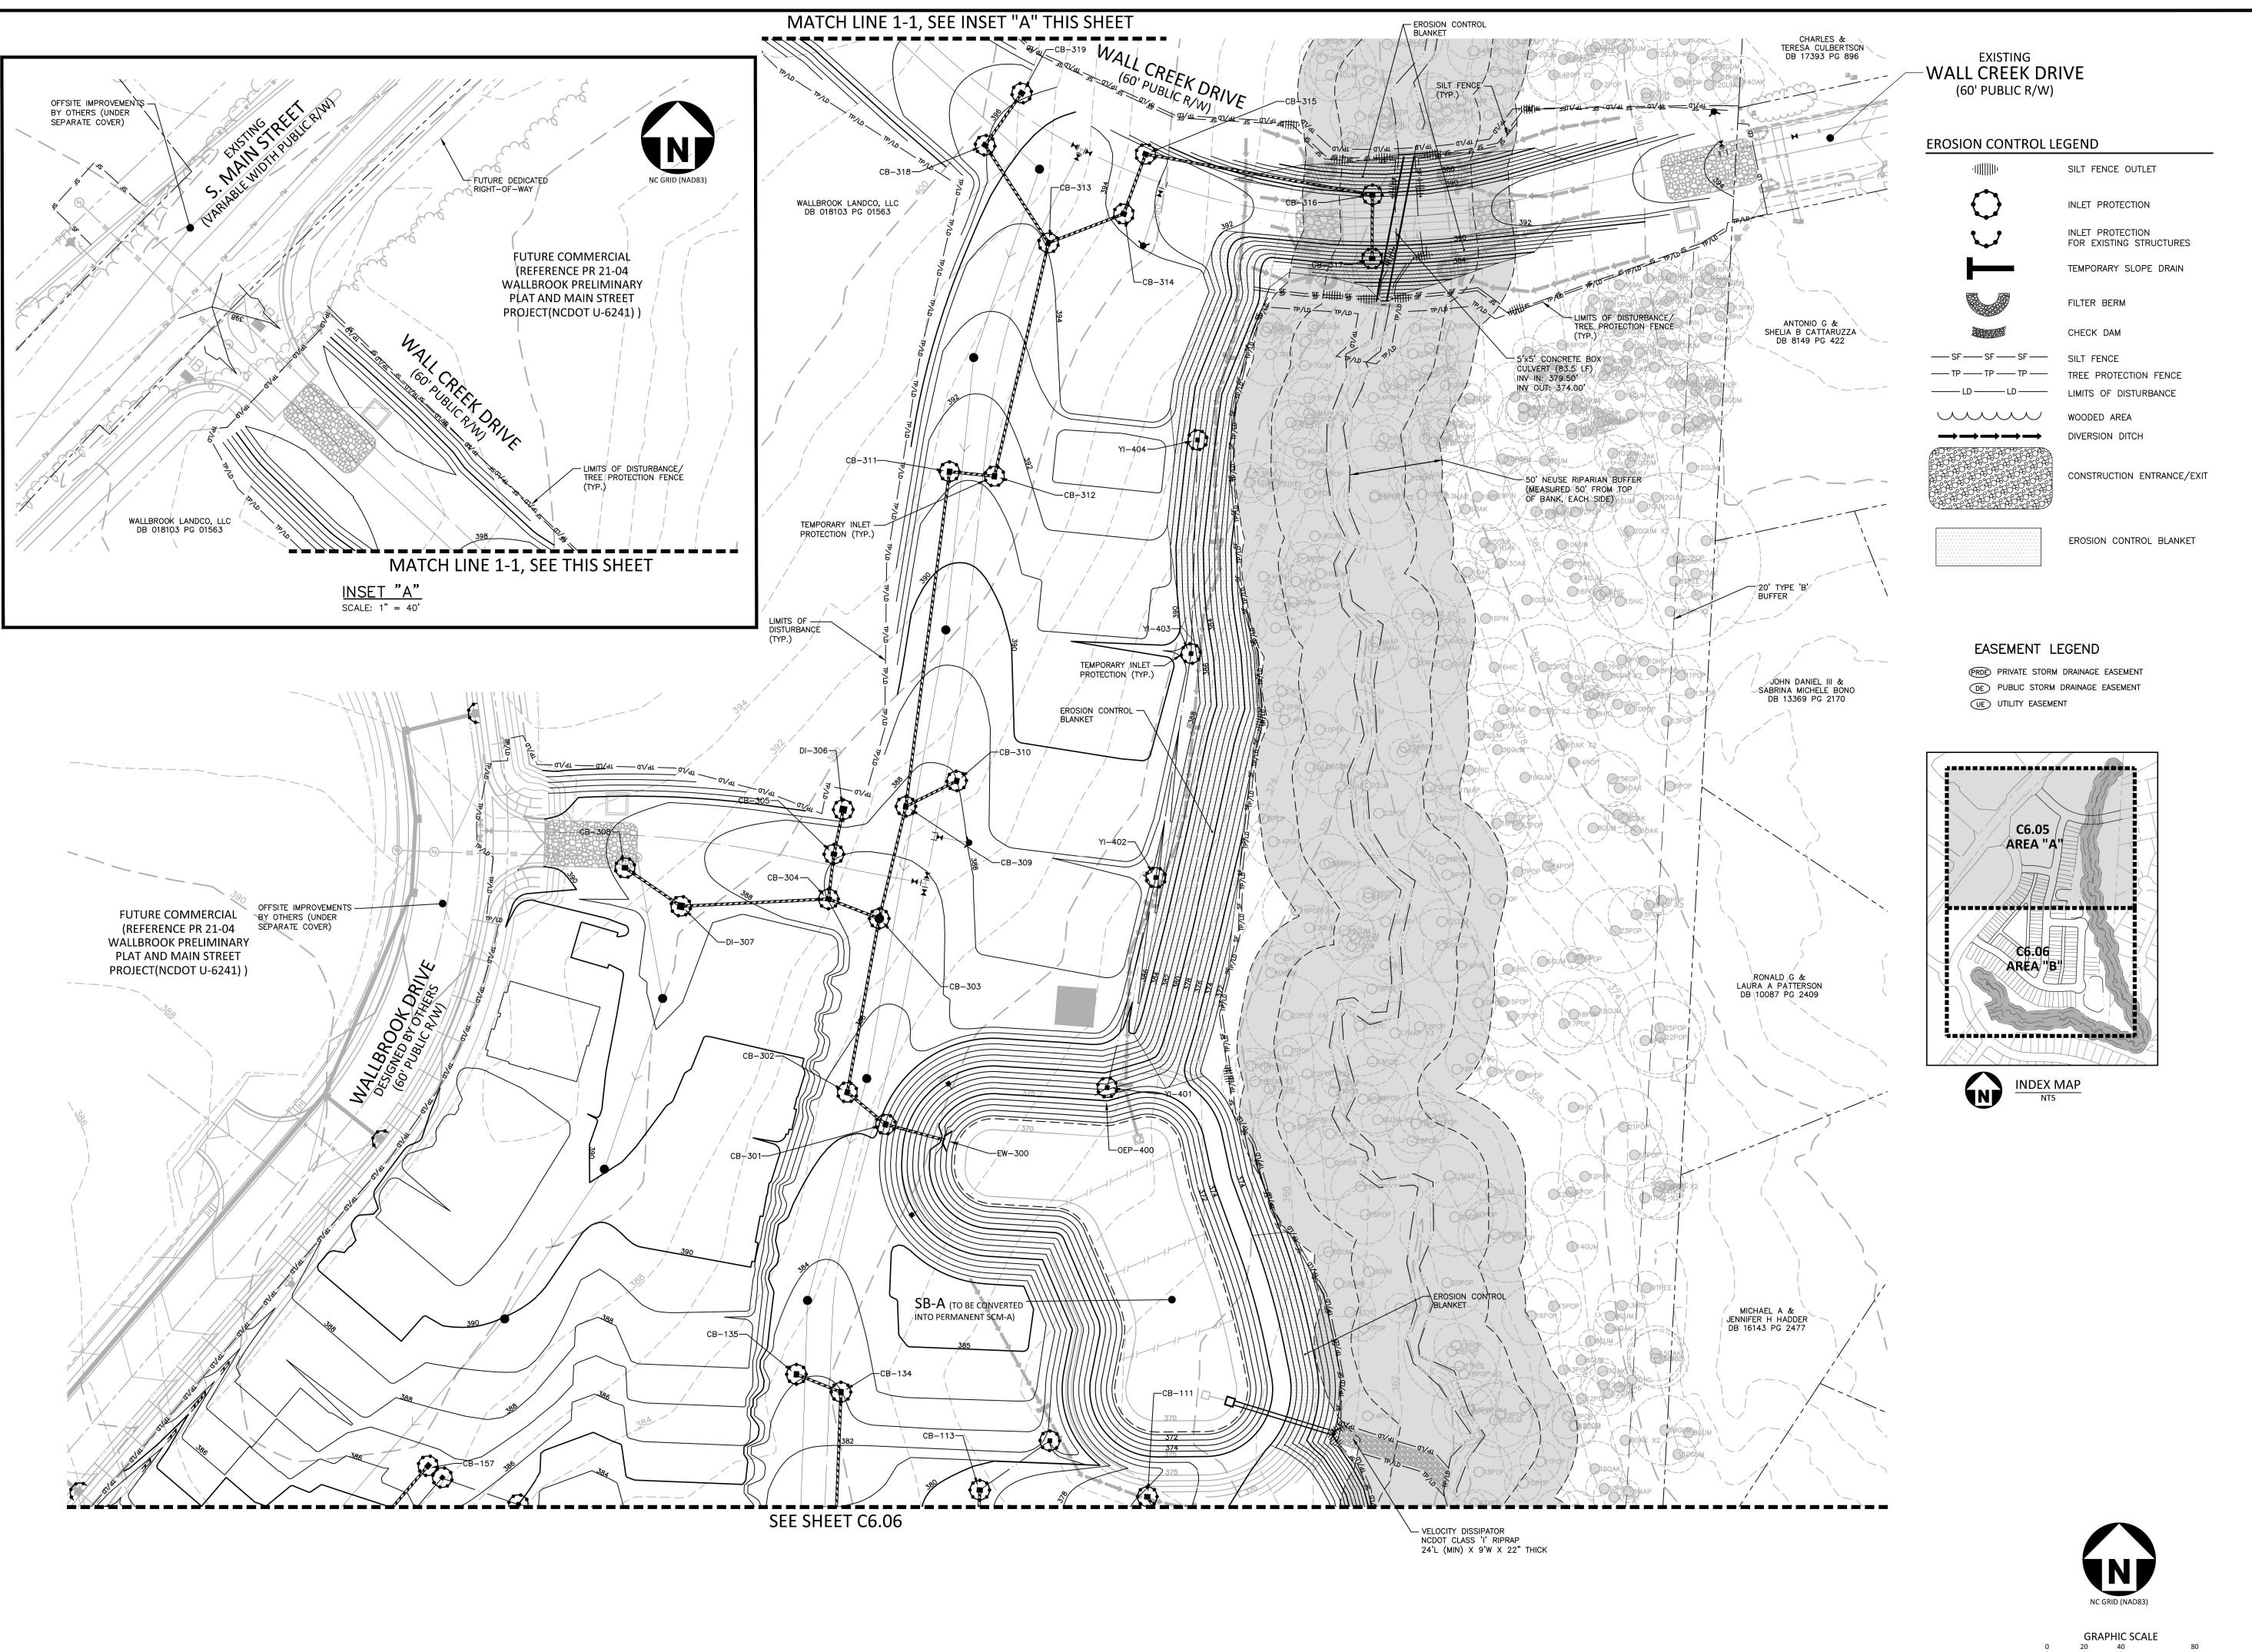



# McAdam:


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NSTRUCTION DRAWINGS
ROLESVILLE, NORTH CAROLINA



# **REVISIONS**

NO. DATE

# PLAN INFORMATION

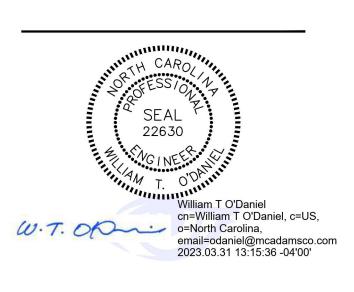PROJECT NO. CPR-19100

FILENAME CPR19100-CD-EC2

CHECKED BY WTO

DRAWN BY JMS

SCALE 1"=40'
DATE 03. 31. 2023

SHEET

FINAL DRAWING - RELEASED FOR CONSTRUCTION

EROSION CONTROL PLAN -STAGE 2 - AREA "A"