#### SPECIAL USE PERMIT CONDITIONS

- USES AND MAXIMUM DENSITIES ARE LIMITED TO THOSE SHOWN ON EACH SITE ON THE CONCEPT PLAN. ANY RESIDENTIAL UNITS NOT DESIGNATED ON THE RESIDENTIAL-TOWNHOMES TRACT MAY BE USED ON ANY OF THE TRACTS LABELED FOR
- NON-RESIDENTIAL USES. PRIOR TO THE ISSUANCE OF THE FIRST CERTIFICATE OF OCCUPANCY FOR THE FIRST RESIDENTIAL UNIT IN THE EAST SIDE AS SHOWN ON THE CONCEPT PLAN, DEVELOPER WILL COMPLETE THE EXTENSION OF WALL CREEK DRIVE TO MAIN STREET
- IF APPLICANT SEEKS A CERTIFICATE OF OCCUPANCY PRIOR TO THE COMMENCEMEN OF WORK ON THE LAPP GRANT PROJECT IMPROVEMENTS. THEN PRIOR TO THE ISSUANCE OF THE FIRST CERTIFICATE OF OCCUPANCY OF THE FIRST RESIDENTIAL UNI IN THE EAST SITE AND IN ACCORDANCE WITH THE "WALLBROOK DEVELOPMENT TIA ADDENDUM -- RESIDENTIAL-ONLY PHASE" DATED FEBRUARY 13, 2020, DEVELOPER WILL CONSTRUCT A 100' NORTHBOUND RIGHT TURN LANE AND A 100' SOUTHBOUN LEFT TURN LANE AT THE INTERSECTION OF WALL CREEK DRIVE (AS EXTENDED) AND MAIN STREET. IF WORK ON THE LAPP GRANT PROJECT IMPROVEMENTS IS COMMENCED BEFORE THE FIRST CERTIFICATE OF OCCUPANCY IS REQUESTED DEVELOPER IS NOT REQUIRED TO CONSTRUCT THE AFOREMENTIONED IMPROVEMENTS
- NO LATER THAN SIX MONTHS FOLLOWING THE COMPLETION OF THE LAPP GRANT PROJECT IMPROVEMENTS, DEVELOPER WILL COMPLETE BOTH 1) THE EXTENSION OF VIRGINIA WATER DRIVE TO MAIN STREET AND 2) THE EXTENSION OF BURLINGTON MILLS ROAD (AS REALIGNED) FROM MAIN STREET TO VIRGINIA WATER DRIVE.
- DEVELOPER WILL COMPLETE TRAFFIC IMPROVEMENTS AS SET FORTH IN OCTOBER 12 2020 MEMO BY STANTEC.
- AS SHOWN ON THE "PRELIMINARY PLAT PLAN SP 21-02," AREAS OF THE SITE EAST OF THE RIPARIAN STREAM AND ADJACENT TO WAKE COUNTY PINS 1758676836, 1758674619, 1758674416, 1758674204, 1758674100, AND 1758663984 SHALL NOT BE DEVELOPED WITH STRUCTURES OR IMPROVEMENTS.

PARCEL OWNER LIST			
PIN	OWNER	AREA	
1758-56-8976	WALLBROOK LANDCO, LLC. 3 KEEL STREET, SUITE 2 WRIGHTSVILLE BEACH, NC 28480	42.324 AC	

#### DEVELOPER/OWNER

WALLBROOK LANDCO, LLC. 3 KEEL STREET, SUITE 2 WRIGHTSVILLE BEACH, NC 28480

#### **CURRENT ZONING: CO SUD**

#### **SURVEY BY:**


JOHNSON, MIRMIRAN & THOMPSON 9201 ARBORETUM PARKWAY, SUITE 310 RICHMOND, VIRGINIA 23236

TOPOGRAPHIC MARCH 25, 2020 ALTA SURVEY MARCH 25, 2020

WILLIAM T. ROBBINS, PLS NC LICENSE # 4192 804-323-9900

#### **SURVEY NOTES**

- THE PROPERTY LIES IN ZONE "X" PER NATIONAL FLOOD INSURANCE PROGRAM RATE MAP (FIRM), WAKE COUNTY, NORTH CAROLINA, PANEL 1758, MAP NO. 3720175800J.
- THE SURVEY IS REFERENCED TO THE NORTH CAROLINA STATE PLANE COORDINATE SYSTEM, NORTH AMERICAN DATUM OF 1983, 2001 ADJUSTMENT, NAD83(2001), ALL DISTANCES ARE HORIZONTAL GROUND DISTANCES.
- THE SUBJECT PARCEL IS ZONED CO-SUD (COMMERCIAL OUTLYING SPECIAL USE DISTRICT) PER WAKE COUNTY GIS.
- SURVEY WAS PREPARED BY JOHNSON, MIRMIRAN & THOMPSON UNDER THE SUPERVISION OF WILLIAM T. ROBBINS, PLS. FIELD WORK WAS COMPLETED MARCH 25,
- AREAS COMPUTED BY COORDINATE METHOD. NO CEMETERIES OBSERVED AS A RESULTS OF THE SURVEY.

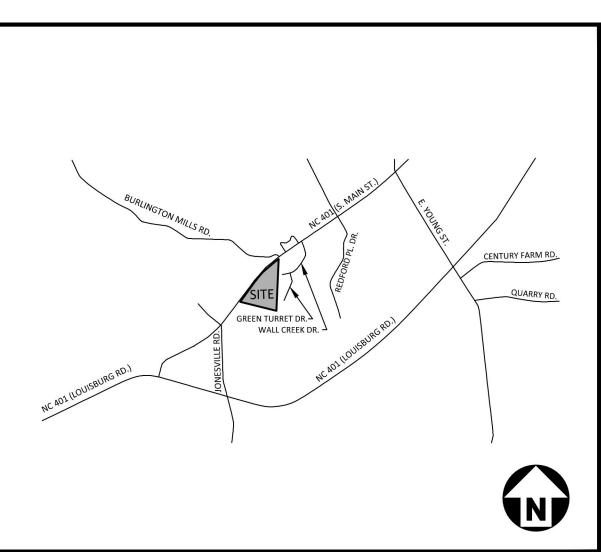

**VICINITY MAP** 

# WALLBROCK

# S. MAIN STREET ROLESVILLE, NORTH CAROLINA

# **TOWNHOMES CONSTRUCTION DRAWINGS** CD22-04

PROJECT NUMBER: CPR-19100 DATE: MAY 22, 2023

### 15.4.5 - Streets

Type of Street Required All subdivision lots shall abut at least 20 feet on a public street. All public streets shall be dedicated to the Town of Rolesville, the State of North Carolina or the public as determined appropriate by the Board of Commissioners of the Town of Rolesville. All public streets shall be built to the standards of this ordinance and all other applicable standards of the Town of Rolesville and the North Carolina Department of Transportation. Public streets not dedicated to the Town which are eligible for acceptance into the State Highway System shall be constructed to the standards necessary to be put on the State Highway System or the standards in this ordinance, whichever is stricter, in regard to each particular item and shall be put on such system. Streets not dedicated to the Town which are not eligible to be put on the State Highway System because there are too few lots or residences shall, nevertheless, be dedicated to the public and shall be in accordance with the standards in this ordinance or the standards necessary to be put on the State Highway System, whichever is stricter in regard to each particular item, so as to be

later date. A written maintenance agreement with provisions for maintenance of the street until it is put on the State System shall be included with the final plat.

Subdivision Street Disclosure Statement All streets shown on the final plat shall be designated in accordance with G.S. § 136-102.6 and designation as public shall be conclusively presumed an offer of dedication to the public. Where streets are dedicated to the public but not accepted into a municipal or the State system, before lots are sold, a statement explaining the status of the street

## EROSION CONTROL, STORMWATER AND FLOODPLAIN MANAGEMENT **APPROVED** EROSION CONTROL ☐ SEC-084327-2022 STORMWATER MGMT. SWF-084502-2022 FLOOD STUDY S-Janet Boyer E=janet.boyer@wakegov.com, O=Wake County, OU=Watershed Management, CN=Janet Boyer


## **CHANTITIES** .

QUANTITIES.			
	STREETS		
	WALL CREEK DR	60' R/W	615 LF
	LETTIE LN	50' R/W	1,180 LI
	WALLSTONE WAY	50' R/W	1,470 LI
	CHIMNEY DR	50' R/W	205 LF
	DEEP OAK DR	20' PRIVATE ALLEY	635 LF
	RANDY DR	20' PRIVATE ALLEY	240 LF
	ROLES WAY	20' PRIVATE ALLEY	585 LF
	ZIGGY LN	20' PRIVATE ALLEY	445 LF

#### PUBLIC UTILITY IMPROVEMENTS QUANTITIES (CONSTRUCTION DRAWINGS)

(CONSTRUCTION DIAWINGS)			
ITEM	TOTALS		
NUMBER OF LOTS	140		
LOT NUMBERS	1-140		
6" PUBLIC WATER (LF)	0 LF		
8" PUBLIC WATER (LF)	3,420 LF		
8" PUBLIC SEWER (LF)	2,195 LF		
12" PUBLIC SEWER (LF)	1,565 LF		
WATER SERVICE STUBS	141-22=118*		
SEWER SERVICE STUBS	141		

\* 22 SERVICES ALONG WALLBROOK DRIVE TO BE INSTALLED BY OTHERS

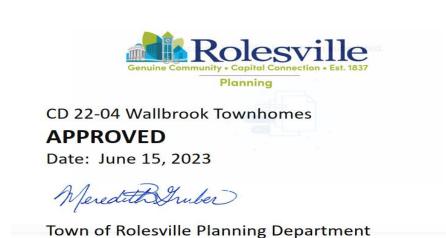

NOTE: PHASE 2 RELIES ON DESIGN AND INFRASTRUCTURE BY OTHERS FOR PUBLIC WATER. PHASE 2 IS NOT TO BE PLATTED UNTIL THE WATER BY OTHERS IS INSTALLED, INSPECTED AND ACCEPTED BY RALEIGH.

#### SHEET INDEX PROJECT NOTES EXISTING CONDITIONS (PREPARED BY JMT SURVEY) DEMOLITION PLAN OVERALL SITE PLAN

SITE PLAN - AREA "A" C2.01 C2.02 SITE PLAN - AREA "B" LOT DIMENSIONS - AREA "A"

1 of 1

C1.01

C2.00

LOT DIMENSIONS - AREA "B" OVERALL PHASING PLAN C3.00 OVERALL GRADING AND STORM DRAINAGE PLAN

C3.01 GRADING AND STORM DRAINAGE PLAN - AREA "A" C3.02 GRADING AND STORM DRAINAGE PLAN - AREA "B"

C4.00 OVERALL UTILITY PLAN UTILITY PLAN - AREA "A" C4.01

C4.02 UTILITY PLAN - AREA "B" C5.00 PLAN AND PROFILE - WALL CREEK DR STA. 9+00 THRU STA. 18+00 C5.01 PLAN AND PROFILE - LETTIE LN STA. 9+50 THRU STA. 22+00

C5.02 PLAN AND PROFILE - WALLSTONE WAY STA. 9+50 THRU STA. 19+50 C5.03 PLAN AND PROFILE - WALLSTONE WAY STA. 19+50 THRU STA. 26+50 PLAN AND PROFILE - CHIMNEY DR STA. 9+50 THRU STA. 13+00

C5.04 PLAN AND PROFILE - DEEP OAK DR STA. 9+50 THRU STA. 16+50 PLAN AND PROFILE - RANDY DR STA. 9+50 THRU STA. 13+00

PLAN AND PROFILE - ROLES WAY STA. 9+50 THRU STA. 16+50 C5.05 C5.06 PLAN AND PROFILE - ZIGGY LN STA. 9+50 THRU STA. 15+00

PLAN AND PROFILE - SS OUTFALL "A" STA. 9+50 THRU STA. 18+50 C5.07 **EROSION CONTROL NOTES** 

**OVERALL EROSION CONTROL PLAN - STAGE 1** C6.01 C6.02 EROSION CONTROL PLAN - STAGE 1 - AREA "A" C6.03 EROSION CONTROL PLAN - STAGE 1 - AREA "B"

**OVERALL EROSION CONTROL PLAN - STAGE 2** C6.04 EROSION CONTROL PLAN - STAGE 2 - AREA "A" C6.05 **EROSION CONTROL PLAN - STAGE 2 - AREA "B"** C6.06 OVERALL EROSION CONTROL PLAN - STAGE 3 C6.07

C6.08 EROSION CONTROL PLAN - STAGE 3 - AREA "A" C6.09 EROSION CONTROL PLAN - STAGE 3 - AREA "B"

C6.10 **EROSION CONTROL DETAILS** C6.11 **EROSION CONTROL DETAILS** C6.12 **EROSION CONTROL DETAILS** 

C6.13 **EROSION CONTROL DETAILS EROSION CONTROL DETAILS** 

SITE DETAILS C8.01 STORM DRAINAGE DETAILS

C8.02 STORM DRAINAGE DETAILS WATER DETAILS WATER DETAILS

SEWER DETAILS C8.06 SEWER DETAILS STORMWATER CONTROL MEASURE "A" PLAN VIEW C9.A1

C9.A2 STORMWATER CONTROL MEASURE "A" DETAILS C9.A3 STORMWATER CONTROL MEASURE "A" DETAILS STORMWATER CONTROL MEASURE "A" LANDSCAPE PLAN C9.A4 C9.B1 STORMWATER CONTROL MEASURE "B" PLAN VIEW

C9.B2 STORMWATER CONTROL MEASURE "B" DETAILS STORMWATER CONTROL MEASURE "B" DETAILS C9.B3 C9.B4 STORMWATER CONTROL MEASURE "B" LANDSCAPE PLAN

C10.01 OPEN SPACE PLAN OVERALL CODE LANDSCAPE PLAN L5.00

L5.01 ENLARGED CODE LANDSCAPE PLAN

TREE PRESERVATION PLAN (PREPARED BY ARK CONSULTING) SIGHT LIGHTING AND SPECIFICATIONS (BY ON-SITE LIGHTING) PHOTOMETRIC PLAN (PREPARED BY ON-SITE LIGHTING)

SL2.2 PHOTOMETRIC PLAN (PREPARED BY ON-SITE LIGHTING)

#### SITE PERMITTING APPROVAL

#### Water and Sewer Permits (If applicable)

City of Raleigh Development Approval

The City of Raleigh consents to the connection and extension of the City's Public Sewer System as shown on this plan. The material and Construction methods used for this project shall conform to the standards and specifications of the City's Public Utilities Handbook. City of Raleigh Public Utilities Department Permit # S-5230

The City of Raleigh consents to the connection and extension of the City's Public Water System as shown on this plan. The material and Construction methods used for this project shall conform to the standards and specifications of the City's Public Utilities Handbook. City of Raleigh Public Utilities Department Permit # W-4043

The City of Raleigh consents to the connection to its public sewer system and extension of the private sewer collection system as shown on this plan. The material and constructions methods used for this project shall conform to the standards and specifications of the City's Public Utilities Handbook City of Raleigh Public Utilities Department Permit # \_\_\_\_\_

CITY OF RALEIGH - PLANS AUTHORIZED FOR CONSTRUCTION

Plans for the proposed use have been reviewed for general compliance with applicable codes. This limited review, and authorization for construction is not to be considered to represent total compliance with all legal requirements for development and construction. The property owner, design consultants, and contractors are each responsible for compliance with all applicable City, State and Federal laws. This specific authorization below is not a permit, nor shall it be construed to permit any violation of City, State or Federal Law. All Construction must be in accordance with all Local, State, and Federal Rules and Regulations.

Electronic Approval: This approval is being issued electronically. This approval is valid only upon the signature of a City of Raleigh Review Officer below. The City will retain a copy of the approved plans. Any work authorized by this approval must proceed in accordance with the plans kept on file with the City. This electronic approval may not be edited once issued. Any modification to this approval once issued will invalidate this approval.

City of Raleigh Review Officer

FINAL DRAWING - RELEASED FOR CONSTRUCTION



621 Hillsborough Street Suite 500 Raleigh, NC 27603 phone 919. 361. 5000

The John R. McAdams Company, Inc

fax 919. 361. 2269 license number: C-0293, C-187

www.mcadamsco.com


#### **CONTACT**

MIKE SANCHEZ sanchez@mcadamsco.com PHONE: 919. 361. 5000

### CLIENT

WALLBROOK LANDCO, LLC 3 KEEL STREET, SUITE 2 WRIGHTSVILLE BEACH, NORTH CAROLINA 28480-1709

#### PROJECT DIRECTORY

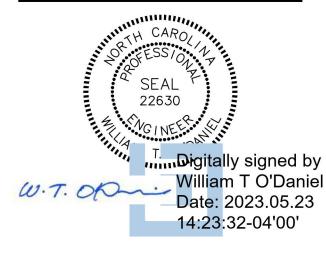

#### **REVISIONS**

NO. DATE

CONSTRUCTION **DRAWINGS FOR:** 

**WALLBROOK** ROLESVILLE, NORTH CAROLINA PROJECT NUMBER: CPR-19100

#### **GENERAL NOTES:**

- 1. ALL DIMENSIONS AND GRADES SHOWN ON THE PLANS SHALL BE FIELD VERIFIED BY THE CONTRACTOR PRIOR TO CONSTRUCTION. CONTRACTOR SHALL NOTIFY THE OWNER IF ANY DISCREPANCIES EXIST PRIOR TO PROCEEDING WITH CONSTRUCTION FOR NECESSARY PLAN OR GRADE CHANGES. NO EXTRA COMPENSATION SHALL BE PAID TO THE CONTRACTOR FOR ANY WORK DONE DUE TO DIMENSIONS OR GRADES SHOWN INCORRECTLY ON THESE PLANS IF SUCH NOTIFICATION HAS NOT BEEN GIVEN.
- 2. THERE MAY BE WETLANDS WITHIN THIS SITE. IT IS THE OWNER'S RESPONSIBILITY FOR WETLANDS JURISDICTION AND PERMIT DISTURBANCE PRIOR TO ANY GRADING ACTIVITY.

THE PROJECT WITH A COPY OF THE TRANSMITTAL LETTER TO THE OWNER.

#### SITE PLAN NOTES

- 1. ALL CONSTRUCTION SHALL CONFORM TO THE LATEST TOWN OF ROLESVILLE AND/OR NCDOT STANDARDS AND SPECIFICATIONS AS APPLICABLE.
- 2. ALL DIMENSIONS SHOWN ON SITE PLAN ARE MEASURED TO BACK OF CURB UNLESS OTHERWISE NOTED.
- 3. CONTRACTOR SHALL MAINTAIN AN "AS-BUILT" SET OF DRAWINGS TO RECORD THE EXACT LOCATION OF ALL PIPING PRIOR TO CONCEALMENT. DRAWINGS SHALL BE GIVEN TO THE ENGINEER UPON COMPLETION OF
- 4. EXISTING IMPROVEMENTS DAMAGED DURING CONSTRUCTION SHALL BE REPLACED/RESTORED TO THEIR ORIGINAL CONDITION AND TO THE SATISFACTION OF THE OWNER, BY THE CONTRACTOR RESPONSIBLE FOR THE DAMAGE.
- 5. THE CONTRACTOR SHALL NOTE THAT THE DRAWINGS MAY NOT SHOW EVERY OFFSET, TRANSITION, FITTING, ETC. THAT MAY BE REQUIRED. THE CONTRACTOR SHALL INSTALL SUCH STANDARD APPURTENANCES AS REQUIRED TO CLOSELY FOLLOW THE GRADES AND ALIGNMENTS DEPICTED ON THE PLANS.
- 6. CONTRACTOR SHALL NOTIFY "NC811" (811) OR (1-800-632-4949) AT LEAST 3 FULL BUSINESS DAYS PRIOR TO BEGINNING CONSTRUCTION OR EXCAVATION TO HAVE EXISTING UTILITIES LOCATED. CONTRACTOR SHALL CONTACT ANY LOCAL UTILITIES THAT PROVIDE THEIR OWN LOCATOR SERVICES INDEPENDENT OF "NC811". REPORT ANY DISCREPANCIES TO THE ENGINEER IMMEDIATELY.
- 7. CONTRACTOR IS RESPONSIBLE FOR COORDINATING CONSTRUCTION ACTIVITIES WITH THE APPROPRIATE UTILITY COMPANIES FOR ANY REQUIRED RELOCATIONS (I.E. POWER POLES, TELEPHONE PEDESTALS, WATER METERS, ETC.).
- 8. ALL DIMENSIONS AND GRADES SHOWN ON THE PLANS SHALL BE FIELD VERIFIED BY THE CONTRACTOR PRIOR TO CONSTRUCTION. CONTRACTOR SHALL NOTIFY THE ENGINEER IF ANY DISCREPANCIES EXIST PRIOR TO PROCEEDING WITH CONSTRUCTION, FOR NECESSARY PLAN OR GRADE CHANGES. NO EXTRA COMPENSATION SHALL BE PAID TO CONTRACTOR FOR ANY WORK DONE DUE TO DIMENSIONS OR GRADES SHOWN INCORRECTLY ON THESE PLANS IF SUCH NOTIFICATION HAS NOT BEEN GIVEN.
- 9. ACCESSIBLE RAMPS SHALL BE CONSTRUCTED IN ACCORDANCE WITH NCDOT DETAILS.
- 10. ALL SIDEWALKS THAT CONNECT TO THE PUBLIC RIGHT-OF-WAY MUST BE ACCESSIBLE TO PERSONS WHO ARE BLIND, HAVE LOW VISION AND PEOPLE WITH MOBILITY DISABILITIES. PEDESTRIAN EXISTING ROUTES AND ALTERNATE PEDESTRIAN ROUTES DURING CONSTRUCTION WILL BE REQUIRED TO BE COMPLIANT WITH THE PUBLIC RIGHTS OF WAY ACCESSIBILITY GUIDELINES (PROWAG), 2010 ADA STANDARDS FOR ACCESSIBLE DESIGN AND THE MANUAL ON UNIFORM TRAFFIC CONTROL DEVICES (MUTCD).
- 11. TYPICAL PAVEMENT SECTION DETAILS ARE SHOWN WITHIN THIS SET AND INTENDED TO BE A MINIMUM PAVEMENT SECTION REQUIREMENT. THE CURRENT GEOTECHNICAL REPORT SHALL OVER-RIDE ALL TYPICAL PAVEMENT SECTIONS SHOWN, IF THE GEOTECHNICAL ENGINEER DEEMS A HEAVIER SECTION IS REQUIRED.
- 12. EQUIPMENT AND PRODUCTS OTHER THAN THOSE SPECIFIED MAY BE USED PROVIDED APPROVAL HAS BEEN OBTAINED FROM THE OWNER IN WRITING PRIOR TO ORDERING OR INSTALLATION. THE CONTRACTOR SHALL WAIVE ANY CLAIM FOR ADDITIONAL COST RELATED TO SUBSTITUTION OF ALTERNATE EQUIPMENT.
- 13. ALL SIGNAGE ASSOCIATED WITH THE PUBLIC STREET SYSTEM SHALL ADHERE TO MUTCD STANDARDS AND SPECIFICATIONS.

#### **NOTES:**

- ROADS LABELED AS PUBLIC WILL BE DEDICATED AS PUBLIC ROW TO BE
  MAINTANED BY THE TOWN OF ROLESVILLE.
- 2. ROADS LABELED AS PRIVATE WILL BE DEDICATED AS PRIVATE AND BE MAINTAINED BY THE HOA.
- 3. GREENWAY EASEMENTS LABELED AS PUBLIC WILL BE DEDICATED AS PUBLIC AND BE MAINTAINED BY THE TOWN OF ROLESVILLE.
- 4. SANITARY SEWER EASEMENTS WILL BE DEDICATED AS PUBLIC EASEMENTS TO THE CITY OF RALEIGH.

#### STORM DRAINAGE NOTES

- 1. ALL STORM DRAINAGE PIPES SHOWN SHALL BE REINFORCED CONCRETE (RCP) (MINIMUM CLASS III) UNLESS NOTED OTHERWISE. CONTRACTOR TO COORDINATE WITH THE GEOTECH TO VERIFY TYPE OF BEDDING REQUIRED BASED ON SOIL CONDITIONS. CONTRACTOR TO SELECT REQUIRED CLASS OF PIPE BASED ON DEPTH OF PIPE AND BEDDING PROVIDED PER THE AMERICAN CONCRETE PIPE ASSOCIATION GUIDELINES.
- 2. ALL STORM DRAINAGE CONSTRUCTION SHALL BE IN ACCORDANCE WITH THE TOWN OF ROLESVILLE STANDARDS.
- 3. ALL CONCRETE SHALL MEET A MINIMUM 3000 PSI COMPRESSIVE STRENGTH.
- 4 ALL PIPE IN STORM DRAIN STRUCTURES SHALL BE STRUCK EVEN WITH INSIDE WALL.
- 5. ALL PIPE JOINTS SHALL BE MADE WITH PREFORMED JOINT SEALER, WHICH CONFORMS TO AASHTO SPECIFICATION M-198 FOR TYPE B FLEXIBLE PLASTIC GASKETS UNLESS OTHERWISE NOTED.
- 6. THE INTERIOR SURFACES OF ALL STORM DRAINAGE STRUCTURES SHALL BE POINTED UP AND SMOOTHED TO AN ACCEPTABLE STANDARD, USING MORTAR MIXED TO MANUFACTURER'S SPECIFICATIONS.
- 7. ALL BACKFILL SHALL BE NON-PLASTIC IN NATURE, FREE FROM ROOTS, VEGETATION MATTER, WASTE CONSTRUCTION MATERIAL OR OTHER OBJECTIONABLE MATERIAL. SAID MATERIAL SHALL BE CAPABLE OF BEING COMPACTED BY MECHANICAL MEANS AND SHALL HAVE NO TENDENCY TO FLOW OR BEHAVE IN A PLASTIC MANNER UNDER THE TAMPING BLOWS OR PROOF ROLLING.
- 8. MATERIALS DEEMED BY THE OWNER'S REPRESENTATIVE OR GEOTECH AS UNSUITABLE FOR BACKFILL PURPOSES SHALL BE REMOVED AND REPLACED WITH SUITABLE MATERIAL.
- 9. BACKFILLING OF TRENCHES SHALL BE ACCOMPLISHED IMMEDIATELY AFTER PIPE IS LAID. THE FILL AROUND THE PIPE SHALL BE THOROUGHLY COMPACTED TO 95 % OF THE MAXIMUM DRY DENSITY OBTAINABLE WITH THE STANDARD PROCTOR TEST. THE TOP EIGHT (8) INCHES SHALL BE COMPACTED TO 100 PERCENT STANDARD PROCTOR.
- 10. UNDER NO CIRCUMSTANCES SHALL WATER BE ALLOWED TO RISE IN UNBACKFILLED TRENCHES AFTER PIPE HAS BEEN PLACED.
- 11. ALL CONCRETE PIPE AND PRECAST STORM STRUCTURES SHALL MEET NCDOT STANDARDS BY MANUFACTURER.
- CONTRACTOR SHALL BE RESPONSIBLE FOR CHECKING ALL PIPE AND STRUCTURES FOR CRACKS OR BREAKS, PRIOR TO INSTALLATION.
  ANY DAMAGED ITEMS SHALL NOT BE INSTALLED.

#### **GRADING NOTES**

- 1. ALL DIMENSIONS AND GRADES SHOWN ON THE PLANS SHALL BE FIELD VERIFIED BY THE CONTRACTOR PRIOR TO CONSTRUCTION. CONTRACTOR SHALL NOTIFY THE ENGINEER IF ANY DISCREPANCIES EXIST PRIOR TO PROCEEDING WITH CONSTRUCTION, FOR NECESSARY PLAN OR GRADE CHANGES. NO EXTRA COMPENSATION SHALL BE PAID TO THE CONTRACTOR FOR ANY WORK DONE DUE TO DIMENSIONS OR GRADES SHOWN INCORRECTLY ON THESE PLANS IF SUCH NOTIFICATION HAS NOT BEEN GIVEN.
- OCCUPATIONAL SAFETY AND HEALTH ADMINISTRATION (OSHA) STANDARDS FOR EXCAVATIONS; FINAL RULE 29CFR PART 1926, SUBPART "P" APPLIES TO ALL EXCAVATIONS EXCEEDING FIVE (5) FEET IN DEPTH EXCAVATION EXCEEDING TWENTY (20) FEET IN DEPTH REQUIRES THE DESIGN OF A TRENCH SAFETY SYSTEM BY A REGISTERED PROFESSIONAL ENGINEER, PROVIDED BY CONTRACTOR RESPONSIBLE FOR EXCAVATION.
- 3. ALL CONSTRUCTION SHALL BE IN ACCORDANCE WITH THE TOWN OF ROLESVILLE AND/OR NCDOT STANDARDS AND SPECIFICATIONS AS APPLICABLE.
- 4. CONTRACTOR SHALL NOTIFY "NC811" (811) OR (1-800-632-4949) AT LEAST 3 FULL BUSINESS DAYS PRIOR TO BEGINNING CONSTRUCTION OR EXCAVATION TO HAVE EXISTING UTILITIES LOCATED. CONTRACTOR SHALL CONTACT ANY LOCAL UTILITIES THAT PROVIDE THEIR OWN LOCATOR SERVICES INDEPENDENT OF "NC811". REPORT ANY DISCREPANCIES TO THE ENGINEER IMMEDIATELY.
- 5. CONSTRUCTION, MAINTENANCE AND REMOVAL OF ALL EROSION CONTROL DEVICES ARE THE RESPONSIBILITY OF THE GENERAL CONTRACTOR. TIMING OF REMOVAL SHALL BE COORDINATED WITH THE EROSION CONTROL INSPECTOR.
- 6. EXISTING UTILITIES AND STRUCTURES SHOWN, BOTH UNDERGROUND AND ABOVE GROUND, ARE BASED ON A FIELD SURVEY AND THE BEST AVAILABLE RECORD DRAWINGS. THE CONTRACTOR SHALL VERIFY FIELD CONDITIONS PRIOR TO BEGINNING RELATED CONSTRUCTION. ANY DISCREPANCIES SHALL BE REPORTED TO THE ENGINEER IMMEDIATELY.
- 7. SOIL UNDER BUILDINGS, PAVED AREAS AND WITHIN SLOPES GREATER THAN 3:1 (H:V) SHALL BE APPROVED, PLACED AND COMPACTED AS RECOMMENDED BY THE GEOTECHNICAL ENGINEER.

#### RETAINING WALL NOTES

- 1. THE RETAINING WALL ALIGNMENT SHOWN ON THESE PLANS DEPICTS THE LOCATION OF THE FRONT FACE OF THE RETAINING WALL AT THE TOP OF THE WALL. THE CONTRACTOR IS RESPONSIBLE FOR ENSURING RETAINING WALLS ARE NOT LOCATED IN ANY STREAM BUFFERS, AND THEIR CONSTRUCTION DOES NOT ENCROACH INTO ANY ADJACENT PROPERTIES DUE TO ANY BATTER INCORPORATED IN THE DESIGN OF THE WALLS.
- 2. RETAINING WALLS ARE TO BE DESIGN-BUILD PROJECTS BY THE CONTRACTOR. IT SHALL BE THE CONTRACTOR'S RESPONSIBILITY TO OBTAIN FINAL CONSTRUCTION DRAWINGS FROM A REGISTERED ENGINEER AND GAIN ALL REQUIRED PERMITS NECESSARY FOR THE CONSTRUCTION OF THE RETAINING WALLS.
- 3. RETAINING WALLS SHALL BE ASSUMED TO BE BACKFILLED WITH OFF-SITE BORROW MATERIAL OR PROCESSED FILL, UNLESS THE CONTRACTOR CAN PROVIDE TO THE OWNER WITH CONFIRMATION FROM THE GEOTECHNICAL ENGINEER AND THE RETAINING WALL DESIGNER, THAT READILY AVAILABLE ON-SITE SOILS CAN BE USED.
- 4. THE TOP AND BOTTOM OF WALL ELEVATIONS SHOWN ON THESE PLANS IDENTIFY FINISHED GRADE ELEVATIONS ONLY. THE EXTENT THAT THE RETAINING WALL WILL BE EXTENDED BELOW GRADE TO THE FOOTING OR ABOVE GRADE TO THE TOP OF THE CAP BLOCK COURSE SHALL BE IDENTIFIED ON THE RETAINING WALL CONSTRUCTION
- 5. ALL RETAINING WALLS OVER 30" HIGH SHALL HAVE A SAFETY FENCE (DESIGN BY OTHERS).
- 6. ANY TIEBACK SYSTEMS FOR THE RETAINING WALLS SHALL NOT BE ALLOWED WITHIN PUBLIC RIGHT-OF-WAY.

DETAILS & SPECIFICATIONS (REFERENCE: CORPUD HANDBOOK, CURRENT EDITION)

## CITY OF RALEIGH PUBLIC UTILITIES STANDARD UTILITY NOTES (AS APPLICABLE)

- 1. ALL MATERIALS & CONSTRUCTION METHODS SHALL BE IN ACCORDANCE WITH CITY OF RALEIGH DESIGN STANDARDS,
- 2. UTILITY SEPARATION REQUIREMENTS:
- a. A DISTANCE OF 100' SHALL BE MAINTAINED BETWEEN SANITARY SEWER & ANY PRIVATE OR PUBLIC WATER SUPPLY SOURCE SUCH AS AN IMPOUNDED RESERVOIR USED AS A SOURCE OF DRINKING WATER. IF ADEQUATE LATERAL SEPARATION CANNOT BE ACHIEVED, FERROUS SANITARY SEWER PIPE SHALL BE SPECIFIED & INSTALLED TO WATERLINE SPECIFICATIONS. HOWEVER, THE MINIMUM SEPARATION SHALL NOT BE LESS THAN 25' FROM A PRIVATE WELL OR 50' FROM A PUBLIC WELL.
- b. When installing water &/or sewer mains, the horizontal separation between utilities shall be 10'. If this separation cannot be maintained due to existing conditions, the variation allowed is the water main in a separate trench with the elevation of the water main at least 18" above the top of the sewer & must be approved by the public utilities director. All distances are measured from outside diameter to outside diameter to
- c. WHERE IT IS IMPOSSIBLE TO OBTAIN PROPER SEPARATION, OR ANYTIME A SANITARY SEWER PASSES OVER A WATERMAIN, DIP MATERIALS OR STEEL ENCASEMENT EXTENDED 10' ON EACH SIDE OF CROSSING MUST BE SPECIFIED & INSTALLED TO WATERLINE SPECIFICATIONS.
- d. 5.0' MINIMUM HORIZONTAL SEPARATION IS REQUIRED BETWEEN ALL SANITARY SEWER & STORM SEWER FACILITIES, UNLESS DIP MATERIAL IS SPECIFIED FOR SANITARY SEWER.
- e. MAINTAIN 18" MIN. VERTICAL SEPARATION AT ALL WATERMAIN & RCP STORM DRAIN CROSSINGS; MAINTAIN 18" MIN. VERTICAL SEPARATION AT ALL SANITARY SEWER & RCP STORM DRAIN CROSSINGS. WHERE ADEQUATE SEPARATIONS CANNOT BE ACHIEVED, SPECIFY DIP MATERIALS & A CONCRETE CRADLE HAVING 6" MIN. CLEARANCE (PER CORPUD DETAILS W-41 & CONCRETE CRADLE HAVING 6" MIN. CLEARANCE (PER CORPUD DETAILS W-41 & CONCRETE CRADLE HAVING 6" MIN. CLEARANCE (PER CORPUD DETAILS W-41 & CONCRETE CRADLE HAVING 6" MIN. CLEARANCE (PER CORPUD DETAILS W-41 & CONCRETE CRADLE HAVING 6" MIN. CLEARANCE (PER CORPUD DETAILS W-41 & CONCRETE CRADLE HAVING 6" MIN. CLEARANCE (PER CORPUD DETAILS W-41 & CONCRETE CRADLE HAVING 6" MIN. CLEARANCE (PER CORPUD DETAILS W-41 & CONCRETE CRADLE HAVING 6" MIN. CLEARANCE (PER CORPUD DETAILS W-41 & CONCRETE CRADLE HAVING 6" MIN. CLEARANCE (PER CORPUD DETAILS W-41 & CONCRETE CRADLE HAVING 6" MIN. CLEARANCE (PER CORPUD DETAILS W-41 & CONCRETE CRADLE HAVING 6" MIN. CLEARANCE (PER CORPUD DETAILS W-41 & CONCRETE CRADLE HAVING 6" MIN. CLEARANCE (PER CORPUD DETAILS W-41 & CONCRETE CRADLE HAVING 6" MIN. CLEARANCE (PER CORPUD DETAILS W-41 & CONCRETE CRADLE HAVING 6" MIN. CLEARANCE (PER CORPUD DETAILS W-41 & CONCRETE CRADLE HAVING 6" MIN. CLEARANCE (PER CORPUD DETAILS W-41 & CONCRETE CRADLE HAVING 6" MIN. CLEARANCE (PER CORPUD DETAILS W-41 & CONCRETE CRADLE HAVING 6" MIN. CLEARANCE (PER CORPUD DETAILS W-41 & CONCRETE CRADLE HAVING M-41 & CONCRETE CR
- f. ALL OTHER UNDERGROUND UTILITIES SHALL CROSS WATER & SEWER FACILITIES WITH 18" MIN. VERTICAL SEPARATION
- 3. ANY NECESSARY FIELD REVISIONS ARE SUBJECT TO REVIEW & APPROVAL OF AN AMENDED PLAN &/OR PROFILE BY THE CITY OF RALEIGH PUBLIC UTILITIES DEPARTMENT PRIOR TO CONSTRUCTION.
- 4. CONTRACTOR SHALL MAINTAIN CONTINUOUS WATER & SEWER SERVICE TO EXISTING RESIDENCES & BUSINESSES THROUGHOUT CONSTRUCTION OF PROJECT. ANY NECESSARY SERVICE INTERRUPTIONS SHALL BE PRECEDED BY A 24 HOUR ADVANCE NOTICE TO THE CITY OF RALEIGH PUBLIC UTILITIES DEPARTMENT.
- 5. 3.0' MINIMUM COVER IS REQUIRED ON ALL WATER MAINS & SEWER FORCEMAINS. 4.0' MINIMUM COVER IS REQUIRED ON ALL REUSE MAINS.
- 6. IT IS THE DEVELOPER'S RESPONSIBILITY TO ABANDON OR REMOVE EXISTING WATER & SEWER SERVICES NOT BEING USED IN REDEVELOPMENT OF A SITE UNLESS OTHERWISE DIRECTED BY THE CITY OF RALEIGH PUBLIC UTILITIES DEPARTMENT. THIS INCLUDES ABANDONING TAP AT MAIN & REMOVAL OF SERVICE FROM ROW OR EASEMENT PER CORPUD HANDBOOK PROCEDURE.
- 7. INSTALL 3/4" COPPER WATER SERVICES WITH METERS LOCATED AT ROW OR WITHIN A 2'X2' WATERLINE EASEMENT IMMEDIATELY ADJACENT. NOTE: IT IS THE APPLICANT'S RESPONSIBILITY TO PROPERLY SIZE THE WATER SERVICE FOR EACH CONNECTION TO PROVIDE ADEQUATE FLOW & PRESSURE.
- 8. INSTALL 4" PVC SEWER SERVICES @ 1.0% MINIMUM GRADE WITH CLEANOUTS LOCATED AT ROW OR EASEMENT LINE & SPACED EVERY 75 LINEAR FEET MAXIMUM.
- 9. PRESSURE REDUCING VALVES ARE REQUIRED ON ALL WATER SERVICES EXCEEDING 80 PSI; BACKWATER VALVES ARE REQUIRED ON ALL SANITARY SEWER SERVICES HAVING BUILDING DRAINS LOWER THAN 1.0' ABOVE THE NEXT UPSTREAM MANHOLE.
- 10. ALL ENVIRONMENTAL PERMITS APPLICABLE TO THE PROJECT MUST BE OBTAINED FROM NCDWQ, USACE &/OR FEMA FOR ANY RIPARIAN BUFFER, WETLAND &/OR FLOODPLAIN IMPACTS (RESPECTIVELY) PRIOR TO CONSTRUCTION.
- 11. NCDOT / RAILROAD ENCROACHMENT AGREEMENTS ARE REQUIRED FOR ANY UTILITY WORK (INCLUDING MAIN EXTENSIONS & SERVICE TAPS) WITHIN STATE OR RAILROAD ROW PRIOR TO CONSTRUCTION.
- 12. GREASE INTERCEPTOR / OIL WATER SEPARATOR SIZING CALCULATIONS & INSTALLATION SPECIFICATIONS SHALL BE APPROVED BY THE CORPUD FOG PROGRAM COORDINATOR PRIOR TO ISSUANCE OF A BUILDING PERMIT. CONTACT TIM BEASLEY AT (919) 996-2334 OR TIMOTHY.BEASLEY@RALEIGHNC.GOV FOR MORE INFORMATION.
- 13. CROSS-CONNECTION CONTROL PROTECTION DEVICES ARE REQUIRED BASED ON DEGREE OF HEALTH HAZARD INVOLVED AS LISTED IN APPENDIX-B OF THE RULES GOVERNING PUBLIC WATER SYSTEMS IN NORTH CAROLINA. THESE GUIDELINES ARE THE MINIMUM REQUIREMENTS. THE DEVICES SHALL MEET AMERICAN SOCIETY OF SANITARY ENGINEERING (ASSE) STANDARDS OR BE ON THE UNIVERSITY OF SOUTHERN CALIFORNIA APPROVAL LIST. THE DEVICES SHALL BE INSTALLED AND TESTED (BOTH INITIAL AND PERIODIC TESTING THEREAFTER) IN ACCORDANCE WITH THE MANUFACTURER'S RECOMMENDATIONS OR THE LOCAL CROSS-CONNECTION CONTROL PROGRAM, WHICHEVER IS MORE STRINGENT. CONTACT JOANIE HARTLEY AT (919) 996-5923 OR JOANIE.HARTLEY@RALEIGHNC.GOV FOR MORE INFORMATION.

#### SETBACKS

# R3 PUD FRONT (FRONT LOAD) 20 FT FRONT (ALLEY LOAD) 10 FT

FRONT (FRONT LOAD) | 20 FT
FRONT (ALLEY LOAD) | 10 FT
SIDE | 5 FT
AGGREGATE SIDE | 10 FT
CORNER SIDE | 10 FT
REAR (FRONT LOAD) | 15 FT
REAR (ALLEY LOAD) | 5 FT (RIGHT-OF-WAY)
MIN LOT WIDTH | 26 FT (FRONT) 20 FT (ALLEY)

#### SITE AND OPEN SPACE AREAS

TOTAL SITE AREA	23.38 AC
RETAIL	0.00 AC
RESIDENTIAL	23.38 AC
R3 PUD	140 PROPOSED TOWNHOMES
TOTAL UNITS	140
OVERALL DENSITY	5.99 DU/AC
TOWNHOME AREA	23.38 AC
TOWNHOME DENSITY	5.99 DU/AC
ALLOWED DENSITY	10 DU/AC (TOWNHOME)
TOTAL IMPERVIOUS	562,727 SF (12.09 AC)
	15% OF TOTAL SITE AREA REQUIRED
OPEN SPACE	3.50 AC REQUIRED
	8.89 AC PROVIDED
TOWNHOMES	
15% TH AREA (23.38 AC)	3.50 ACRES REQUIRED
35% ACTIVE OS AREA (3.50 AC)	1.23 ACRES REQUIRED
, i	
TOTAL OPEN SPACE REQUIRED:	3.50 AC
TOTAL OREN CD4 OF DD 01/10 FD	4.00.40.104000.450.0050.455
TOTAL OPEN SPACE PROVIDED:	1.80 AC IMPROVED OPEN SPACE
	7.09 AC UNIMPROVED OPEN SPACE
	8.89 AC TOTAL OPEN SPACE PROVIDED
· · · · · · · · · · · · · · · · · · ·	

## REQUIRED TOWNHOME PARKING

TOTAL UNITS TOTAL 3 BEDROOM UNITS	140 124	
(2 SPACES/TH + 0.5 SPACES PER BEDROOM OVER 2) = TOTAL 4 BEDROOM UNITS	(124 x 2) + (124 x 0.5) = 310 16	
(2 SPACES/TH + 0.5 SPACES PER BEDROOM OVER 2) = VISITOR PARKING MAIL KIOSK PARKING	(16 x 2) + (16 x 0.5) +(16 x 0.5)= 48 140 UNITS/4 = 35 SPACES 6 (SEE MAIL KIOSK	
TOTAL REQUIRED PARKING	CALCULATION TABLE) 399 SPACES	
PROVIDED PARKING: GARAGE PARKING	140 x 2 = 280	
DRIVEWAY PARKING STREET PARKING	140 x 1 =140 0	
MAIL KIOSK PARKING	13	

46 (12 AMENITY, 34 GUEST)

479 SPACES

#### NAAU KIOCK CALCUU ATION


PARKING LOT SPACES

TOTAL PARKING PROVIDED


MAIL KIOSK CALCUL	KIOSK CALCULATIONS		
NUMBER OF MAIL BOXES(UNITS) 52 OR LESS 53-78 79-104 105 OR MORE	REQUIRED PARKING SPACES 2 3 4 4 PLUS 1 PER EACH ADDITIONAL 26 MAILBOXES		
MAIL KIOSK AREA  MAIL KIOSK CALCULATION:  140 UNITS @ 16 UNITS/KIOSK (CBU) = 9 KIOSKS (CBUs)  MAIL KIOSK PARKING: 140 UNITS			

REQUIRED: 6 SPACES

PROVIDED: 13 SPACES (2 ACCESSIBLE)

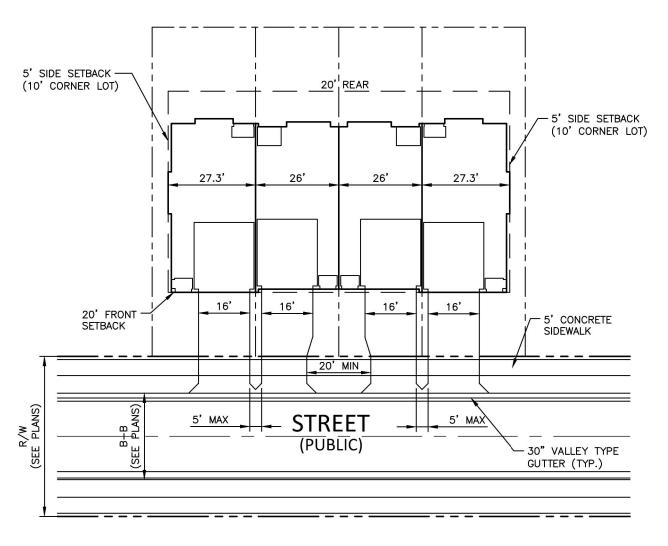

# TYPICAL TOWNHOME LAYOUT (FRONT LOADED UNITS) SCALE: 1" = 30'

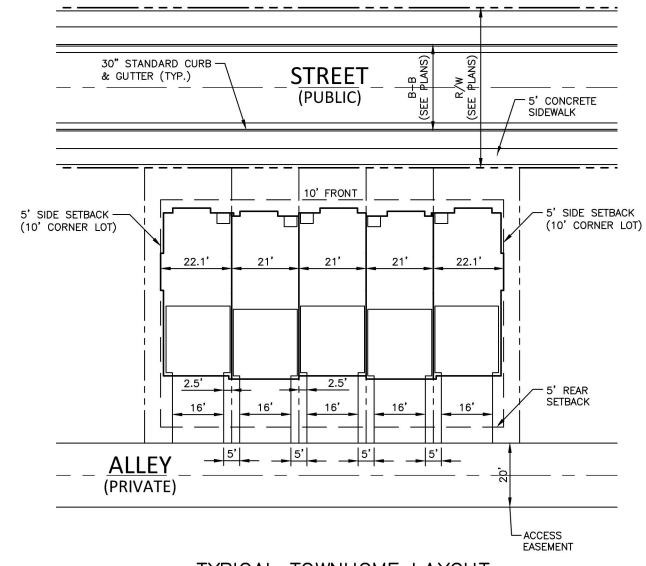

TYPICAL TOWNHOME LAYOUT

(ALLEY LOADED UNITS)

# McAdams

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CONSTRUCTION DRAWINGS



#### **REVISIONS**

NO. DATE

#### PLAN INFORMATION

PROJECT NO. CPR-19100

FILENAME CPR19100-CD-N1

CHECKED BY WTO

DRAWN BY JMS


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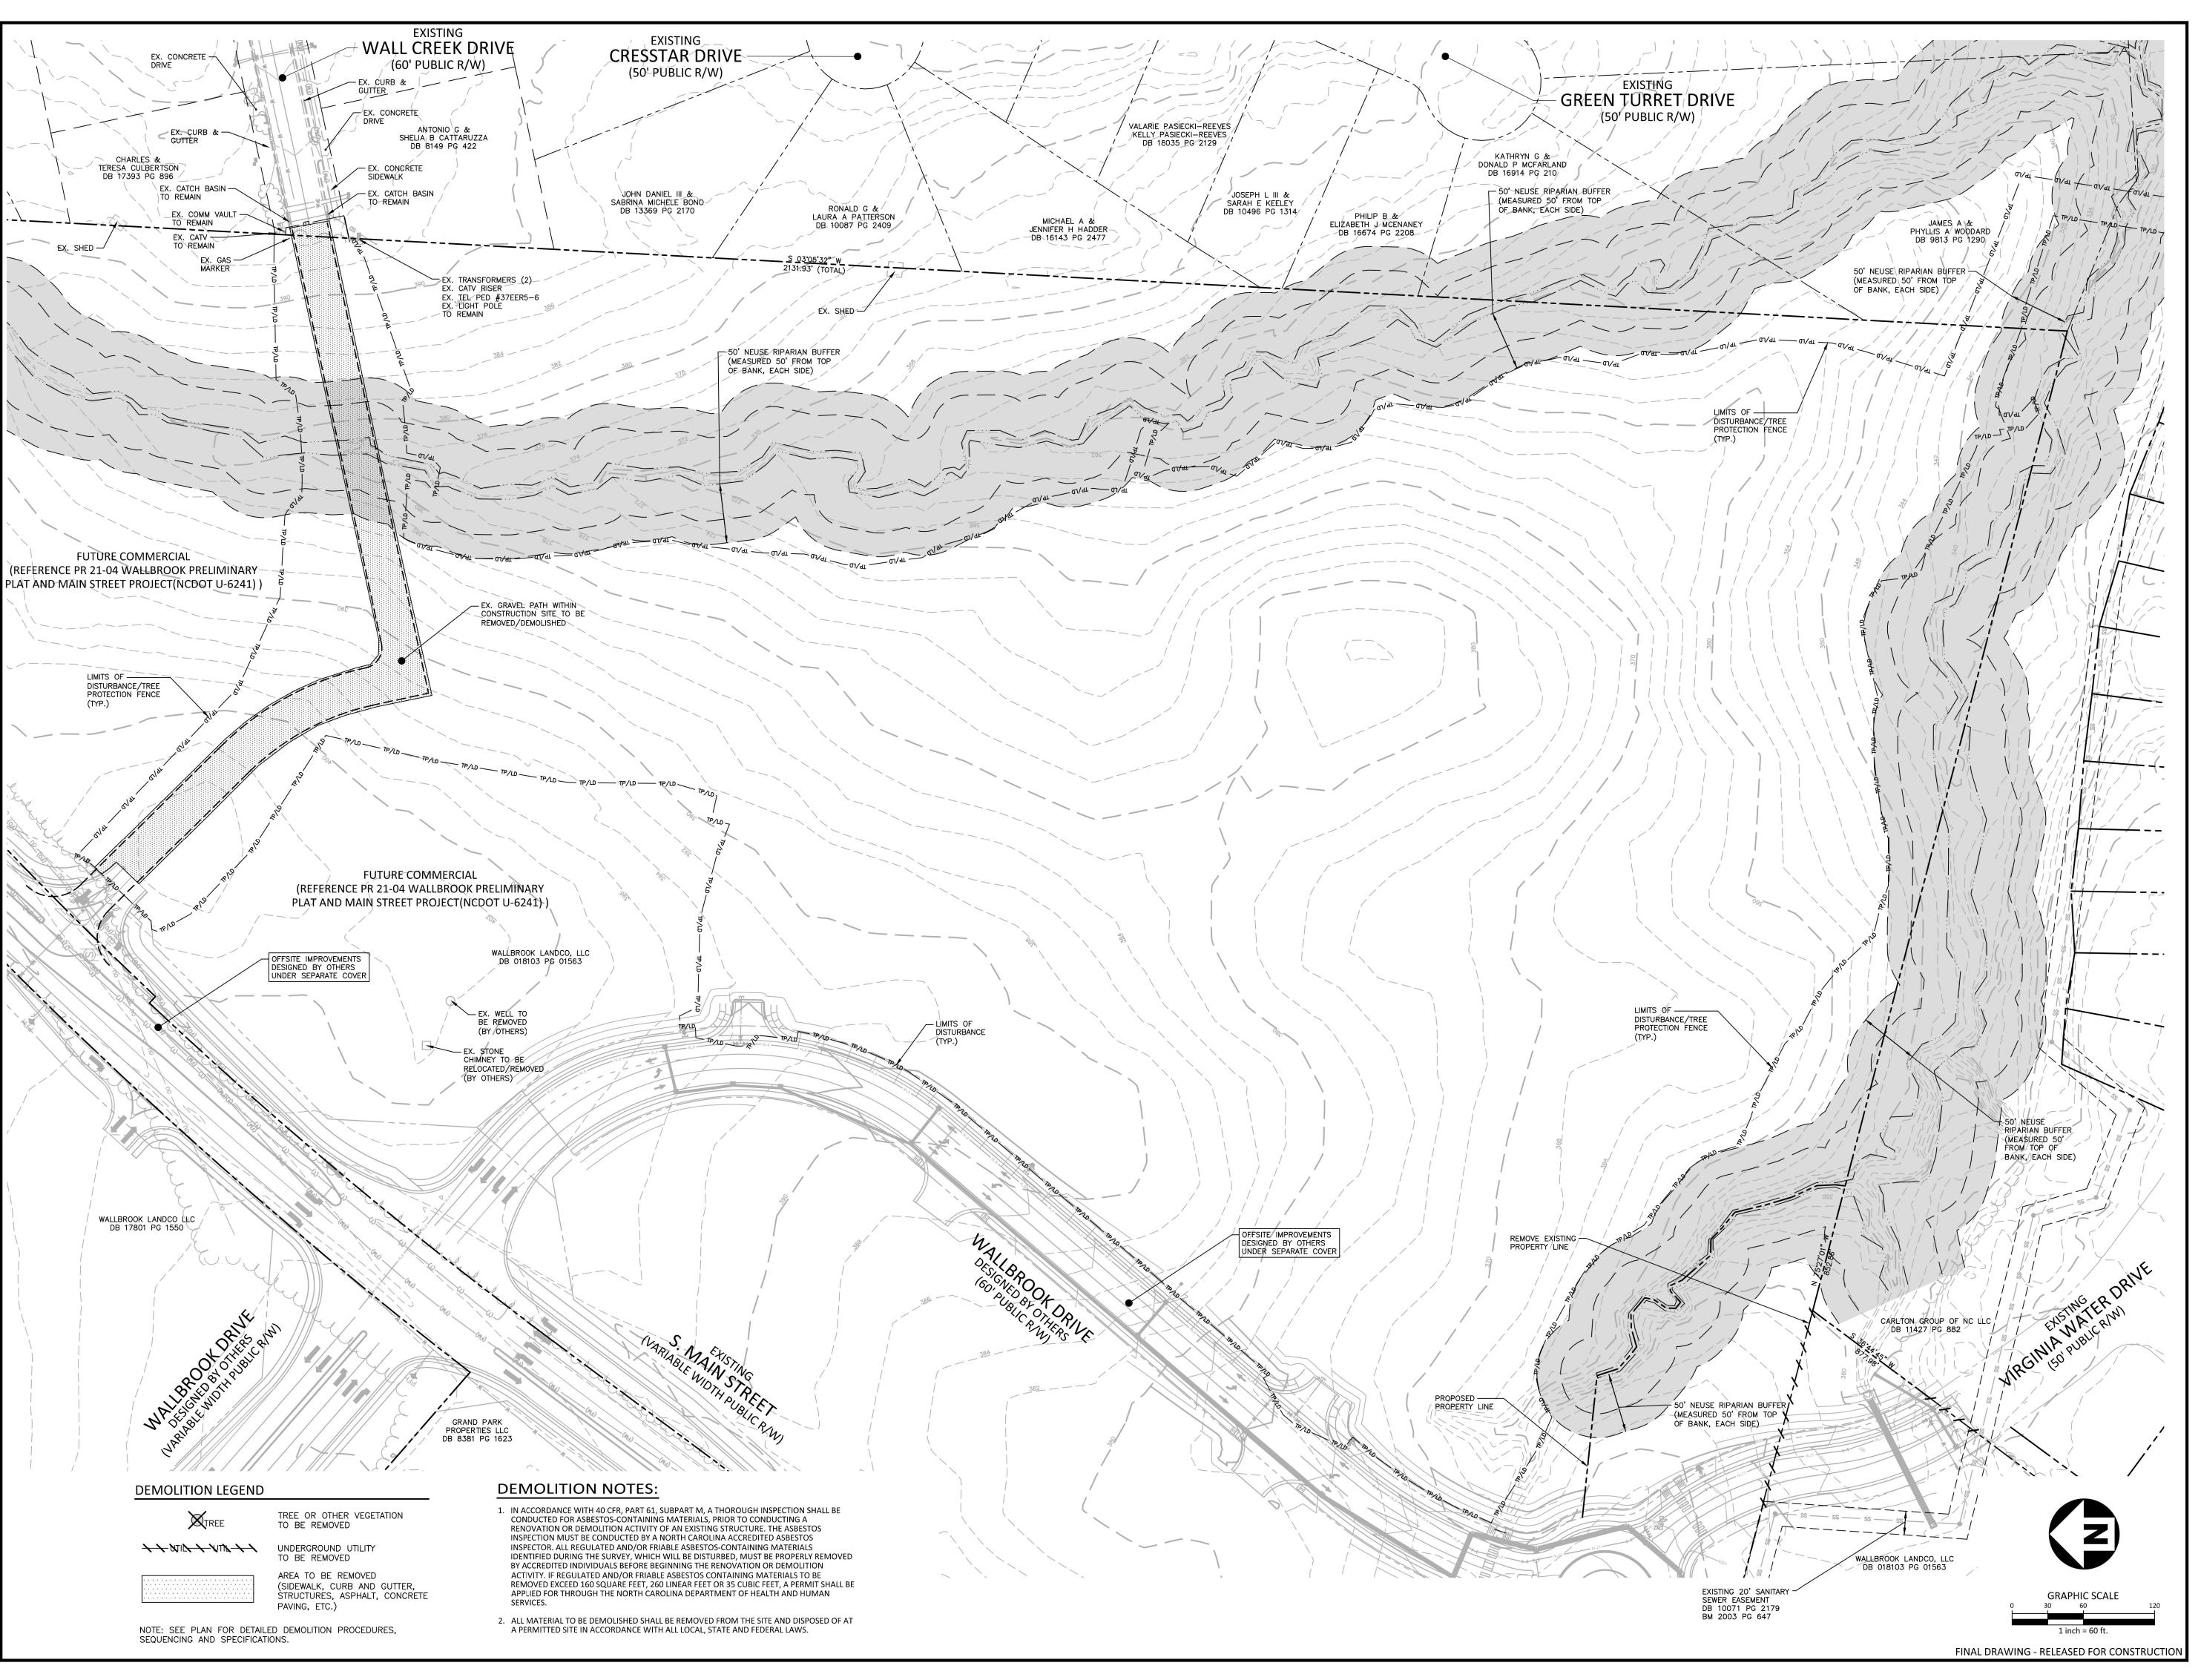
SCALE --DATE 05. 22. 2023
SHEET

FINAL DRAWING - RELEASED FOR CONSTRUCTION

PROJECT NOTES

C0.00



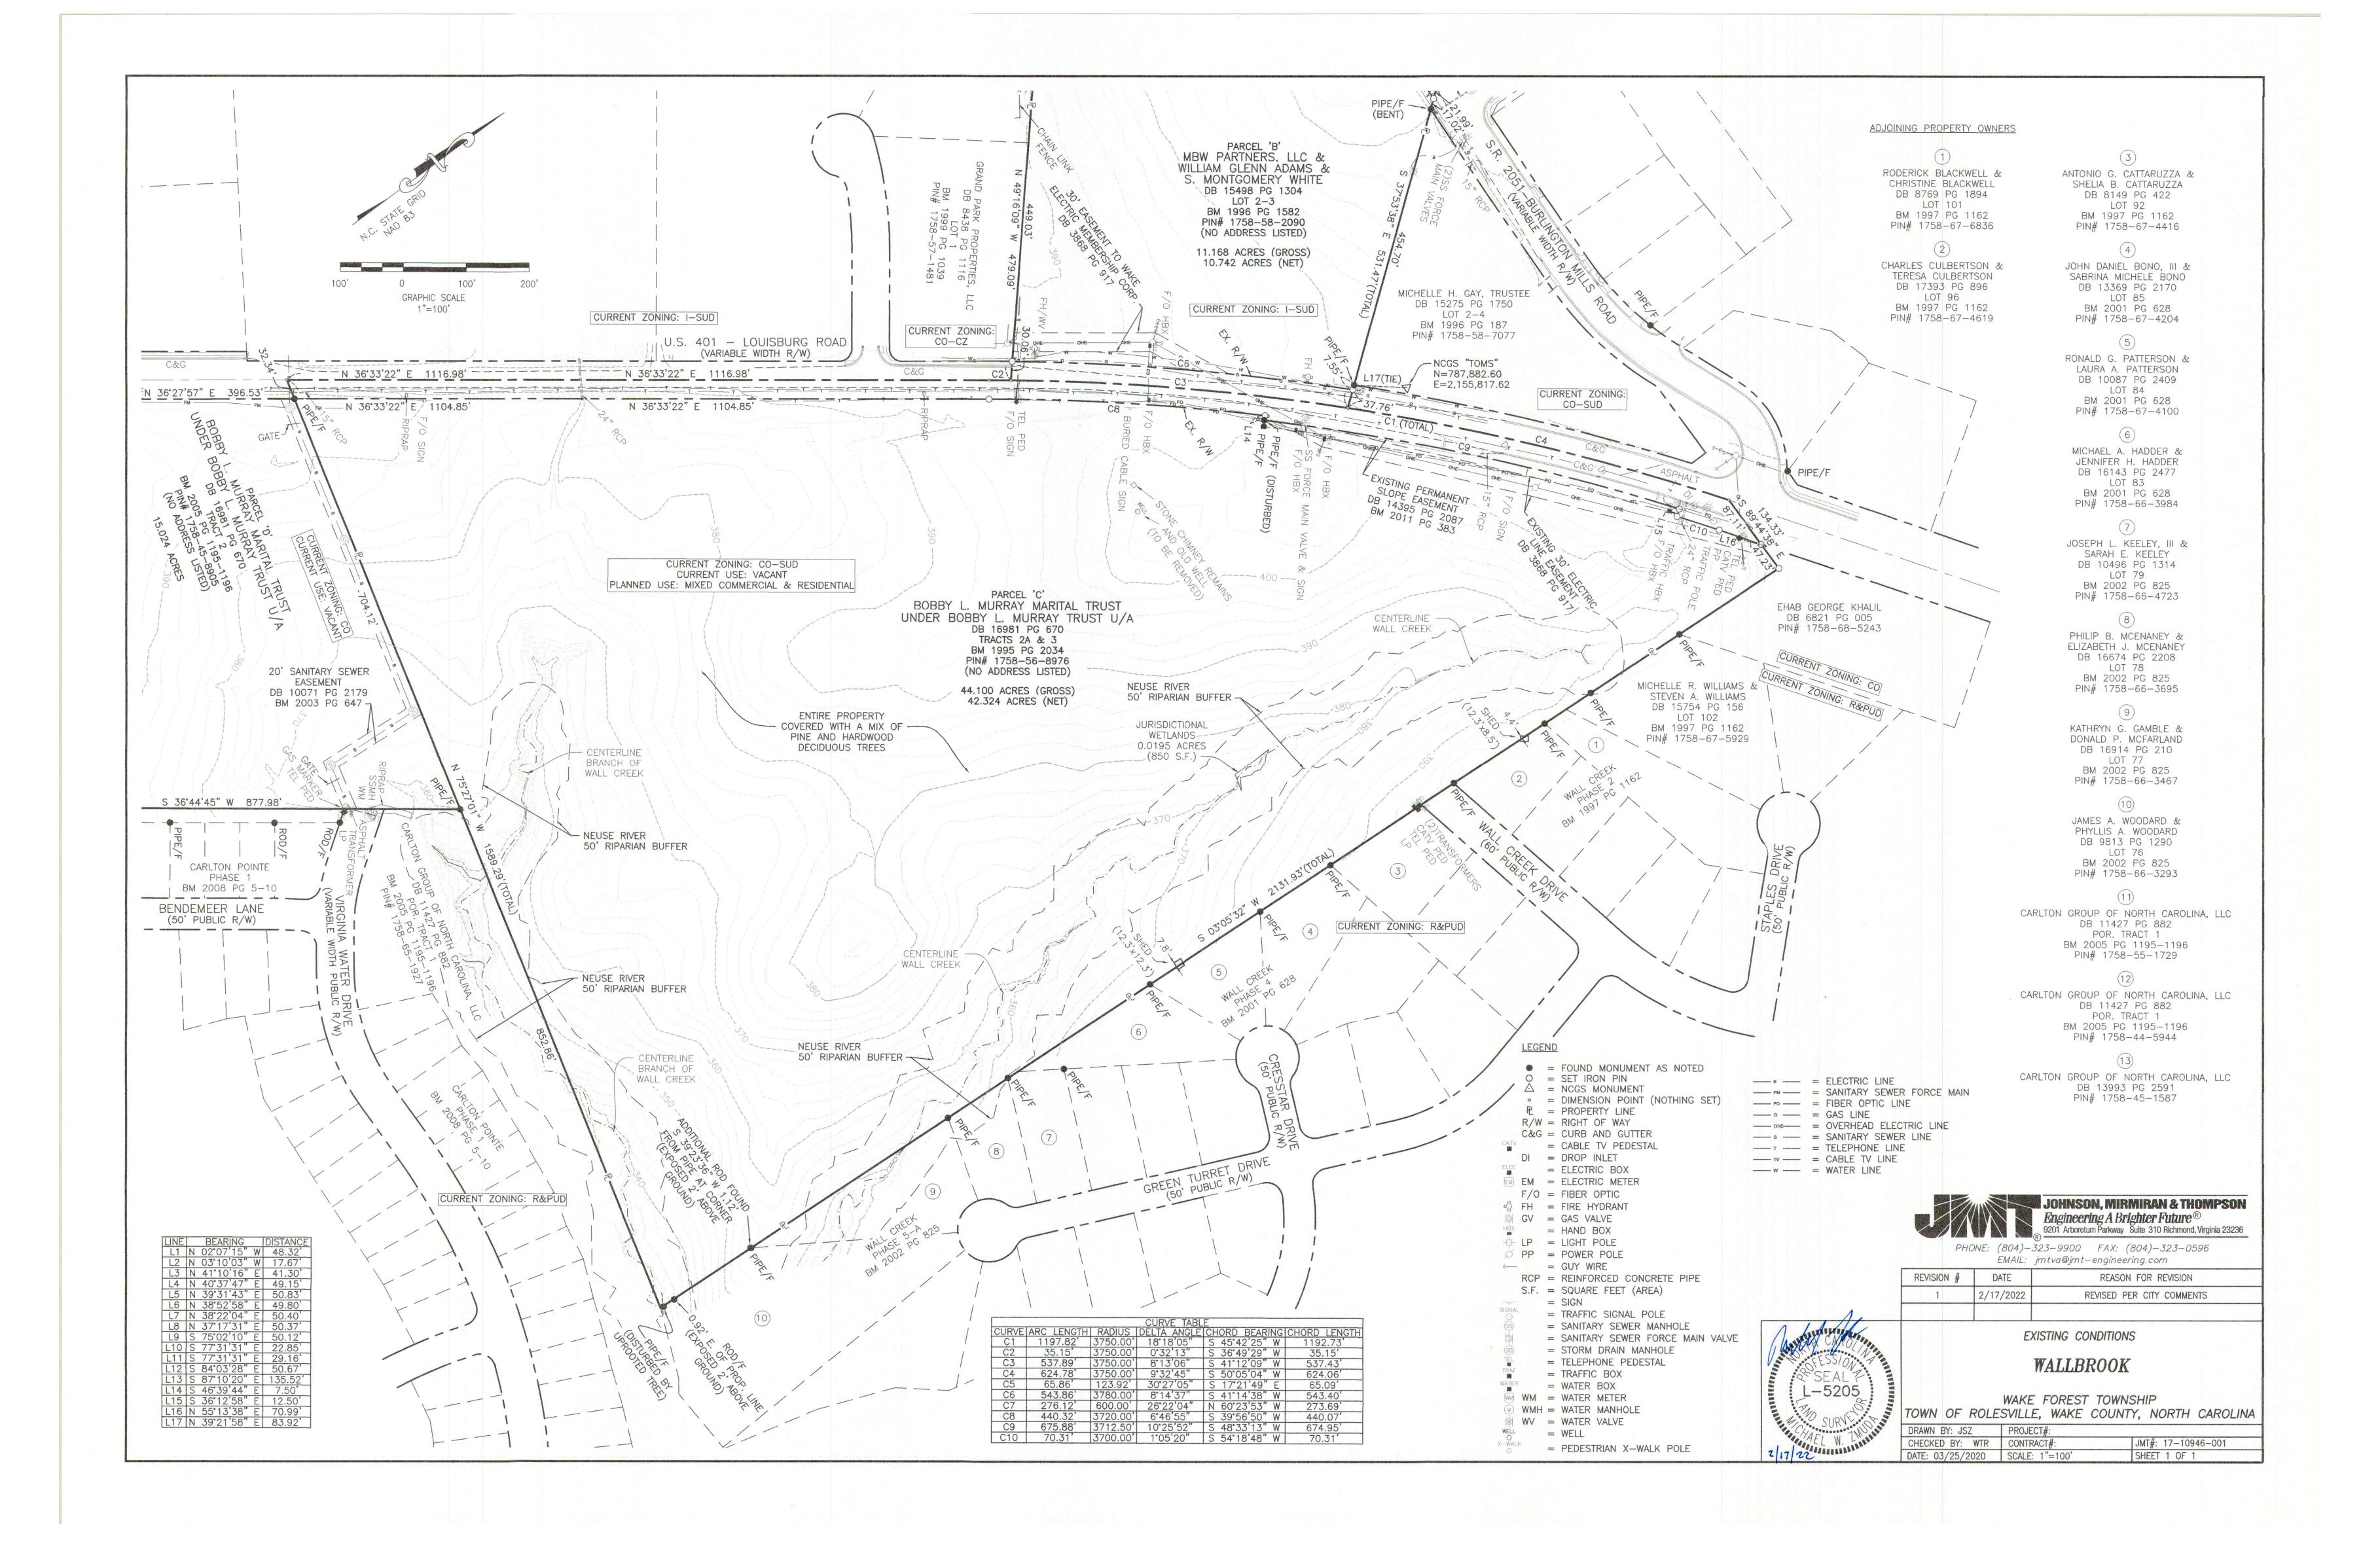



# McAdam


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# WALLBKOOK ONSTRUCTION DRAWINGS ROLESVILLE, NORTH CAROLINA



### **REVISIONS**

NO. DATE

#### PLAN INFORMATION

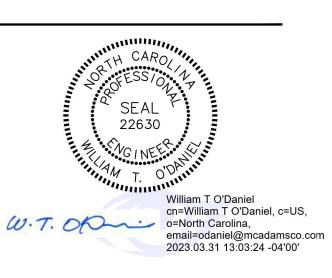PROJECT NO. CPR-19100

FILENAME CPR19100-CD-DM1

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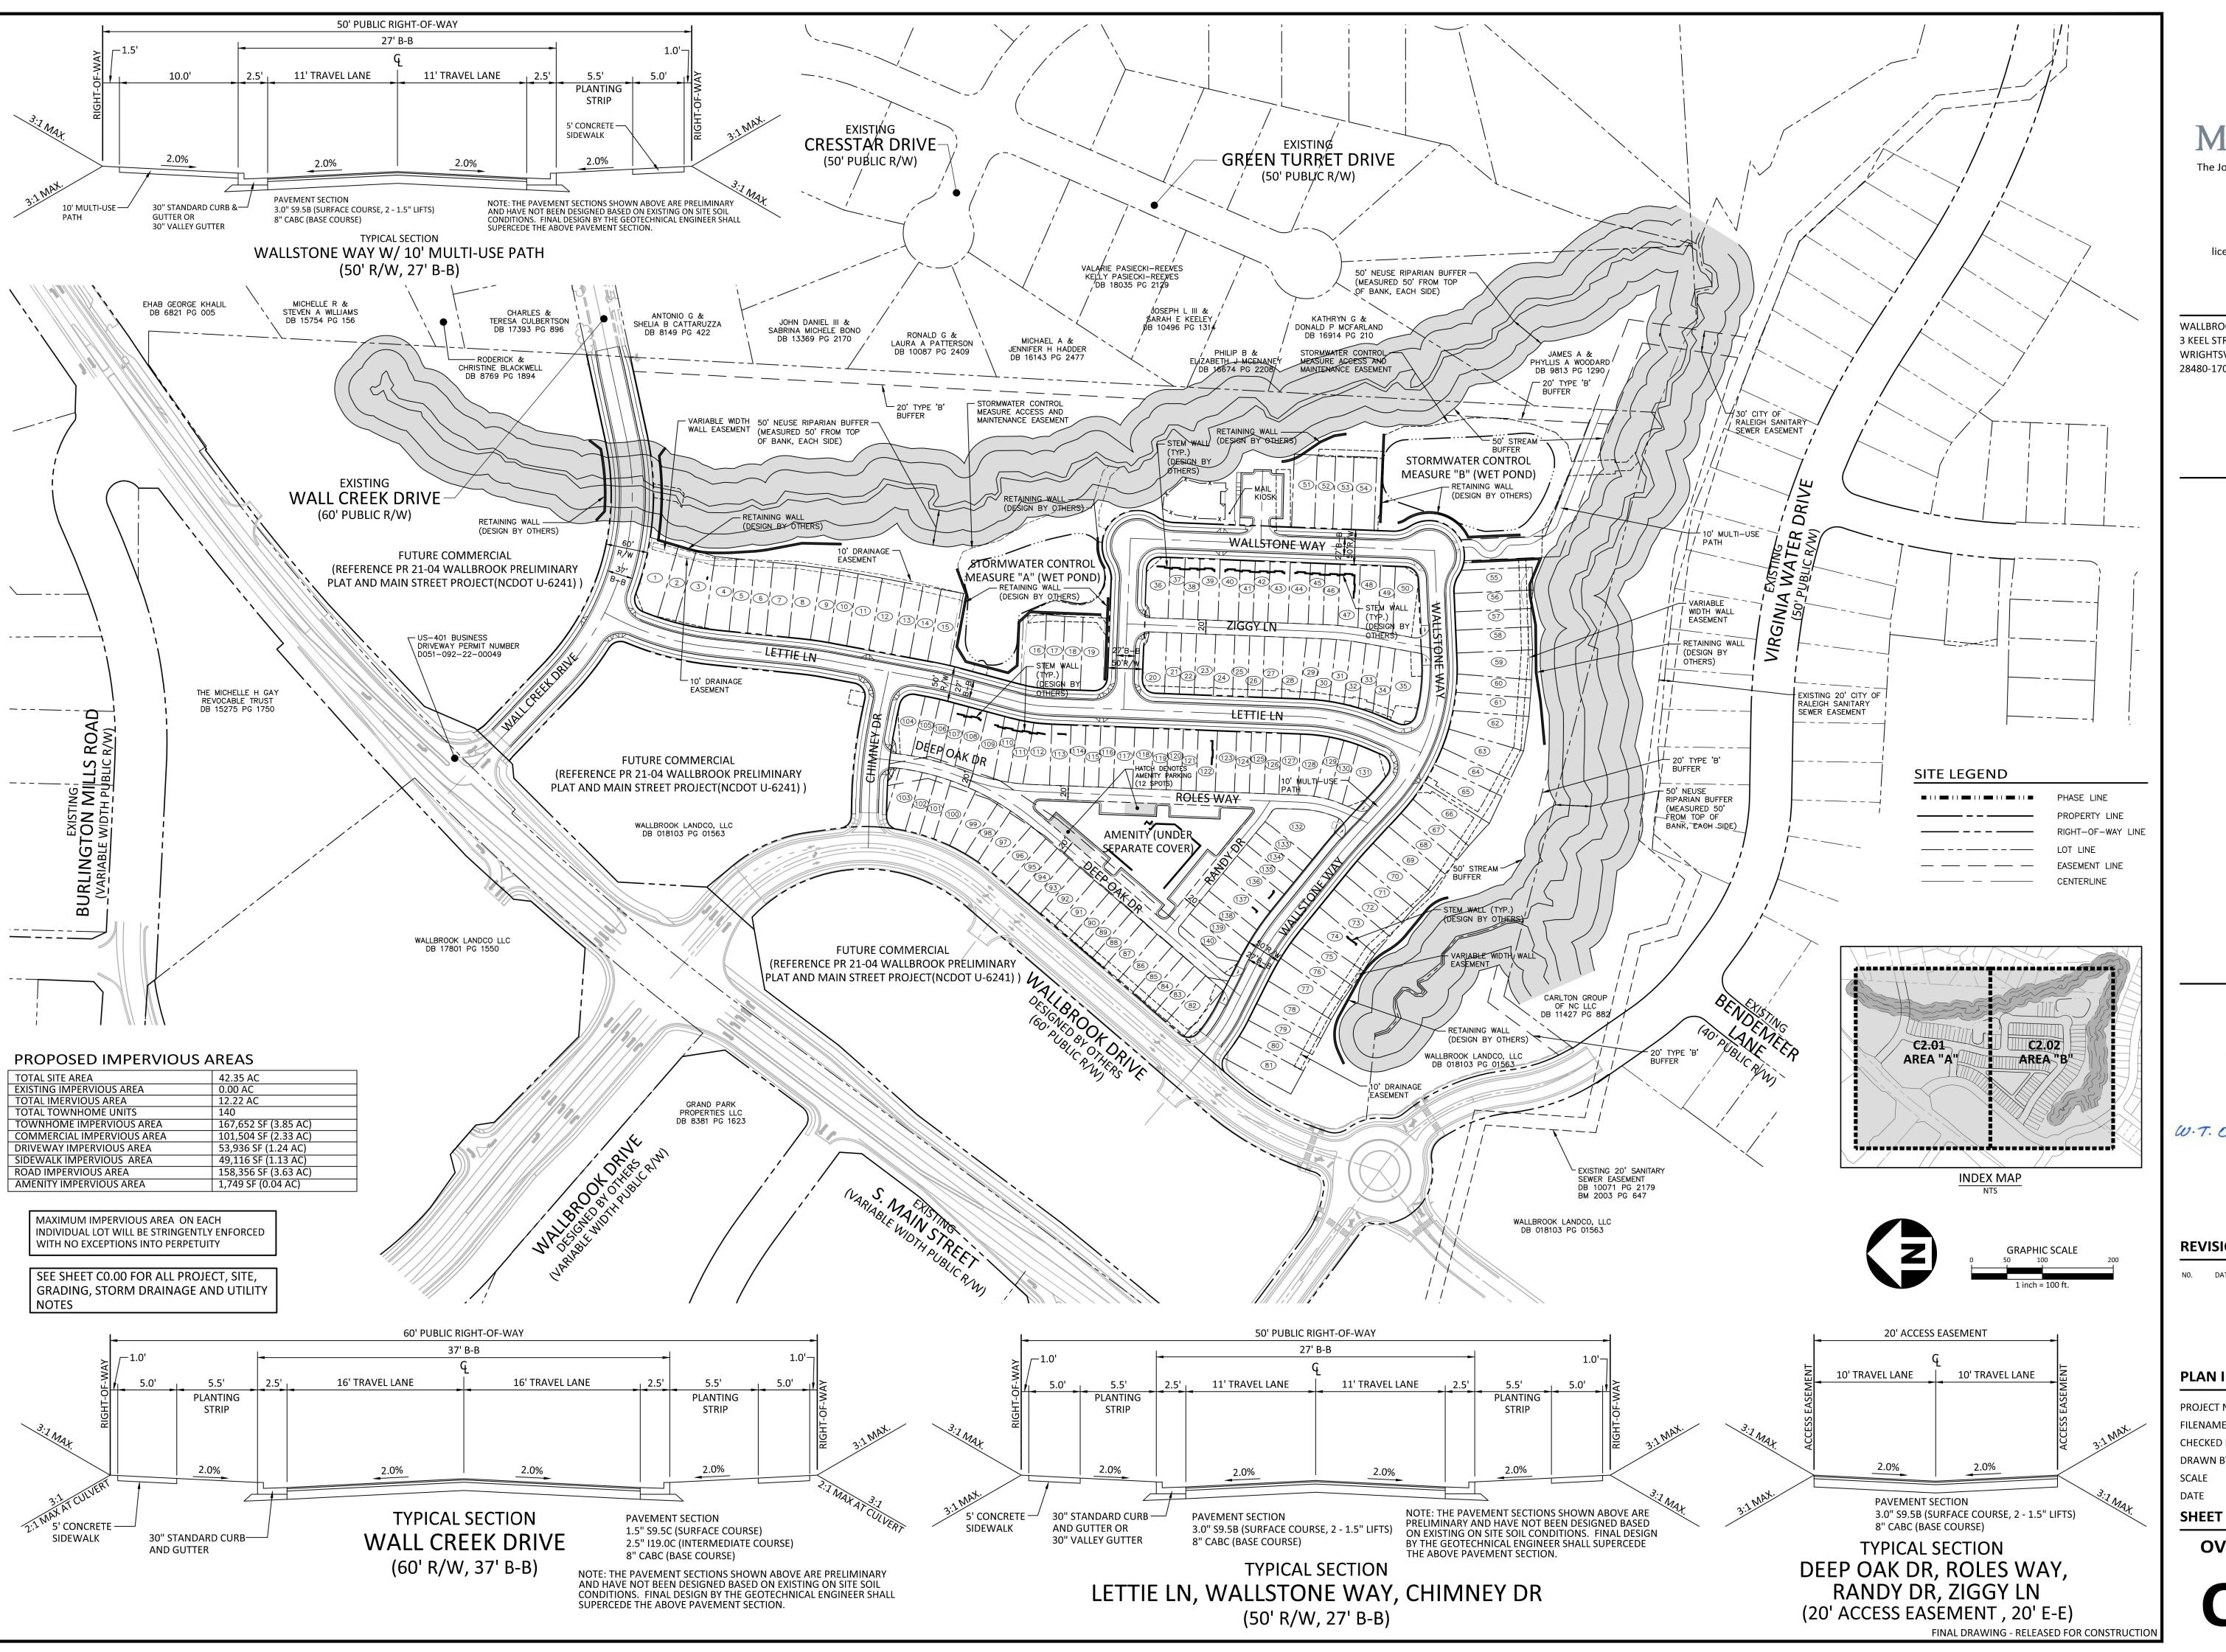
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SCALE 1"=60'

DATE 03. 31. 2023 **SHEET** 

DEMOLITION PLAN

C1.01





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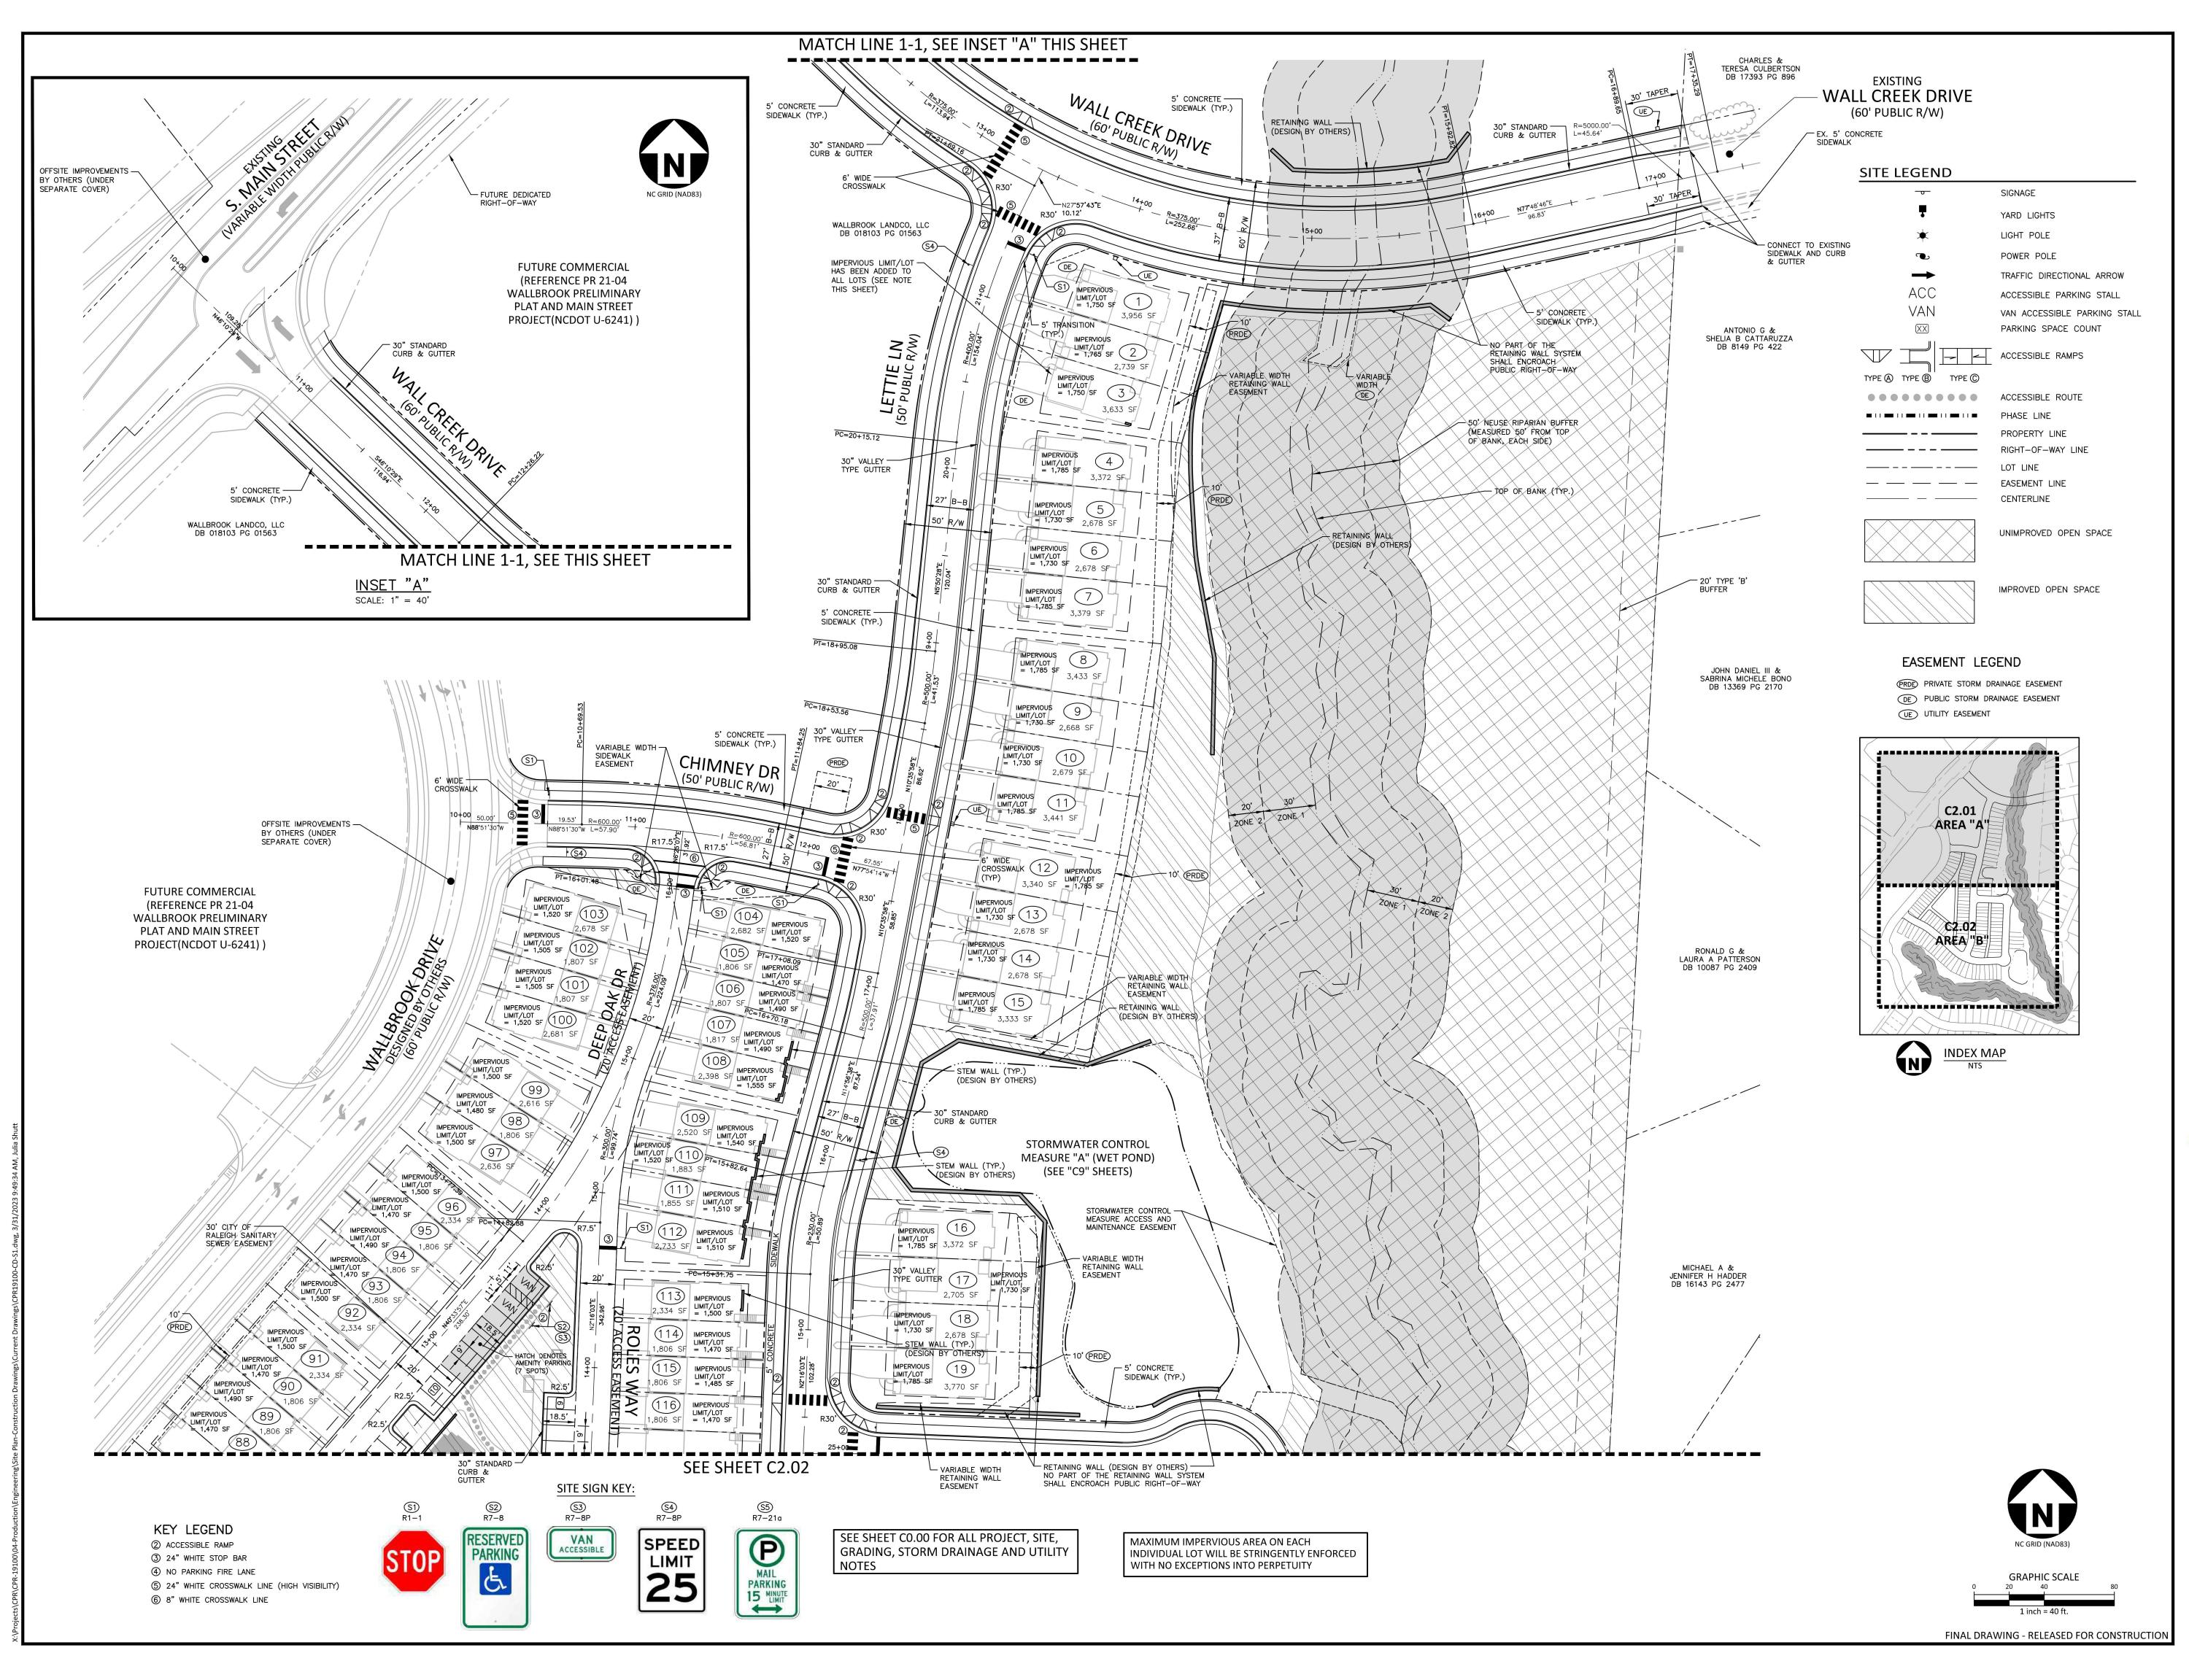
## **REVISIONS**

## **PLAN INFORMATION**

PROJECT NO. CPR-19100 **FILENAME** CPR19100-CD-OAS1 CHECKED BY

DRAWN BY **SCALE** 03. 31. 2023

**OVERALL SITE PLAN** 





# **McAdams**


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# ONSTRUCTION DRAWINGS ROLESVILLE, NORTH CAROLINA



#### REVISIONS

NO. DATE

#### **PLAN INFORMATION**

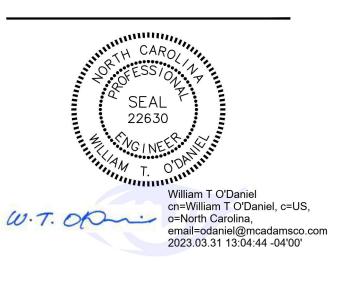PROJECT NO. CPR-19100

FILENAME CPR19100-CD-S1

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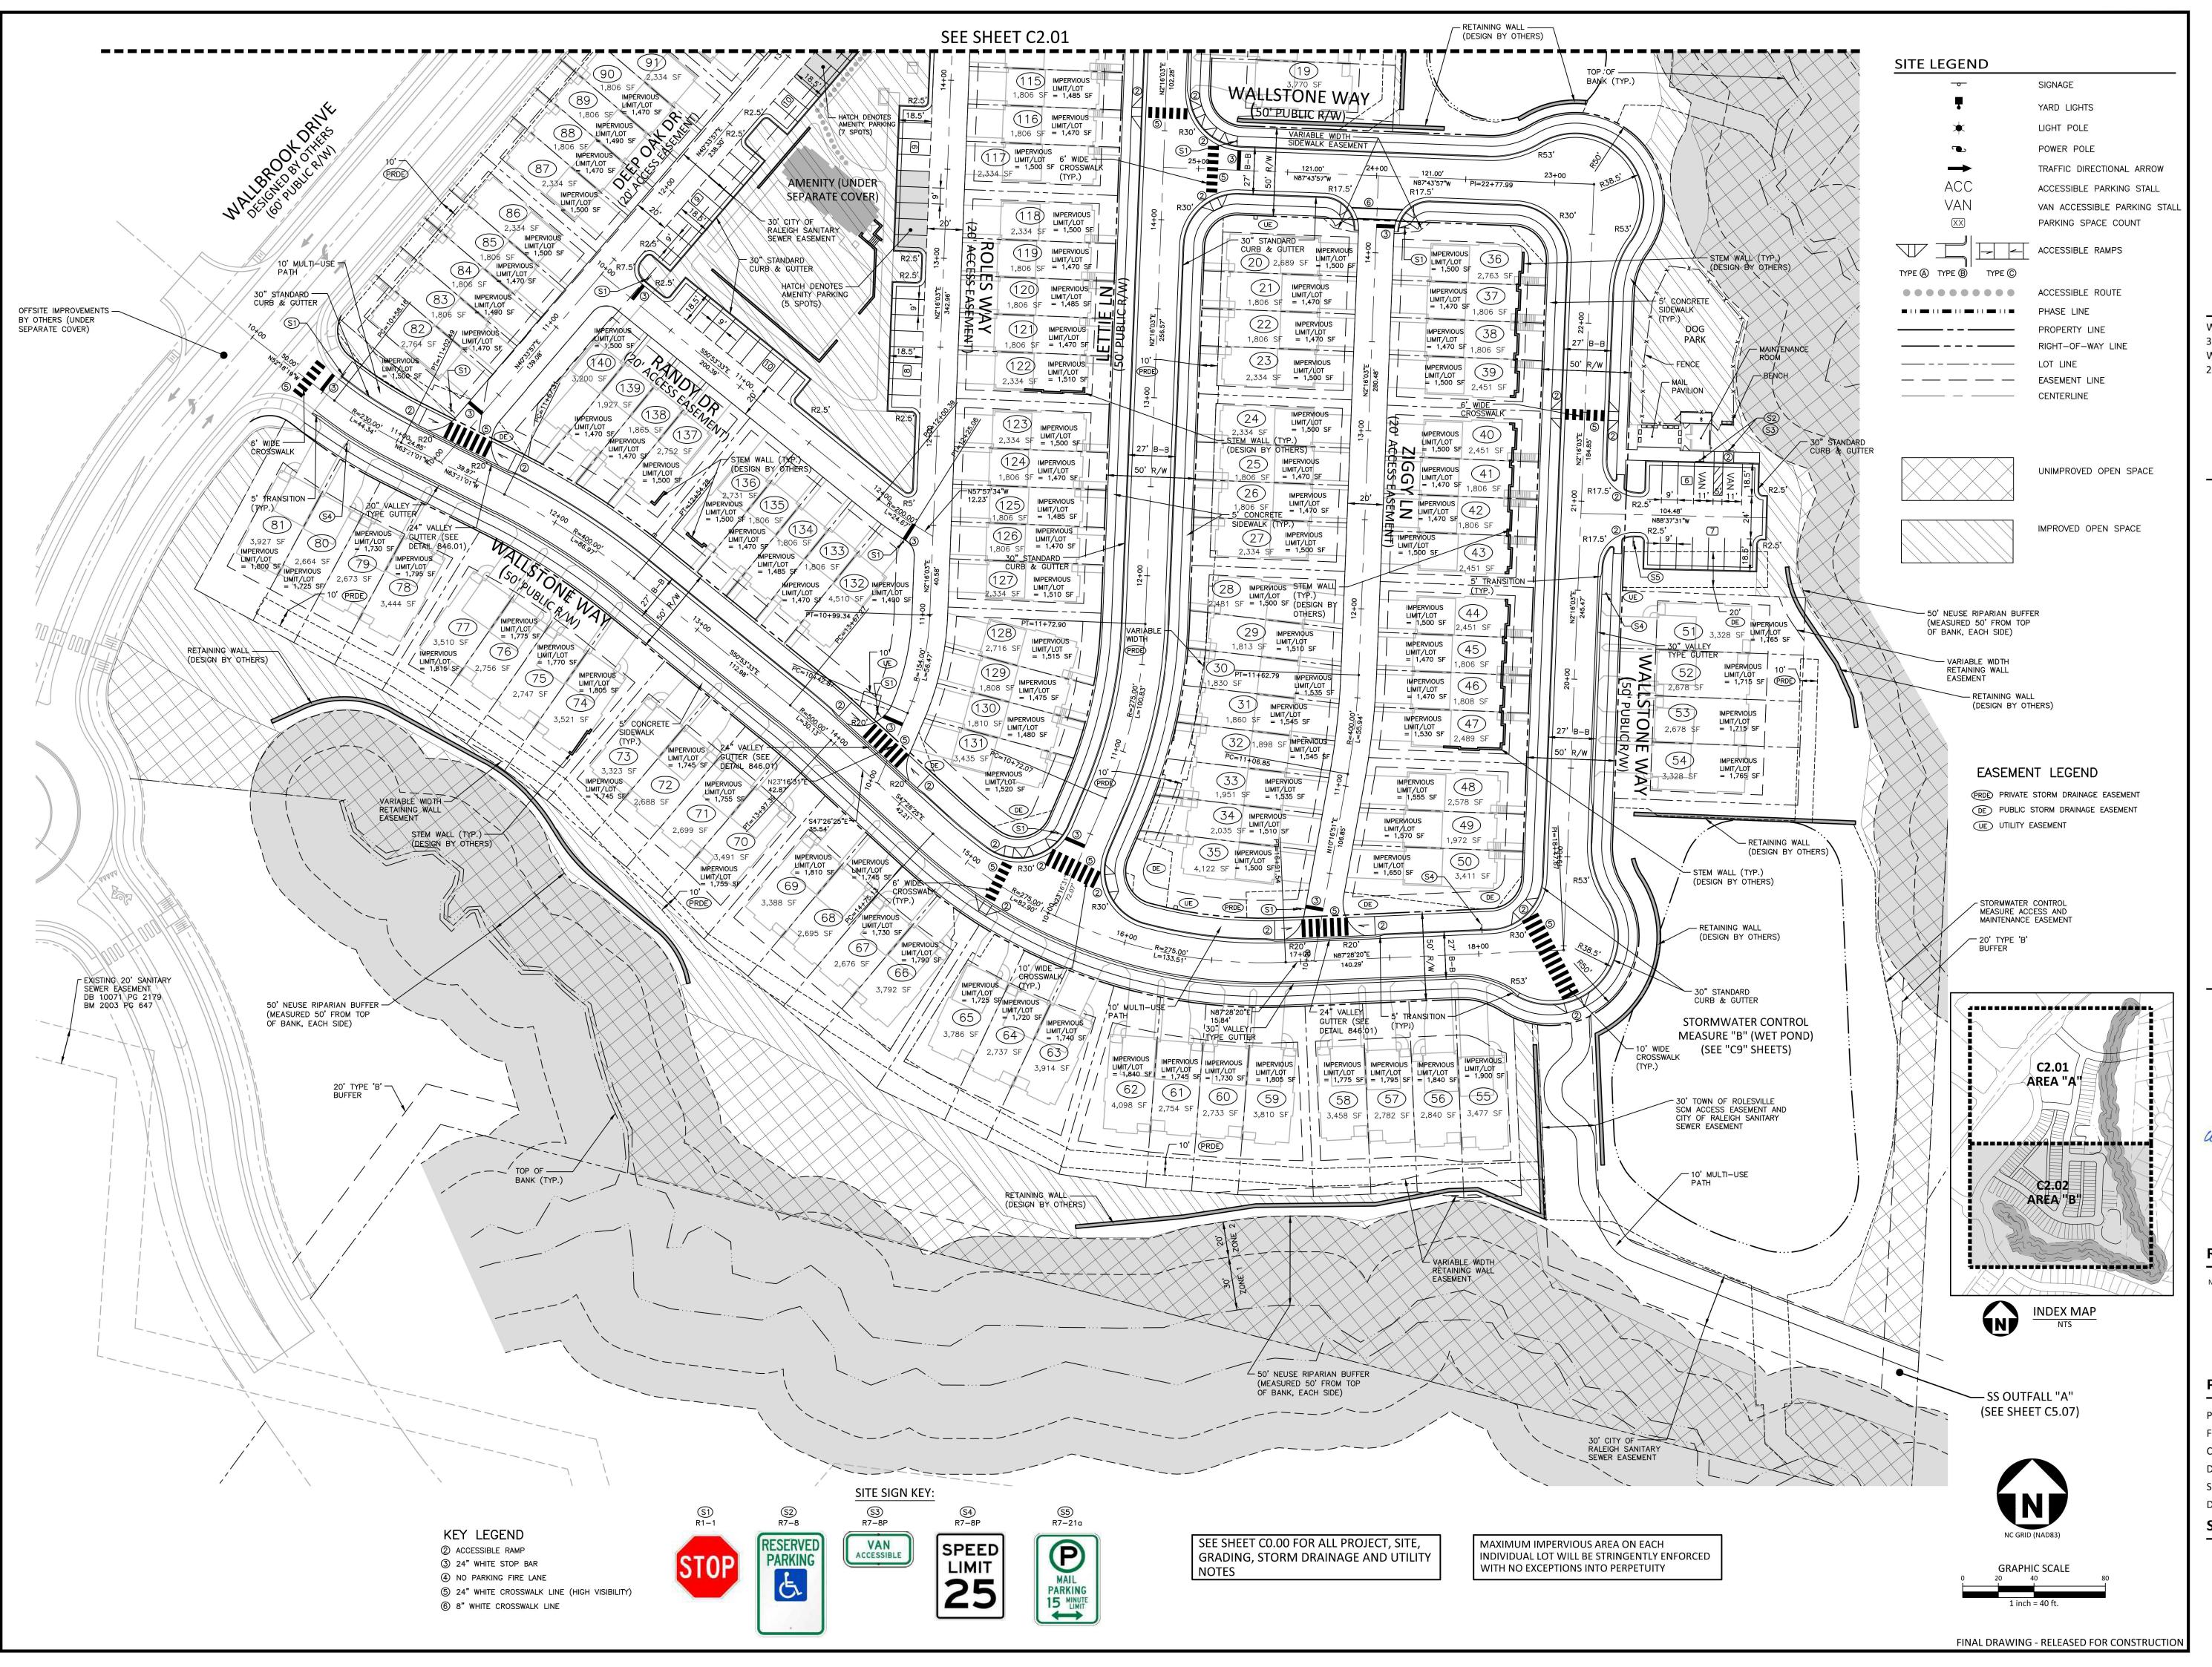
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SCALE 1"=40'

SCALE 1"=40'
DATE 03. 31. 2023

SHEET

SITE PLAN - AREA "A"





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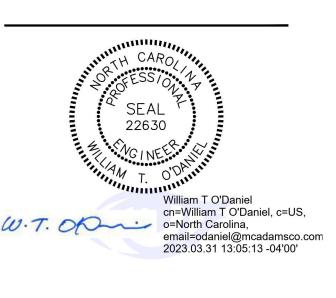
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NSTRUCTION DRAWINGS

ROLESVILLE, NORTH CAROLINA



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DATE

#### PLAN INFORMATION

PROJECT NO. CPR-19100

FILENAME CPR19100-CD-S1


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SCALE 1"=40'

DATE 03. 31. 2023 **SHEET** 

SITE PLAN - AREA "B"



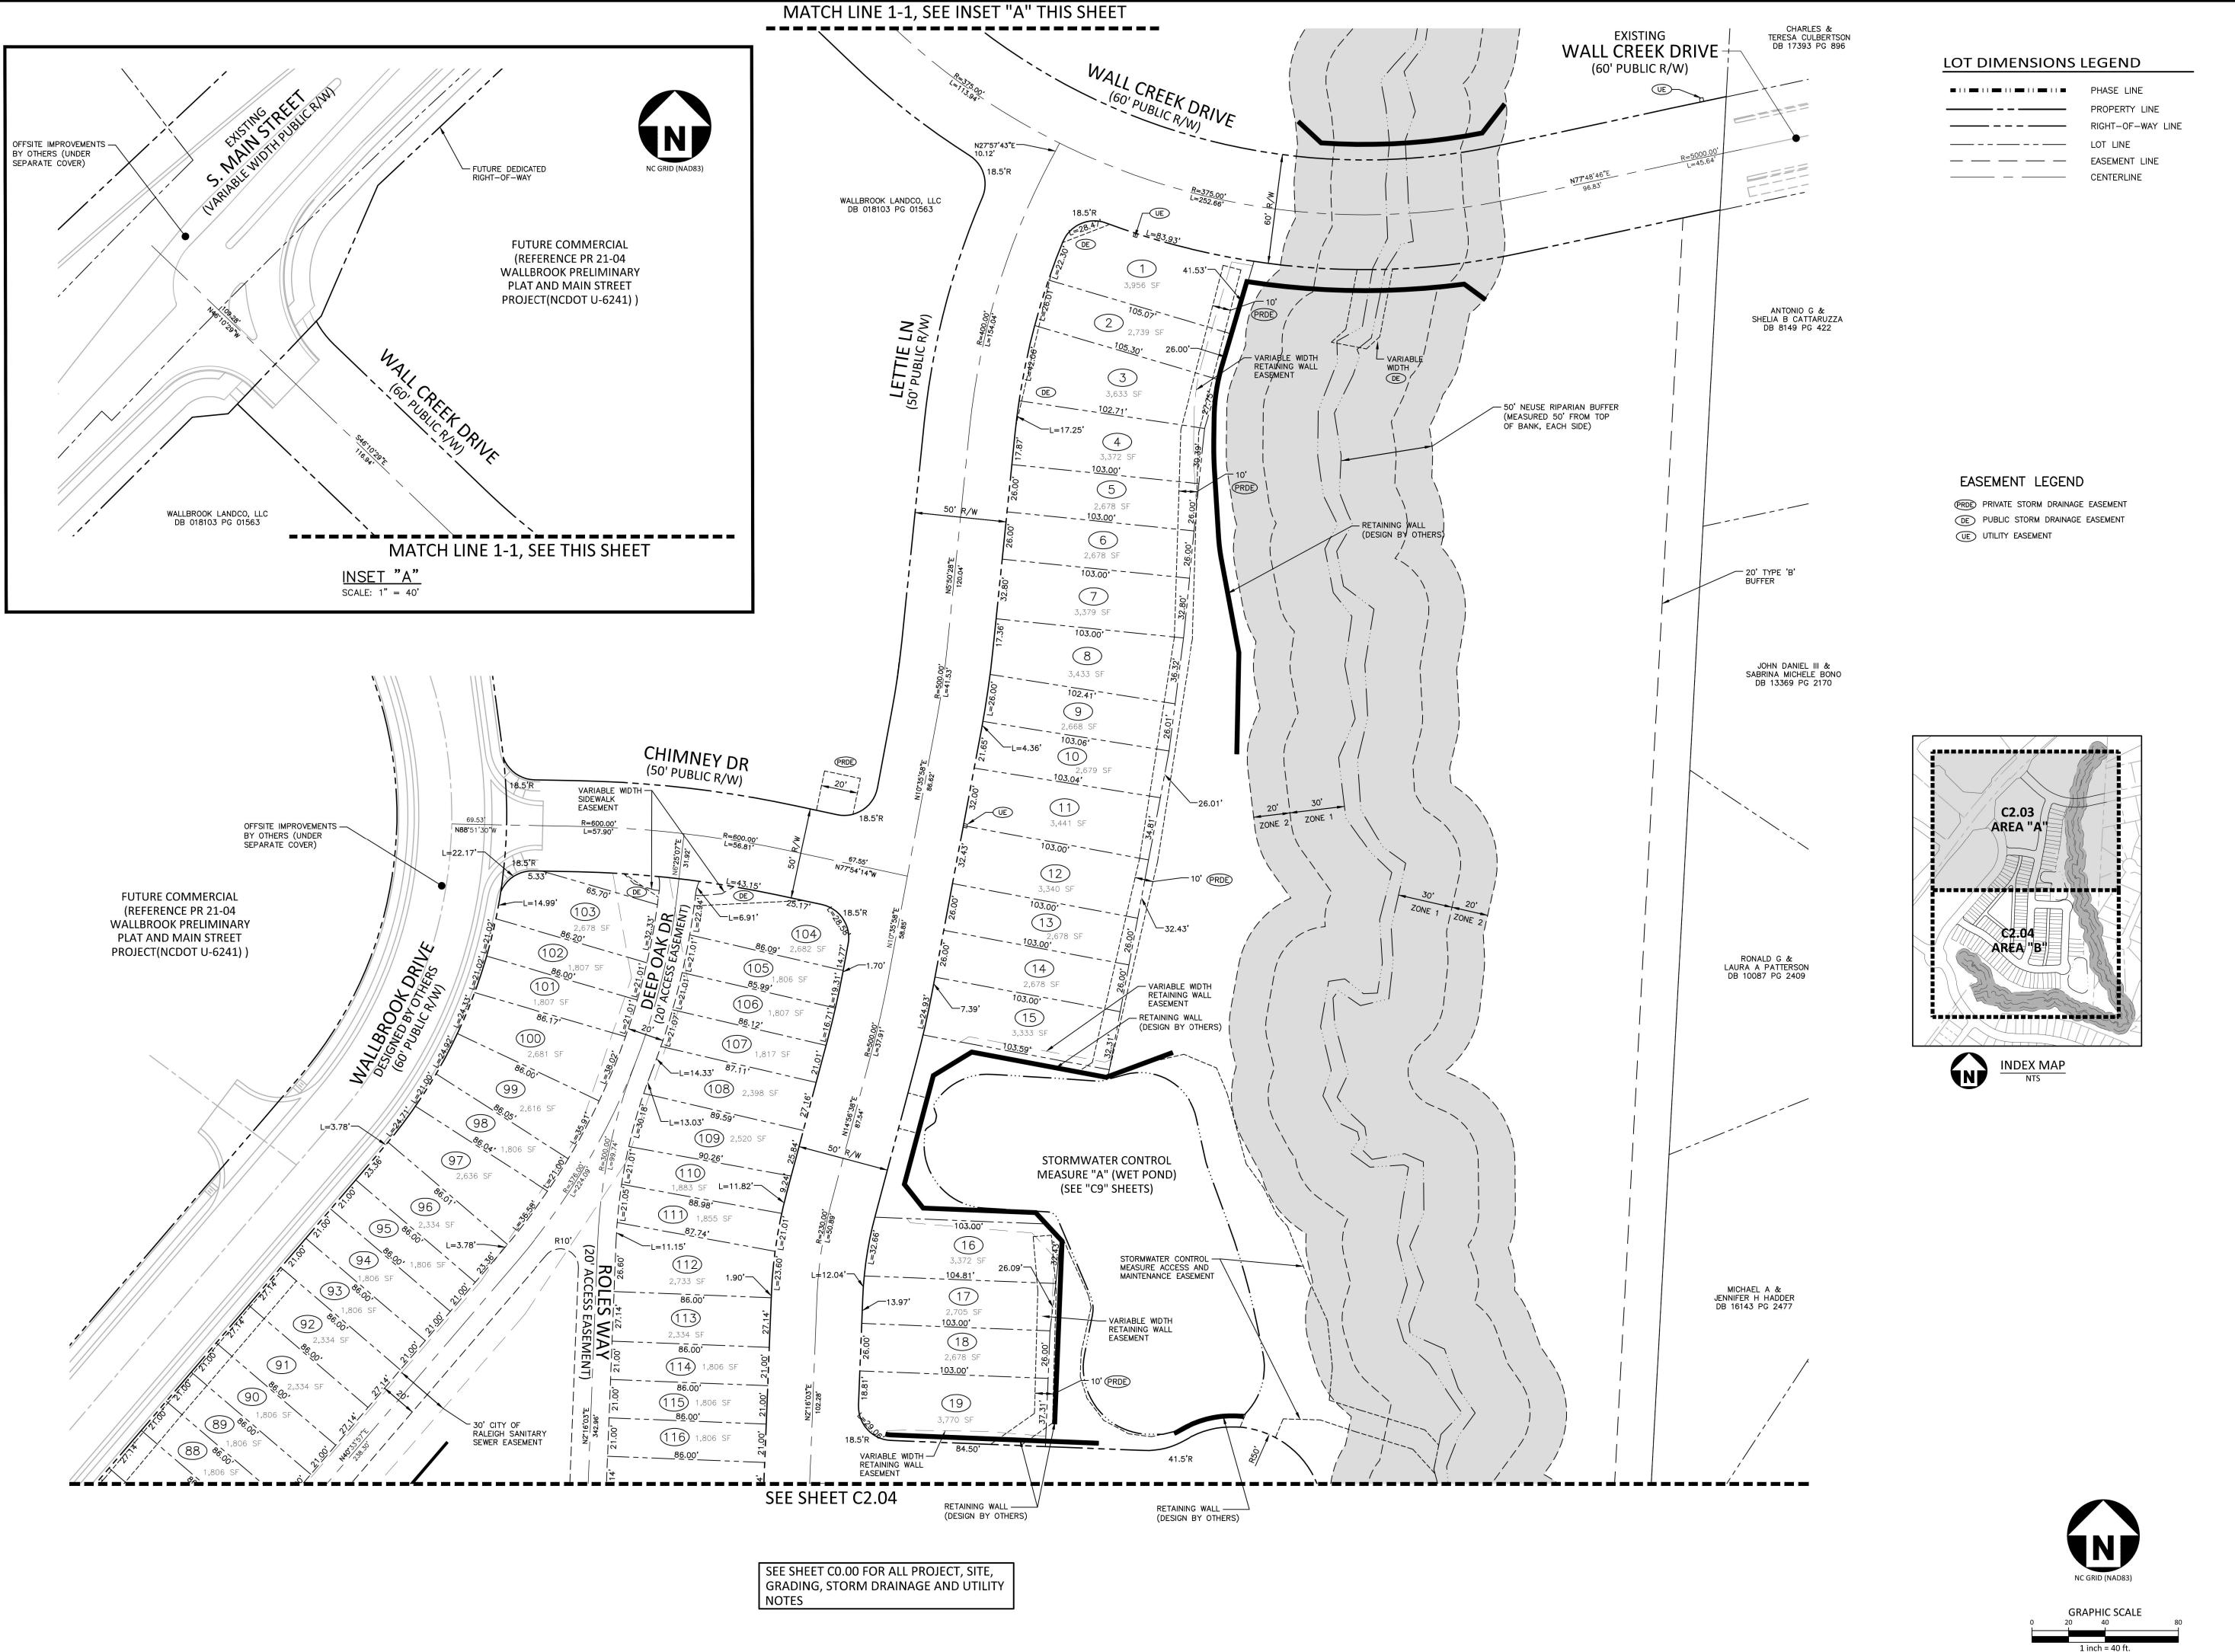


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#### **PLAN INFORMATION**


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**SCALE** 1"=40' DATE 03. 31. 2023

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**LOT DIMENSIONS -**AREA "A"



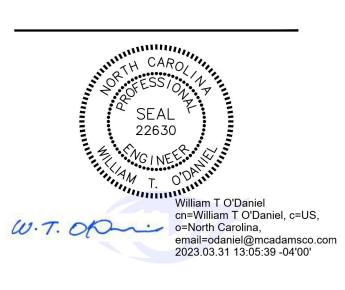

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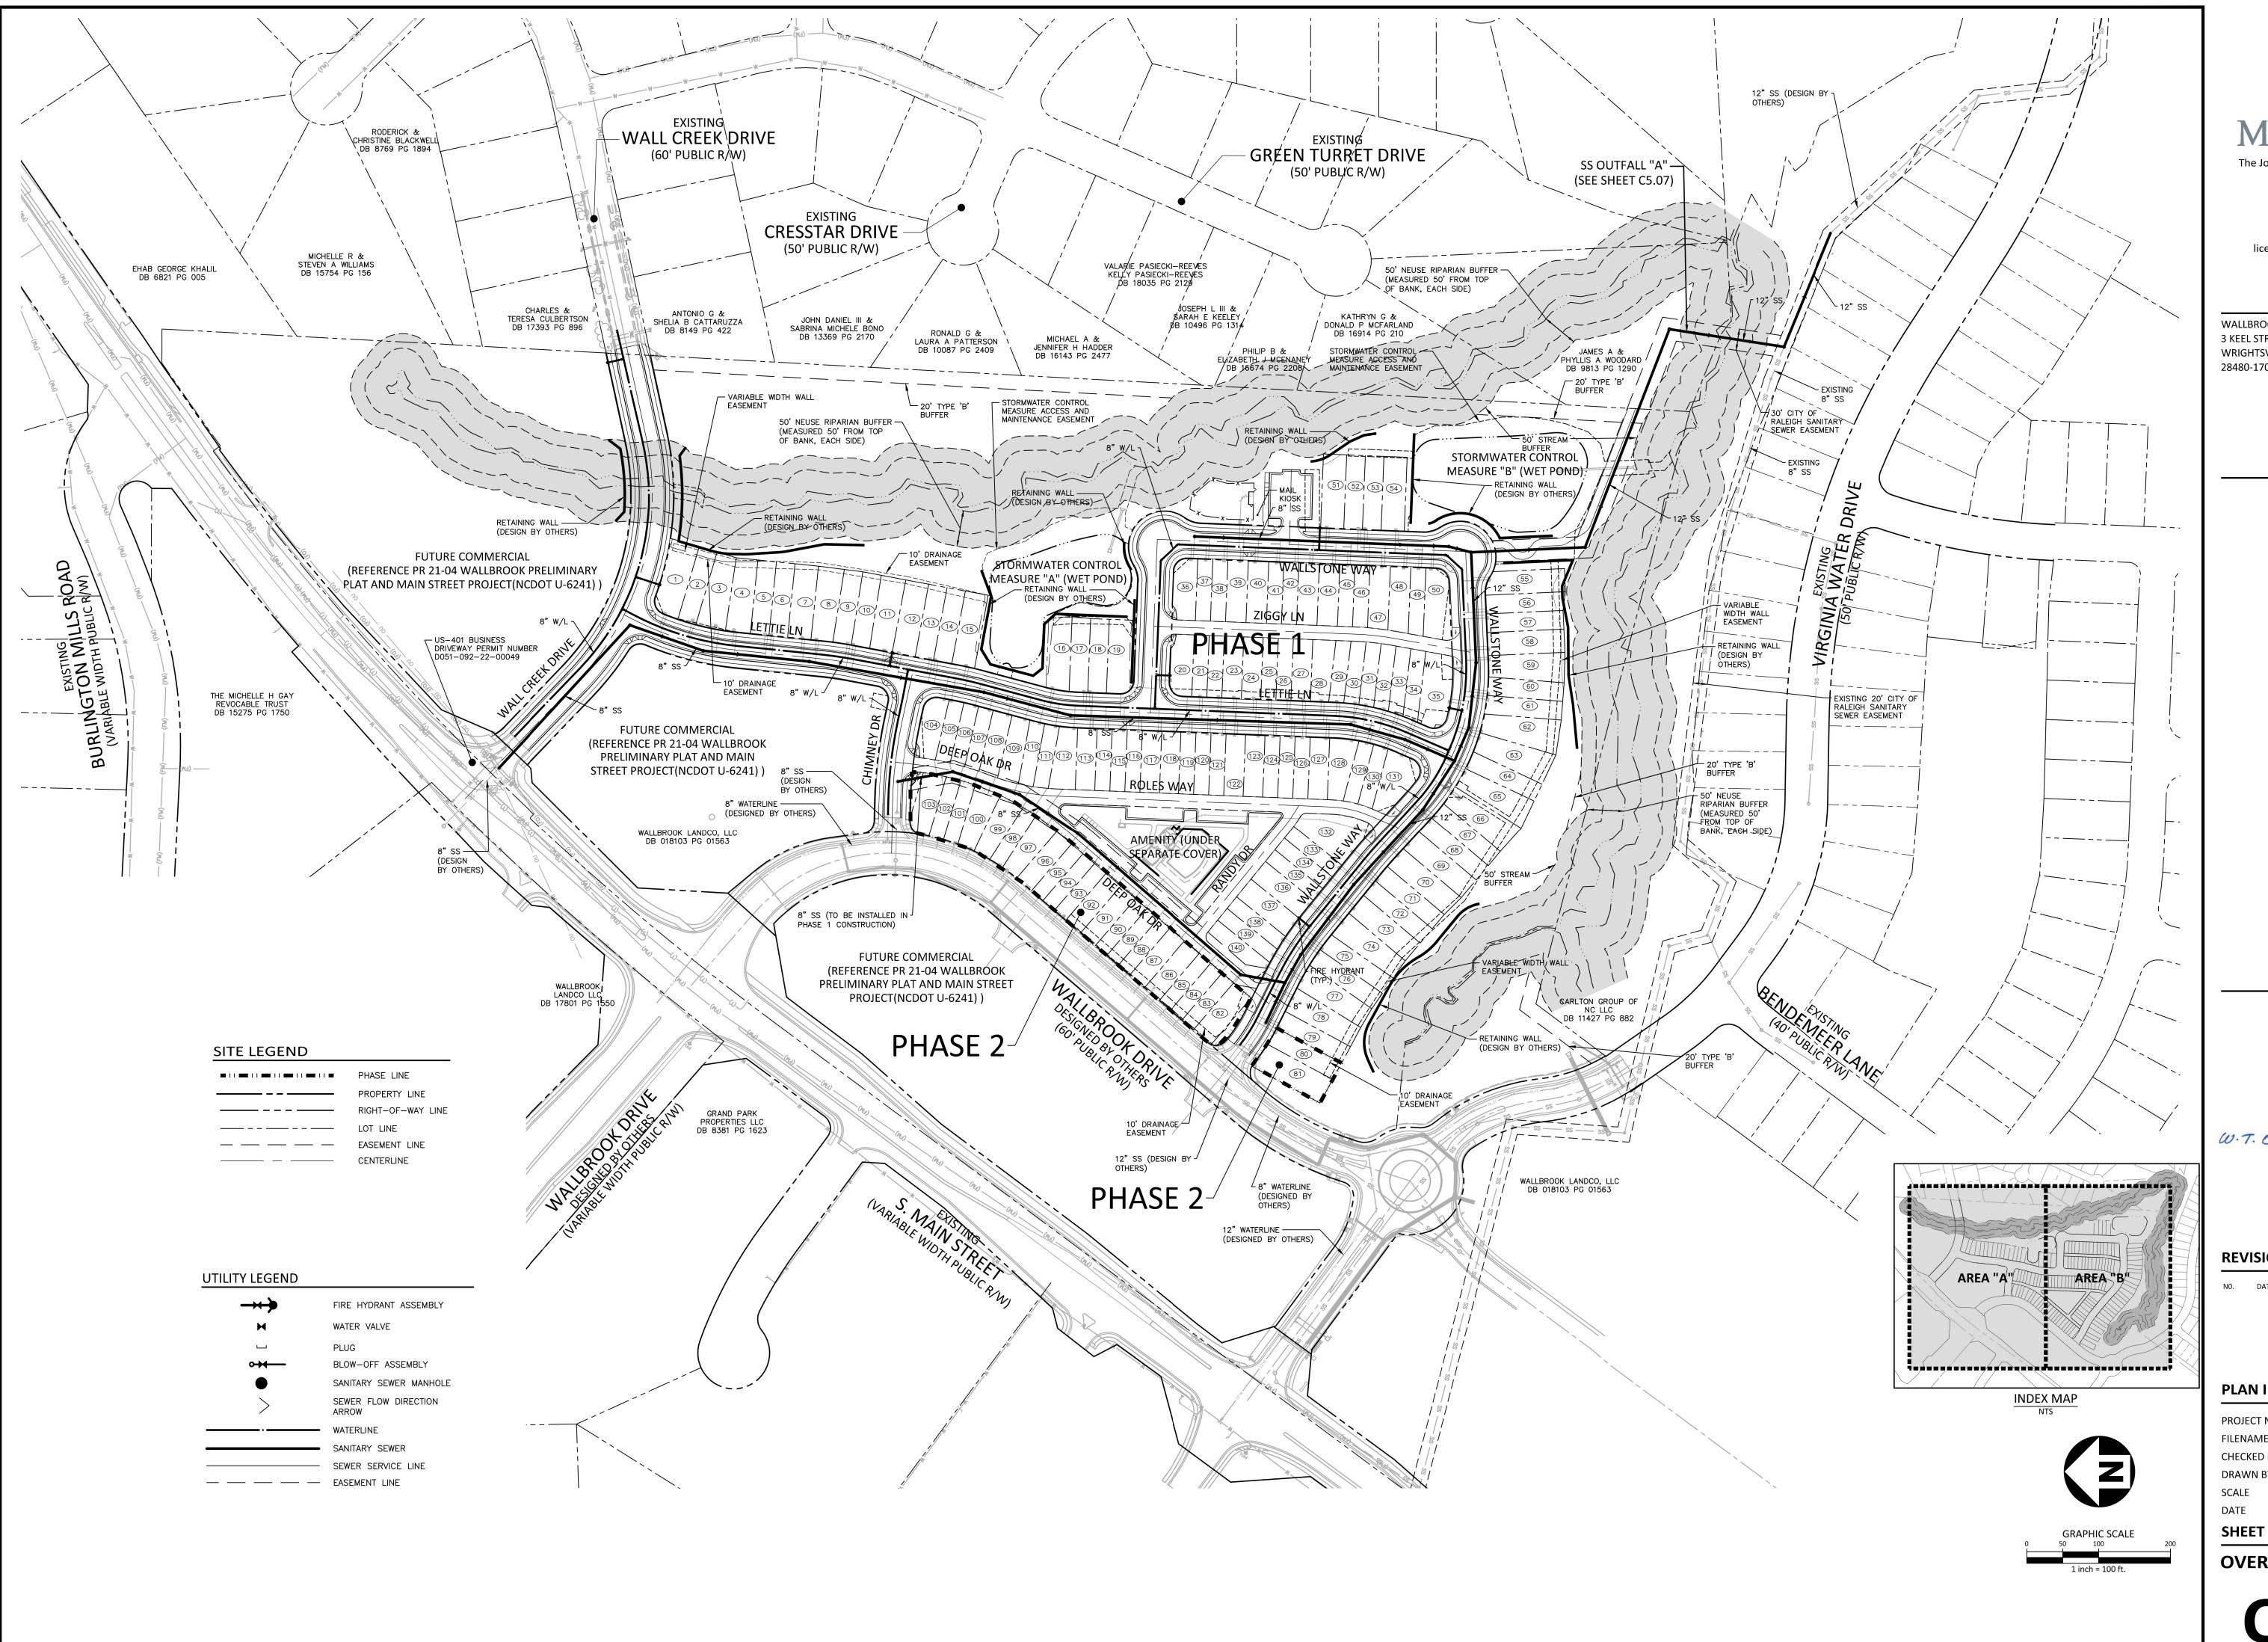
**REVISIONS** 

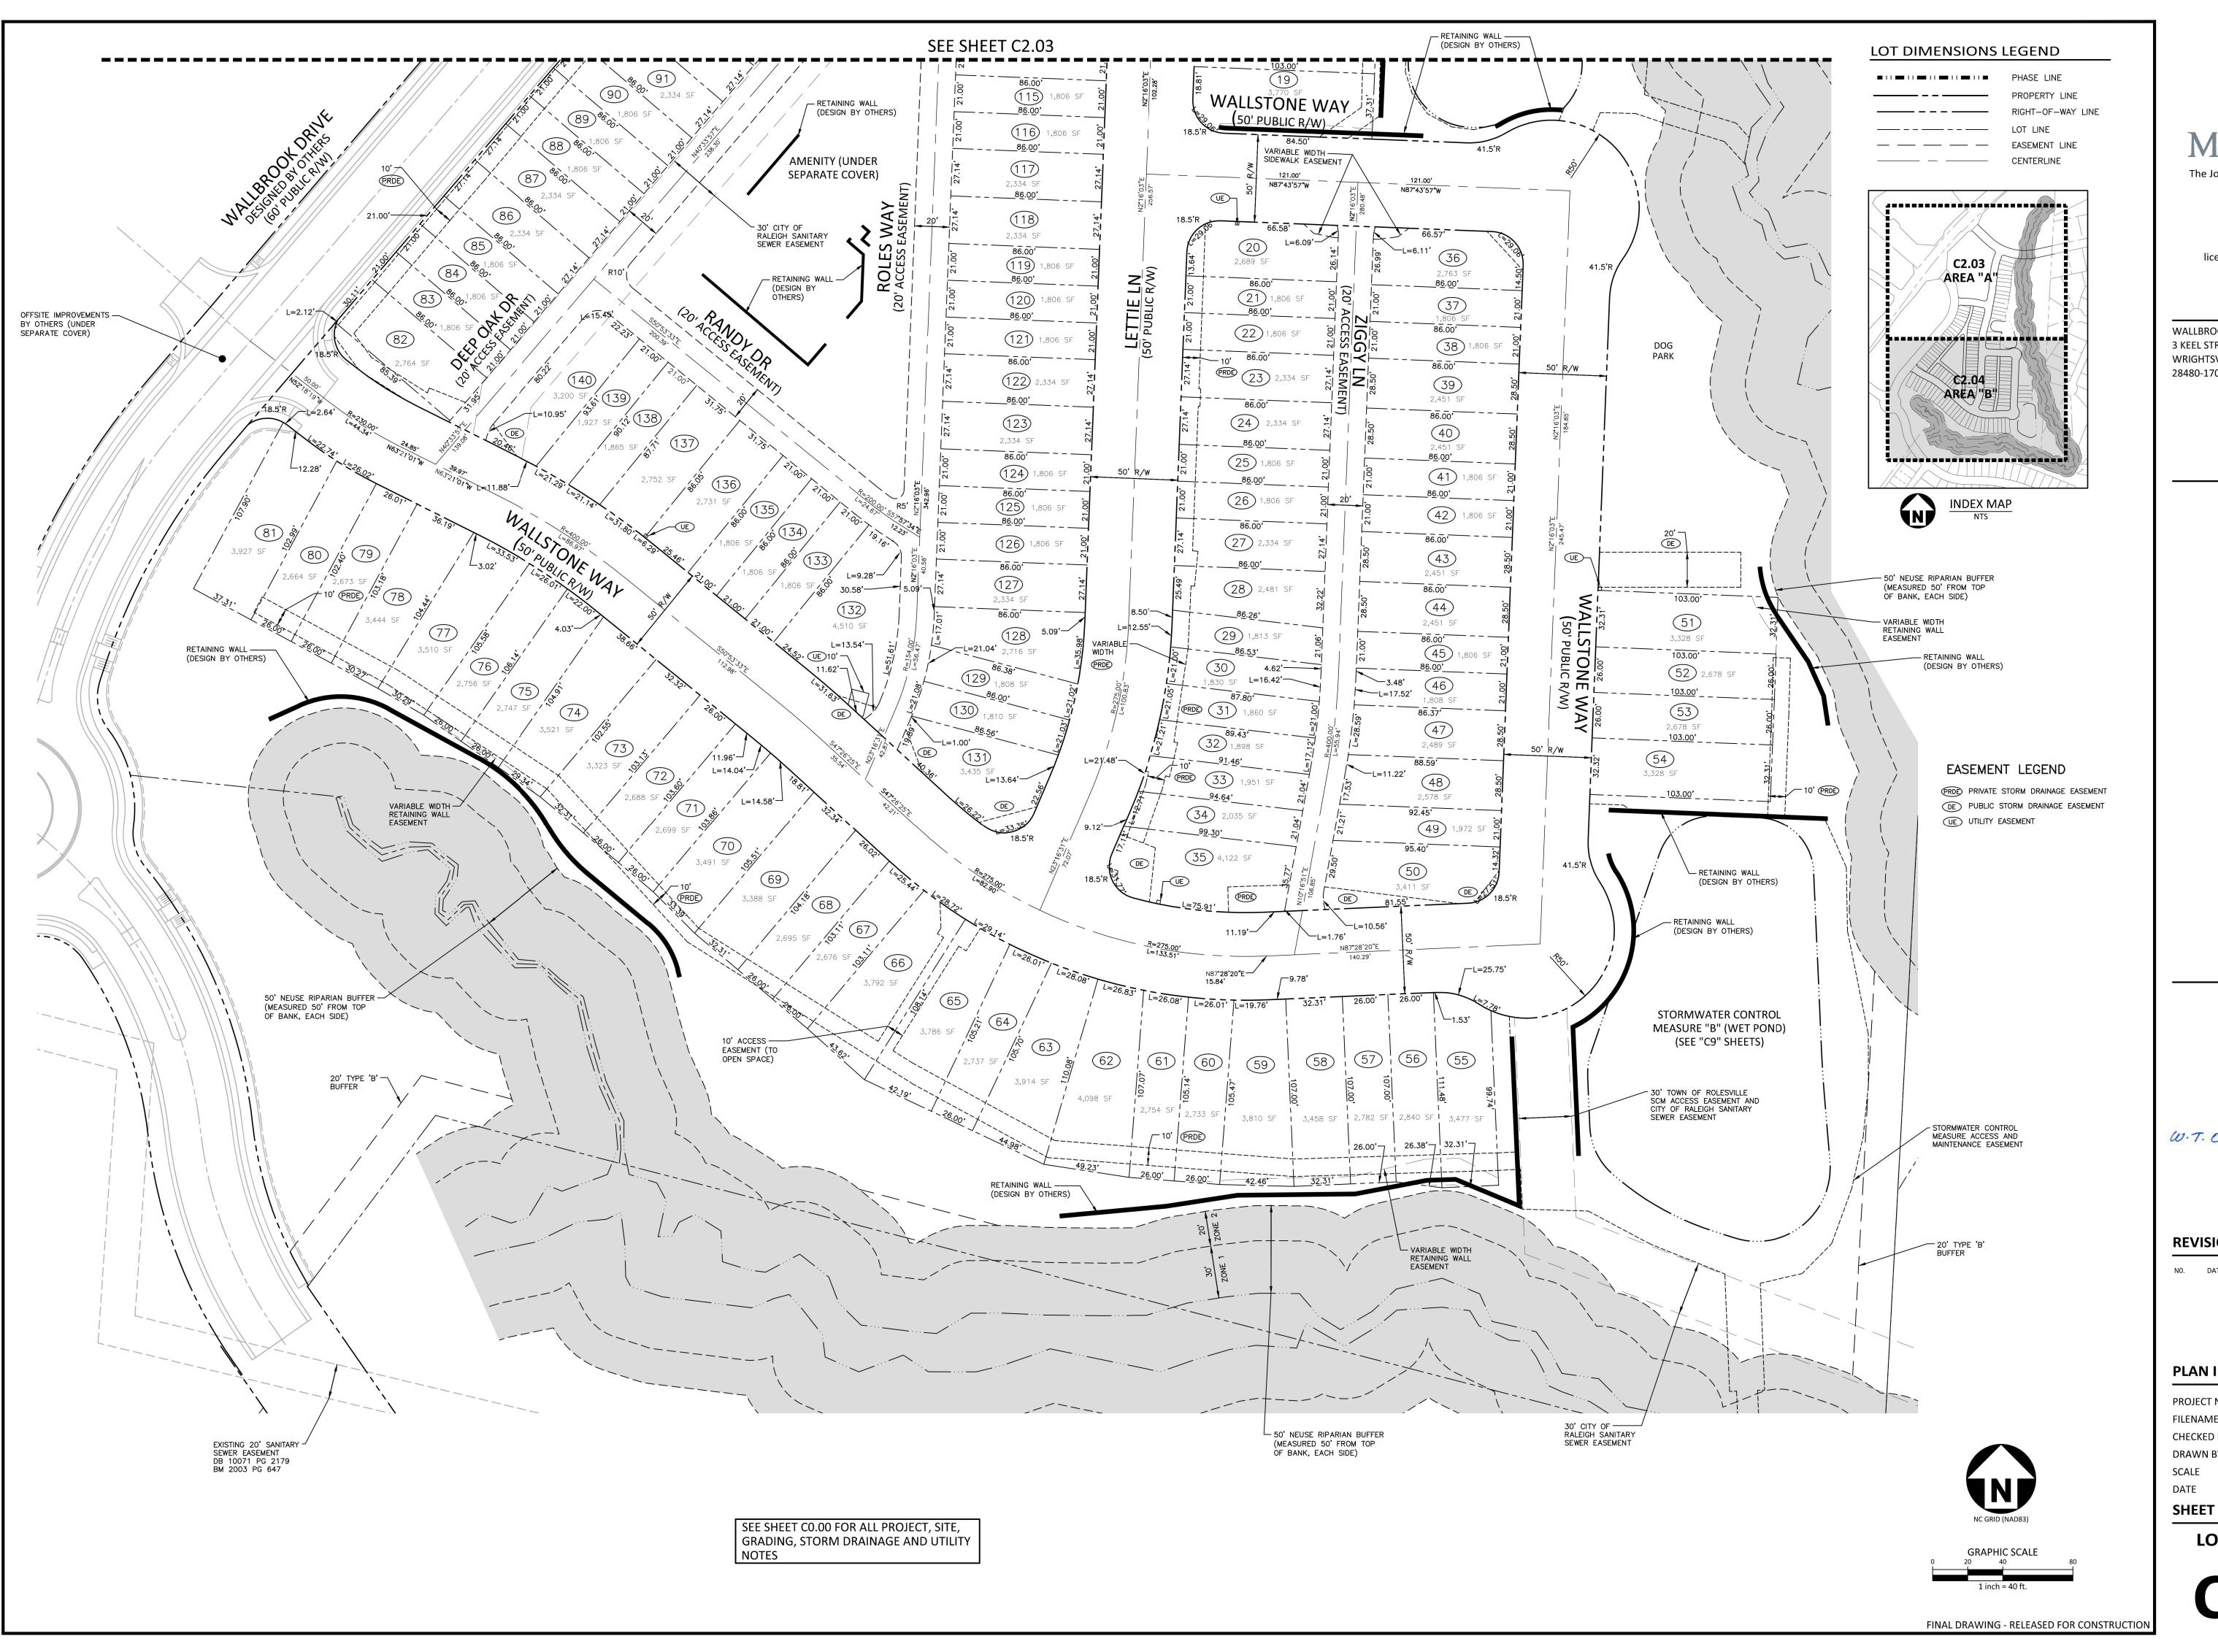NO. DATE

#### **PLAN INFORMATION**

PROJECT NO. CPR-19100 **FILENAME** CPR19100-CD-S2 CHECKED BY DRAWN BY **SCALE** 1"=40' DATE 03. 31. 2023

> **LOT DIMENSIONS -**AREA "B"






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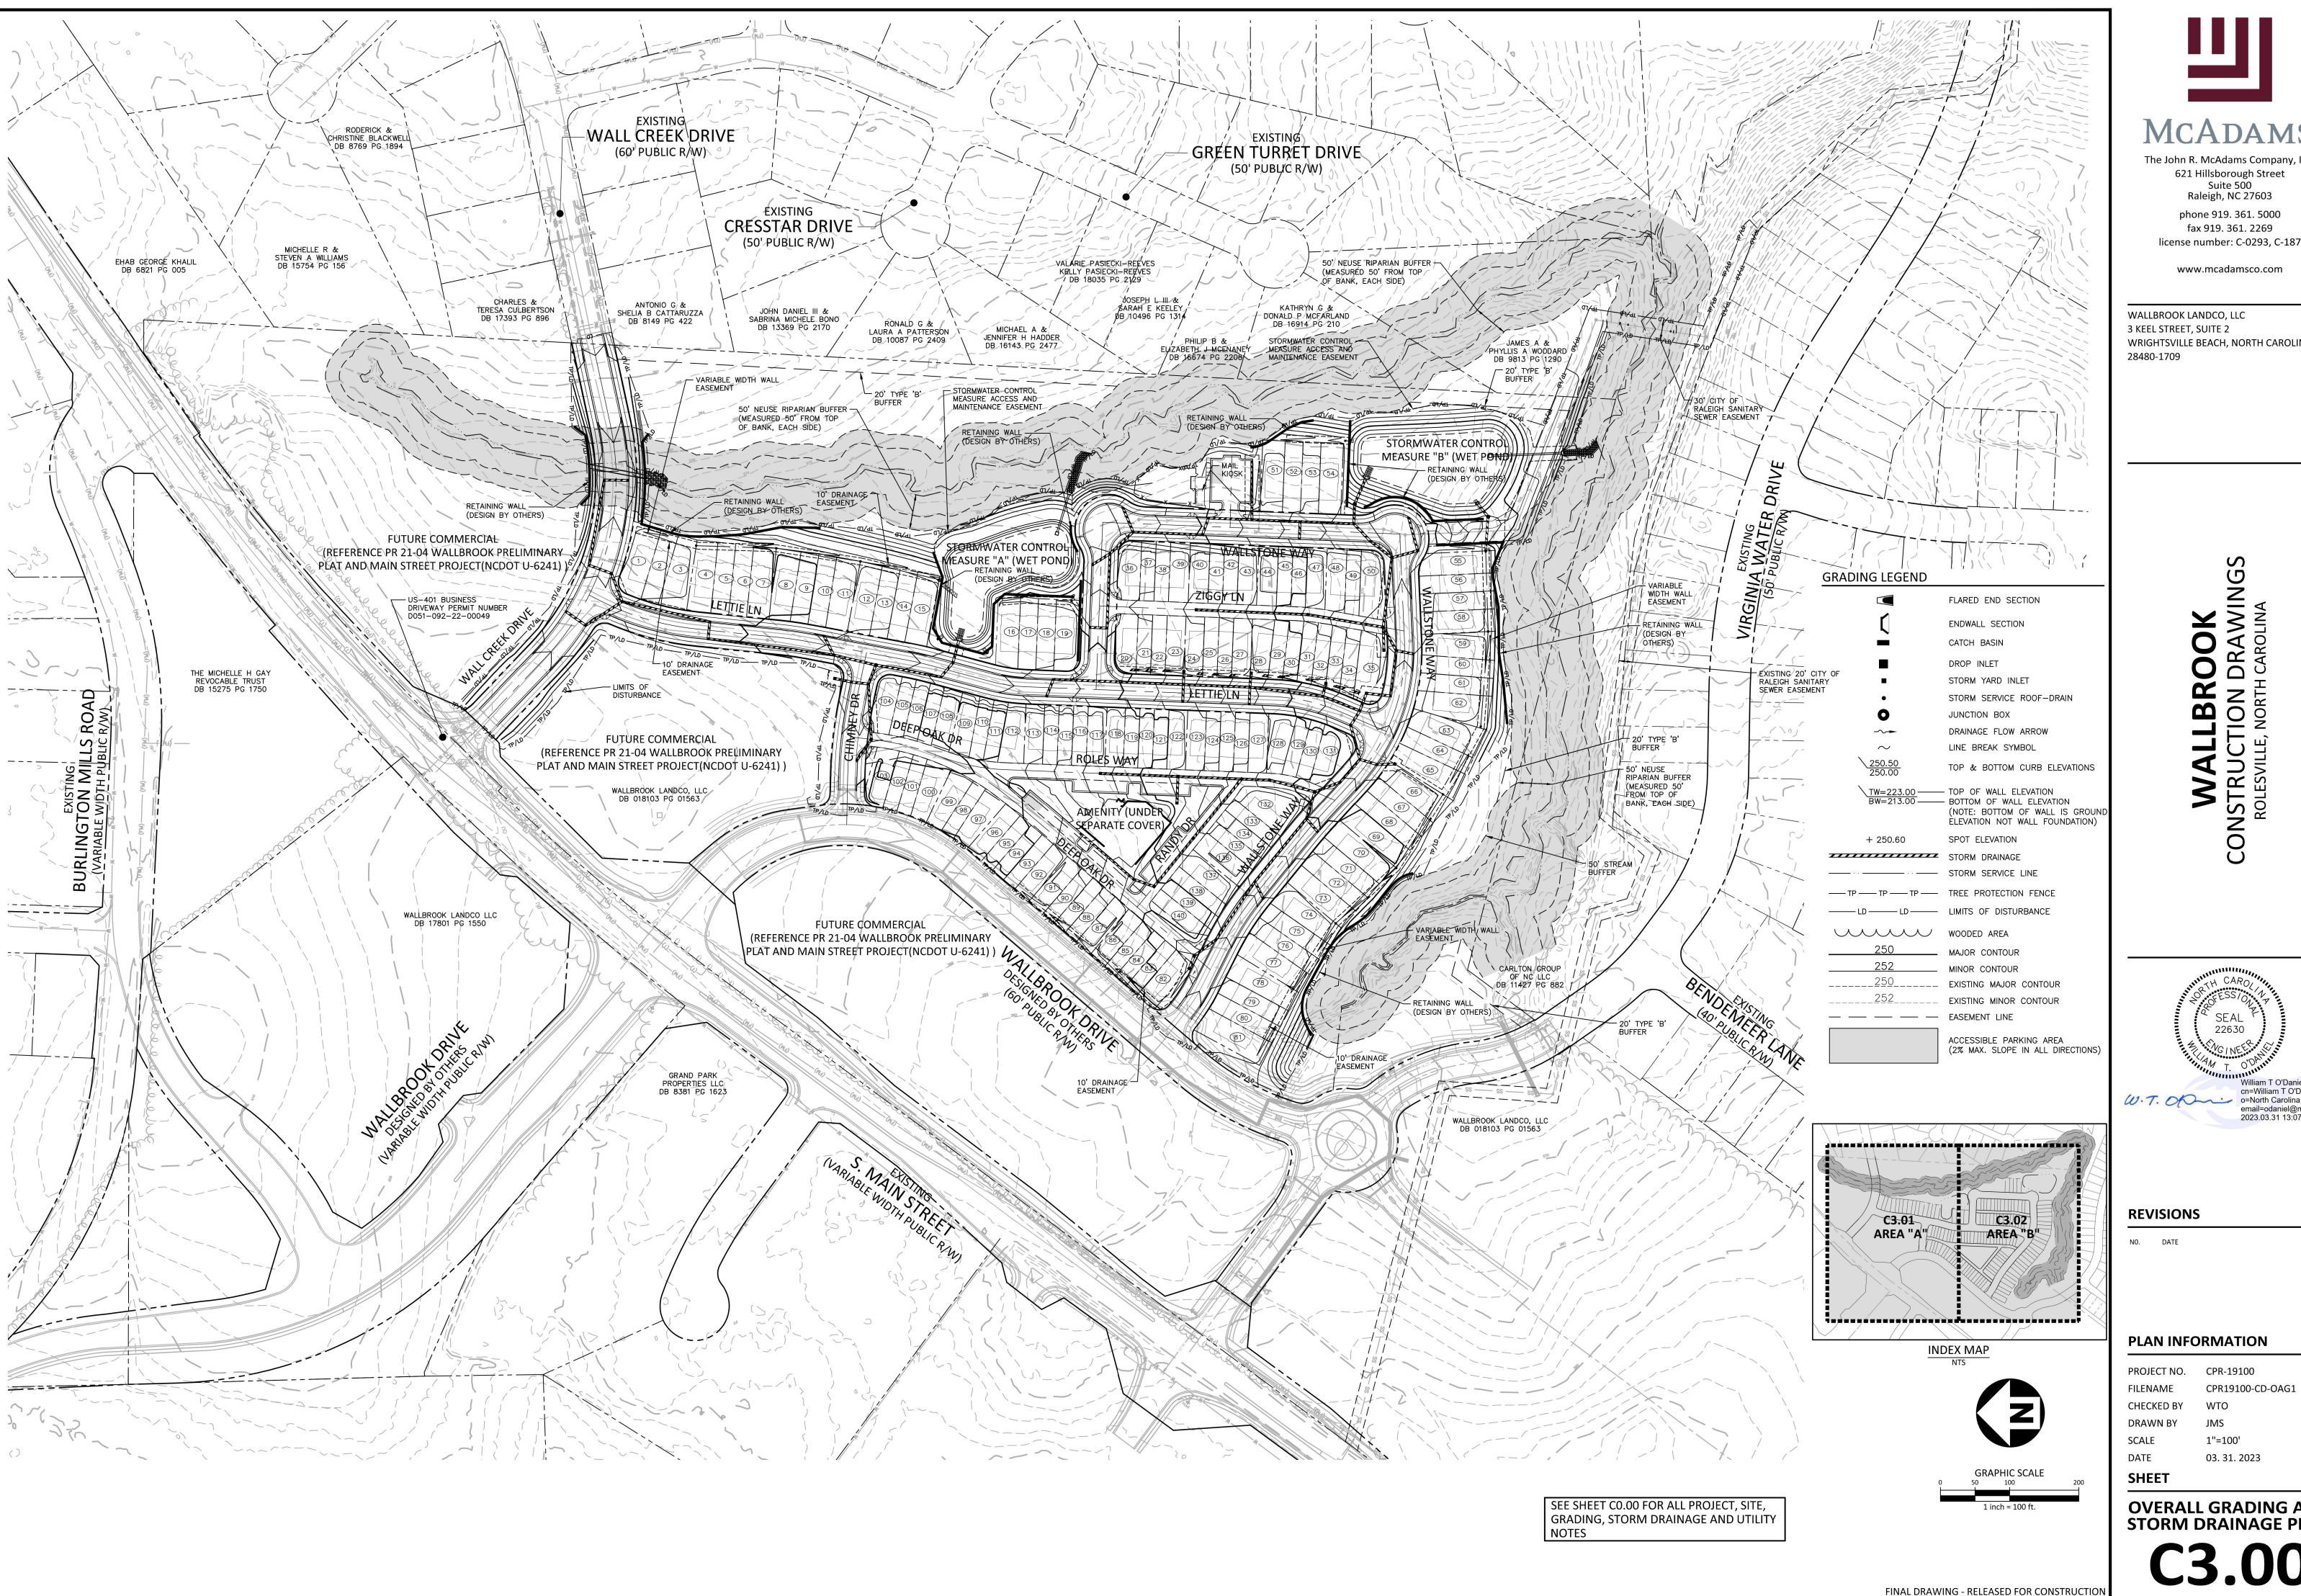
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#### PLAN INFORMATION

PROJECT NO. CPR-19100 **FILENAME** CPR19100-CD-OAPH1 CHECKED BY

DRAWN BY SCALE 1"=100' DATE 03. 31. 2023

**OVERALL PHASING PLAN** 

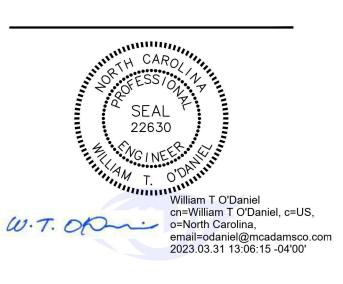




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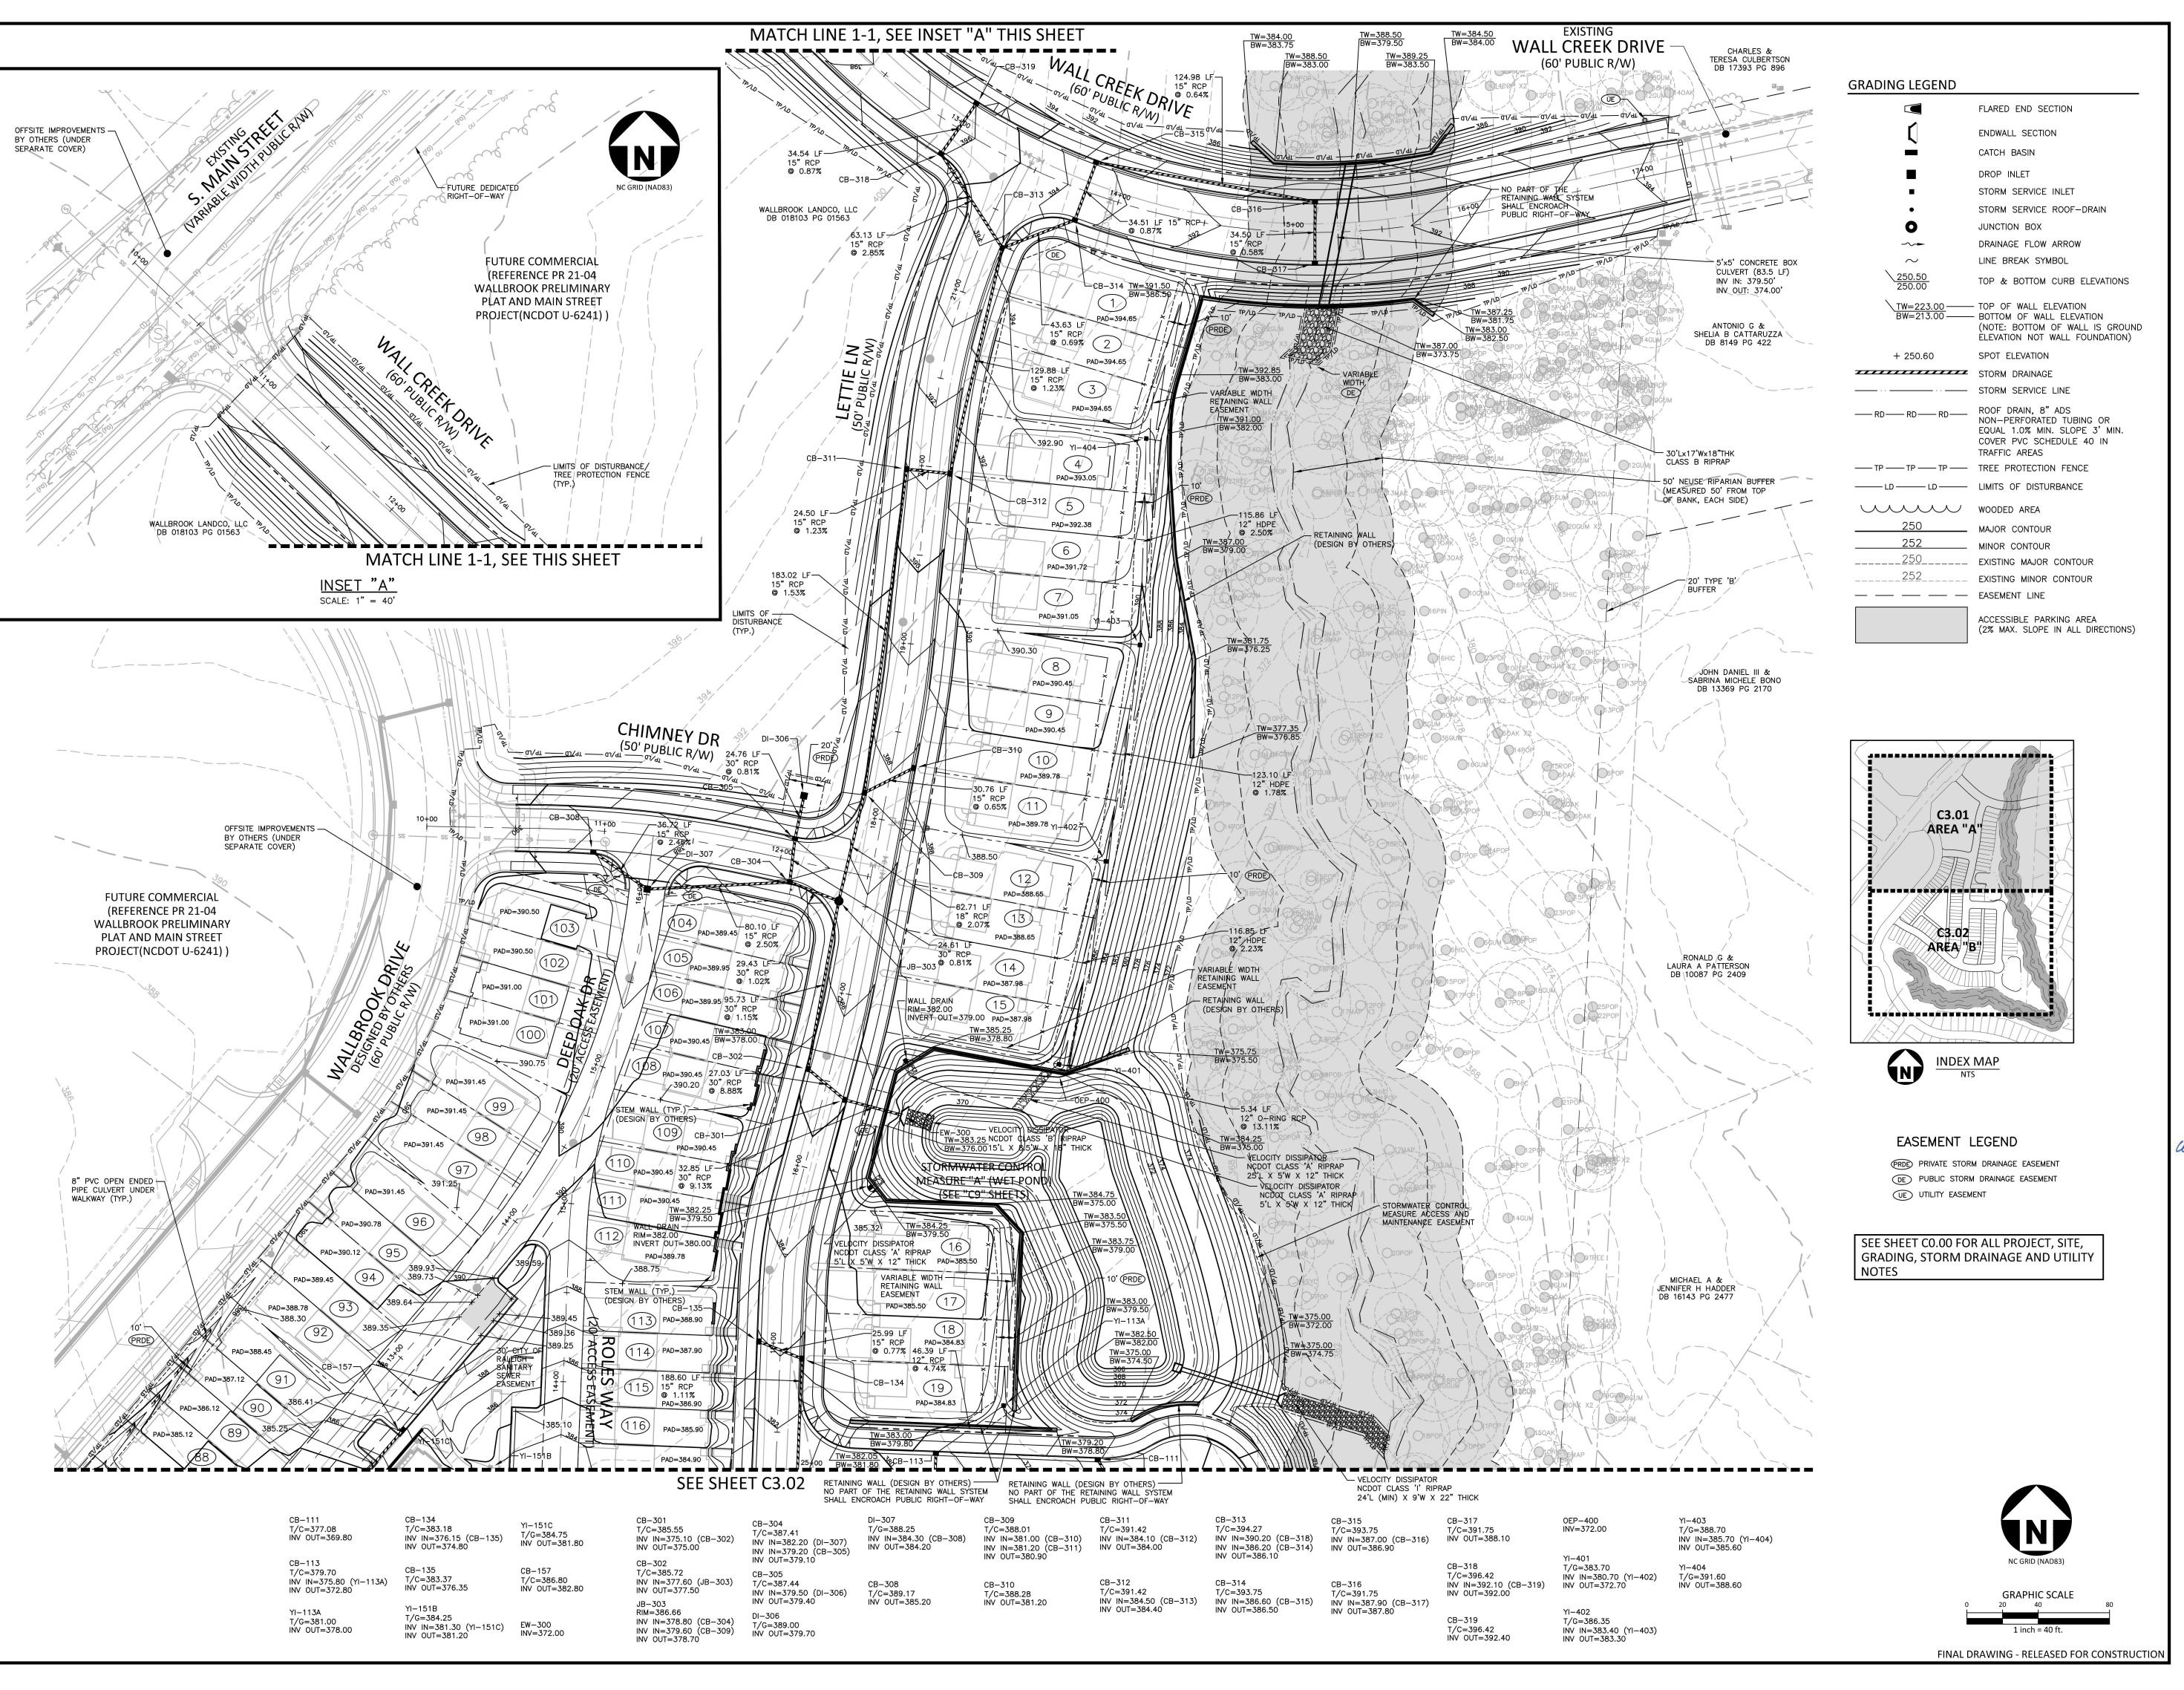
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#### PLAN INFORMATION

PROJECT NO. CPR-19100 **FILENAME** CPR19100-CD-OAG1 CHECKED BY

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OVERALL GRADING AND STORM DRAINAGE PLAN



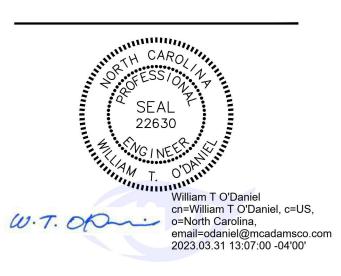

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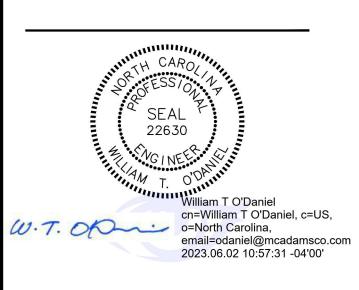
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NSTRUCTION DRAWINGS
ROLESVILLE, NORTH CAROLINA



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## PLAN INFORMATION

PROJECT NO. CPR-19100

FILENAME CPR19100-CD-G1

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 JMS


 SCALE
 1"=40'

 DATE
 05. 22. 2023

GRADING AND STORM

DRAINAGE PLAN - AREA "A"

C3.01

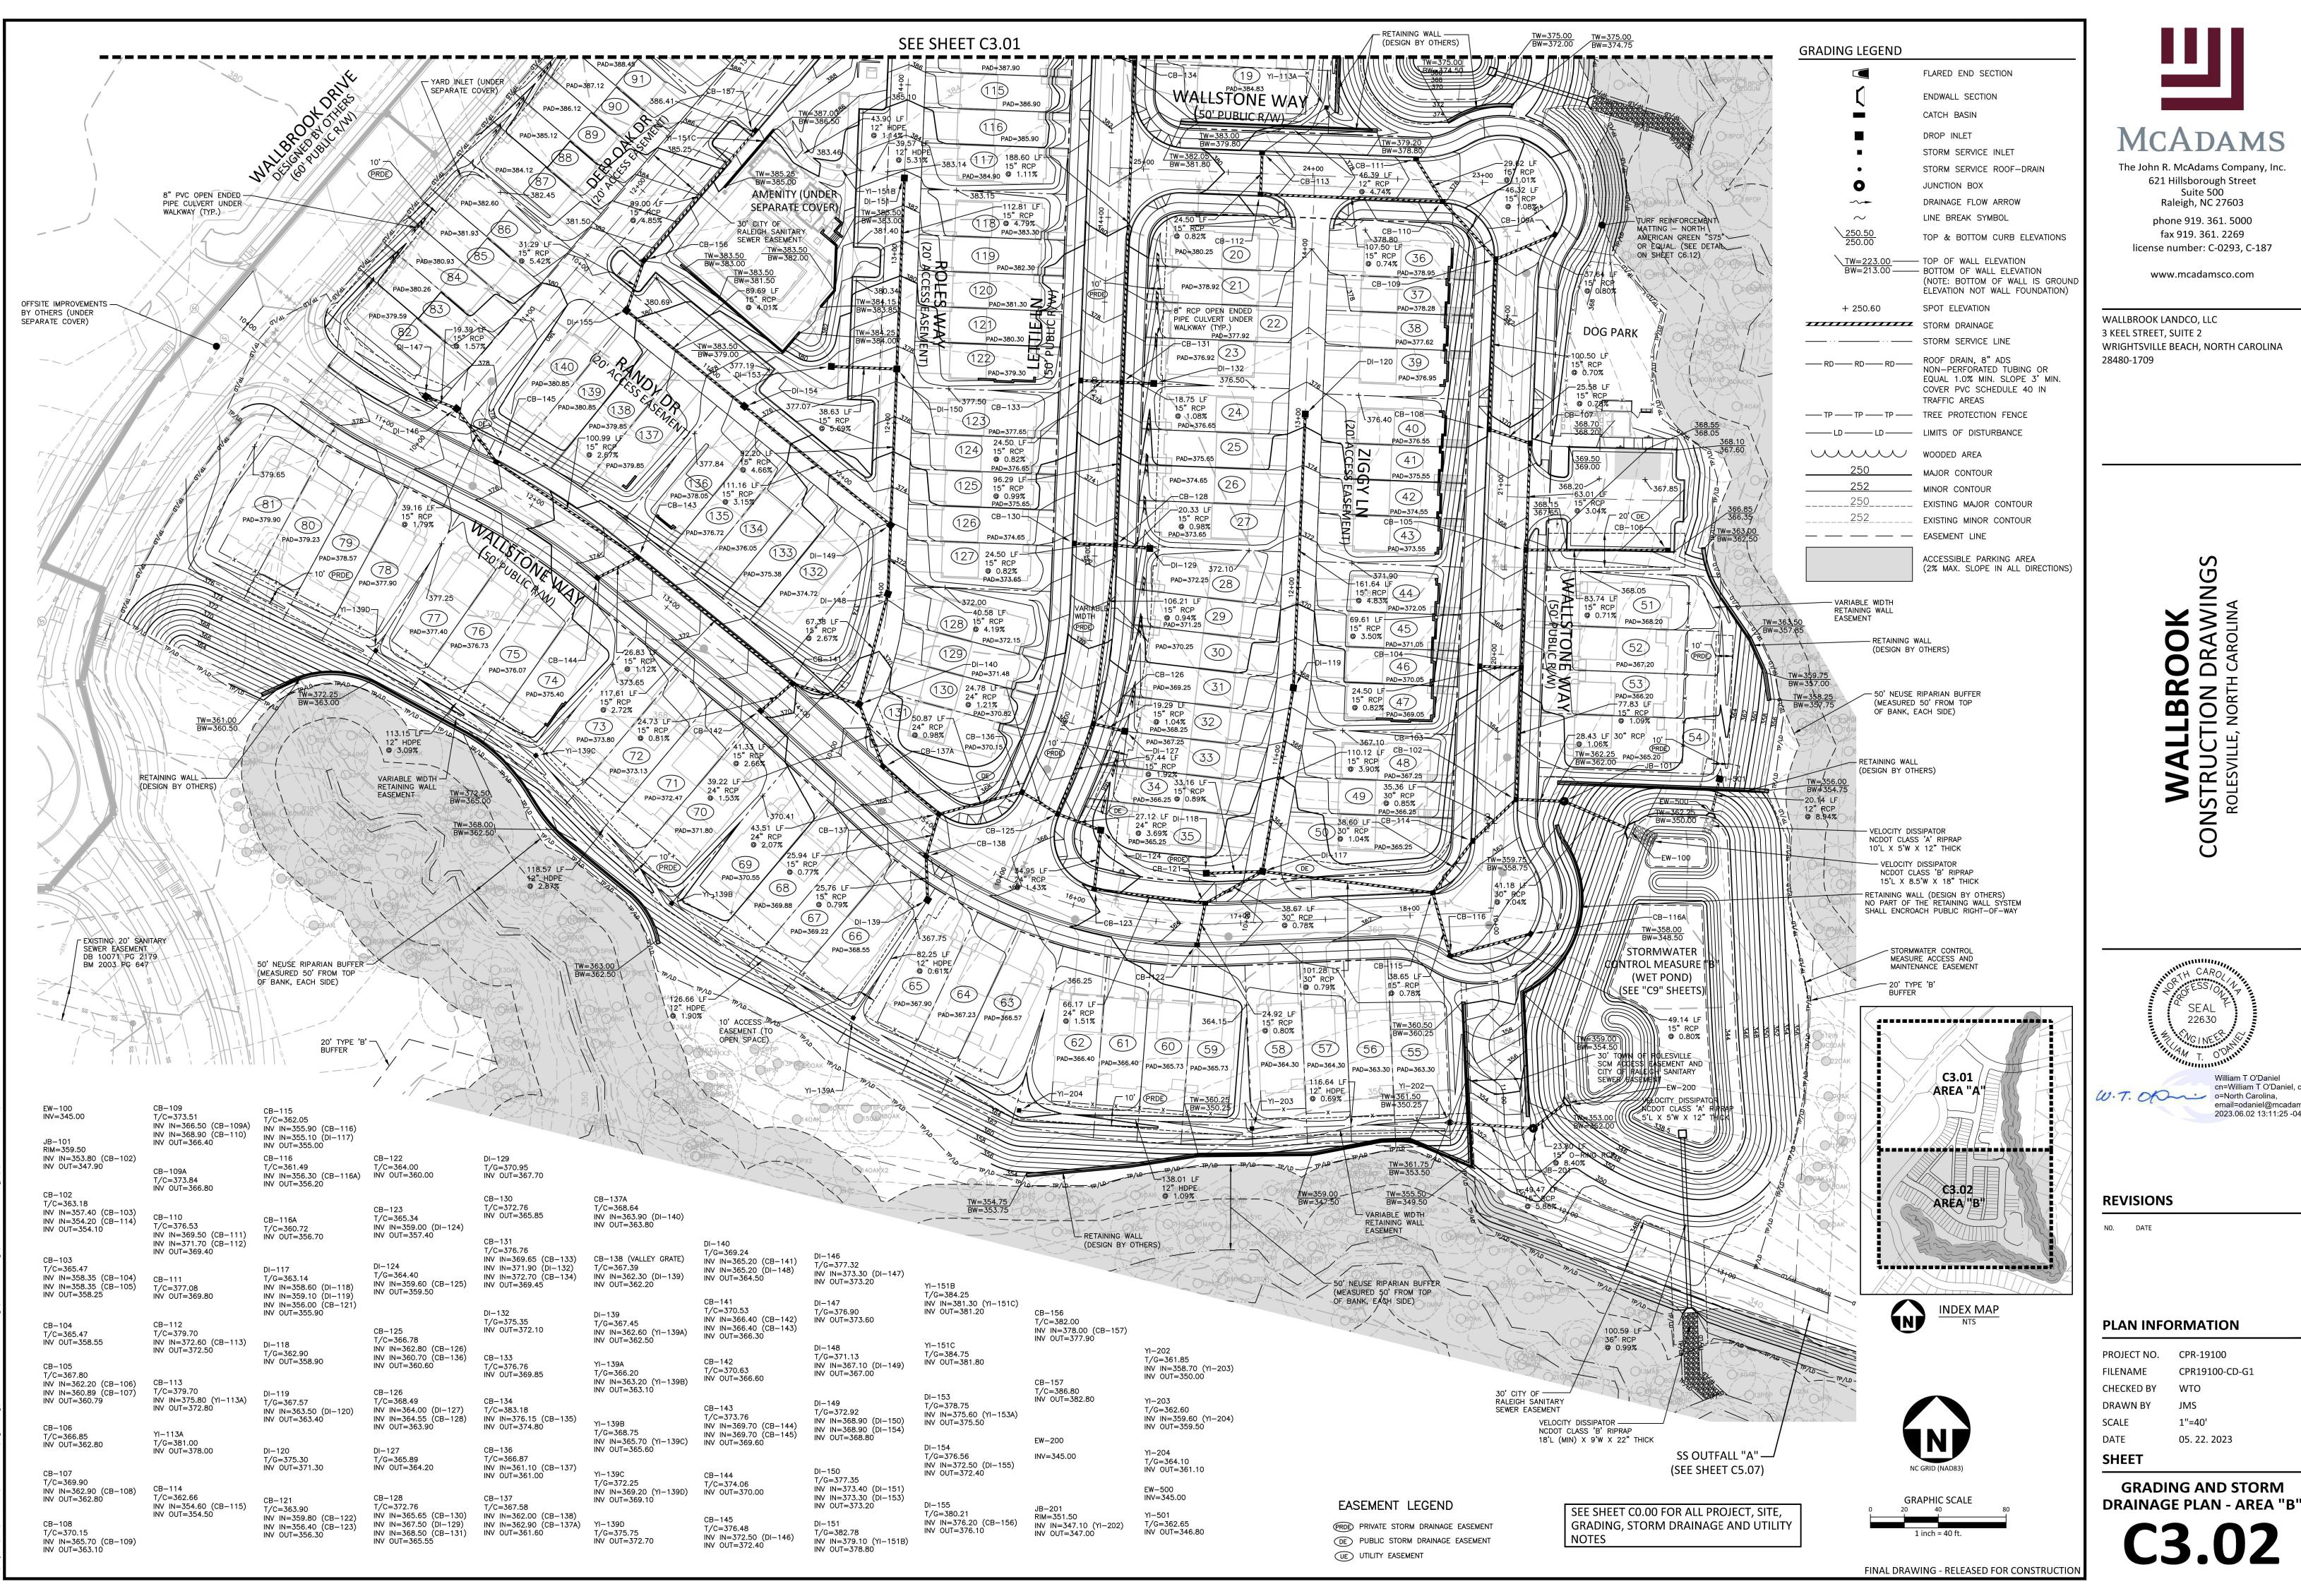




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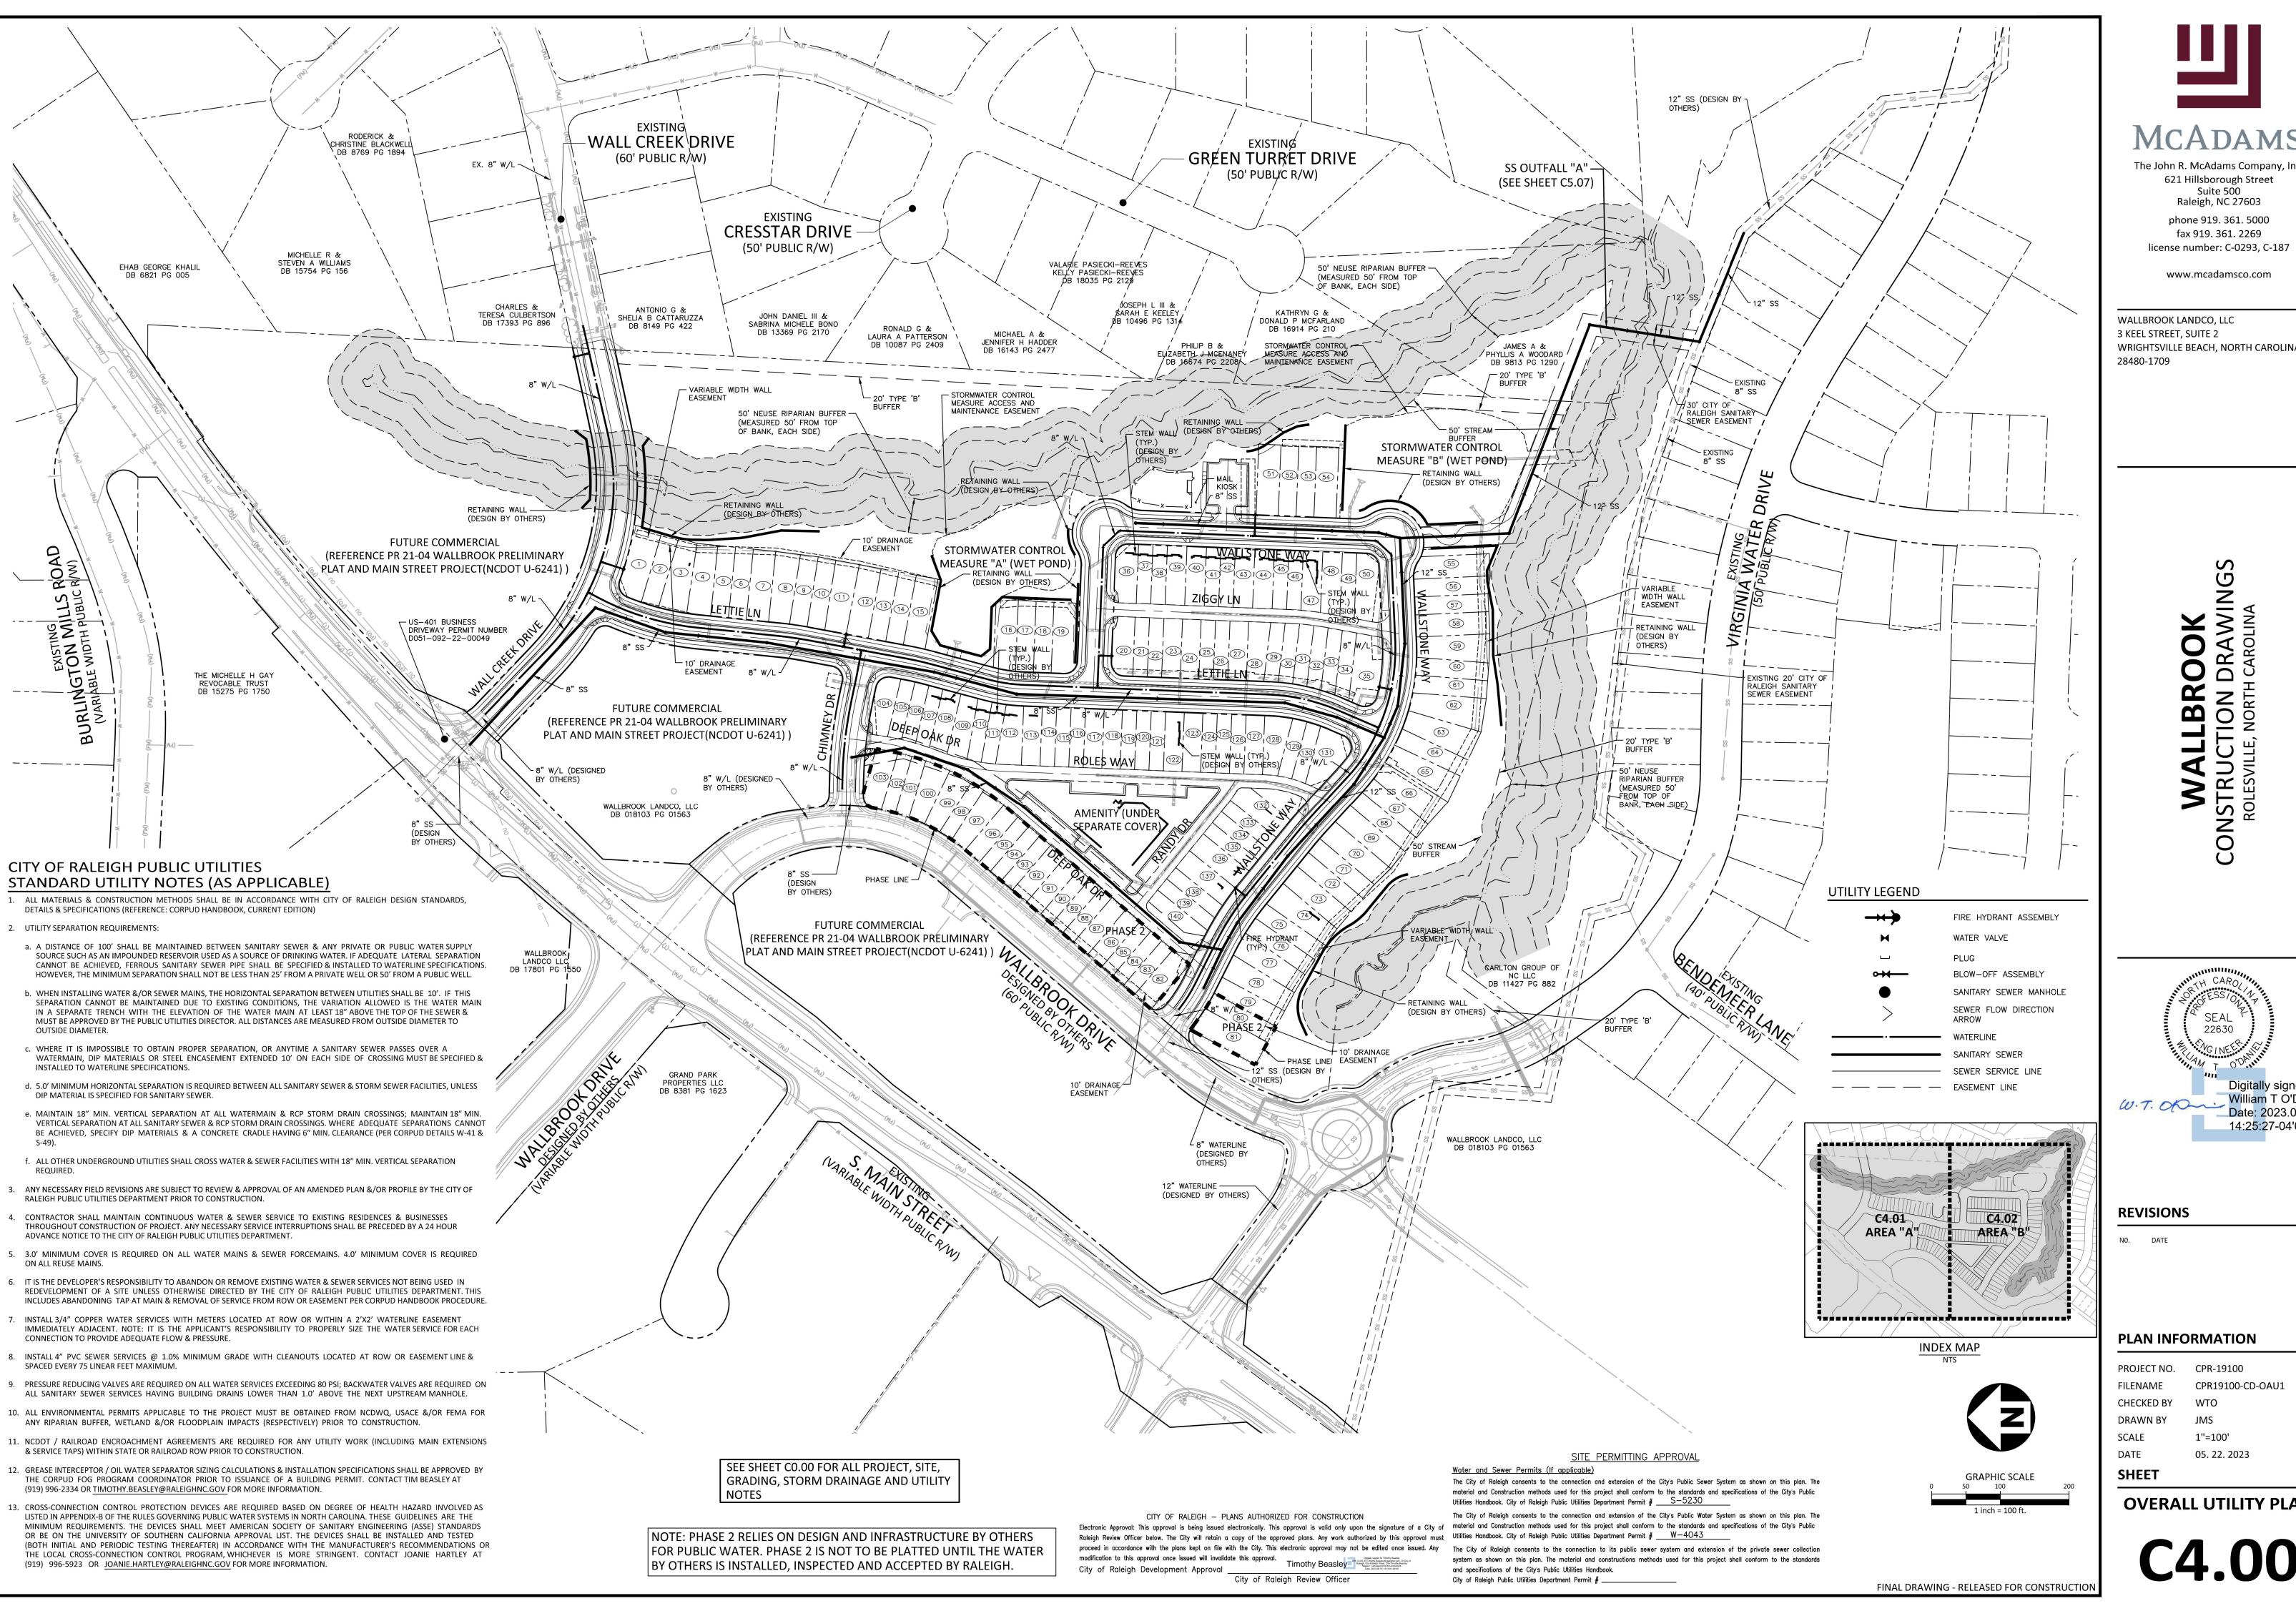
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PLAN INFORMATION

PROJECT NO. CPR-19100 **FILENAME** CPR19100-CD-G1 CHECKED BY DRAWN BY

1"=40' 05. 22. 2023

**SHEET GRADING AND STORM** 

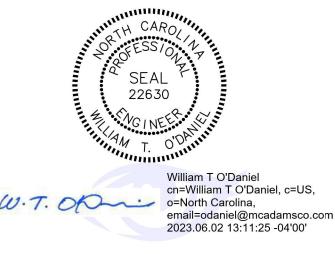


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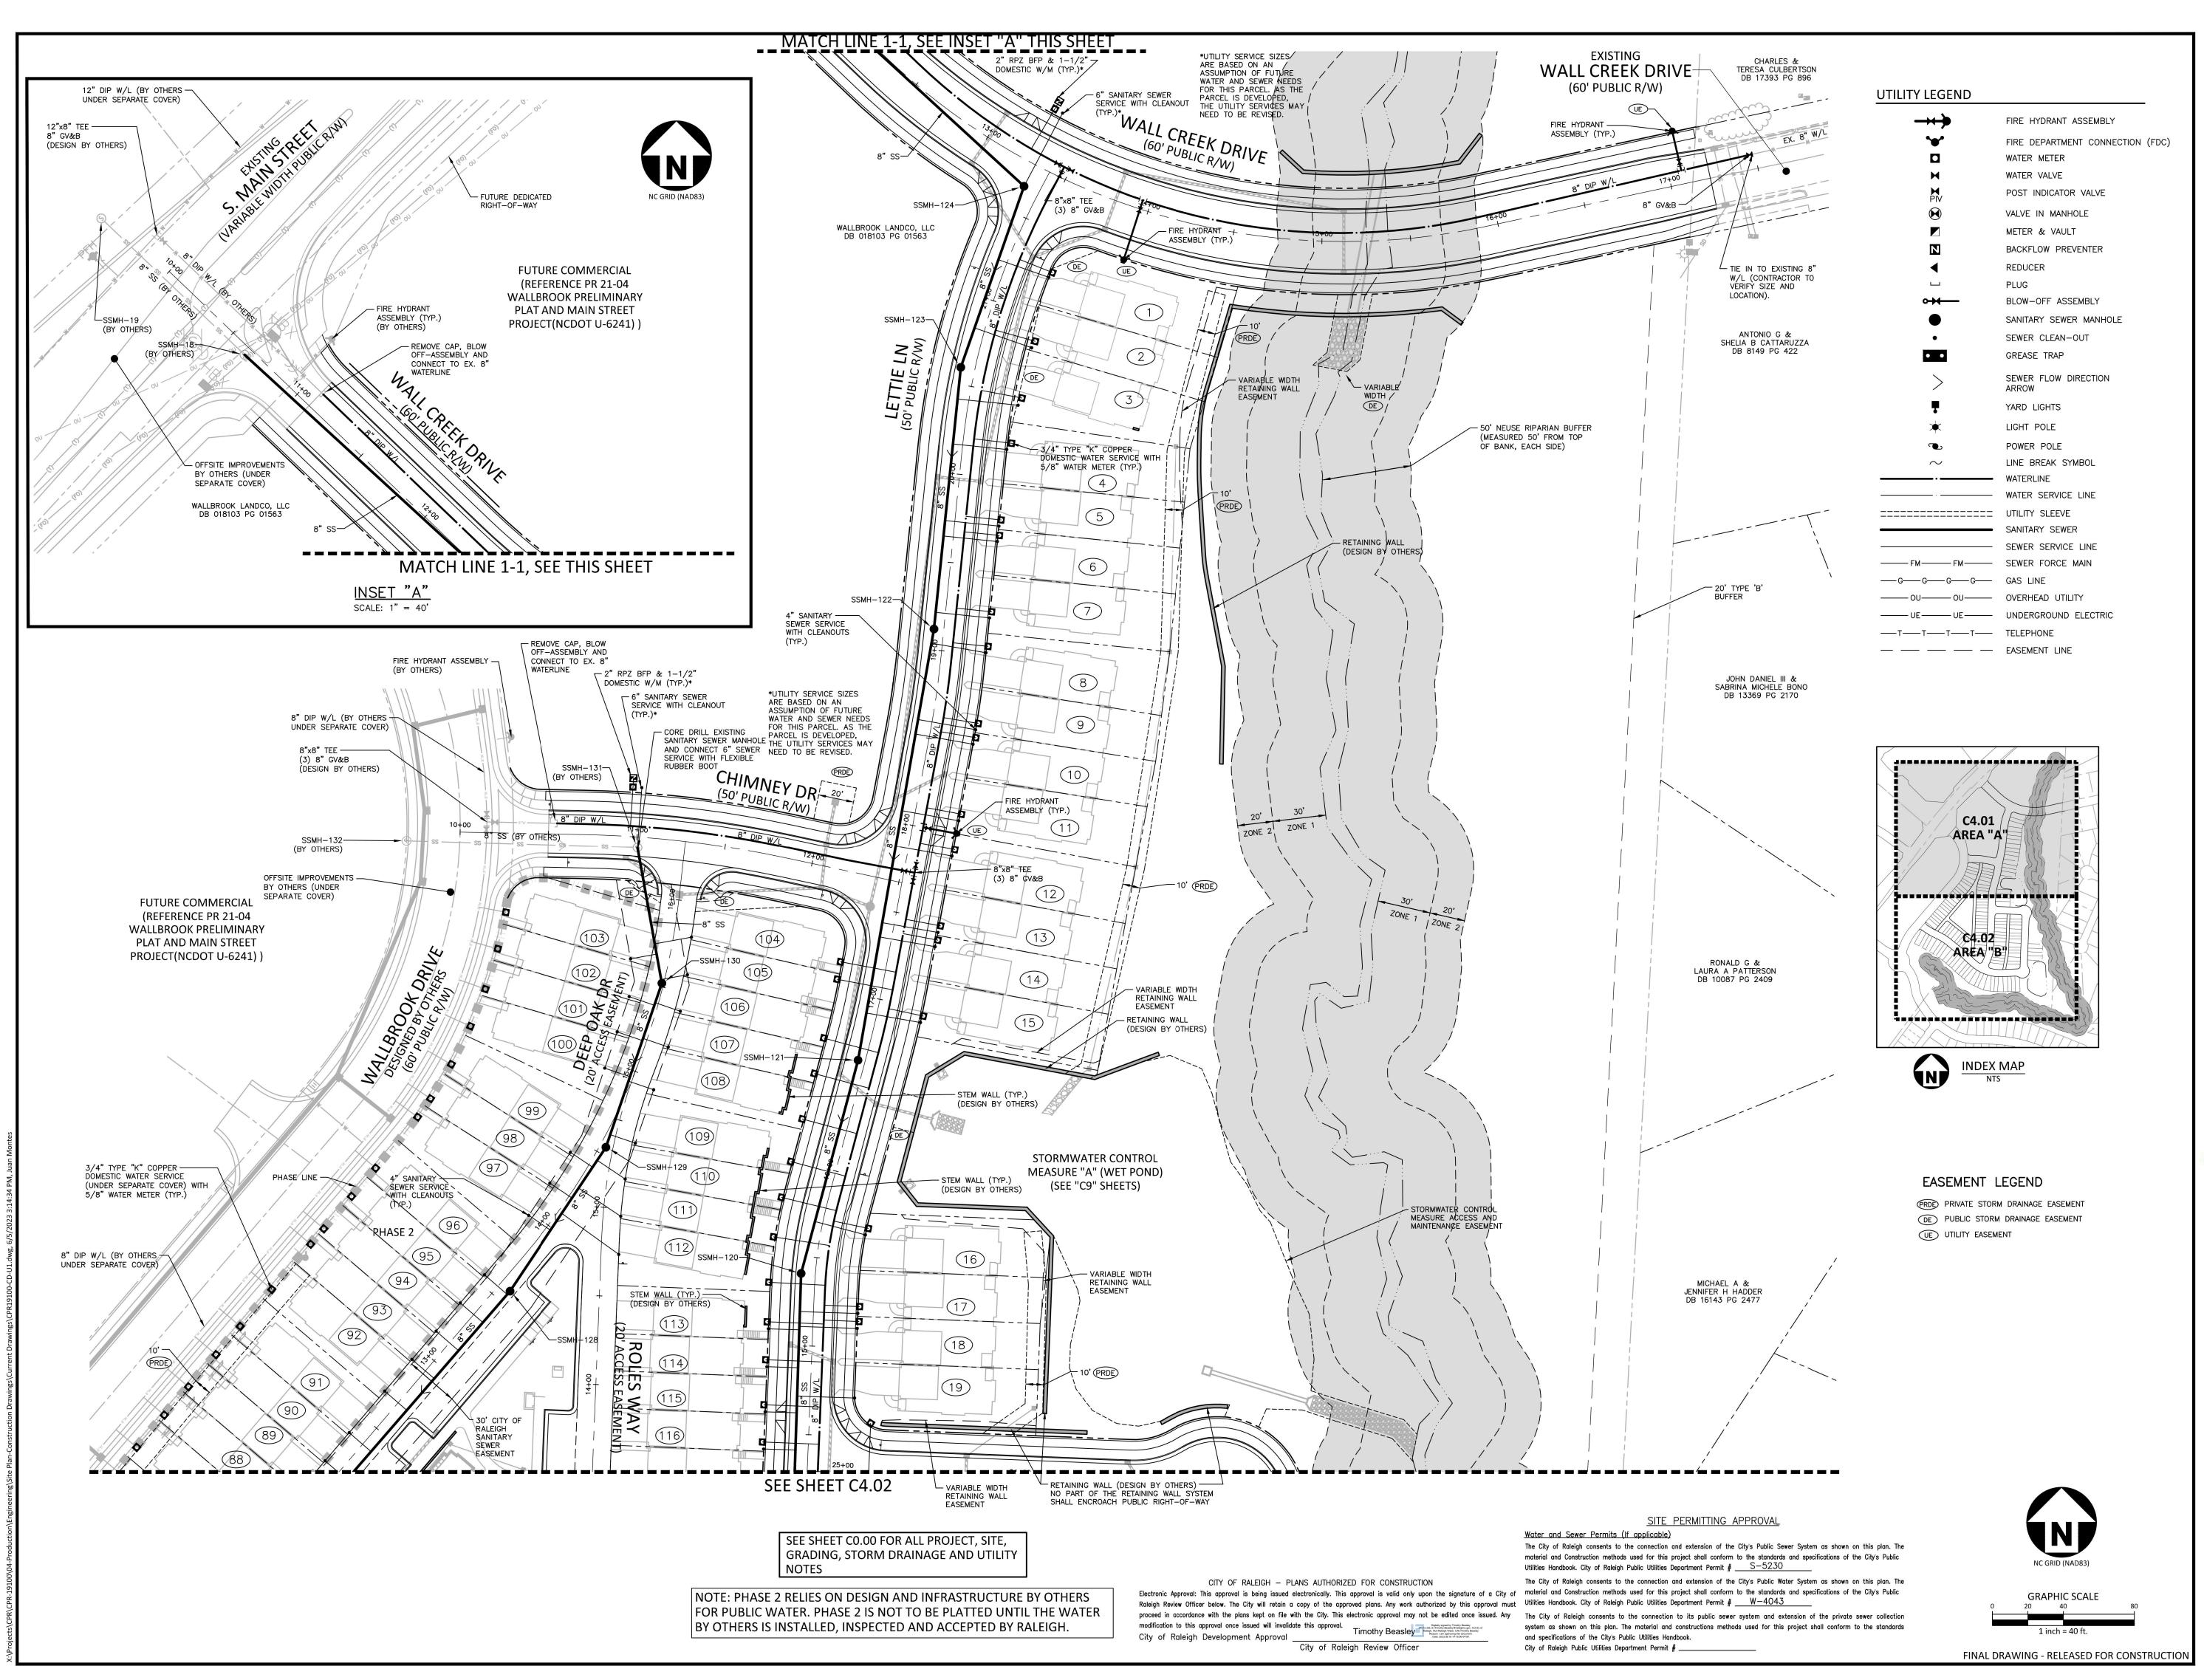
## PLAN INFORMATION

PROJECT NO. CPR-19100 **FILENAME** CPR19100-CD-OAU1 CHECKED BY

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**OVERALL UTILITY PLAN** 



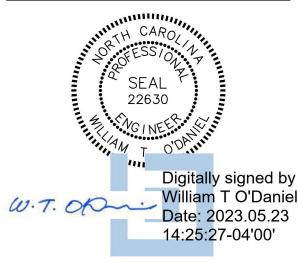

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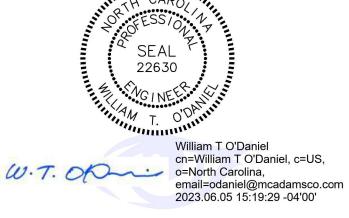
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ONSTRUCTION DRAWINGS
ROLESVILLE, NORTH CAROLINA



REVISIONS

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PLAN INFORMATION

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FILENAME CPR19100-CD-U1

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UTILITY PLAN - AREA "A"

C4.01