
ROLESVILLE, NC, USA TOWN PROJECT ID # V6-SDP-23-08

SITE LOCATION MAP

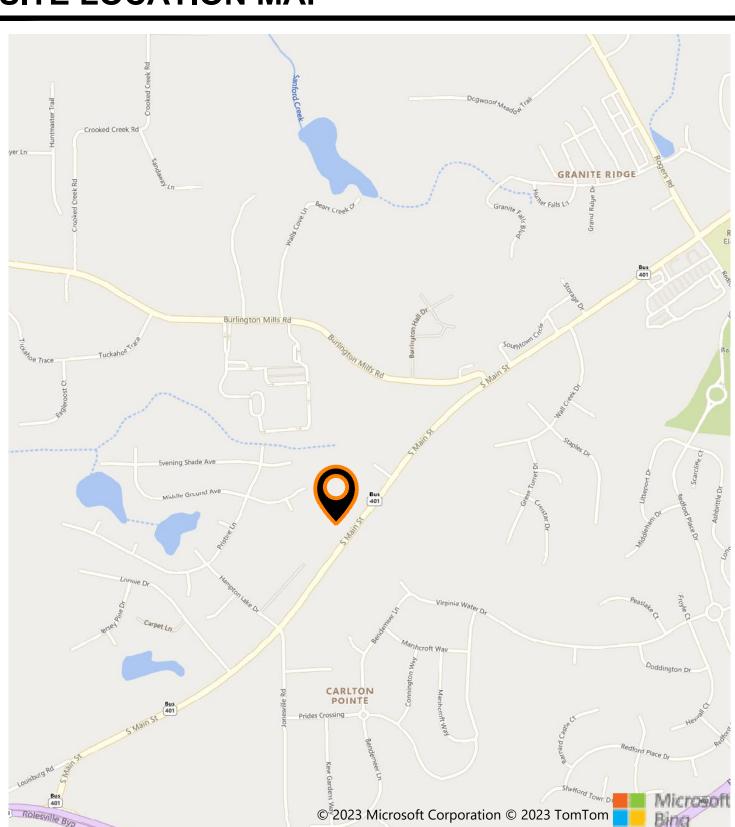

PROJECT DESCRIPTION

THIS PROJECT IS LOCATED ON A 1.92 ACRE SITE, IN ROLESVILLE, NC. THE PROPERTY AS IT EXISTS IS AN UNDEVELOPED LOT. THE PROPOSED DEVELOPEMENT WILL BE AN AUTOMATED CAR WASH WITH ASSOCIATED PARKING AND INFRASTRUCTURE.

THIS PROPERTY IS LOCATED OUTSIDE OF ANY REGULATED FLOOD ZONES, ZONEX (OTHER AREAS), NAVD88, SCALED FROM THE FIRM THE TOWN OF ROLESVILLE, NORTH CAROLINA PANEL NO. 3720175800K.

PARCEL ID: 1758-57-0146

ZONING DISTRICT: GENERAL COMMERCIAL CONDITIONAL ZONING (GC-CZ) PER REZ-24-03

GENERAL NOTES

PROJECT SURVEY INFORMATION AND CONTRACTOR VERIFICATION REQUIREMENTS

- 1. BOUNDARY, TOPOGRAPHIC, TREE, WETLAND DELINEATION, AND OTHER EXISTING CONDITIONS SHOWN ARE FROM SURVEY PREPARED BY MSP & ASSOCIATES LAND SURVEYING, INC. 2. ALL ELEVATIONS ARE BASED ON NAVD88 DATUM.
- 3. THE CONTRACTOR SHALL VERIFY THE EXISTING TOPOGRAPHIC WORK, EXISTING UTILITY LINE LOCATIONS AND ELEVATIONS PRIOR TO BEGINNING WORK. SHOULD THE CONTRACTOR FIND ANY DISCREPANCIES ON THE DRAWINGS PRIOR TO BEGINNING WORK OR DURING CONSTRUCTION, THE ENGINEER SHALL BE NOTIFIED
- THE CONTRACTOR SHALL MAINTAIN AND BE SOLELY RESPONSIBLE FOR JOBSITE SAFETY.
- AN AUTOCAD BASE PLAN OF THIS DRAWINGS CAN BE PROVIDED TO THE CONTRACTOR UPON REQUEST. ENGINEER SHALL NOT BE RESPONSIBLE FOR ERRORS IN ELECTRONIC DATA.
- 6. THE CONTRACTOR IS RESPONSIBLE FOR TRAFFIC CONTROL PLANS AND COORDINATION WITH THE TOWN OF ROLESVILLE AND NCDOT FOR LANE/ROAD CLOSURE AS NEEDED THROUGHOUT CONSTRUCTION. ALL SITE WORK TO BE PERFORMED IN CONFORMANCE WITH THE TOWN OF ROLESVILLE CODE OF ORDINANCE.
- MATERIAL SPECIFICATIONS ARE PROVIDED IN THE SPECIFICATIONS AND SPECIAL PROVISIONS SECTION. ALL UTILITY INSTALLATIONS, PUBLIC AND PRIVATE, SHALL BE PERFORMED IN CONFORMANCE WITH THE CITY OF
- RALEIGH WATER AND SEWER POLICIES, PROCEDURES, STANDARDS AND SPECIFICATIONS. 9. THIS DEVELOPMENT IS NOT REQUIRED TO PERFORM A TRAFFIC IMPACT ANALYSIS PER DETERMINATION BY LAND DEVELOPMENT ADMINISTRATOR ON 02/14/2024 PER LDO SECTION 8.C.5.





APPROVED EROSION CONTROL X SEC-113756-2023 STORMWATER MGMT. X SWF-113754-2023 FLOOD STUDY SWF-DATE 01/28/2025

EROSION CONTROL, STORMWATER

AND FLOODPLAIN MANAGEMENT

SITE OVERVIEW

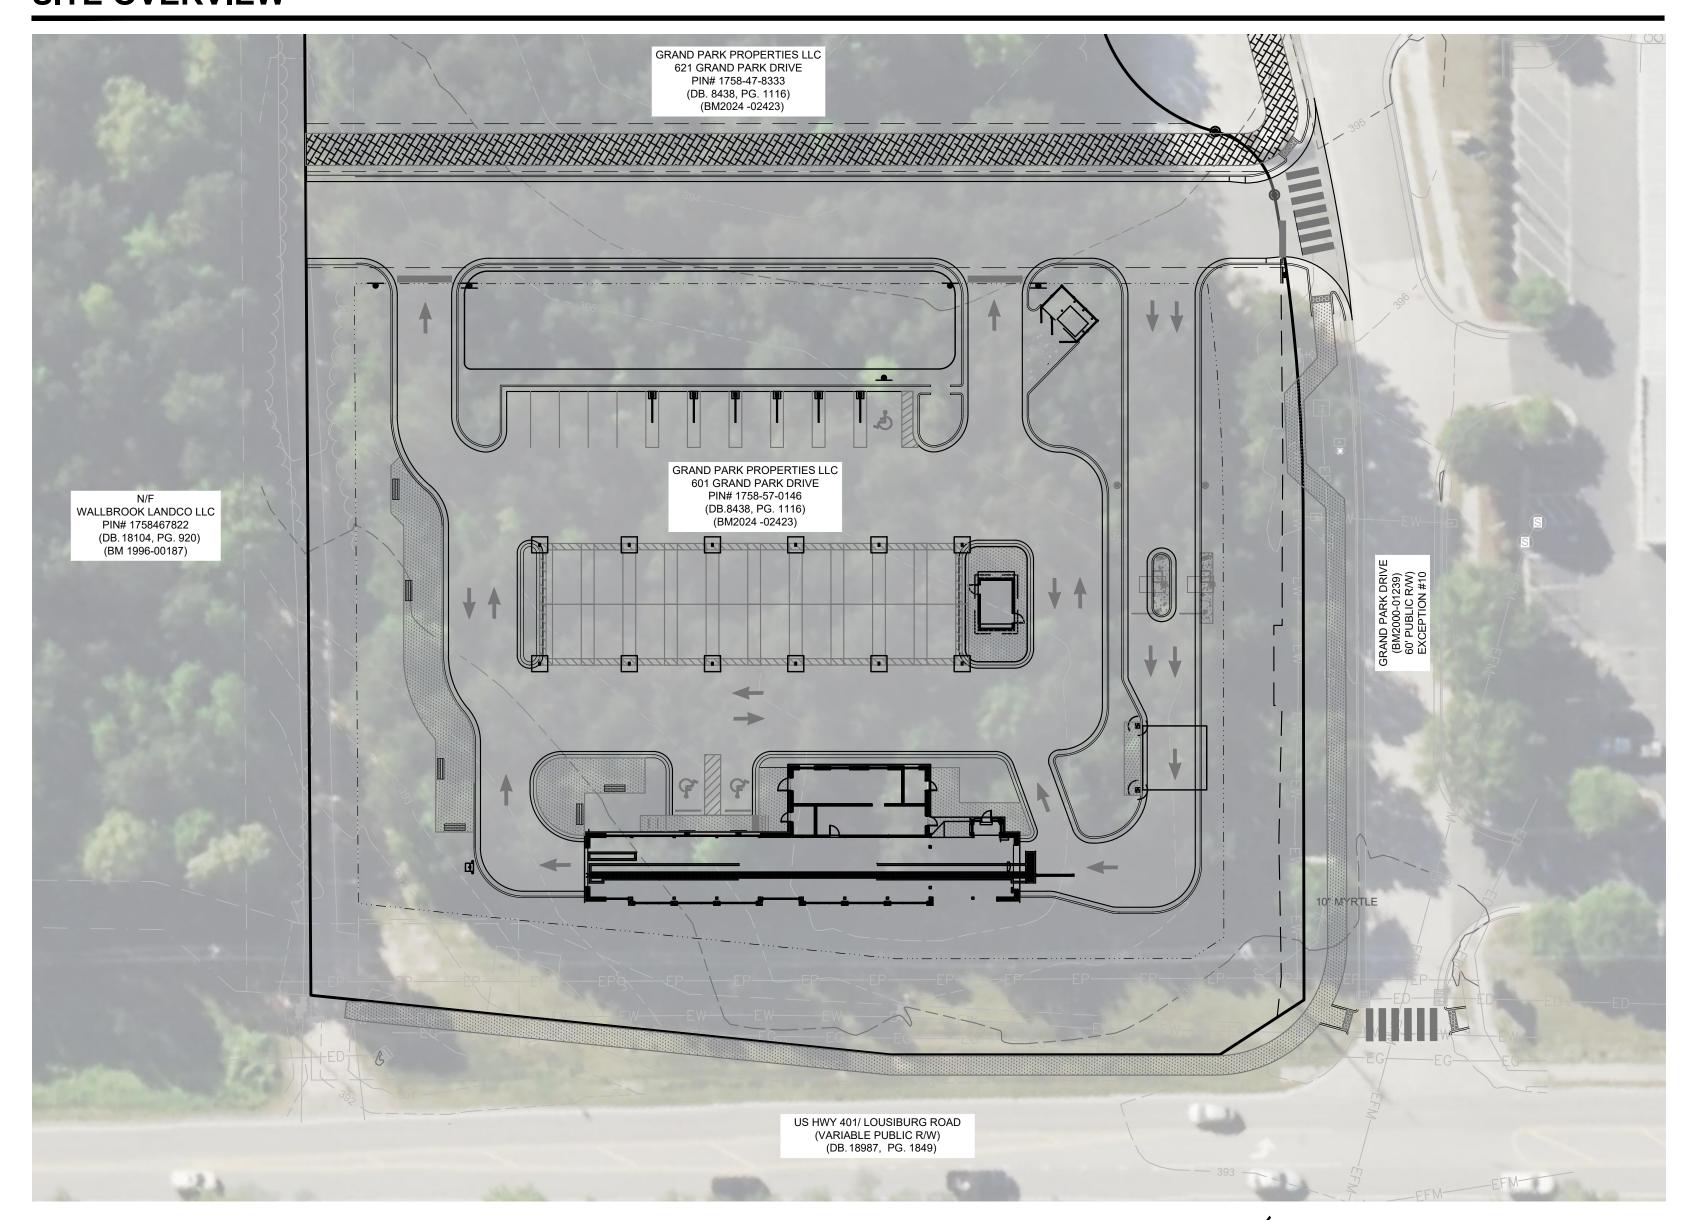

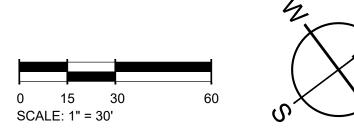

SURVEYOR

MSP & ASSOCIATES

LAND SURVEYING INC.

301 E. HILLCREST DR.

PHONE: (864) 370-2232

GREENVILEE, SC, 29609

PROJECT CONTACTS

DEVELOPER: SHJ DEVELOPMENT, LLC 124 EAST THOMPSON STREET POST OFFICE DRAWER 311 THOMASTON, GA 30286 **CONTACT: ALEX PERRY**

PHONE: 478-972-2418 OWNER:

GRAND PARK PROPERTIES, LLC 2636 WAIT AVENUE WAKE FOREST, NC 27587 CONTACT: GEORGE M. UPCHURCH, JR. PHONE: 919-996-3245

CIVIL ENGINEER & LANDSCAPE ARCHITECT: SOURCES: SEAMON WHITESIDE & ASSOCIATES, LLC SURVEYOR 230 E PETERSON DR CHARLOTTE, NC 28217 CONTACT: TOMMIE LITTLE PHONE: 980-312-5450

UTILITY CONTACTS: CITY OF RALEIGH PUBLIC UTILITIES ONE EXCHANGE PLAZA, RALEIGH, NC 27601

Water Distribution / Extension System

The City of Raleigh consents to the connection and extension of the City's public water system as shown on this plan. The material and Construction methods used for this project shall conform to the standards and specifications of the City's Public Utilities Handbook.

Public Utilities Department Permit # W-4162 Authorization to Construct

ATTENTION CONTRACTORS

The Construction Contractor responsible for the extension of water, sewer, and/or reuse, as approved in these plans, is responsible for contacting the Public Works Department at (919) 996-2409, and the Public Utilities Department at (919) 996-4540 at least twenty four hours prior to beginning any of their construction.

Failure to notify both City Departments in advance of beginning construction, will result in the issuance of *monetary fines*, and require reinstallation of any water or sewer facilities not inspected as a result of this notification failure.

Failure to call for Inspection, Install a Downstream Plug, have Permitted Plans on the Jobsite, or any other Violation of City of Raleigh Standards will result in a Fine and Possible Exclusion from future work in the City of Raleigh.

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E1.2	SITE PHOTOMETRIC PLAN

SITE INFORMATION:

PROPOSED USE: CAR WASH

ADDRESS: 601 GRAND PARK DRIVE, ROLESVILLE, NC PROPERTY AREA: 1.92 ACRES PARCEL: 1758-57-0146 EXISTING USE: UNDEVELOPED

TOWN CORPORATE ZONING LIMITS PER ANX-24-02:

PROPERTY ZONING: GENERAL COMMERCIAL CONDITIONAL ZONING (GC-CZ) PER REZ-24-03

BUILDING SETBACKS: FRONT (SE): CORNER (NE): REAR (NW): SIDE (SW):

PERIMETER LANDSCAPE YARDS: NORTHEAST:

REQUIRED OPEN SPACE (5%) = 0.01 AC (4182 SF)

PRE VS. POST DEVELOPMENT AREA:

PRE-IMPERVIOUS AREA: 0.04 AC (2.08%) 1.30 AC (67.7%) POST-IMPERVIOUS AREA:

PARKING NOTE:

PARKING REQUIRED:

1 SPACE PER 400 SF GFA OR 5 SPACES MINIMUM = 5 SPACES

PARKING PROVIDED: EMPLOYEE SPACES:

5 SPACES

33 SPACES

(4 MAX ON SHIFT)

26 STALLS (1 ADA) VACUUM STALLS: ADA PARKING: 2 SPACES

TOTAL PARKING:

BIKE PARKING: REQUIRED: 1 SPACE (1 SPACE PER 5000 SF GFA) PROVIDED: 4 SPACES

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SW+ PROJECT: 1/28/24 DRAWN BY: CPE

CHECKED BY: **REVISION HISTORY** A 12/22/23 F 11/06/24 B 03/01/24 G 12/20/24

D 10/01/24 E 11/01/24

C 09/04/24 H 1/03/25

TITLESHEET

			DRAV	VIN	G LEC	SEND	NOTE: THIS LEGEND DOES THE ORIGINAL FORMAT AS	NOT APPLY TO 'EXISTING CONDITIONS' SHEET(S). THO: RECEIVED BY THE SURVEYOR	SE ARE SHOWN IN
OBJECTS AND SYMBOLS	EXISTING	<u>NEW</u>	OBJECTS AND SYMBOLS	EXISTIN	G <u>NEW</u>	<u>HATCH PATTERNS</u>		SWPP PLAN LEGEN	<u>ID</u>
Right of Way			Benchmark Sanitary Sewer Manhole	S	N/A			Turf Reinforcement Mat	TR
Lot Line			Sanitary Sewer Manhole ID # Sanitary Sewer Cleanout	N/A	(MH) # ⊗	Demo Existing Gravel		Sodding (See Turf and Grasses Specs)	S
Adjoining Property Line Easement		N/A	TYPE 1 Storm Drainage Structure (CI-1) Catch Basin (CB)					Temporary Seeding (See Schedule in EC Notes)	TS
Setback		(Same as Existing)	Storm Drainage Junction Box (JB)			Demo Existing Trees		Permanent Seeding (See Turf and Grasses Species)	PS
Sanitary Sewer (Gravity)	ES	s	Yard Inlet (YI) Control Structure (CS)	YI	YI CS		<u> </u>	Erosion Control Blanket (See Turf and Grasses Species)	EC
Sanitary Sewer (Force Main) Water Line	EFM	——————————————————————————————————————	Storm Drainage Structure ID # Telephone Box	N/A	(#) N/A	Proposed Sidewalk		Concrete Washout Basin	CW
Curb & Gutter (Straight)			Telephone Manhole Electrical Box	(Î) [E]	N/A N/A			Block & Stone Inlet Protection	
Curb & Gutter (Roll)	(Width varies with size)		Electrical Manhole Power Pole	(E)	N/A	Heavy Duty Concrete		Filter Fabric Inlet Protection	
Previous Phase Storm Drain Pipe Storm Drain Pipe	ED	N/A (Width varies with size)	Light Pole Fire Hydrant Assembly	¤ -0- H	* * <u>+</u>	Pavement	4	Construction Entrance	
Drainage Flow Arrow	N/A	~~ ~	Water Line Valve	\bowtie	101				,
Silt Fence, Standard	ESF	SF	Water Line Reducer Sign		<u>•</u>	Standard Duty Concrete Pavement		Dandy Sack or Grate Gator Inlet Protection	
Match Line Drainage Basin Limits	N/A N/A		ADA Accessible Parking Space	<u> </u>	<u>.</u>				
Conduit	EC	c	Spot Elevation	₊ X.XX	√X.XX	Asphalt Greenway			
Natural Gas	EG	G	Drainage Basin Area	N/A	X.XXAc				
Overhead Electrical Underground Electrical	EP	P	Parking Count ID #	N/A	(2)				
Underground Telephone	ET	т ———	Revision ID #	N/A		Area to be Permanently Stabilized			
Fence	X	x	Rip Rap at Pipe Outlet	N/A					
Elevation Contour	22								
Revision Cloud (Encloses Revision)	N/A								

SEAMONWHITESIDE

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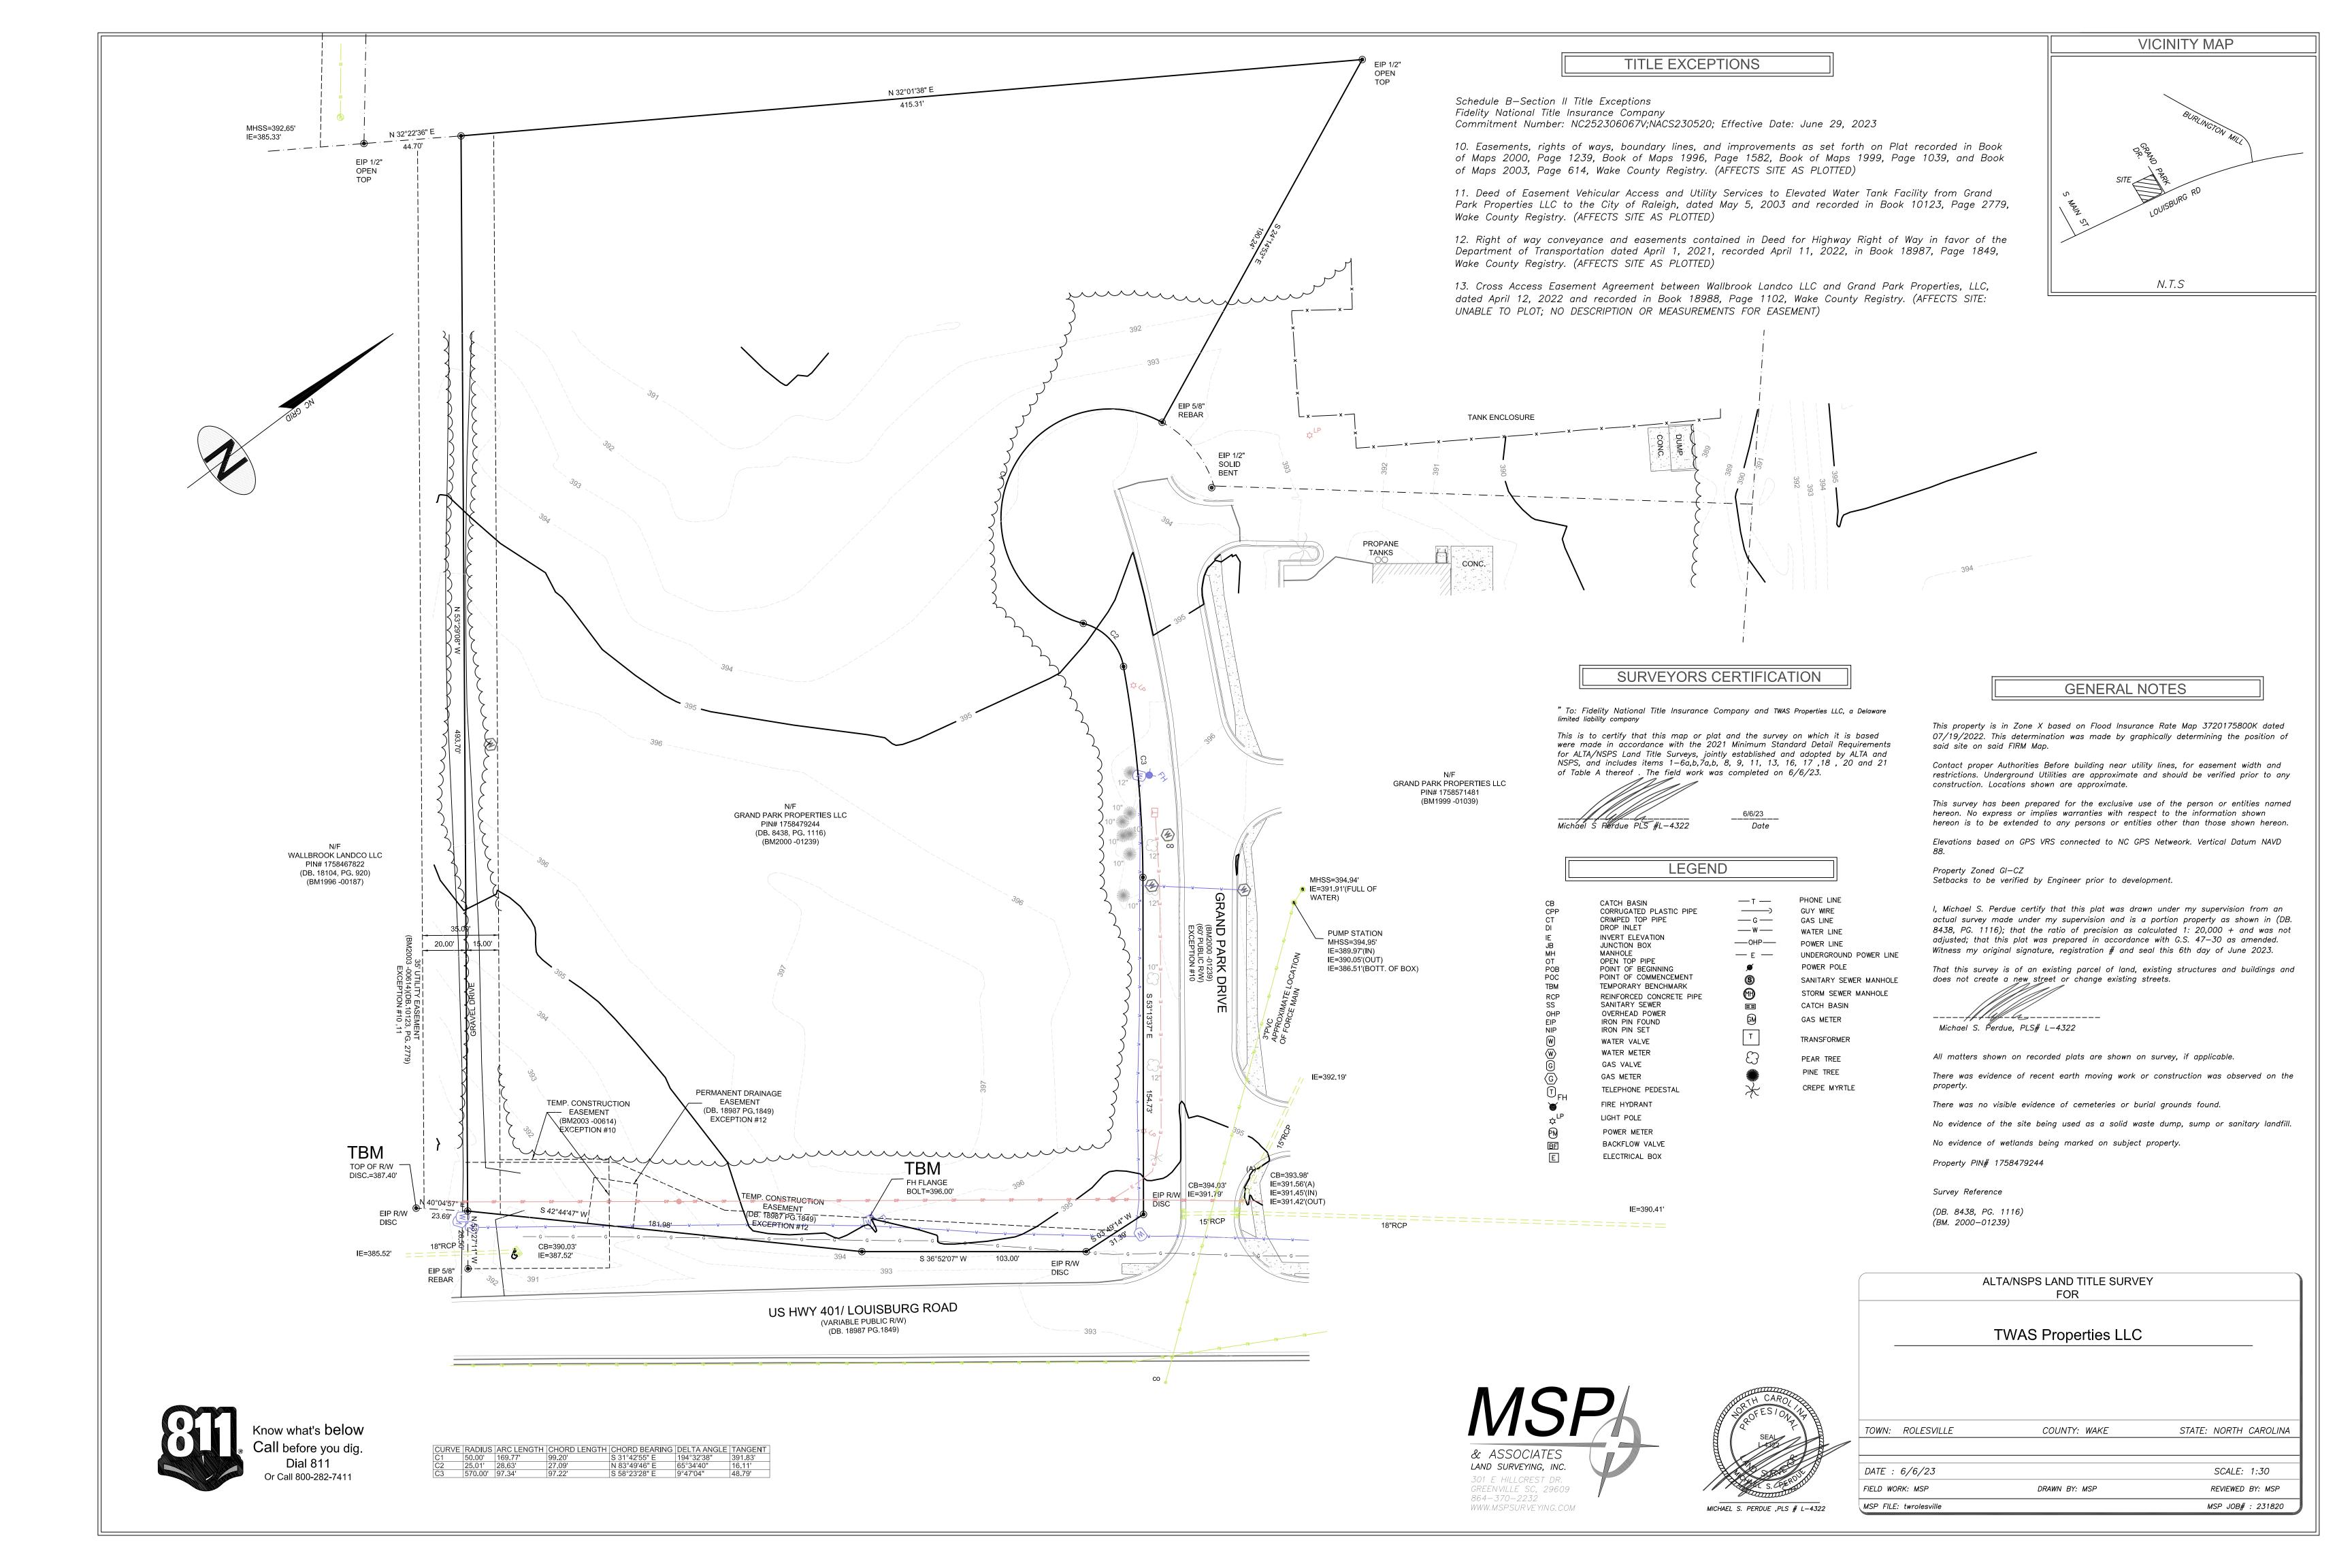





VE AUTO SPA

SW+ PROJECT: 10772
DATE: 1/28/24
DRAWN BY: CPE
CHECKED BY: TLL

LEGEND & REVISION NOTES



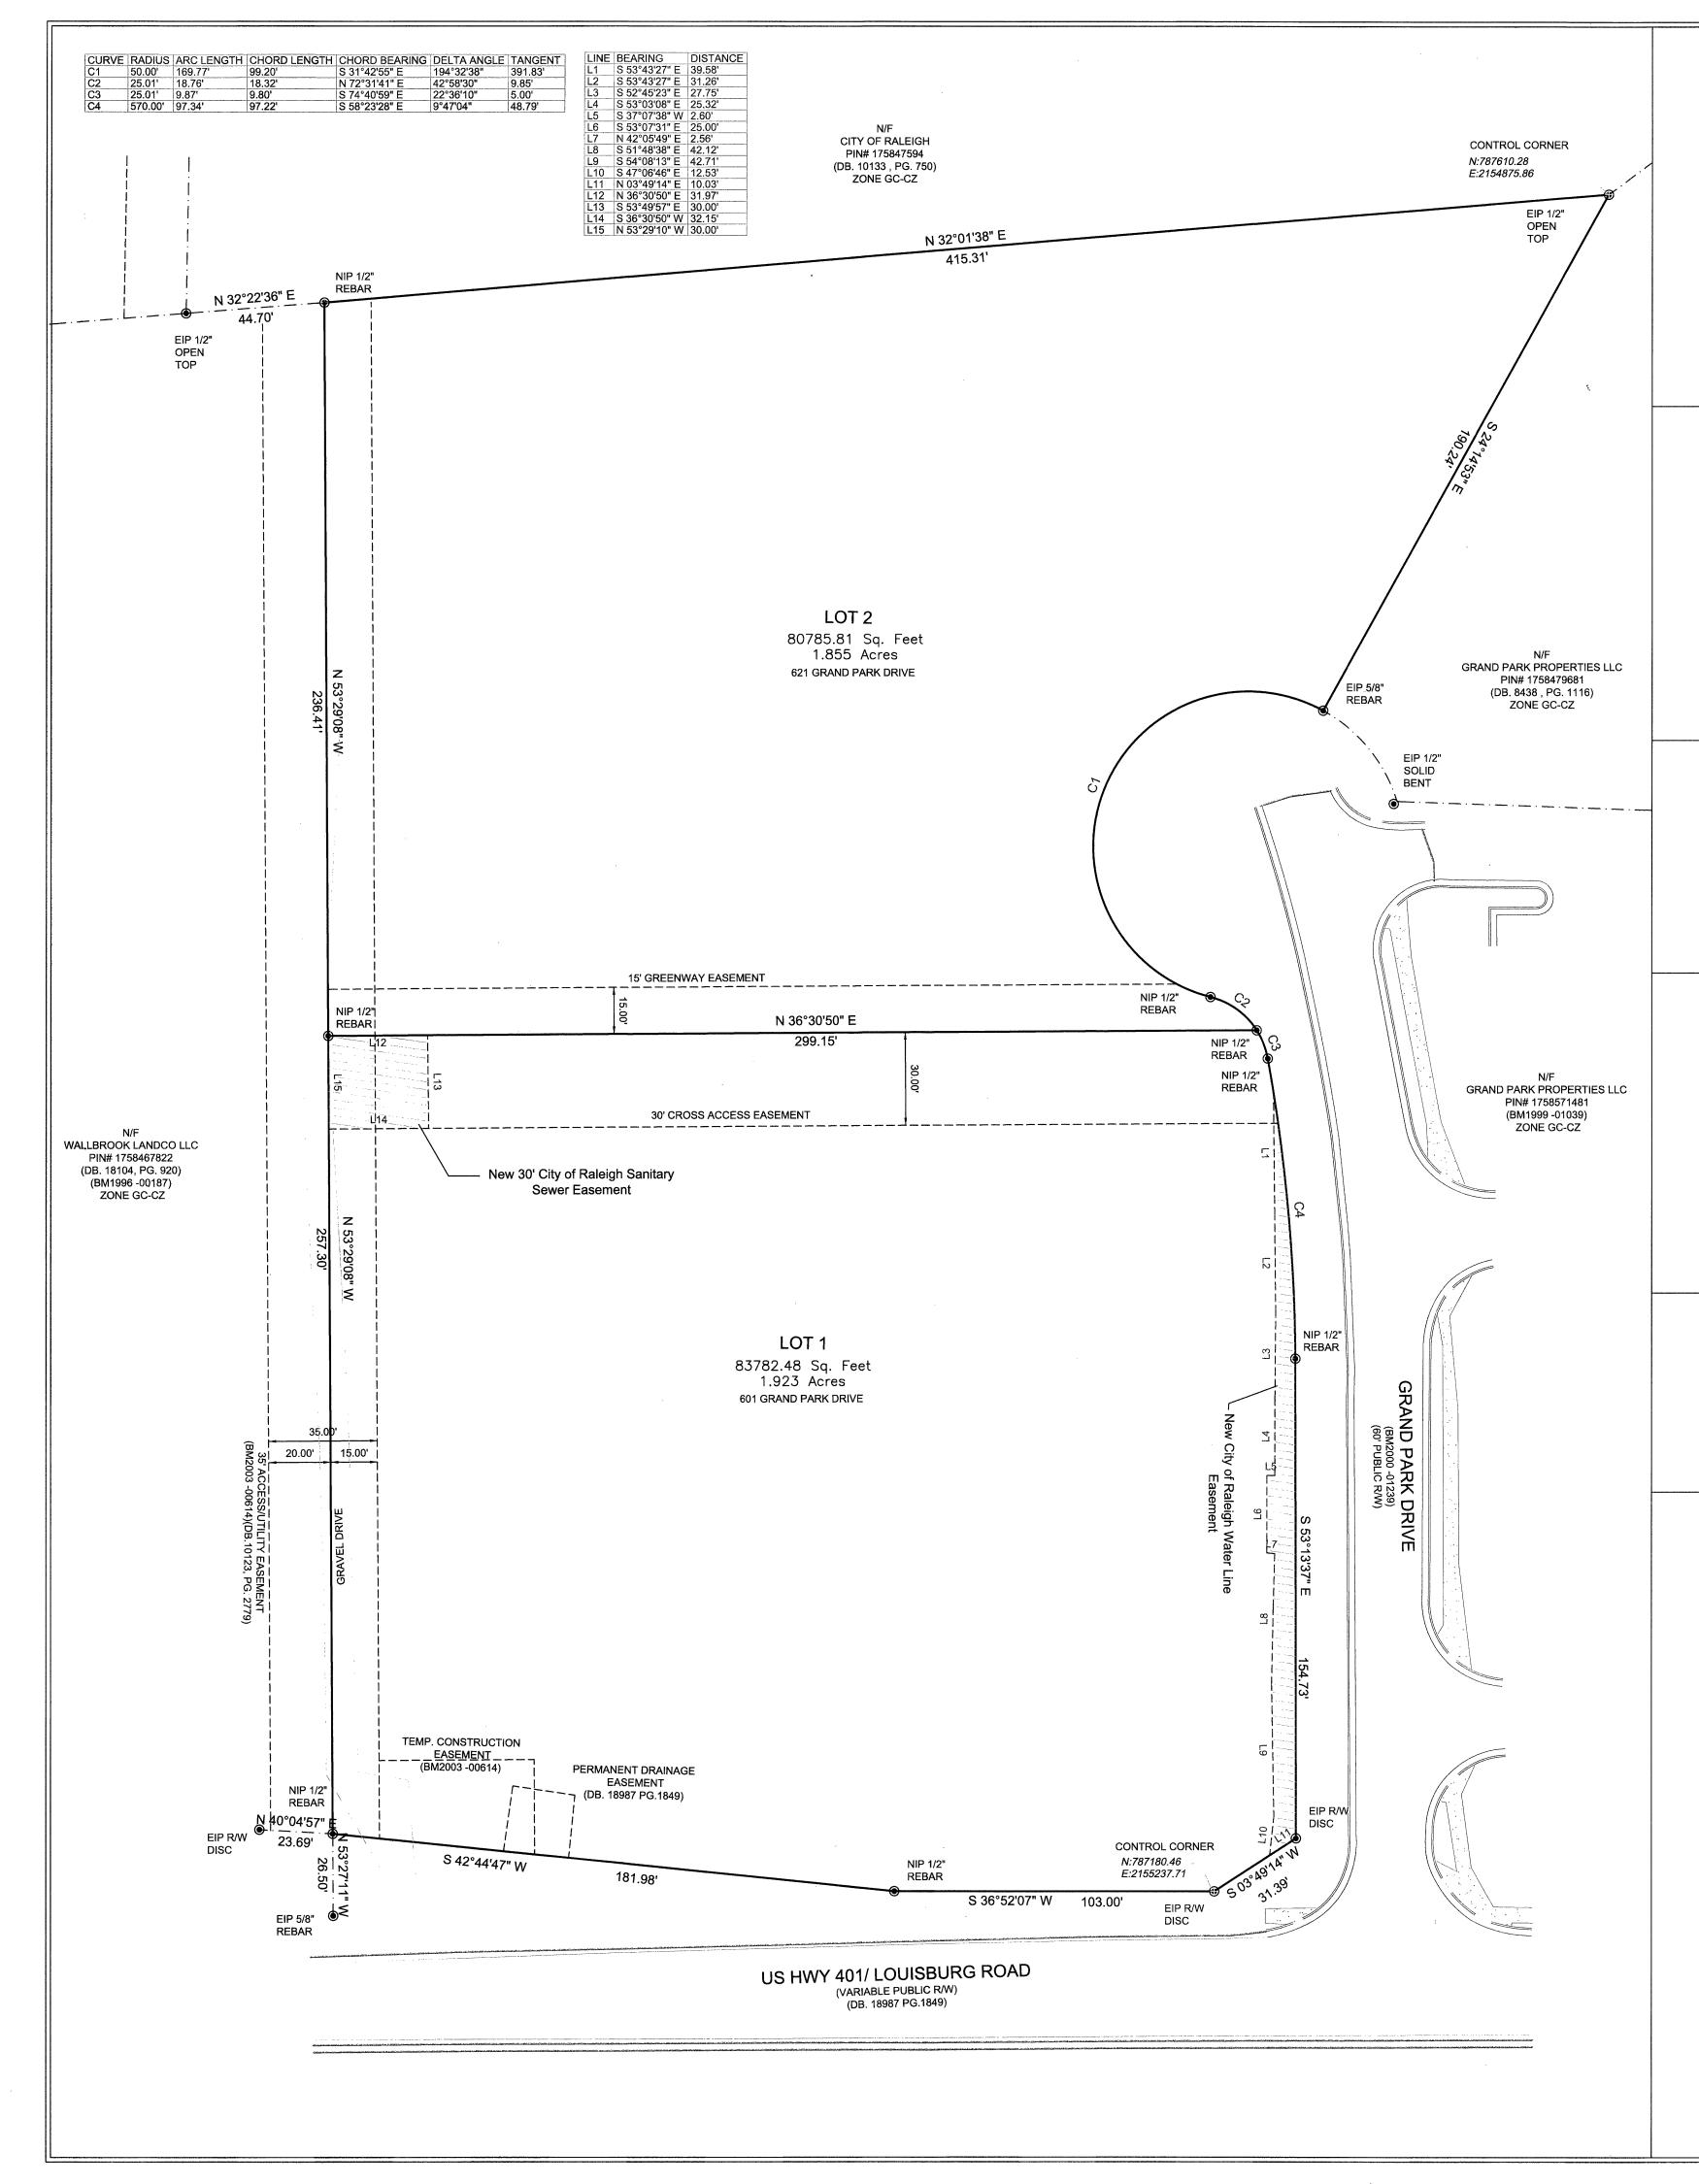

Certificate of Ownership and Dedication

I hereby certify that I am the owner of the property shown and describe hereon, which is in the subdivision jurisdiction of the Town of Rolesville and that I hereby adopt this plan of subdivision with my free consent and establish minimum building setback lines as noted.

Certificate of Approval for Recording

I hereby certify that the subdivision plat shown hereon has been found to comply with the Subdivision Regulations of the Town of Rolesville, North Carolina and that this plat has been approved by the LDA of the Town of Rolesville for recording in the Office of the Register of Deeds of Wake County.

Rolesville, North Carolina

I, <u>Meredith Gruber</u>, Review Officer of the Town of Rolesville, Wake County, certify that the map or plat to which this certification is affixed meets all statutory requirements for recording.

I, Michael S. Perdue certify that this plat was drawn under my supervision from an actual survey made under my supervision and is a portion property as shown in (DB. 8438, PG. 1116); that the ratio of precision as calculated 1: 20,000 + and was not adjusted; that this plat was prepared in accordance with G.S. 47—30 as amended. Witness my original signature, registration # and seal this 25th day of Nov. 2024.

That the survey creates a subdivision of land within the area of a county or municipality that has an ordinance that regulates parcels of land.

Michael S. Pérdue, PLS# L-4322

LOT TABLE

LOT 1

83782.48 Sq. Feet 1.923 Acres


1.30 Acres Impervious Area

LOT 2 80785.81 Sq. Feet

1.855 Acres

0.07 Acres Impervious Area

VICINITY MAP N.T.S

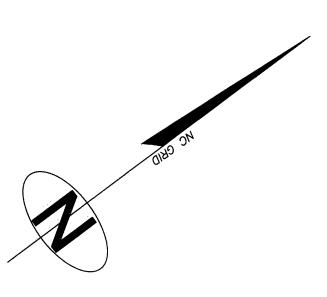

GENERAL NOTES


1) This property is in Zone X based on Flood Insurance Rate Map 3720175800K dated 07/19/2022. This determination was made by graphically determining the position of said site on said FIRM Map.

General Commercial Conditional Zoning (GC-CZ) District per Rezoning Application REZ-24-03, approved on 08-06-2024.

3) Property PIN# 1758479244

4) Purpose of this plat is to sub divide parcel into two lots as shown hereon.

5) Survey Reference (DB. 8438, PG. 1116) (BM. 2000-01239)

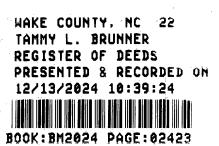


LEGEND

BOUNDARY CORNER IRON PIN FOUND IRON PIN SET


EASEMENT LINE ADJOINING PROPERTY

OWNER INFORMATION

GRAND PARK PROPERTIES LLC 2636 WAIT AVE WAKE FOREST, NC 27587

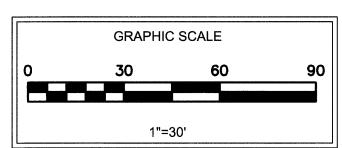



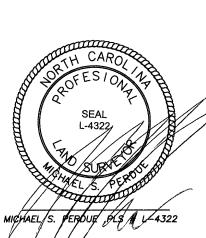


MINOR FINAL SUBDIVISION PLAT


TWAS Properties LLC

NOWN: ROLESVILLE COUNTY: WAKE STATE: NORTH CAROLINA

DATE : 11/25/24 SCALE: 1:30 DRAWN BY: MSP REVIEWED BY: MSP

FIELD WORK: MSP MSP FILE: twrolesville MSP JOB# : 231820

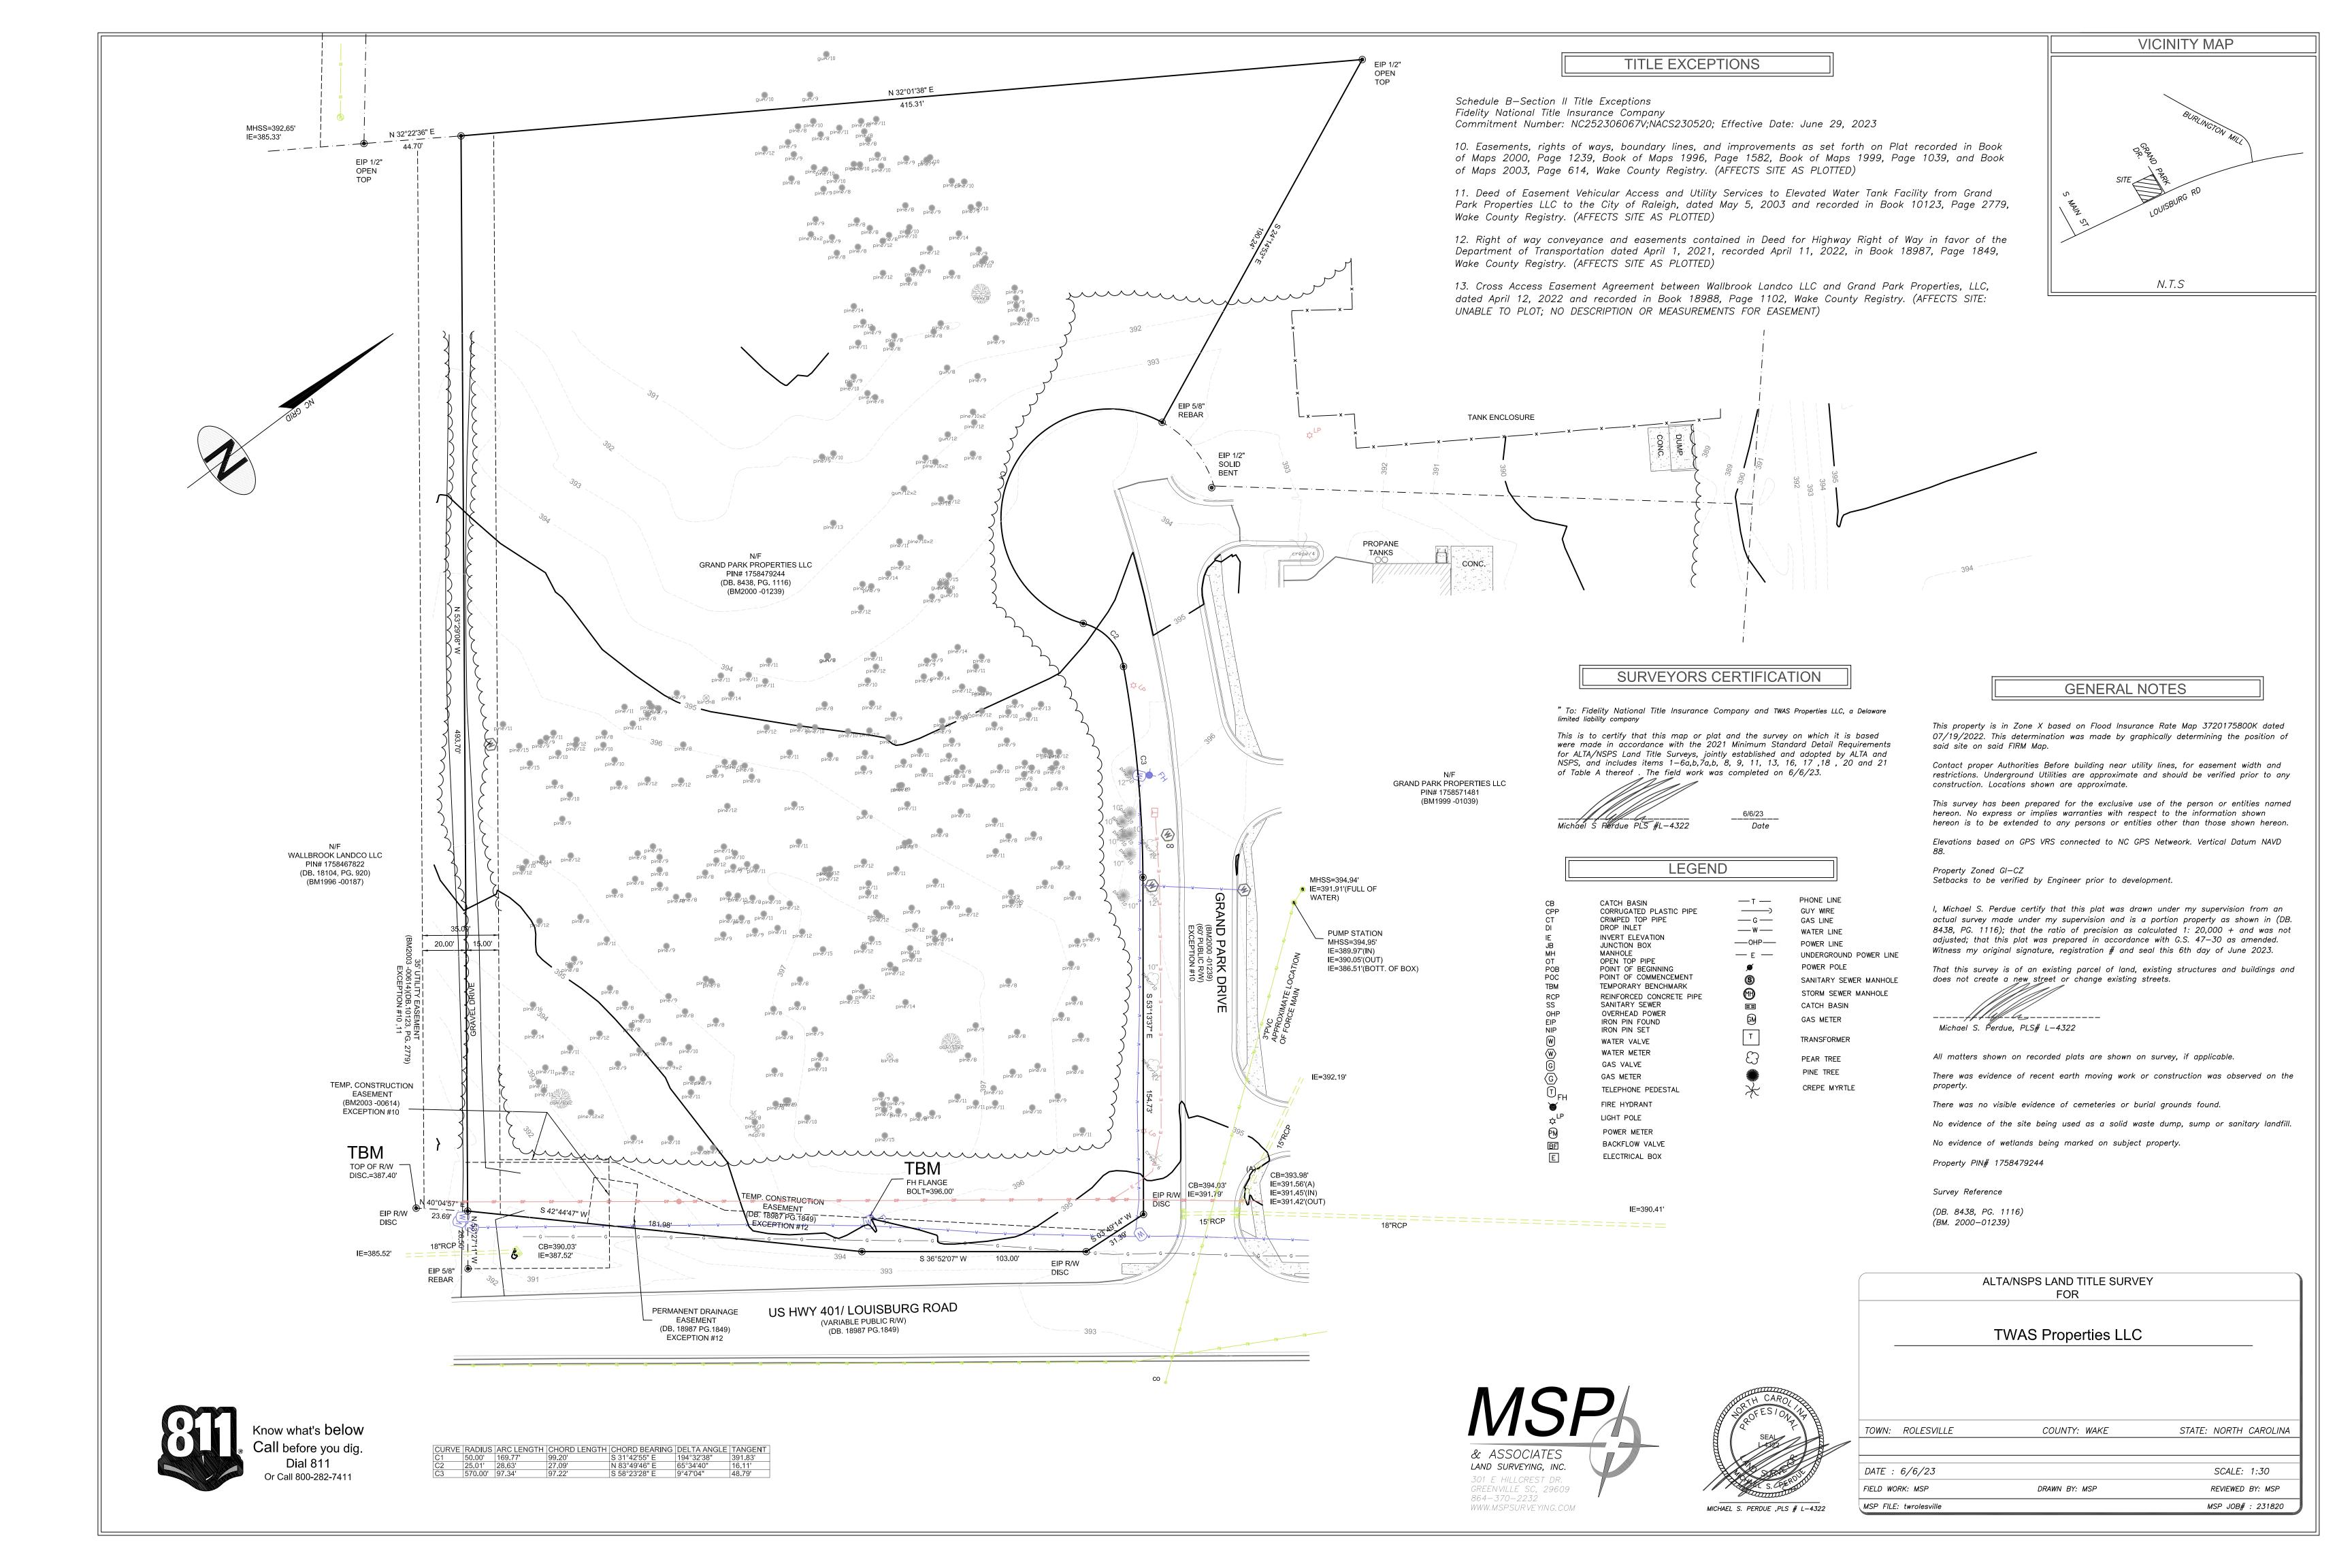

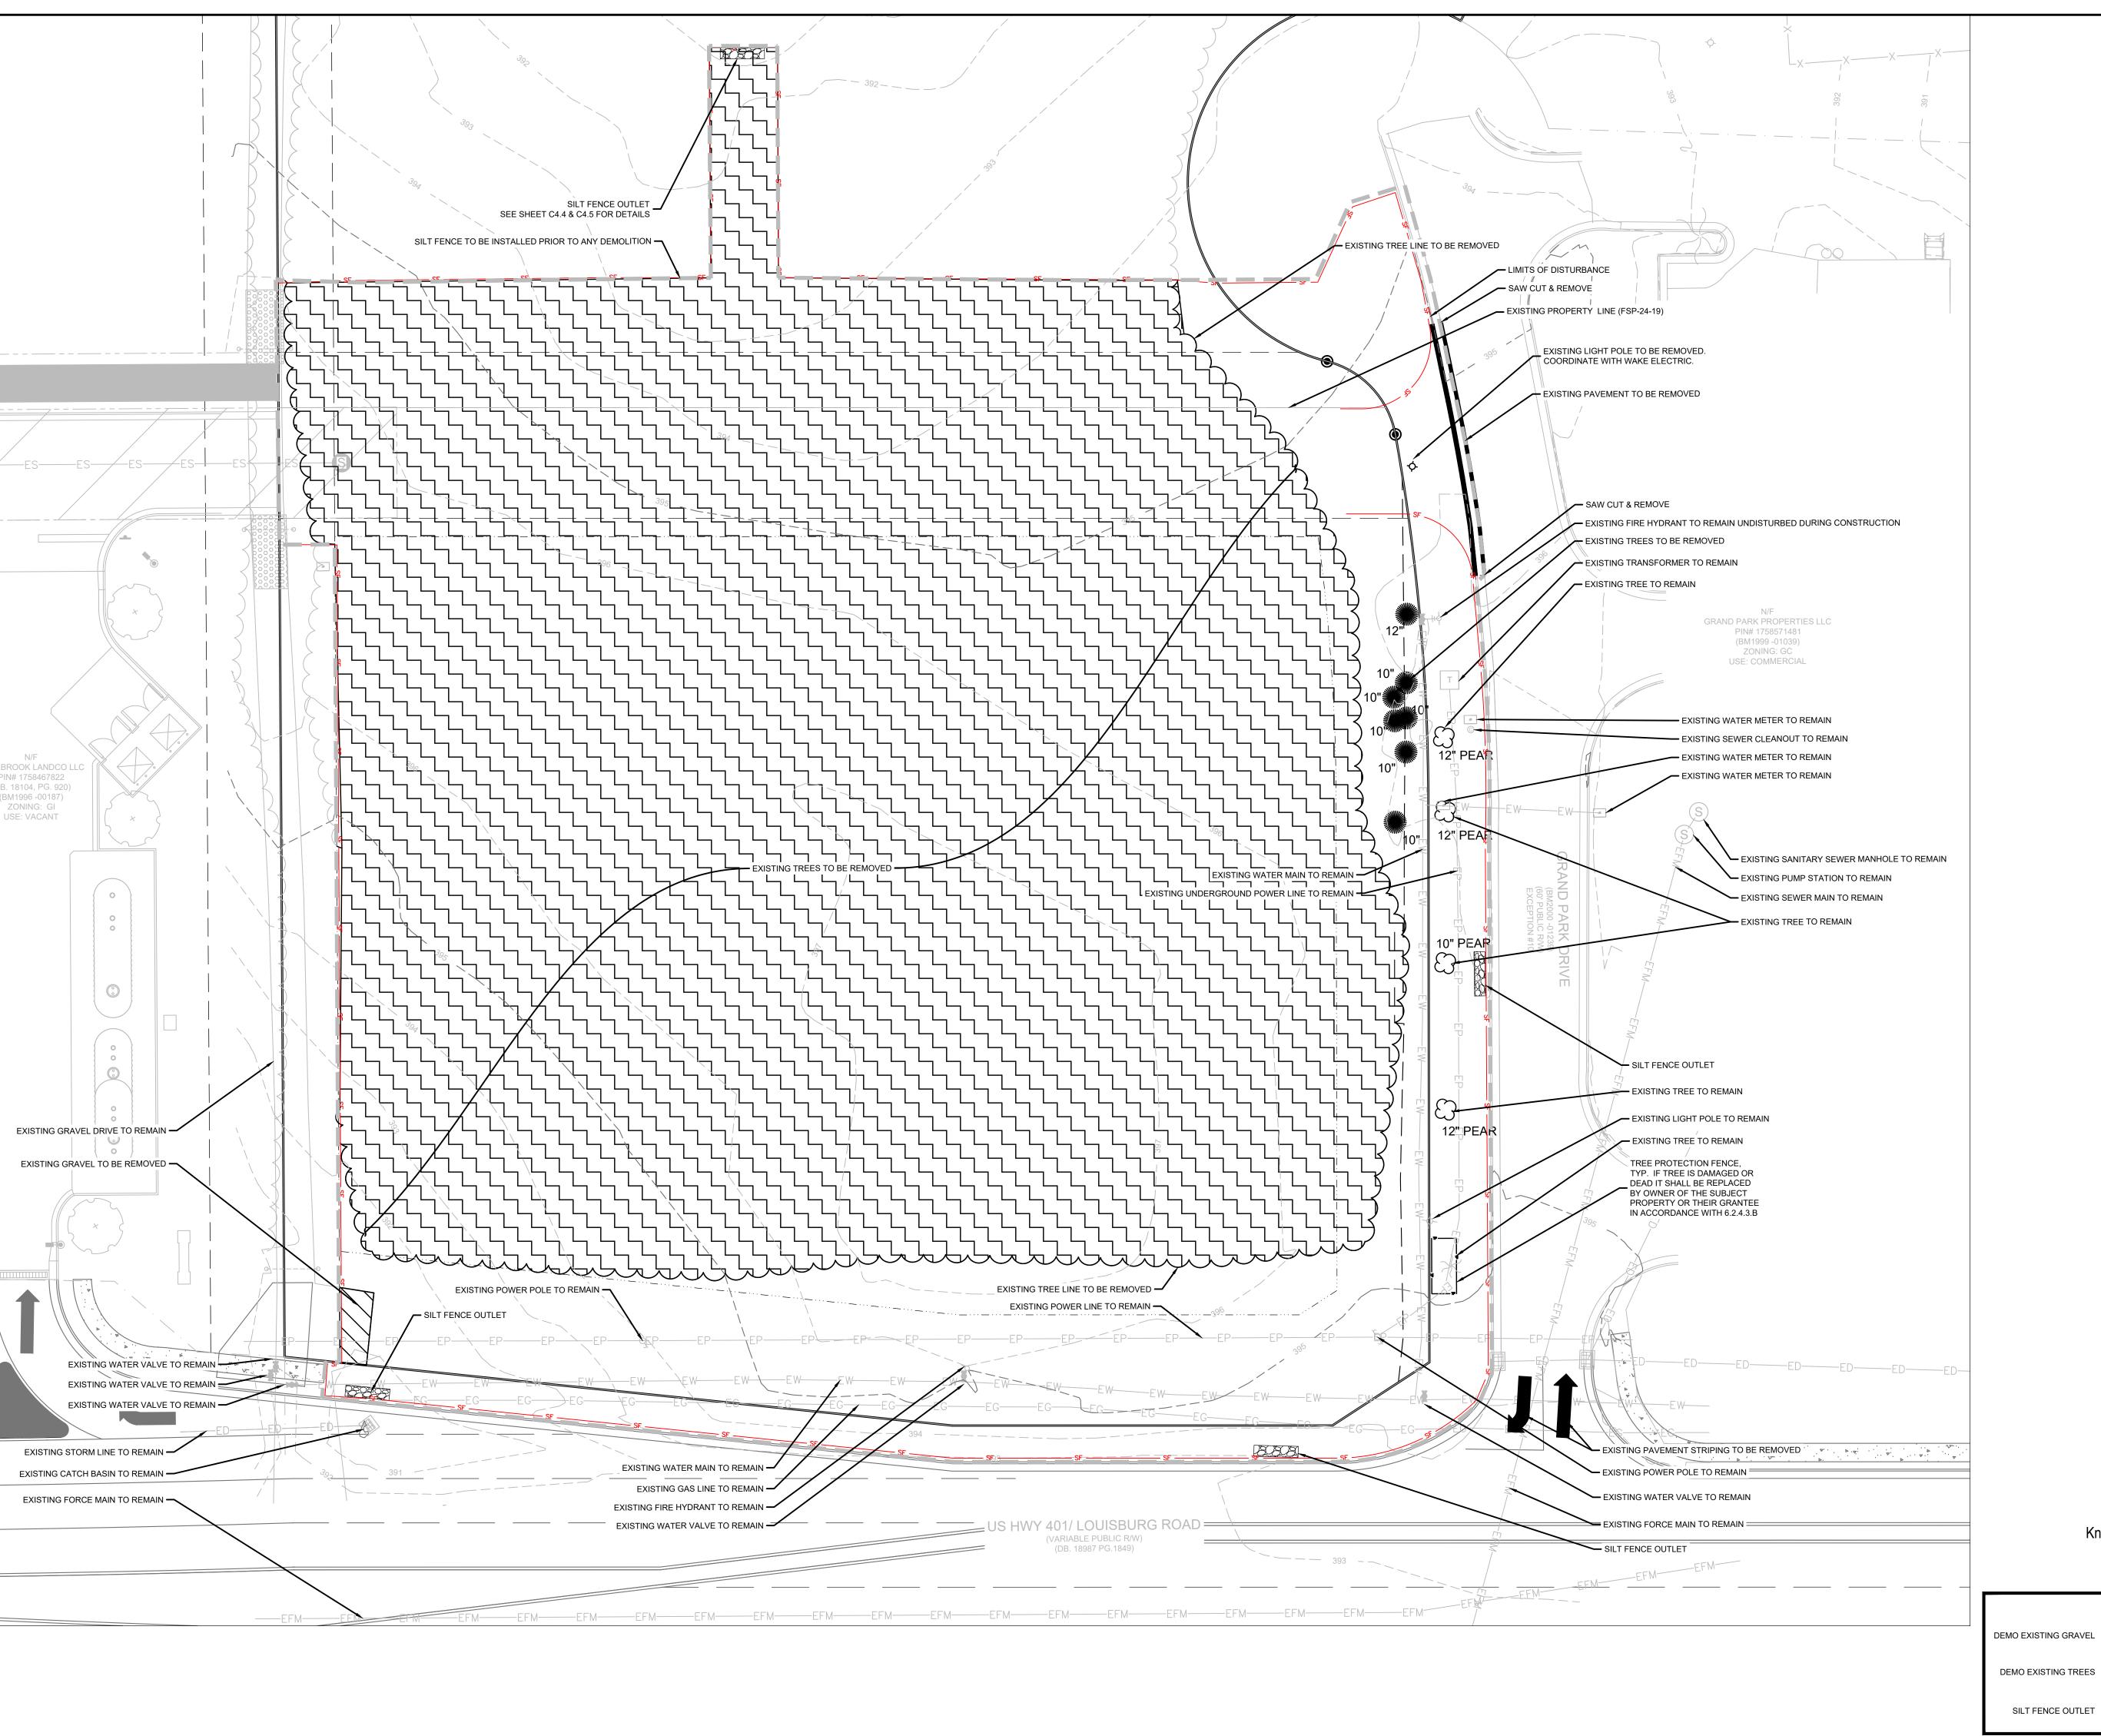

DEMOLITION NOTES:

- 1. ALL DEMOLITION DEBRIS IS TO BE REMOVED FROM THE PROJECT SITE AND DISPOSED OF IN ACCORDANCE WITH APPLICABLE COUNTY, STATE, AND FEDERAL REGULATIONS.
- 2. CONTRACTOR IS RESPONSIBLE FOR LOCATING ALL EXISTING UTILITIES BEFORE ANY WORK IS STARTED. ENGINEER SHALL BE NOTIFIED OF ANY DISCREPANCIES BETWEEN THE FIELD MARKINGS AND SURVEY.
- 3. NO LAND DISTURBING ACTIVITY PRIOR TO APPROVAL OF EROSION AND SEDIMENT CONTROL PLAN AND THE ISSUANCE OF THE LAND-DISTURBING PERMIT AT THE PRECONSTRUCTION MEETING.
- 4. CONTRACTOR TO REMOVE ALL TREES WITHIN LIMITS OF DISTURBANCE.

EXISTING UTILITY NOTE:

Call before you dig.

DEMOLITION LEGEND

SCALE: 1" = 20'

LIMITS OF DISTURBANCE — — —

EXISTING CURB TO BE


THE LOCATION OF EXISTING UNDERGROUND UTILITIES ARE SHOWN IN AN APPROXIMATE WAY ONLY AND HAVE NOT BEEN INDEPENDENTLY VERIFIED BY THE OWNER OR ITS REPRESENTATIVE. THE CONTRACTOR SHALL DETERMINE THE EXACT LOCATION OF ALL EXISTING UTILITIES BEFORE COMMENCING ANY WORK, AND AGREES TO BE FULLY RESPONSIBLE FOR ANY AND ALL DAMAGES WHICH MIGHT OCCUR DUE TO THE CONTRACTOR'S FAILURE TO EXACTLY LOCATE AND PRESERVE ANY AND ALL UNDERGROUND UTILITIES.



MOUNT PLEASANT, SC 843.884.1667 GREENVILLE, SC 864.298.0534 SUMMERVILLE, SC 843.972.0710 SPARTANBURG, SC 864.272.1272 CHARLOTTE, NC

980.312.5450

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SW+ PROJECT:

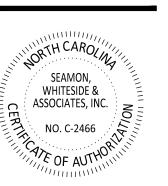		DR	AWN BY:		С
\mathcal{N}_{λ}		СН	ECKED BY	′ :	7
4,		RI	EVISION	Н	STOR
			10/30/23		
		Α	12/22/23	F	11/06/2
		В	03/01/24	G	12/20/2
0	40	С	09/04/24	Н	1/03/2
		D	10/01/24		
		F	11/01/24		

EXISTING CONDITIONS AND DEMO PLAN

C3.1

PHASE I SEQUENCING:

 DRAFT EROSION AND SEDIMENT CONTROL PLAN MUST BE APPROVED AND A LETTER OF APPROVAL (LOA) MUST BE ISSUED PRIOR TO OBTAINING THE CERTIFICATE OF COVERAGE FROM DEQ

2. RECEIVE NPDES COVERAGE FROM NCDEQ.

- 3. PRE-CONSTRUCTION CONFERENCE TO BE CONDUCTED WITH THE WAKE COUNTY FIELD CONSULTANT (JEEVAN NEUPANE 919-819-8907) TO DISCUSS EROSION CONTROL MEASURE. FAILURE TO SCHEDULE SUCH CONFERENCE PRIOR TO ANY LAND DISTURBING ACTIVITY IS SUBJECT TO FINE. LDP WILL BE ISSUED AT THE PRECONSTRUCTION MEETING (ON-SITE). SITE SHOULD BE FLAGGED PRIOR TO PRE-CONSTRUCTION
- 4. INSTALL SILT FENCE, INLET PROTECTION, BERMS AND OTHER MEASURES AS SHOWN ON PLANS, CLEARING ONLY AS NECESSARY TO INSTALL THESE DEVICES.
- 5. CALL FOR ON-SITE INSPECTION BY WAKE COUNTY FIELD CONSULTANT (JEEVAN NEUPANE 919-819-8907). WHEN APPROVED, INSPECTOR GIVES CONTRACTOR THE ABILITY TO CLEAR AND GRUB SITE.
- 6. THE CONTRACTOR SHALL DILIGENTLY AND CONTINUOUSLY MAINTAIN ALL EROSION CONTROL DEVICES AND STRUCTURES.
- 7. FOR PHASED EROSION CONTROL PLANS, CONTRACTOR SHALL MEET WITH EROSION CONTROL INSPECTOR PRIOR TO COMMENCING WITH EACH PHASE OF EROSION CONTROL MEASURES.
- 8. CONTRACTOR SHALL NOT ALLOW MORE THAN 0.25 ACRES OF DISTURBED AREA TO DRAIN TOWARDS 100LF OF SILT FENCE OR PERFORM GRADING IN A MANNER THAT ALLOWS SEDIMENT LADEN WATER TO FLOW LONGITUDINALLY ALONG SILT FENCE LINE. IF A LOW SPOT DEVELOPS ALONG GRADING NEAR SILT FENCE, CONTRACTOR SHALL COORDINATE WITH EROSION CONTROL INSPECTOR TO PLACE A SILT FENCE OUTLET IN OUTLET LOCATIONS.
- 9. CONTACT WAKE COUNTY FIELD CONSULTANT (JEEVAN NEUPANE 919-819-8907) UPON COMPLETION OF INSTALLATION OF PERIMETER EROSION AND SEDIMENT CONTROLS PRIOR TO PROCEEDING WITH ANY OTHER EARTH DISTURBANCE OR GRADING.
- 10. UPON APPROVAL FROM WAKE COUNTY FIELD CONSULTANT (JEEVAN NEUPANE 919-819-8907), COMPLETE DEMOLITION OF ANY SITE FEATURES (PAVEMENT, CURB, ETC.), CLEARING AND GRUBBING, AND STRIP SITE OF TOP SOIL. ALL DEMOLISHED MATERIAL IS TO BE DISPOSED IN ACCORDANCE WITH APPLICABLE NORTH CAROLINA REGULATIONS. CONTRACTOR TO ENSURE ALL APPLICABLE DEMOLITION PERMITS HAVE BEEN ISSUED AND HAVE ORIGINALS OF THE SAME PRIOR TO COMMENCING DEMOLITION ACTIVITIES.
- 11. CONTACT WAKE COUNTY FIELD CONSULTANT (JEEVAN NEUPANE 919-819-8907) UPON COMPLETION OF STRIPPING, THE STOCKPILING OF TOPSOIL, THE CONSTRUCTION OF TEMPORARY SEDIMENT AND EROSION CONTROL FACILITIES, DISPOSAL OF ALL WASTE MATERIAL, AND PREPARATION OF THE GROUND

INLET PROTECTION NOTE:

PROVIDE APPROPRIATE INLET PROTECTION FOR VARIOUS PHASES OF THE CONSTRUCTION . HARDWARE CLOTH AND GRAVEL PROTECTION SHALL BE PROVIDED FOR INLETS IN NON-PAVED AREA. WEEP FILTERS SHALL BE PROVIDED FOR INLETS IN PAVED AREAS.

STABILIZATION NOTE:

PROVIDE FINAL STABILIZATION FOR ALL DISTURBED AREAS. REFER TO THE LANDSCAPE PLAN FOR SPECIFIC MATERIALS / PLANTINGS. ANY DISTURBED AREA NOT ADDRESSED IN THE LANDSCAPE PLANS SHALL BE PERMANENT SEEDED.

EXISTING UTILITY NOTE:

THE LOCATION OF EXISTING UNDERGROUND UTILITIES ARE SHOWN IN AN APPROXIMATE WAY ONLY AND HAVE NOT BEEN INDEPENDENTLY VERIFIED BY THE OWNER OR ITS REPRESENTATIVE. THE CONTRACTOR SHALL DETERMINE THE EXACT LOCATION OF ALL EXISTING UTILITIES BEFORE COMMENCING ANY WORK, AND AGREES TO BE FULLY RESPONSIBLE FOR ANY AND ALL DAMAGES WHICH MIGHT OCCUR DUE TO THE CONTRACTOR'S FAILURE TO EXACTLY LOCATE AND PRESERVE ANY AND ALL UNDERGROUND UTILITIES.




Call before you dig.

Know what's below.

TOTAL SITE ACREAGE
1.92 ACRES

DISTURBED ACREAGE
2.30 ACRES

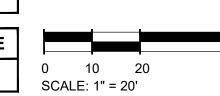

	E&SC PLAN	I LEGEND	
LIMITS OF DISTURBANCE		CONCRETE WASHOUT BASIN (SEE DETAIL)	CW
SILT FENCE, STANDARD	SF	SILT BAG INLET PROTECTION	
SILT FENCE OUTLET/RIP RAP APRON/RIP RAP BASIN & ROCK SEDIMENT TRAP		HARDWARE CLOTH AND	
CONSTRUCTION ENTRANCE		GRAVEL INLET PROTECTION	
PERMANENT SOD	PS	TEMPORARY SEEDING	TS



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864.272.1272 CHARLOTTE, NC 980.312.5450 www.seamonwhiteside.com

SEAMON,
WHITESIDE &
ASSOCIATES, INC.
NO. C-2466



L WAVE AUTO SPA

SW+ PROJECT: 10772
DATE: 1/28/24
DRAWN BY: CPE
CHECKED BY: TLL

REVISION HISTORY

10/30/23

A 12/22/23 F 11/06/24

B 03/01/24 G 12/20/24

C 09/04/24 H 1/03/25

D 10/01/24

E 11/01/24

EROSION CONTROL PH I

MINOLITI

PHASE II SEQUENCING:

- 1. CONTACT THE WAKE COUNTY FIELD CONSULTANT (JEEVAN NEUPANE 919-819-8907) FOR APPROVAL TO
- 2. TEMPORARILY STABILIZE GRADED AREAS (NON-STEEP SLOPES) AS REQUIRED.
- 3. COMPLETE ROUGH GRADING. COMPLETE THE INSTALLATION OF STORMWATER SYSTEM AND SITE
- 4. CONTACT THE WAKE COUNTY FIELD CONSULTANT (JEEVAN NEUPANE 919-819-8907) UPON COMPLETION OF ROUGH GRADING, BUT PRIOR TO PLACING TOPSOIL, PERMANENT DRAINAGE, OR OTHER SITE DEVELOPMENT IMPROVEMENTS AND GROUND COVERS.
- 5. INSTALL CURB ALONG THE PERIMETER OF THE SITE TO AID IN THE PROTECTION OF THE EXISTING ADJACENT PROPERTIES AND THE ADJACENT ROADWAYS.

INLET PROTECTION NOTE:

PROVIDE APPROPRIATE INLET PROTECTION FOR VARIOUS PHASES OF THE CONSTRUCTION . HARDWARE CLOTH AND GRAVEL INLET PROTECTION SHALL BE PROVIDED FOR INLETS IN NON-PAVED AREA. DANDY SACK INLET PROTECTION SHALL BE PROVIDED FOR INLETS IN PAVED AREAS.

STABILIZATION NOTE:

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MOUNT PLEASANT, SC 843.884.1667 GREENVILLE, SC 864.298.0534

SUMMERVILLE, SC





DISTURBED ACREAGE **2.30 ACRES**


E&SC PLAN LEGEND

LIMITS OF DISTURBANCE

SILT FENCE, STANDARD

SEDIMENT TRAP

PERMANENT SOD

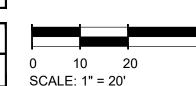

_				
	0 SCA	10 ALE: 1" =	20 20'	

CONCRETE WASHOUT BASIN (SEE DETAIL)	cw
SILT BAG INLET PROTECTION	
HARDWARE CLOTH AND GRAVEL INLET PROTECTION	

TEMPORARY SEEDING

TS

EROSION CONTROL PH

REVISION HISTORY

A 12/22/23 F 11/06/24

B 03/01/24 G 12/20/24

C 09/04/24 H 1/03/25

SW+ PROJECT:

DRAWN BY:

CHECKED BY:


D 10/01/24

E 11/01/24

1/28/24 CPE

DATE:

C4.2

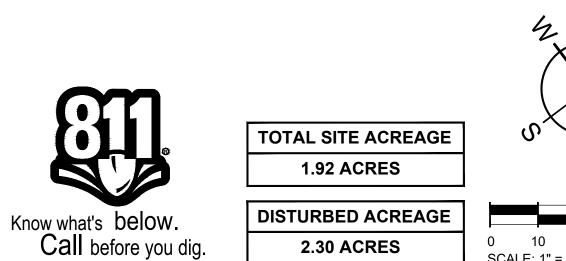

PHASE III SEQUENCING:

- 1. CONTACT WAKE COUNTY FIELD CONSULTANT (JEEVAN NEUPANE 919-819-8907) FOR APPROVAL TO PROCEED
- 2. BEGIN FINE GRADING AND INITIATE FINAL PAVING
- 3. ONCE BUILDING CONSTRUCTION FOR SITE IS COMPLETE, CONTACT THE WAKE COUNTY FIELD CONSULTANT (JEEVAN NEUPANE 919-819-8907) FOR APPROVAL TO REMOVE APPLICABLE EROSION CONTROL MEASURES.

4. PERMANENTLY STABILIZE ANY REMAINING AREAS IN ACCORDANCE WITH THE PERMANENT SEEDING SCHEDULE AND NOTES. INSTALL FINAL SITE LANDSCAPING

5. REQUEST FINAL APPROVAL FROM THE WAKE COUNTY FIELD CONSULTANT (JEEVAN NEUPANE 919-819-8907) PRIOR TO REMOVING ANY REMAINING SEDIMENT CONTROL MEASURES AND UPON COMPLETION OF FINAL GRADING, PERMANENT DRAINAGE, AND EROSION CONTROL FACILITIES, INCLUDING ESTABLISHED GROUND COVERS AND PLANTINGS, AND ALL OTHER WORK OF THE BUILDING PERMITS.

STABILIZATION NOTE:

PROVIDE FINAL STABILIZATION FOR ALL DISTURBED AREAS. REFER TO THE LANDSCAPE PLAN FOR SPECIFIC MATERIALS / PLANTINGS. ANY DISTURBED AREA NOT ADDRESSED IN THE LANDSCAPE PLANS SHALL BE PERMANENT SEEDED.

EXISTING UTILITY NOTE:

THE LOCATION OF EXISTING UNDERGROUND UTILITIES ARE SHOWN IN AN APPROXIMATE WAY ONLY AND HAVE NOT BEEN INDEPENDENTLY VERIFIED BY THE OWNER OR ITS REPRESENTATIVE. THE CONTRACTOR SHALL DETERMINE THE EXACT LOCATION OF ALL EXISTING UTILITIES BEFORE COMMENCING ANY WORK, AND AGREES TO BE FULLY RESPONSIBLE FOR ANY AND ALL DAMAGES WHICH MIGHT OCCUR DUE TO THE CONTRACTOR'S FAILURE TO EXACTLY LOCATE AND PRESERVE ANY AND ALL UNDERGROUND UTILITIES.



MOUNT PLEASANT, SC 843.884.1667 GREENVILLE, SC 864.298.0534 SUMMERVILLE, SC 843.972.0710 SPARTANBURG, SC 864.272.1272 CHARLOTTE, NC

980.312.5450 WWW.SEAMONWHITESIDE.COM

> WHITESIDE & ASSOCIATES, INC. NO. C-2466



SW+ PROJECT: 1/28/24 DRAWN BY: CPE CHECKED BY:

DATE: **REVISION HISTORY**

0 10 20 SCALE: 1" = 20'

SILT BAG INLET

HARDWARE CLOTH AND GRAVEL INLET PROTECTION

TEMPORARY SEEDING

TOTAL SITE ACREAGE

1.92 ACRES

DISTURBED ACREAGE

2.30 ACRES

E&SC PLAN LEGEND

Know what's below.

LIMITS OF DISTURBANCE

SILT FENCE OUTLET/RIP RAP

CONSTRUCTION ENTRANCE

SILT FENCE, STANDARD


SEDIMENT TRAP

PERMANENT SOD

Call before you dig.

A 12/22/23 F 11/06/24 B 03/01/24 G 12/20/24 C 09/04/24 H 1/03/25 D 10/01/24 CW CONCRETE WASHOUT BASIN E 11/01/24 (SEE DETAIL) **EROSION** PROTECTION CONTROL PH

TS

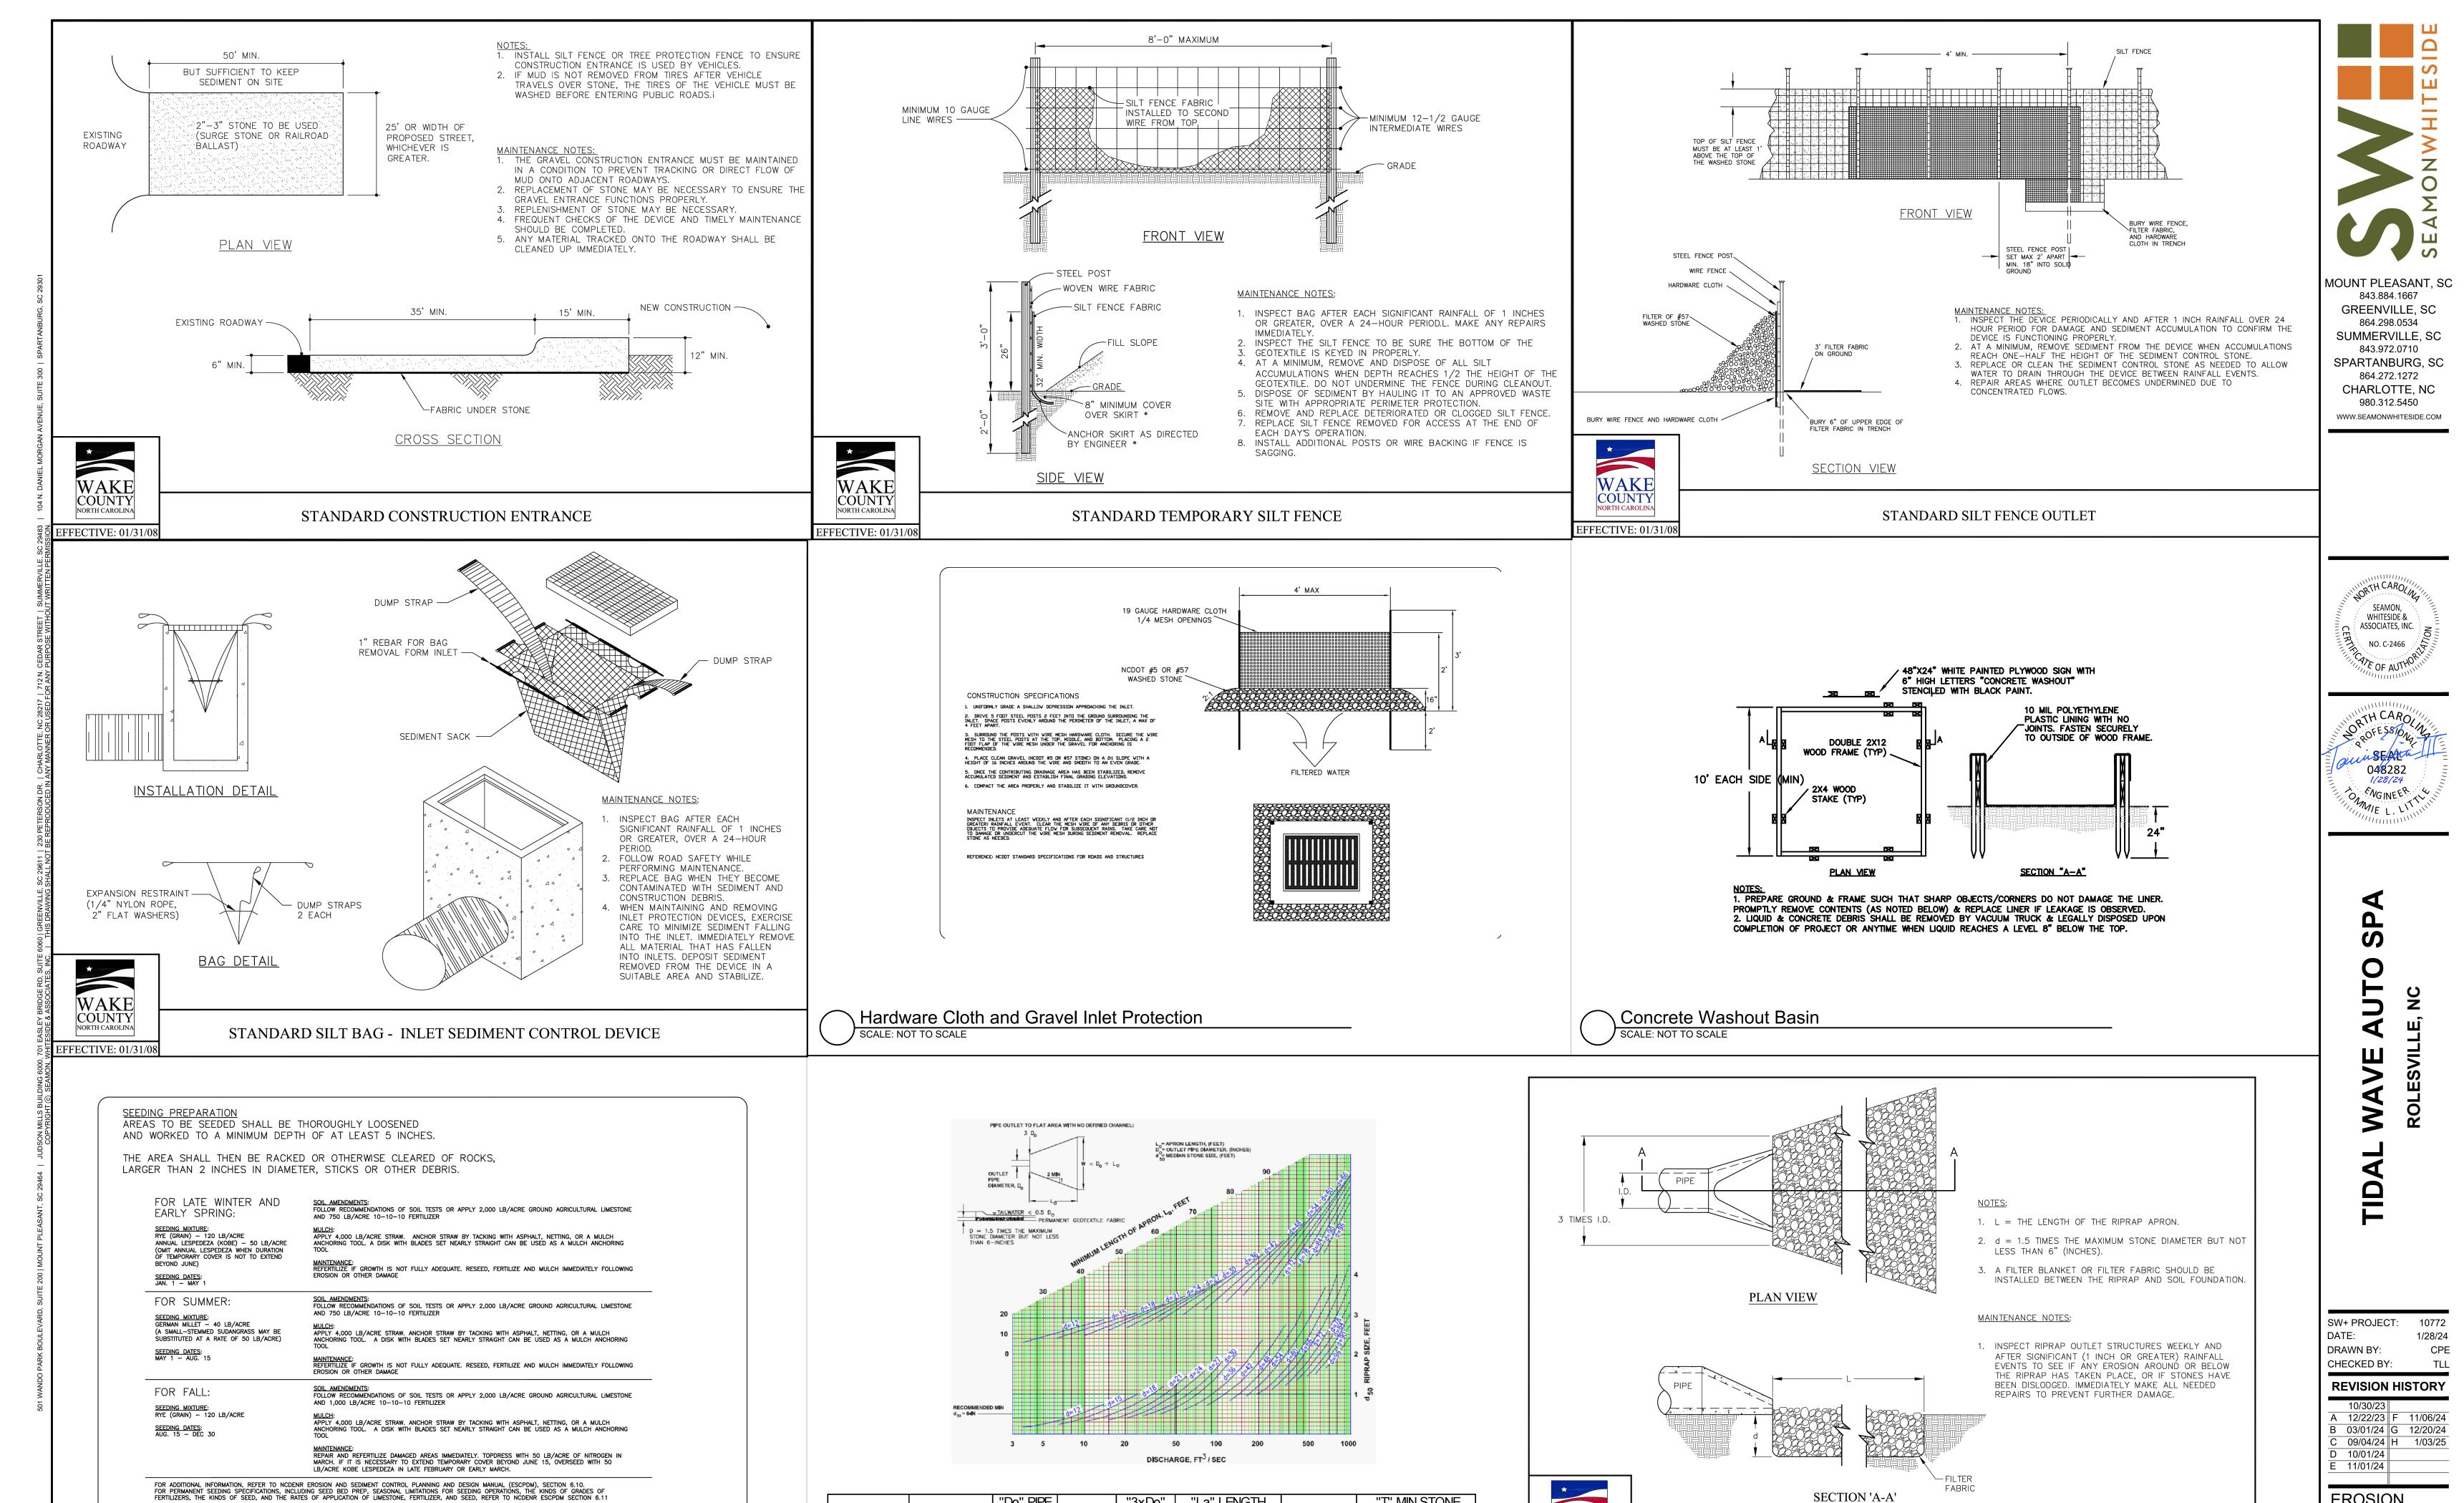

"3xDo"

(FT)

7.50

7.50

'Do" PIPE

DIA (IN)

30

30

\ Pipe Outlet Riprap Protection with Calculations

0.50

0.50

Q(CFS)

3.50

3.50

RIPRAP#

STORM-7

PLEASE CONSULT THE NATURAL RESOURCES CONSERVATION SERVICE FOR ADDITIONAL ALTERNATIVES FOR VEGETATING DENUDED AREAS. ②

Temporary Seeding Schedule
SCALE: NOT TO SCALE

"La" LENGTH

(MIN 10 FT) (FT

10.00

12.50

12.50

"T" MIN STONE

WAKE

COUNTY

NORTH CAROLIN

EFFECTIVE: 01/31/08

DEPTH (IN)

13.50

13.50

C4.4

EROSION

CONTROL

DETAILS

SECTION 'A-A'

STANDARD PIPE OUTLET TO FLAT AREA

NO WELL-DEFINED CHANNEI

SELF-INSPECTION, RECORDKEEPING AND REPORTING SECTION A: SELF-INSPECTION Self-inspections are required during normal business hours in accordance with the table below. When adverse weather or site conditions would cause the safety of the inspection personnel to be in jeopardy, the inspection may be delayed until the next business day on which it is safe to perform the inspection. In addition, when a storm event of equal to or greater than 1.0 inch occurs outside of normal business hours, the self-inspection shall be performed upon the commencement of the next business day. Any time when inspections were delayed shall be noted in the Inspection Record. (during normal Inspection records must include: business hours) (1) Rain gauge maintained in Daily rainfall amounts. If no daily rain gauge observations are made during weekend of good working order holiday periods, and no individual-day rainfall information is available, record the cumulative rain measurement for those un-attended days (and this will determine if a site inspection is needed). Days on which no rainfall occurred shall be recorded as The permittee may use another rain-monitoring device pproved by the Division. 7 calendar days Date and time of the inspection, Name of the person performing the inspection . Indication of whether the measures were operating event ≥ 1.0 inch in properly, escription of maintenance needs for the measure, Description, evidence, and date of corrective actions taken. Identification of the discharge outfalls inspected, . Date and time of the inspection, 3. Name of the person performing the inspection, outfalls (SDCs) and within 24 Evidence of indicators of stormwater pollution such as oil sheen, floating or suspended solids or discoloration, event ≥ 1.0 inch in . Indication of visible sediment leaving the site. Description, evidence, and date of corrective actions taken. (4) Perimeter of At least once per If visible sedimentation is found outside site limits, then a record 1. Actions taken to clean up or stabilize the sediment that has left and within 24 the site limits. Description, evidence, and date of corrective actions taken, and 3. An explanation as to the actions taken to control future If the stream or wetland has increased visible sedimentation or a At least once per wetlands onsite 7 calendar days stream has visible increased turbidity from the construction activity, then a record of the following shall be made: and within 24 hours of a rain Description, evidence and date of corrective actions taken, and . Records of the required reports to the appropriate Division Regional Office per Part III, Section C, Item (2)(a) of this permit. 24 hours After each phase (6) Ground The phase of grading (installation of perimeter E&SC measures, clearing and grubbing, installation of storm of grading stabilization measures drainage facilities, completion of all land-disturbing ground cover). Documentation that the required ground stabilization measures have been provided within the required timeframe or an assurance that they will be provided as NOTE: The rain inspection resets the required 7 calendar day inspection requirement.

SELF-INSPECTION, RECORDKEEPING AND REPORTING

SECTION B: RECORDKEEPING 1. E&SC Plan Documentation

The approved E&SC plan as well as any approved deviation shall be kept on the site. The approved E&SC plan must be kept up-to-date throughout the coverage under this permit

The following items pertaining to the E&SC plan shall be kept on site and available for inspection at all times during normal business hours. Item to Document Documentation Requirements (a) Each E&SC measure has been installed Initial and date each E&SC measure on a copy

and does not significantly deviate from the of the approved E&SC plan or complete, date locations, dimensions and relative elevations | and sign an inspection report that lists each shown on the approved E&SC plan. E&SC measure shown on the approved E&SC plan. This documentation is required upon the initial installation of the E&SC measures or if the E&SC measures are modified after initial (b) A phase of grading has been completed. Initial and date a copy of the approved E&SC plan or complete, date and sign an inspection onstruction phase. Initial and date a copy of the approved E&SC (c) Ground cover is located and installed in accordance with the approved E&SC plan or complete, date and sign an inspection report to indicate compliance with approved

(d) The maintenance and repair Complete, date and sign an inspection report. requirements for all E&SC measures have been performed. (e) Corrective actions have been taken plan or complete, date and sign an inspection to E&SC measures. report to indicate the completion of the

2. Additional Documentation to be Kept on Site In addition to the E&SC plan documents above, the following items shall be kept on the site and available for inspectors at all times during normal business hours, unless the Division provides a site-specific exemption based on unique site conditions that make

a) This General Permit as well as the Certificate of Coverage, after it is received. b) Records of inspections made during the previous twelve months. The permittee shall record the required observations on the Inspection Record Form provided by the Division or a similar inspection form that includes all the required elements. Use of electronically-available records in lieu of the required paper copies will be allowed if shown to provide equal access and utility as the hard-copy records. 3. Documentation to be Retained for Three Years

All data used to complete the e-NOI and all inspection records shall be maintained for a period of three years after project completion and made available upon request. [40 CFR 122.41]

PART II. SECTION G. ITEM (4) DRAW DOWN OF SEDIMENT BASINS FOR MAINTENANCE OR CLOSE OUT

this requirement not practical:

Sediment basins and traps that receive runoff from drainage areas of one acre or more shall use outlet structures that withdraw water from the surface when these devices need to be drawn down for maintenance or close out unless this is infeasible. The circumstances in which it is not feasible to withdraw water from the surface shall be rare (for example, times with extended cold weather). Non-surface withdrawals from sediment basins shall be allowed only when all of the following criteria have been met:

(a) The E&SC plan authority has been provided with documentation of the non-surface withdrawal and the specific time periods or conditions in which it will occur. The non-surface withdrawal shall not commence until the E&SC plan authority has approved these items.

(b) The non-surface withdrawal has been reported as an anticipated bypass in accordance with Part III, Section C, Item (2)(c) and (d) of this permit, (c) Dewatering discharges are treated with controls to minimize discharges of pollutants from stormwater that is removed from the sediment basin. Examples of appropriate controls include

properly sited, designed and maintained dewatering tanks, weir tanks, and filtration systems, (d) Vegetated, upland areas of the sites or a properly designed stone pad is used to the extent feasible at the outlet of the dewatering treatment devices described in Item (c) above, (e) Velocity dissipation devices such as check dams, sediment traps, and riprap are provided at the discharge points of all dewatering devices, and (f) Sediment removed from the dewatering treatment devices described in Item (c) above is disposed of in a manner that does not cause deposition of sediment into waters of the United States SELF-INSPECTION, RECORDKEEPING AND REPORTING

SECTION C: REPORTING 1. Occurrences that Must be Reported

Permittees shall report the following occurrences: (a) Visible sediment deposition in a stream or wetland.

(b) Oil spills if:

1(b)-(c) above

(c) Anticipated

22.41(m)(3)]

(d) Unanticipated

bypasses [40 CFR

(e) Noncompliance

with the conditions

of this permit that

may endanger

health or the

CFR 122.41(I)(7)]

122.41(m)(3)]

 They are 25 gallons or more, They are less than 25 gallons but cannot be cleaned up within 24 hours,

 They cause sheen on surface waters (regardless of volume), or • They are within 100 feet of surface waters (regardless of volume).

Releases of hazardous substances in excess of reportable quantities under Section 311 of the Clean Water Act (Ref: 40 CFR 110.3 and 40 CFR 117.3) or Section 102 of CERCLA (Ref: 40 CFR 302.4) or G.S. 143-215.85.

(d) Anticipated bypasses and unanticipated bypasses.

(e) Noncompliance with the conditions of this permit that may endanger health or the

2. Reporting Timeframes and Other Requirements After a permittee becomes aware of an occurrence that must be reported, he shall contact the appropriate Division regional office within the timeframes and in accordance with the

other requirements listed below. Occurrences outside normal business hours may also be

reported to the Department's Environmental Emergency Center personnel at (800) Reporting Timeframes (After Discovery) and Other Requirements (a) Visible sediment • Within 24 hours, an oral or electronic notification deposition in a Within 7 calendar days, a report that contains a description of the stream or wetland sediment and actions taken to address the cause of the deposition. Division staff may waive the requirement for a written report on a case-by-case basis. If the stream is named on the NC 303(d) list as impaired for sedimentrelated causes, the permittee may be required to perform additional monitoring, inspections or apply more stringent practices if staff determine that additional requirements are needed to assure compliance with the federal or state impaired-waters conditions. (b) Oil spills and Within 24 hours, an oral or electronic notification. The notification shall include information about the date, time, nature, volume and release of location of the spill or release. substances per Item

> A report at least ten days before the date of the bypass, if possible The report shall include an evaluation of the anticipated quality and effect of the bypass. Within 24 hours, an oral or electronic notification Within 7 calendar days, a report that includes an evaluation of the

quality and effect of the bypass. Within 24 hours, an oral or electronic notification. Within 7 calendar days, a report that contains a description of the noncompliance, and its causes; the period of noncompliance, including exact dates and times, and if the noncompliance has not been corrected, the anticipated time noncompliance is expected to continue; and steps taken or planned to reduce, eliminate, and prevent reoccurrence of the noncompliance. [40 CFR 122.41(I)(6). Division staff may waive the requirement for a written report on a

case-by-case basis.

NORTH CAROLINA

Environmental Quality

NCG01 SELF-INSPECTION, RECORDKEEPING AND REPORTING EFFECTIVE: 04/01/19

GROUND STABILIZATION AND MATERIALS HANDLING PRACTICES FOR COMPLIANCE WITH

may not apply depending on site conditions and the delegated authority having jurisdictior

plementing the details and specifications on this plan sheet will result in the construction activity being considered compliant with the Ground Stabilization and Materials Handling sections of the NCG01 Construction General Permit (Sections E and F. respectively). The permittee shall comply with the Erosion and Sediment Control plan approved by the delegated authority having jurisdiction. All details and specifications shown on this sheet

SECTION E: GROUND STABILIZATION **Required Ground Stabilization Timeframes** Stabilize within this | many calendar Site Area Description Timeframe variations days after ceasing land disturbance Perimeter dikes swales, ditches, and perimeter slopes) High Quality Water (HQW) Zones f slopes are 10' or less in length and are Slopes steeper than not steeper than 2:1, 14 days are 7 days for slopes greater than 50' in length and with slopes steeper than 4:1 7 days for perimeter dikes, swales,) Slopes 3:1 to 4:1 ditches, perimeter slopes and HQW -10 days for Falls Lake Watershed days for perimeter dikes, swales, ditches, perimeter slopes and HQW Zone Areas with slope -10 days for Falls Lake Watershed unless flatter than 4:1 there is zero slope

Note: After the permanent cessation of construction activities, any areas with temporary ground stabilization shall be converted to permanent ground stabilization as soon as practicable but in no case longer than 90 calendar days after the last land disturbing ctivity. Temporary ground stabilization shall be maintained in a manner to render the surface stable against accelerated erosion until permanent ground stabilization is achieved.

GROUND STABILIZATION SPECIFICATION tabilize the ground sufficiently so that rain will not dislodge the soil. Use one of the hniques in the table below: Temporary Stabilization

Temporary grass seed covered with straw or Permanent grass seed covered with straw or other mulches and tackifiers other mulches and tackifiers • Geotextile fabrics such as permanent soil reinforcement matting Rolled erosion control products with or without temporary grass seed Hvdroseeding

Appropriately applied straw or other mulch

Plastic sheeting

 Uniform and evenly distributed ground cover sufficient to restrain erosion Structural methods such as concrete, asphalt or retaining walls

Rolled erosion control products with grass seed

Shrubs or other permanent plantings covered

POLYACRYLAMIDES (PAMS) AND FLOCCULANTS Select flocculants that are appropriate for the soils being exposed during

construction, selecting from the NC DWR List of Approved PAMS/Flocculants. Apply flocculants at or before the inlets to Erosion and Sediment Control Measures Apply flocculants at the concentrations specified in the NC DWR List of Approved PAMS/Flocculants and in accordance with the manufacturer's instructions.

with mulch

Store flocculants in leak-proof containers that are kept under storm-resistant cover or surrounded by secondary containment structures.

Provide ponding area for containment of treated Stormwater before discharging

EQUIPMENT AND VEHICLE MAINTENANCE

Maintain vehicles and equipment to prevent discharge of fluids. Provide drip pans under any stored equipment.

Identify leaks and repair as soon as feasible, or remove leaking equipment from the

Collect all spent fluids, store in separate containers and properly dispose as hazardous waste (recycle when possible) Remove leaking vehicles and construction equipment from service until the problem has been corrected.

Bring used fuels, lubricants, coolants, hydraulic fluids and other petroleum products to a recycling or disposal center that handles these materials.

LITTER, BUILDING MATERIAL AND LAND CLEARING WASTE

Never bury or burn waste. Place litter and debris in approved waste containers. Provide a sufficient number and size of waste containers (e.g dumpster, trash receptacle) on site to contain construction and domestic wastes.

Locate waste containers at least 50 feet away from storm drain inlets and surface waters unless no other alternatives are reasonably available. Locate waste containers on areas that do not receive substantial amounts of runoff from upland areas and does not drain directly to a storm drain, stream or wetland.

Cover waste containers at the end of each workday and before storm events or provide secondary containment. Repair or replace damaged waste containers. Anchor all lightweight items in waste containers during times of high winds. Empty waste containers as needed to prevent overflow. Clean up immediately if

containers overflow. Dispose waste off-site at an approved disposal facility.

9. On business days, clean up and dispose of waste in designated waste containers.

PAINT AND OTHER LIQUID WASTE

Do not dump paint and other liquid waste into storm drains, streams or wetlands. Locate paint washouts at least 50 feet away from storm drain inlets and surface waters unless no other alternatives are reasonably available. Contain liquid wastes in a controlled area.

Containment must be labeled, sized and placed appropriately for the needs of site. Prevent the discharge of soaps, solvents, detergents and other liquid wastes from

Install portable toilets on level ground, at least 50 feet away from storm drains, streams or wetlands unless there is no alternative reasonably available. If 50 foot offset is not attainable, provide relocation of portable toilet behind silt fence or place on a gravel pad and surround with sand bags. Provide staking or anchoring of portable toilets during periods of high winds or in high

foot traffic areas. Monitor portable toilets for leaking and properly dispose of any leaked material. Utilize a licensed sanitary waste hauler to remove leaking portable toilets and replace with properly operating unit.

EARTHEN STOCKPILE MANAGEMENT

Show stockpile locations on plans. Locate earthen-material stockpile areas at least 50 feet away from storm drain inlets, sediment basins, perimeter sediment controls and surface waters unless it can be shown no other alternatives are reasonably Protect stockpile with silt fence installed along toe of slope with a minimum offset of

five feet from the toe of stockpile. Provide stable stone access point when feasible. Stabilize stockpile within the timeframes provided on this sheet and in accordance with the approved plan and any additional requirements. Soil stabilization is defined as vegetative, physical or chemical coverage techniques that will restrain accelerated

erosion on disturbed soils for temporary or permanent control needs.

NCG01 GROUND STABILIZATION AND MATERIALS HANDLING

NORTH CAROLINA **3** Environmental Quality 2. THE CONCRETE VASHOUT STRUCTURES SHALL BE NADITADIED WHEN THE LIQUID AND/OR SOLID REACHES 75% OF THE STRUCTURES 3.CONCRETE VASHOUT STRUCTURE NEEDS TO BE CLEARY MARKED VITH SIGNAGE NOTING DEVICE. 3.CONCRETE VASHOUT STRUCTURE NEEDS TO BE CLEARY MARKED VIT SIGNAGE NOTING DEVICE.

CONCRETE WASHOUTS

BELOW GRADE WASHOUT STRUCTURE

Do not discharge concrete or cement slurry from the site. Dispose of, or recycle settled, hardened concrete residue in accordance with local and state solid waste regulations and at an approved facility. Manage washout from mortar mixers in accordance with the above item and in addition place the mixer and associated materials on impervious barrier and within lot perimeter silt fence.

Install temporary concrete washouts per local requirements, where applicable. If a alternate method or product is to be used, contact your approval authority for review and approval. If local standard details are not available, use one of the two types of temporary concrete washouts provided on this detail.

Do not use concrete washouts for dewatering or storing defective curb or sidewalk sections. Stormwater accumulated within the washout may not be pumped into or discharged to the storm drain system or receiving surface waters. Liquid waste must be pumped out and removed from project. Locate washouts at least 50 feet from storm drain inlets and surface waters unless it

can be shown that no other alternatives are reasonably available. At a minimum, install protection of storm drain inlet(s) closest to the washout which could receive spills or overflow.

Locate washouts in an easily accessible area, on level ground and install a stone entrance pad in front of the washout. Additional controls may be required by the approving authority.

Install at least one sign directing concrete trucks to the washout within the project limits. Post signage on the washout itself to identify this location. Remove leavings from the washout when at approximately 75% capacity to limit overflow events. Replace the tarp, sand bags or other temporary structural components when no longer functional. When utilizing alternative or proprietary

products, follow manufacturer's instructions. 10. At the completion of the concrete work, remove remaining leavings and dispose of in an approved disposal facility. Fill pit, if applicable, and stabilize any disturbance caused by removal of washout.

HERBICIDES, PESTICIDES AND RODENTICIDES

Store and apply herbicides, pesticides and rodenticides in accordance with label Store herbicides, pesticides and rodenticides in their original containers with the

label, which lists directions for use, ingredients and first aid steps in case of accidental poisoning. Do not store herbicides, pesticides and rodenticides in areas where flooding is possible or where they may spill or leak into wells, stormwater drains, ground water

or surface water. If a spill occurs, clean area immediately 4. Do not stockpile these materials onsite.

HAZARDOUS AND TOXIC WASTE

Create designated hazardous waste collection areas on-site.

Place hazardous waste containers under cover or in secondary containment. 3. Do not store hazardous chemicals, drums or bagged materials directly on the ground.

EFFECTIVE: 04/01/19

MOUNT PLEASANT, SC

843.884.1667

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SUMMERVILLE, SC

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CARO

WHITESIDE &

ASSOCIATES, INC.

NO. C-2466

1/28/24 CPE

A 12/22/23 F 11/06/24 B 03/01/24 G 12/20/24 C 09/04/24 H 1/03/25 D 10/01/24 E 11/01/24

EROSION CONTROL **DETAILS**

C4.5

DRAWN BY: CHECKED BY: **REVISION HISTORY**

ADDRESS: 601 GRAND PARK DRIVE, ROLESVILLE, NC PROPERTY AREA: 1.92 ACRES PARCEL: 1758-57-0146 EXISTING USE: UNDEVELOPED

PROPERTY ZONING: GENERAL COMMERCIAL CONDITIONAL ZONING

(GC-CZ) PER REZ-24-03 **BUILDING SETBACKS:** FRONT (SE):

PRE VS. POST DEVELOPMENT AREA:

1.92 AC

0.04 AC (2.08%) 1.30 AC (67.7%)

PARKING REQUIRED:

1 SPACE PER 400 SF GFA OR 5 SPACES MINIMUM = 5 SPACES

EMPLOYEE SPACES:

5 SPACES (4 MAX ON SHIFT)

26 STALLS (1 ADA) ADA PARKING: 2 SPACES


33 SPACES

REQUIRED: 1 SPACE (1 SPACE PER 5000 SF GFA)

PROVIDED: 4 SPACES

SITE LAYOUT AND STAKING NOTES:

- 1. CONTRACTOR SHALL CAREFULLY EXAMINE ALL DOCUMENTS AND THE CONSTRUCTION SITE TO OBTAIN FIRST HAND KNOWLEDGE OF **EXISTING CONDITIONS.**
- 2. ENTIRE SITE SHALL BE DRESSED TO UNIFORM, WELL DRAINED AND VISUALLY APPEALING SURFACE WITH A MINIMUM TOPSOIL LAYER OF FOUR INCHES.
- . ALL STRIPING AND SIGNS SHALL CONFORM WITH THE NORTH CAROLINA DEPARTMENT OF TRANSPORTATION AND THE MANUAL ON UNIFORM TRAFFIC CONTROL DEVICES LATEST EDITION.
- 4. ALL HANDICAP PARKING SPACED AND ACCESSIBLE ROUTE SHALL
- CONFORM WITH THE AMERICAN WITH DISABILITY ACT DESIGN GUIDELINES AND SPECIFICATIONS LATEST EDITION.
- 5. DIMENSIONS AND CURVE RADII ARE GIVEN TO FACE OF CURB, WHERE CURB AND GUTTER IS SHOWN. OTHERWISE DIMENSIONS ARE GIVEN TO THE EDGE OF PAVEMENT. CONTRACTOR IS TO COORDINATE WITH THE ARCHITECTURAL PLANS AS TO THE
- BUILDING LAYOUT AND DIMENSIONS. 6. THIS DEVELOPMENT IS NOT REQUIRED TO PERFORM A TRAFFIC IMPACT ANALYSIS PER DETERMINATION BY LAND DEVELOPMENT ADMINISTRATOR ON 02/14/2024 PER LDO SECTION 8.C.5.
- INTERNAL PEDESTRIAN ACCESS AND FLOW IN ACCORDANCE WITH LDO 6.8.4.B.3 IS NOT APPLICABLE DUE TO NO PUBLIC BUILDING ACCESS ON SITE AND NECESSITY FOR PATRONS TO BE IN A VEHICLE TO PURCHASE THE SERVICES OF THE ESTABLISHMENT.

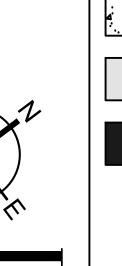

SW+ PROJECT: DATE: 1/28/24 SITE LEGEND DRAWN BY: CPE CHECKED BY: PROPOSED SIDEWALK **REVISION HISTORY HEAVY DUTY** CONCRETE PAVEMENT

STANDARD DUTY

CONCRETE PAVEMENT

ASPHALT GREENWAY

DO NOT ENTER SIGN

HANDICAP PARKING

STOP SIGN

SIGN

A 12/22/23 F 11/06/24 B 03/01/24 G 12/20/24 C 09/04/24 H 1/03/25 D 10/01/24 E 11/01/24

MOUNT PLEASANT, SC

843.884.1667 GREENVILLE, SC

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SPARTANBURG, SC

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CHARLOTTE, NC

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WHITESIDE & ASSOCIATES, INC. NO. C-2466


TH CARO

048282

ON ENGINEER

SITE PLAN

C5.1

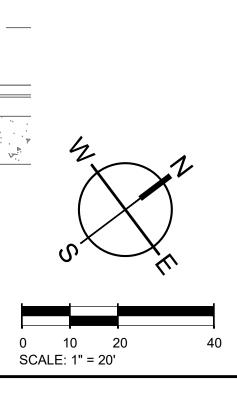

Know what's below.

Call before you dig.

SITE INFORMATION:

ADDRESS: 601 GRAND PARK DRIVE, ROLESVILLE, NC PROPERTY AREA: 1.92 ACRES PARCEL: 1758-57-0146 EXISTING USE: UNDEVELOPED

TOWN CORPORATE ZONING LIMITS PER ANX-24-02:

PROPERTY ZONING: GENERAL COMMERCIAL CONDITIONAL ZONING

(GC-CZ) PER REZ-24-03 **BUILDING SETBACKS:**

FRONT (SE): CORNER (NE): REAR (NW): SIDE (SW):

PERIMETER LANDSCAPE YARDS: NORTHEAST:

REQUIRED OPEN SPACE (5%) = 0.01 AC (4182 SF)

PRE VS. POST DEVELOPMENT AREA:

SITE AREA: 1.92 AC

PRE-IMPERVIOUS AREA: 0.04 AC (2.08%)

POST-IMPERVIOUS AREA: 1.30 AC (67.7%)

PARKING NOTE:

PARKING REQUIRED:

1 SPACE PER 400 SF GFA OR 5 SPACES MINIMUM = 5 SPACES

5 SPACES

2 SPACES

PARKING PROVIDED: EMPLOYEE SPACES:

> VACUUM STALLS: 26 STALLS (1 ADA)

TOTAL PARKING: 33 SPACES


BIKE PARKING:

REQUIRED: 1 SPACE (1 SPACE PER 5000 SF GFA)

PROVIDED: 4 SPACES

SITE LAYOUT AND STAKING NOTES:

- 1. CONTRACTOR SHALL CAREFULLY EXAMINE ALL DOCUMENTS AND THE CONSTRUCTION SITE TO OBTAIN FIRST HAND KNOWLEDGE OF EXISTING CONDITIONS.
- 2. ENTIRE SITE SHALL BE DRESSED TO UNIFORM, WELL DRAINED AND VISUALLY APPEALING SURFACE WITH A MINIMUM TOPSOIL LAYER OF FOUR INCHES.
- 3. ALL STRIPING AND SIGNS SHALL CONFORM WITH THE NORTH CAROLINA DEPARTMENT OF TRANSPORTATION AND THE MANUAL ON UNIFORM TRAFFIC CONTROL DEVICES LATEST EDITION. PARKING STALL STRIPING TO BE WHITE WITH BLUE HANDICAPPED
- 4. ALL HANDICAP PARKING SPACED AND ACCESSIBLE ROUTE SHALL CONFORM WITH THE AMERICAN WITH DISABILITY ACT DESIGN GUIDELINES AND SPECIFICATIONS LATEST EDITION.
- 5. DIMENSIONS AND CURVE RADII ARE GIVEN TO FACE OF CURB, WHERE CURB AND GUTTER IS SHOWN. OTHERWISE DIMENSIONS ARE GIVEN TO THE EDGE OF PAVEMENT. CONTRACTOR IS TO COORDINATE WITH THE ARCHITECTURAL PLANS AS TO THE
- BUILDING LAYOUT AND DIMENSIONS. 6. THIS DEVELOPMENT IS NOT REQUIRED TO PERFORM A TRAFFIC IMPACT ANALYSIS PER DETERMINATION BY LAND DEVELOPMENT
- ADMINISTRATOR ON 02/14/2024 PER LDO SECTION 8.C.5. INTERNAL PEDESTRIAN ACCESS AND FLOW IN ACCORDANCE WITH LDO 6.8.4.B.3 IS NOT APPLICABLE DUE TO NO PUBLIC BUILDING ACCESS ON SITE AND NECESSITY FOR PATRONS TO BE IN A VEHICLE TO PURCHASE THE SERVICES OF THE ESTABLISHMENT.

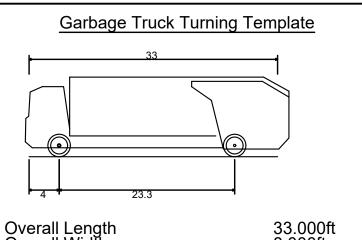

Overall Length
Overall Width
Overall Body Height
Min Body Ground Clearance
Track Width
Lock-to-lock time
Curb to Curb Turning Radius

Know what's below.

Call before you dig.

33.000ft 8.000ft 10.568ft 1.022ft 8.500ft 1.00s 48.500ft

SW+ PROJECT: DATE: 1/28/24 DRAWN BY: CPE CHECKED BY:

MOUNT PLEASANT, SC

843.884.1667 GREENVILLE, SC

864.298.0534 SUMMERVILLE, SC

843.972.0710 SPARTANBURG, SC

864.272.1272

CHARLOTTE, NC

980.312.5450

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WHITESIDE & ASSOCIATES, INC. NO. C-2466


048282

OMNIE L. LIT

REVISION HISTORY A 12/22/23 F 11/06/24 B 03/01/24 G 12/20/24 C 09/04/24 H 1/03/25 D 10/01/24

E 11/01/24

VEHICLE STACKING & TURNING **MOVEMENT**

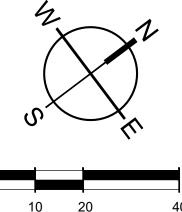

SCALE: 1" = 20'

SITE INFORMATION:

ADDRESS: 601 GRAND PARK DRIVE, ROLESVILLE, NC PROPERTY AREA: 1.92 ACRES PARCEL: 1758-57-0146 EXISTING USE: UNDEVELOPED

TOWN CORPORATE ZONING LIMITS PER ANX-24-02:

PROPERTY ZONING: GENERAL COMMERCIAL CONDITIONAL ZONING

(GC-CZ) PER REZ-24-03 **BUILDING SETBACKS:**

CORNER (NE): REAR (NW): SIDE (SW):

PERIMETER LANDSCAPE YARDS: NORTHEAST:

REQUIRED OPEN SPACE (5%) = 0.01 AC (4182 SF)

PRE VS. POST DEVELOPMENT AREA:

1.92 AC

PRE-IMPERVIOUS AREA: 0.04 AC (2.08%)

POST-IMPERVIOUS AREA: 1.30 AC (67.7%)

PARKING NOTE:

PARKING REQUIRED:

1 SPACE PER 400 SF GFA OR 5 SPACES MINIMUM = 5 SPACES

EMPLOYEE SPACES: 5 SPACES (4 MAX ON SHIFT)

VACUUM STALLS: 26 STALLS (1 ADA)

ADA PARKING: 2 SPACES


REQUIRED: 1 SPACE (1 SPACE PER 5000 SF GFA)

PROVIDED: 4 SPACES

1. CONTRACTOR SHALL CAREFULLY EXAMINE ALL DOCUMENTS AND THE CONSTRUCTION SITE TO OBTAIN FIRST HAND KNOWLEDGE OF EXISTING CONDITIONS.

33 SPACES

- 2. ENTIRE SITE SHALL BE DRESSED TO UNIFORM, WELL DRAINED AND VISUALLY APPEALING SURFACE WITH A MINIMUM TOPSOIL LAYER OF FOUR INCHES.
- 3. ALL STRIPING AND SIGNS SHALL CONFORM WITH THE NORTH CAROLINA DEPARTMENT OF TRANSPORTATION AND THE MANUAL ON UNIFORM TRAFFIC CONTROL DEVICES LATEST EDITION. PARKING STALL STRIPING TO BE WHITE WITH BLUE HANDICAPPED
- 4. ALL HANDICAP PARKING SPACED AND ACCESSIBLE ROUTE SHALL CONFORM WITH THE AMERICAN WITH DISABILITY ACT DESIGN GUIDELINES AND SPECIFICATIONS LATEST EDITION.
- 5. DIMENSIONS AND CURVE RADII ARE GIVEN TO FACE OF CURB, WHERE CURB AND GUTTER IS SHOWN. OTHERWISE DIMENSIONS ARE GIVEN TO THE EDGE OF PAVEMENT. CONTRACTOR IS TO COORDINATE WITH THE ARCHITECTURAL PLANS AS TO THE
- BUILDING LAYOUT AND DIMENSIONS. 6. THIS DEVELOPMENT IS NOT REQUIRED TO PERFORM A TRAFFIC IMPACT ANALYSIS PER DETERMINATION BY LAND DEVELOPMENT
- ADMINISTRATOR ON 02/14/2024 PER LDO SECTION 8.C.5. INTERNAL PEDESTRIAN ACCESS AND FLOW IN ACCORDANCE WITH LDO 6.8.4.B.3 IS NOT APPLICABLE DUE TO NO PUBLIC BUILDING ACCESS ON SITE AND NECESSITY FOR PATRONS TO BE IN A VEHICLE TO PURCHASE THE SERVICES OF THE ESTABLISHMENT.

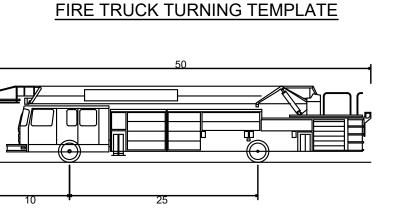

Copy of Rolesville Fire Truck 1
Overall Length
Overall Width
Overall Body Height
Min Body Ground Clearance
Track Width Lock-to-lock time Max Wheel Angle

Know what's below.


Call before you dig.

50.000ft 8.333ft 10.101ft 0.920ft 8.333ft 0.10s 45.00°

SW+ PROJECT: DATE: 1/28/24 DRAWN BY: CPE CHECKED BY: **REVISION HISTORY**

A 12/22/23 F 11/06/24 B 03/01/24 G 12/20/24 C 09/04/24 H 1/03/25 D 10/01/24 E 11/01/24

FIRE PROTECTION PLAN

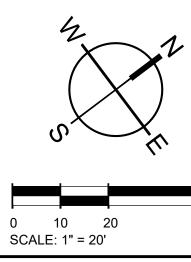

WHITESIDE & ASSOCIATES, INC. NO. C-2466

048282

OMNIE L. LIT

STANDARD DRAINAGE PLAN NOTES:


- FOR PROJECT SURVEY INFORMATION INCLUDING VERTICAL DATUM AND BENCHMARK LOCATIONS, SEE "PROJECT SURVEY INFORMATION AND CONTRACTOR VERIFICATION REQUIREMENTS" ON
- PRIOR TO STARTING CONSTRUCTION, THE CONTRACTOR IS RESPONSIBLE FOR VERIFYING EXISTING CONDITIONS, INCLUDING BUT NOT LIMITED TO TOPOGRAPHIC, TREE, STORM DRAINAGE FACILITIES, AND ALL UTILITIES. EXISTING UTILITIES SHOWN ARE APPROXIMATE AND HAVE NOT BEEN INDEPENDENTLY VERIFIED BY THE OWNER OR ENGINEER. THEREFORE, THE CONTRACTOR IS RESPONSIBLE FOR VERIFYING THE EXACT VERTICAL AND HORIZONTAL LOCATIONS OF ALL EXISTING UTILITIES. ANY DISCREPANCIES OR CONFLICTS IDENTIFIED DURING VERIFICATION OF EXISTING CONDITIONS AND UTILITIES SHALL BE REPORTED TO THE OWNER AND ENGINEER. ANY COSTS ASSOCIATED WITH CORRECTIVE WORK OR DAMAGES THAT ARE A RESULT OF THE CONTRACTOR NOT VERIFYING EXISTING CONDITIONS AND THE EXACT VERTICAL AND HORIZONTAL LOCATION OF ALL EXISTING UTILITIES WILL BE THE CONTRACTOR'S RESPONSIBILITY.
 - REFER TO DRAINAGE PROFILE SHEETS, ROADWAY PLAN & PROFILE SHEETS, GRADING PLAN SHEETS, AND ROADWAY & DRAINAGE DETAIL SHEETS FOR ADDITIONAL DRAINAGE AND GRADING INFORMATION AND REQUIREMENTS.
- DRAINAGE PIPE LENGTHS PROVIDED REPRESENT DISTANCES FROM CENTER OF BOX TO CENTER OF BOX. DRAINAGE PIPES ARE TO TERMINATE INSIDE THE DRAINAGE STRUCTURES IN ACCORDANCE WITH GOVERNING AUTHORITY REQUIREMENTS OR IN ACCORDANCE WITH SCDOT STANDARD DRAWING 719-000-03 DRAINAGE STRUCTURE GENERAL NOTES.
- ANY NECESSARY UNDERCUTTING OR MUCK AND FILL OPERATIONS ARE TO BE COORDINATED WITH THE OWNER AND THE PROJECT GEOTECHNICAL CONSULTANT PRIOR TO EXECUTING THE
- PRIOR TO BEGINNING WORK WITHIN ANY PUBLIC RIGHT-OF-WAY OR EASEMENT, THE CONTRACTOR SHALL OBTAIN ANY APPLICABLE ENCROACHMENT PERMITS FROM THE OWNER OR ENGINEER AND IS RESPONSIBLE FOR FOLLOWING ALL REQUIREMENTS SPECIFIED IN THESE PERMITS.
- UNLESS OTHERWISE NOTED, REINFORCED CONCRETE PIPE (RCP) SHALL BE IN ACCORDANCE WITH ASTM C76, CLASS III, WALL B WITH SEALANT JOINTS (ASTM C990) PER NCDOT SPECIFICATIONS. ALL
- REFER TO DRAINAGE PROFILE SHEETS FOR ADDITIONAL RIM ELEVATION INFORMATION.
- GRCP: GASKETED (O-RING) REINFORCED CONCRETE PIPE. ASTMC76, CLASS III, WALL B WITH GASKETED JOINTS (ASTM C443).

MOUNT PLEASANT, SC 843.884.1667 GREENVILLE, SC 864.298.0534 SUMMERVILLE, SC 843.972.0710 SPARTANBURG, SC 864.272.1272 CHARLOTTE, NC 980.312.5450

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Call before you dig. SCALE: 1" = 20'

SPOT ELEV KEY (FINISHED GRADING)

- A-(ASPHALT) SURFACE OF FINISHED ASPHALT ROADWAY OR WALKING PATH
- C-(CONCRETE) CONCRETE PAVING
- D-(DIRT) FINISHED GROUND ELEVATION
- F-(FLOW) ELEVATION AT WHICH SURFACE WATER FLOWS INTO DRAINAGE STRUCTURE
- -SURFACE OF ASPHALT ADJACENT TO THROAT OR GRATE AT CURB INLET -SURFACE OF ACCESS COVER FOR JUNCTION OR ISOLATION BOX
- -SURFACE OF GRATE AT OUTSIDE EDGE FOR CATCH BASIN, GUTTER INLET, OR GRATED POND STRUCTURE
- FFE FINISHED FLOOR ELEVATION
- G-(GUTTER) SURFACE OF FINISHED GUTTER AT LOWEST POINT (ALONG WATER FLOW PATH) W-(WALK) SURFACE OF FINISHED CONCRETE OR INTERLOCKING PAVER SIDEWALK, PATIO, PLAZA, OR SLAB
- TC TOP OF CURB ELEVATION
- TS TOP OF STAIRS ELEVATION
- BS BOTTOM OF STAIRS ELEVATION TW - FINISHED GRADE ELEVATION AT TOP OF WALL BW - FINISHED GRADE ELEVATION AT BOTTOM OF WALL
- ME-(MATCH EXISTING) FOLLOWING ELEVATION NUMBER -INDICATES TO MATCH ELEVATION OF EXISTING SURFACE AT POINT OF CONNECTION

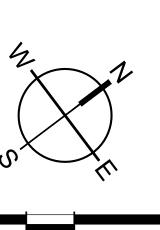EXAMPLE: A12.56ME MEANS THAT THE SURFACE OF NEW ASPHALT IS TO BE AT ELEVATION 12.56 WHICH SHOULD MATCH THE ELEVATION OF THE EXISTING ASPHALT SURFACE AT THE JOINT

C6.1

SW+ PROJECT: 10772

REVISION HISTORY

A 12/22/23 F 11/06/24

B 03/01/24 G 12/20/24

C 09/04/24 H 1/03/25

OVERALL GRADING AND

DRAINAGE

PLAN

1/28/24

CPE

DATE:

DRAWN BY:

CHECKED BY:

D 10/01/24

E 11/01/24



DRAINAGE STRUCTURE LEGEND & DEFINITION OF RIM ELEVATIONS

N.T.S. - SEE DETAIL SHEET FOR STRUCTURE DETAILS

TYPE 1 CURB INLET

CI-1

RIM (BOC)

CATCH BASINS OR JUNCTION BOXES


YI CS IB E O D O
YI OCS IB CB JB SMH TYPE-9


PAVEMENT -

TYPE 16, 17, 18 CURB INLET

* RIM = ELEVATION AT CENTER OF TOP
** TOP OF SLAB TO MATCH ADJACENT GROUND SLOPE

CI-16 CI-17L CI-17R

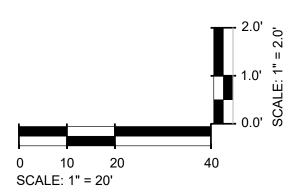

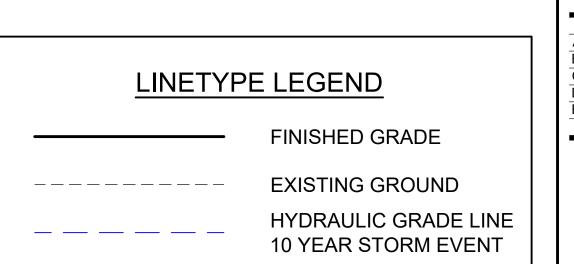


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864.272.1272

CHARLOTTE, NC 980.312.5450



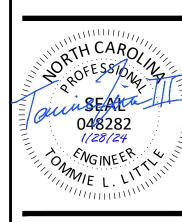

1/28/24 DRAWN BY: CHECKED BY: **REVISION HISTORY**

10/30/23 | A 12/22/23 | F 11/06/24 | B 03/01/24 | G 12/20/24 | C 09/04/24 | H 1/03/25 | D 10/01/24 | E 11/01/24 |

DRAINAGE PROFILES

C6.2

EXISTING 6" WATER MAIN

SCALE: 1" = 10'

SCALE: 1" = 1'

Authorization to Construct

Raleigh Standards will result in a Fine and Possible Exclusion from

future work in the City of Raleigh.

- 1. ALL MATERIALS & CONSTRUCTION METHODS SHALL BE IN ACCORDANCE WITH CITY OF RALEIGH DESIGN STANDARDS, DETAILS &
- SPECIFICATIONS (REFERENCE: CORPUD HANDBOOK, CURRENT EDITION)
- 2. UTILITY SEPARATION REQUIREMENTS:
- 2.a. A DISTANCE OF 100' SHALL BE MAINTAINED BETWEEN SANITARY SEWER & ANY PRIVATE OR PUBLIC WATER SUPPLY SOURCE SUCH AS AN IMPOUNDED RESERVOIR USED AS A SOURCE OF DRINKING WATER. IF ADEQUATE LATERAL SEPARATION CANNOT BE ACHIEVED, FERROUS SANITARY SEWER PIPE SHALL BE SPECIFIED & INSTALLED TO WATERLINE SPECIFICATIONS. HOWEVER, THE MINIMUM SEPARATION SHALL NOT BE LESS THAN 25' FROM A PRIVATE WELL OR 50' FROM A PUBLIC WELL.
- 10'. IF THIS SEPARATION CANNOT BE MAINTAINED DUE TO EXISTING CONDITIONS, THE VARIATION ALLOWED IS THE WATER MAIN IN A SEPARATE TRENCH WITH THE ELEVATION OF THE WATER MAIN AT LEAST 18" ABOVE THE TOP OF THE SEWER & MUST BE APPROVED BY THE PUBLIC UTILITIES DIRECTOR. ALL DISTANCES ARE MEASURED
- FROM OUTSIDE DIAMETER TO OUTSIDE DIAMETER. 2.c. WHERE IT IS IMPOSSIBLE TO OBTAIN PROPER SEPARATION, OR ANYTIME A SANITARY SEWER PASSES OVER A WATERMAIN, DIP MATERIALS OR STEEL ENCASEMENT EXTENDED 10' ON EACH SIDE OF CROSSING MUST BE
- SPECIFIED & INSTALLED TO WATERLINE SPECIFICATIONS 2.d. 5.0' MINIMUM HORIZONTAL SEPARATION IS REQUIRED BETWEEN ALL SANITARY SEWER & STORM SEWER
- 2.e. MAINTAIN 18" MIN. VERTICAL SEPARATION AT ALL WATERMAIN & RCP STORM DRAIN CROSSINGS; MAINTAIN 18" MIN. VERTICAL SEPARATION AT ALL SANITARY SEWER & RCP STORM DRAIN CROSSINGS. WHERE ADEQUATE SEPARATIONS CANNOT BE ACHIEVED, SPECIFY DIP MATERIALS & A CONCRETE CRADLE HAVING 6" MIN.
- CLEARANCE (PER CORPUD DETAILS W41 & S-49). 2.f. ALL OTHER UNDERGROUND UTILITIES SHALL CROSS WATER & SEWER FACILITIES WITH 18" MIN. VERTICAL
- 3. ANY NECESSARY FIELD REVISIONS ARE SUBJECT TO REVIEW & APPROVAL OF AN AMENDED PLAN &/OR PROFILE BY THE CITY OF RALEIGH PUBLIC UTILITIES DEPARTMENT PRIOR TO CONSTRUCTION.
- 4. DEVELOPER SHALL PROVIDE 30 DAYS ADVANCE WRITTEN NOTICE TO OWNER FOR ANY WORK REQUIRED WITHIN AN EXISTING CITY OF RALEIGH UTILITY EASEMENT TRAVERSING PRIVATE PROPERTY.
- 5. CONTRACTOR SHALL MAINTAIN CONTINUOUS WATER & SEWER SERVICE TO EXISTING RESIDENCES & BUSINESSES THROUGHOUT CONSTRUCTION OF PROJECT. ANY NECESSARY SERVICE INTERRUPTIONS SHALL BE PRECEDED BY A 24-HOUR ADVANCE NOTICE TO THE
- 6. 3.0' MINIMUM COVER IS REQUIRED ON ALL WATER MAINS & SEWER FORCE MAINS. 4.0' MINIMUM COVER IS REQUIRED ON ALL
- 7. IT IS THE DEVELOPER'S RESPONSIBILITY TO ABANDON OR REMOVE EXISTING WATER & SEWER SERVICES NOT BEING USED IN REDEVELOPMENT OF A SITE UNLESS OTHERWISE DIRECTED BY THE CITY OF RALEIGH PUBLIC UTILITIES DEPARTMENT. THIS INCLUDES ABANDONING TAP AT MAIN & REMOVAL OF SERVICE FROM ROW OR EASEMENT PER CORPUD HANDBOOK PROCEDURE.
- 8. INSTALL ¾" AND 2" COPPER WATER SERVICES WITH METERS LOCATED AT ROW OR WITHIN A 2'X2' WATERLINE EASEMENT IMMEDIATELY ADJACENT. NOTE: IT IS THE APPLICANT'S RESPONSIBILITY TO PROPERLY SIZE THE WATER SERVICE FOR EACH CONNECTION TO PROVIDE ADEQUATE FLOW & PRESSURE
- 9. INSTALL 6 PVC SEWER SERVICES @ 1.0% MINIMUM GRADE WITH CLEANOUTS LOCATED AT ROW OR EASEMENT LINE & SPACED EVERY 75 LINEAR FEET MAXIMUM. 10. PRESSURE REDUCING VALVES ARE REQUIRED ON ALL WATER SERVICES EXCEEDING 80 PSI; BACKWATER VALVES
- ARE REQUIRED ON ALL SANITARY SEWER SERVICES HAVING BUILDING DRAINS LOWER THAN 1.0' ABOVE THE NEXT **UPSTREAM MANHOLE.** 11. ALL ENVIRONMENTAL PERMITS APPLICABLE TO THE PROJECT MUST BE OBTAINED FROM NCDWQ, USACE &/OR
- FEMA FOR ANY RIPARIAN BUFFER, WETLAND &/OR FLOODPLAIN IMPACTS (RESPECTIVELY) PRIOR TO CONSTRUCTION. 12. NCDOT / RAILROAD ENCROACHMENT AGREEMENTS ARE REQUIRED FOR ANY UTILITY WORK (INCLUDING MAIN EXTENSIONS & SERVICE TAPS) WITHIN STATE OR RAILROAD ROW PRIOR TO CONSTRUCTION.
- 13. GREASE INTERCEPTOR / OIL WATER SEPARATOR SIZING CALCULATIONS & INSTALLATION SPECIFICATIONS SHALL BE APPROVED BY THE RW FOG PROGRAM COORDINATOR PRIOR TO ISSUANCE OF A UC AND/OR BUILDING PERMIT. CONTACT (919) 996-4516 OR
- FOG@RALEIGHNC.GOV FOR MORE INFORMATION. 14. CROSS-CONNECTION CONTROL PROTECTION DEVICES ARE REQUIRED BASED ON DEGREE OF HEALTH HAZARD
- INVOLVED AS LISTED IN APPENDIX-B OF THE RULES GOVERNING PUBLIC WATER SYSTEMS IN NORTH CAROLINA. 15. THE DEVICES SHALL MEET AMERICAN SOCIETY OF SANITARY ENGINEERING (ASSE) STANDARDS AND BE ON THE
- SOUTHERN CALIFORNIA APPROVAL LIST.
- 16. THE DEVICE AND INSTALLATION SHALL MEET THE GUIDELINES OF APPENDIX A GUIDELINES AND REQUIREMENTS FOR THE CROSS CONNECTION PROGRAM IN RALEIGH'S SERVICE AREA.
- 17. THE DEVICES SHALL BE INSTALLED AND TESTED (BOTH INITIAL AND PERIODIC TESTING THEREAFTER) IN
- ACCORDANCE WITH THE MANUFACTURER'S RECOMMENDATIONS OR THE LOCAL CROSS-CONNECTION CONTROL PROGRAM, WHICHEVER IS MORE STRINGENT.
- CONTACT CROSS.CONNECTION@RALEIGHNC.GOV FOR MORE INFORMATION. 18. NOTICE FOR PROJECTS WITH REPLACED OR OVERSIZED MAINS: IF THE CITY'S REIMBURSEMENT FOR AN
- OVERSIZED MAIN OR URBAN MAIN REPLACEMENT PROJECT IS \$250,000 OR GREATER, THE PROJECT MUST BE
- 19. RALEIGH WATER STAFF MAY NEED TO BE ONSITE WHILE ANY CONSTRUCTION OCCURS IN THE VICINITY OF THE CRITICAL WATER TRANSMISSION MAIN. PLEASE EMAIL WDSERVICEREQUESTDL@RALEIGHNC.GOV AT A MINIMUM 72 HOURS IN ADVANCE TO ANY WORK IN THE VICINITY OF THIS CRITICAL WATER TRANSMISSION MAIN.

BACKFLOW PREVENTION NOTES

- .. REDUCED PRESSURE PRINCIPLE BACKFLOW PREVENTION ASSEMBLY AS APPROVED BY TOWN OF ROLESVILLE AND INSTALLED BY CONTRACTOR DURING CONSTRUCTION. ASSEMBLY TO INSTALLED ABOVE GROUND WITHIN INSULATED ENCLOSURE PER TOWN OF ROLESVILLE REQUIREMENTS. ENCLOSURE TO BE LOCATED OUT OF SETBACK.
- 2. THERE SHALL BE NO TAPS, PIPING BRANCHES, UNAPPROVED BYPASS PIPING, HYDRANTS, FIRE DEPT. CONNECTION POINTS OR OTHER WATER USING APPURTENANCES CONNECTED TO THE SUPPLY LINE BETWEEN ANY WATER METER AND ITS REQUIRED
- 3. EACH REQUIRED BACKFLOW PREVENTION ASSEMBLY IS REQUIRED TO BE TESTED BY AN APPROVED CERTIFIED TESTER PRIOR TO PLACING THE WATER SYSTEM IN SERVICE AND YEARLY THEREAFTER. SUBMIT PASSING TEST REPORTS TO TOWN OF ROLESVILLE. 4. DUCTILE IRON, COPPER, OR OTHER METALLIC PIPING (NO PVC) IS TO BE USED WITHIN 5 FEET OF ALL BACKFLOW PREVENTION
- 5. TAMPER SWITCHES SHALL BE INSTALLED ON THE FIRE LINE BACKFLOW PREVENTION. INSTALL 3/4" CONDUIT FROM FIRE LINE BACKFLOW ENCLOSURE/VAULT TO BUILDING ALARM SYSTEM INSIDE BUILDING. COORDINATE WITH ELECTRICAL DRAWINGS AND

SW+ PROJECT:

DATE: 1/28/24 DRAWN BY: CPE CHECKED BY:

MOUNT PLEASANT, SC

843.884.1667

864.298.0534

SUMMERVILLE, SC

843.972.0710

SPARTANBURG, SC

864.272.1272

CHARLOTTE, NC

980.312.5450

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NGINEER

GREENVILLE, SC

REVISION HISTORY A 12/22/23 F 11/06/24 B 03/01/24 G 12/20/24 C 09/04/24 H 1/03/25 D 10/01/24


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UTILITY PLAN AND **PROFILES**


SCALE: 1" = 20'

THE LOCATION OF EXISTING UNDERGROUND UTILITIES ARE SHOWN IN AN APPROXIMATE WAY ONLY AND HAVE NOT BEEN INDEPENDENTLY VERIFIED BY THE OWNER OR ITS REPRESENTATIVE THE CONTRACTOR SHALL DETERMINE THE EXACT LOCATION OF ALL EXISTING UTILITIES BEFORE COMMENCING ANY WORK, AND AGREES TO BE FULLY RESPONSIBLE FOR ANY AND ALL DAMAGES WHICH MIGHT OCCUR DUE TO THE CONTRACTOR'S FAILURE TO EXACTLY LOCATE AND PRESERVE ANY AND ALL UNDERGROUND UTILITIES.



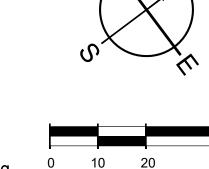

C7.1

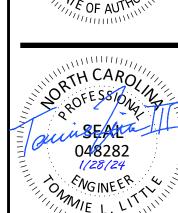

SW+ PROJECT: 1/28/24 CPE

DRAWN BY: CHECKED BY: **REVISION HISTORY**

10/30/23 | A 12/22/23 F 11/06/24 B 03/01/24 G 12/20/24 C 09/04/24 H 1/03/25

E 11/01/24 UTILITY PROFILES

D 10/01/24

LOCATION OF ALL EXISTING UTILITIES BEFORE COMMENCING ANY WORK, AND AGREES TO BE FULLY RESPONSIBLE FOR ANY AND ALL DAMAGES WHICH MIGHT OCCUR DUE TO THE CONTRACTOR'S Know what's below.

Call before you dig. FAILURE TO EXACTLY LOCATE AND PRESERVE ANY AND ALL UNDERGROUND UTILITIES.

0 10 20 SCALE: 1" = 20'


THE LOCATION OF EXISTING UNDERGROUND


UTILITIES ARE SHOWN IN AN APPROXIMATE WAY


ONLY AND HAVE NOT BEEN INDEPENDENTLY VERIFIED BY THE OWNER OR ITS REPRESENTATIVE.

THE CONTRACTOR SHALL DETERMINE THE EXACT

EXISTING UTILITY NOTE:

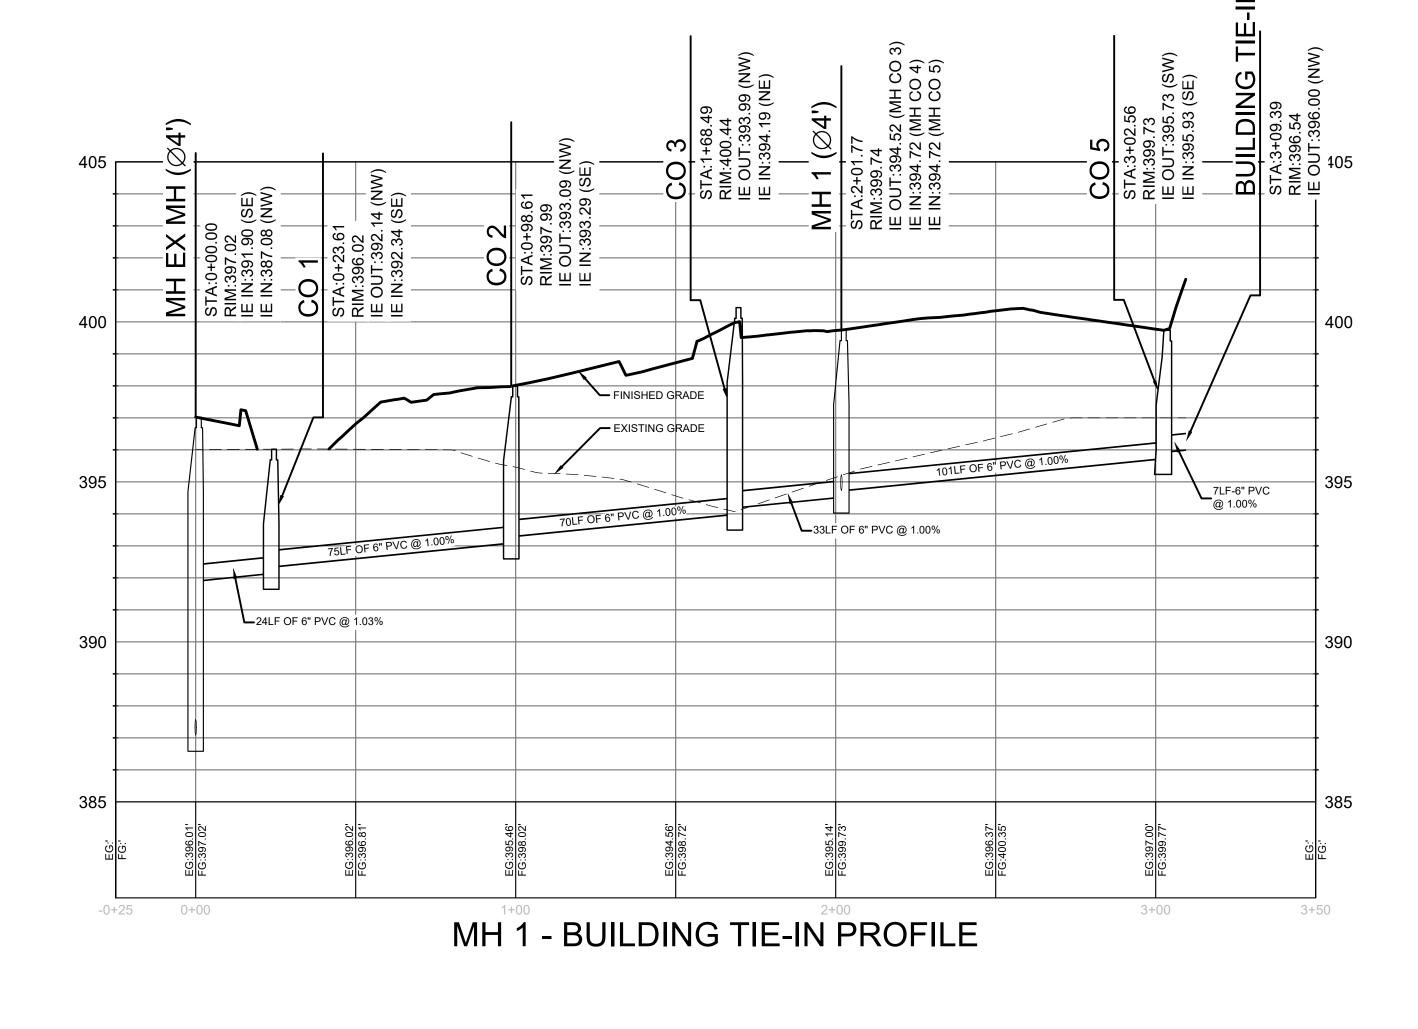

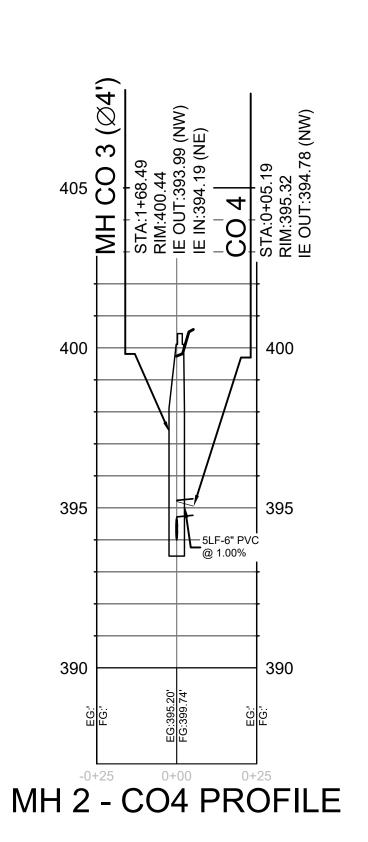

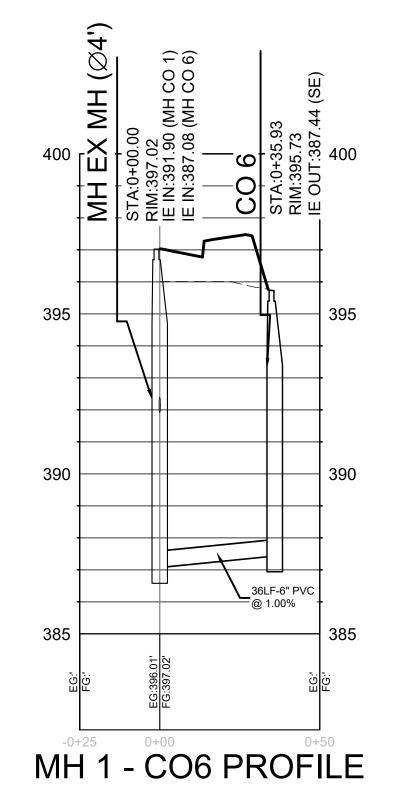

ATTENTION CONTRACTORS

The *Construction Contractor* responsible for the extension of water, sewer, and/or reuse, as approved in these plans, is responsible for contacting the Public Works Department at (919) 996-2409, and the Public Utilities Department at (919) 996-4540 at least twenty four hours prior to beginning any of their construction.

Failure to notify both City Departments in advance of beginning construction, will result in the issuance of *monetary fines*, and require reinstallation of any water or sewer facilities not inspected as a result of this notification failure.

Failure to call for Inspection, Install a Downstream Plug, have Permitted Plans on the Jobsite, or any other Violation of City of Raleigh Standards will result in a Fine and Possible Exclusion from future work in the City of Raleigh.

Public

Water Distribution / Extension System

The City of Raleigh consents to the connection and extension of the

City's public water system as shown on this plan. The material and Construction methods used for this project shall conform to the

standards and specifications of the City's Public Utilities Handbook.

City of Raleigh
Public Utilities Department Permit # W-4162


Authorization to Construct

C7.2

Raleigh Standards will result in a Fine and Possible Exclusion from

future work in the *City of Raleigh*.

Authorization to Construct

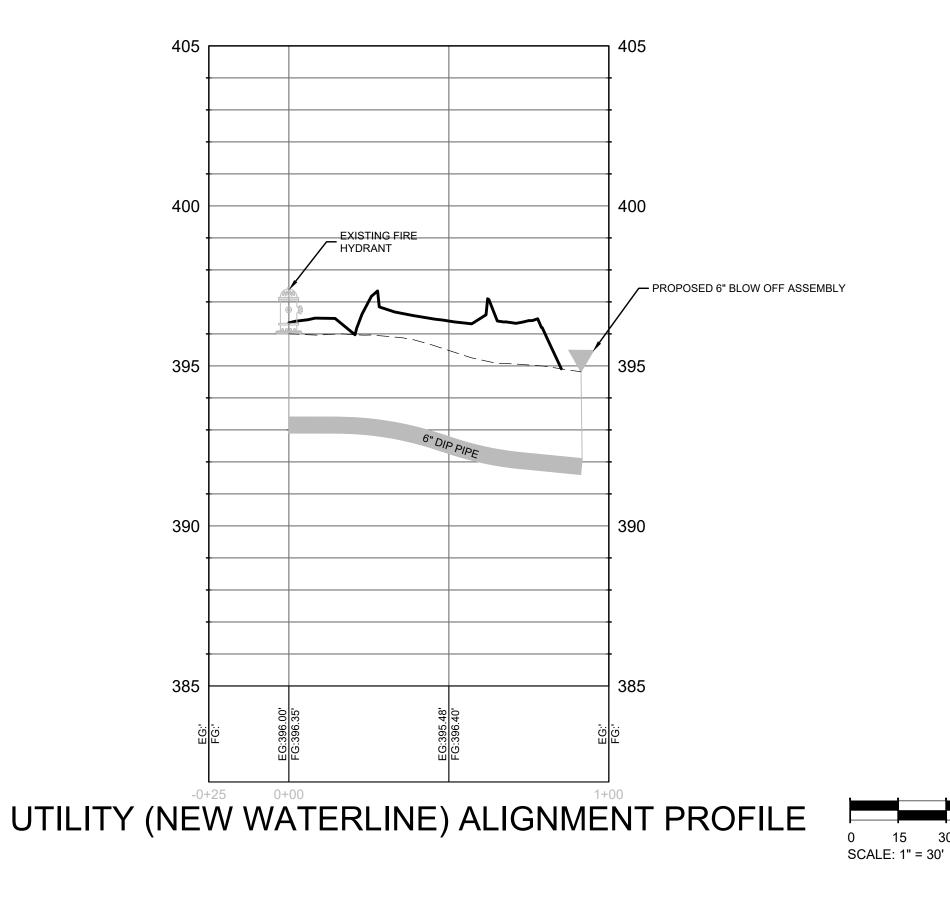

STANDARD UTILITY NOTES

1. ALL MATERIALS & CONSTRUCTION METHODS SHALL BE IN ACCORDANCE WITH CITY OF RALEIGH DESIGN STANDARDS, DETAILS &

SPECIFICATIONS (REFERENCE: CORPUD HANDBOOK, CURRENT EDITION)

2. UTILITY SEPARATION REQUIREMENTS:

- 2.a. A DISTANCE OF 100' SHALL BE MAINTAINED BETWEEN SANITARY SEWER & ANY PRIVATE OR PUBLIC WATER SUPPLY SOURCE SUCH AS AN IMPOUNDED RESERVOIR USED AS A SOURCE OF DRINKING WATER. IF ADEQUATE LATERAL SEPARATION CANNOT BE ACHIEVED, FERROUS SANITARY SEWER PIPE SHALL BE SPECIFIED & INSTALLED TO WATERLINE SPECIFICATIONS. HOWEVER, THE MINIMUM SEPARATION SHALL NOT BE LESS THAN 25' FROM A PRIVATE WELL OR 50' FROM A PUBLIC WELL.
- 2.b. WHEN INSTALLING WATER &/OR SEWER MAINS, THE HORIZONTAL SEPARATION BETWEEN UTILITIES SHALL BE 10'. IF THIS SEPARATION CANNOT BE MAINTAINED DUE TO EXISTING CONDITIONS, THE VARIATION ALLOWED IS THE WATER MAIN IN A SEPARATE TRENCH WITH THE ELEVATION OF THE WATER MAIN AT LEAST 18" ABOVE THE TOP OF THE SEWER & MUST BE APPROVED BY THE PUBLIC UTILITIES DIRECTOR. ALL DISTANCES ARE MEASURED
- FROM OUTSIDE DIAMETER TO OUTSIDE DIAMETER.

 2.c. WHERE IT IS IMPOSSIBLE TO OBTAIN PROPER SEPARATION, OR ANYTIME A SANITARY SEWER PASSES OVER A WATERMAIN, DIP MATERIALS OR STEEL ENCASEMENT EXTENDED 10' ON EACH SIDE OF CROSSING MUST BE SPECIFIED & INSTALLED TO WATERLINE SPECIFICATIONS
- 2.d. 5.0' MINIMUM HORIZONTAL SEPARATION IS REQUIRED BETWEEN ALL SANITARY SEWER & STORM SEWER FACILITIES, UNLESS DIP MATERIAL IS SPECIFIED FOR SANITARY SEWER
- 2.e. MAINTAIN 18" MIN. VERTICAL SEPARATION AT ALL WATERMAIN & RCP STORM DRAIN CROSSINGS; MAINTAIN 18" MIN. VERTICAL SEPARATION AT ALL SANITARY SEWER & RCP STORM DRAIN CROSSINGS. WHERE ADEQUATE SEPARATIONS CANNOT BE ACHIEVED, SPECIFY DIP MATERIALS & A CONCRETE CRADLE HAVING 6" MIN.
- CLEARANCE (PER CORPUD DETAILS W41 & S-49).

 2.f. ALL OTHER UNDERGROUND UTILITIES SHALL CROSS WATER & SEWER FACILITIES WITH 18" MIN. VERTICAL SEPARATION REQUIRED.
- 3. ANY NECESSARY FIELD REVISIONS ARE SUBJECT TO REVIEW & APPROVAL OF AN AMENDED PLAN &/OR PROFILE BY THE CITY OF RALEIGH PUBLIC UTILITIES DEPARTMENT PRIOR TO CONSTRUCTION.
- DEVELOPER SHALL PROVIDE 30 DAYS ADVANCE WRITTEN NOTICE TO OWNER FOR ANY WORK REQUIRED WITHIN AN EXISTING CITY OF RALEIGH UTILITY EASEMENT TRAVERSING PRIVATE PROPERTY.
 CONTRACTOR SHALL MAINTAIN CONTINUOUS WATER & SEWER SERVICE TO EXISTING RESIDENCES &
- BUSINESSES THROUGHOUT CONSTRUCTION OF PROJECT. ANY NECESSARY SERVICE INTERRUPTIONS SHALL BE PRECEDED BY A 24-HOUR ADVANCE NOTICE TO THE CITY OF RALEIGH PUBLIC UTILITIES DEPARTMENT
- 6. 3.0' MINIMUM COVER IS REQUIRED ON ALL WATER MAINS & SEWER FORCE MAINS. 4.0' MINIMUM COVER IS REQUIRED ON ALL
- 7. IT IS THE DEVELOPER'S RESPONSIBILITY TO ABANDON OR REMOVE EXISTING WATER & SEWER SERVICES NOT BEING USED IN REDEVELOPMENT OF A SITE UNLESS OTHERWISE DIRECTED BY THE CITY OF RALEIGH PUBLIC UTILITIES DEPARTMENT. THIS INCLUDES ABANDONING TAP AT MAIN & REMOVAL OF SERVICE FROM ROW OR EASEMENT PER CORPUD HANDBOOK PROCEDURE.
- 8. INSTALL ¾" AND 2" COPPER WATER SERVICES WITH METERS LOCATED AT ROW OR WITHIN A 2'X2' WATERLINE EASEMENT IMMEDIATELY ADJACENT. NOTE: IT IS THE APPLICANT'S RESPONSIBILITY TO PROPERLY SIZE THE WATER SERVICE FOR EACH CONNECTION TO PROVIDE ADEQUATE FLOW & PRESSURE
- SERVICE FOR EACH CONNECTION TO PROVIDE ADEQUATE FLOW & PRESSURE

 9. INSTALL 6 PVC SEWER SERVICES @ 1.0% MINIMUM GRADE WITH CLEANOUTS LOCATED AT ROW OR EASEMENT LINE & SPACED EVERY 75 LINEAR FEET MAXIMUM.
- 10. PRESSURE REDUCING VALVES ARE REQUIRED ON ALL WATER SERVICES EXCEEDING 80 PSI; BACKWATER VALVES ARE REQUIRED ON ALL SANITARY SEWER SERVICES HAVING BUILDING DRAINS LOWER THAN 1.0' ABOVE THE NEXT UPSTREAM MANHOLE.
- 11. ALL ENVIRONMENTAL PERMITS APPLICABLE TO THE PROJECT MUST BE OBTAINED FROM NCDWQ, USACE &/OR FEMA FOR ANY RIPARIAN BUFFER, WETLAND &/OR FLOODPLAIN IMPACTS (RESPECTIVELY) PRIOR TO CONSTRUCTION.
 12. NCDOT / RAILROAD ENCROACHMENT AGREEMENTS ARE REQUIRED FOR ANY UTILITY WORK (INCLUDING MAIN EXTENSIONS & SERVICE TAPS) WITHIN STATE OR RAILROAD ROW PRIOR TO CONSTRUCTION.
- 13. GREASE INTERCEPTOR / OIL WATER SEPARATOR SIZING CALCULATIONS & INSTALLATION SPECIFICATIONS SHALL BE APPROVED BY THE RW FOG PROGRAM COORDINATOR PRIOR TO ISSUANCE OF A UC AND/OR BUILDING PERMIT. CONTACT (919) 996-4516 OR FOG@RALEIGHNC.GOV FOR MORE INFORMATION.
- 14. CROSS-CONNECTION CONTROL PROTECTION DEVICES ARE REQUIRED BASED ON DEGREE OF HEALTH HAZARD INVOLVED AS LISTED IN APPENDIX-B OF THE RULES GOVERNING PUBLIC WATER SYSTEMS IN NORTH CAROLINA.

 15. THE DEVICES SHALL MEET AMERICAN SOCIETY OF SANITARY ENGINEERING (ASSE) STANDARDS AND BE ON THE
- 15. THE DEVICES SHALL MEET AMERICAN SOCIETY OF SANITARY ENGINEERING (ASSE) STANDARDS AND BE ON THE UNIVERSITY OF SOUTHERN CALIFORNIA APPROVAL LIST.
- 16. THE DEVICE AND INSTALLATION SHALL MEET THE GUIDELINES OF APPENDIX A GUIDELINES AND REQUIREMENTS FOR THE CROSS CONNECTION PROGRAM IN RALEIGH'S SERVICE AREA.
- 17. THE DEVICES SHALL BE INSTALLED AND TESTED (BOTH INITIAL AND PERIODIC TESTING THEREAFTER) IN ACCORDANCE WITH THE MANUFACTURER'S RECOMMENDATIONS OR THE LOCAL CROSS-CONNECTION CONTROL PROGRAM, WHICHEVER IS MORE STRINGENT.
- CONTACT CROSS.CONNECTION@RALEIGHNC.GOV FOR MORE INFORMATION.


 18. NOTICE FOR PROJECTS WITH REPLACED OR OVERSIZED MAINS: IF THE CITY'S REIMBURSEMENT FOR AN
- OVERSIZED MAIN OR URBAN MAIN REPLACEMENT PROJECT IS \$250,000 OR GREATER, THE PROJECT MUST BE PUBLICLY BID.
- 19. RALEIGH WATER STAFF MAY NEED TO BE ONSITE WHILE ANY CONSTRUCTION OCCURS IN THE VICINITY OF THE CRITICAL WATER TRANSMISSION MAIN. PLEASE EMAIL WDSERVICEREQUESTDL@RALEIGHNC.GOV AT A MINIMUM 72 HOURS IN ADVANCE TO ANY WORK IN THE VICINITY OF THIS CRITICAL WATER TRANSMISSION MAIN.

BACKFLOW PREVENTION NOTES

- REDUCED PRESSURE PRINCIPLE BACKFLOW PREVENTION ASSEMBLY AS APPROVED BY TOWN OF ROLESVILLE AND INSTALLED BY CONTRACTOR DURING CONSTRUCTION. ASSEMBLY TO INSTALLED ABOVE GROUND WITHIN INSULATED ENCLOSURE PER TOWN OF ROLESVILLE REQUIREMENTS. ENCLOSURE TO BE LOCATED OUT OF SETBACK.
- THERE SHALL BE NO TAPS, PIPING BRANCHES, UNAPPROVED BYPASS PIPING, HYDRANTS, FIRE DEPT. CONNECTION POINTS OR
 OTHER WATER USING APPURTENANCES CONNECTED TO THE SUPPLY LINE BETWEEN ANY WATER METER AND ITS REQUIRED
 BACKFLOW PREVENTER.
- 3. EACH REQUIRED BACKFLOW PREVENTION ASSEMBLY IS REQUIRED TO BE TESTED BY AN APPROVED CERTIFIED TESTER PRIOR TO PLACING THE WATER SYSTEM IN SERVICE AND YEARLY THEREAFTER. SUBMIT PASSING TEST REPORTS TO TOWN OF ROLESVILLE.
- PLACING THE WATER SYSTEM IN SERVICE AND YEARLY THEREAFTER. SUBMIT PASSING TEST REPORTS TO TOWN OF ROLESVILLE
 4. DUCTILE IRON, COPPER, OR OTHER METALLIC PIPING (NO PVC) IS TO BE USED WITHIN 5 FEET OF ALL BACKFLOW PREVENTION DEVICES.
- 5. TAMPER SWITCHES SHALL BE INSTALLED ON THE FIRE LINE BACKFLOW PREVENTION. INSTALL 3/4" CONDUIT FROM FIRE LINE BACKFLOW ENCLOSURE/VAULT TO BUILDING ALARM SYSTEM INSIDE BUILDING. COORDINATE WITH ELECTRICAL DRAWINGS AND ALARM SYSTEM MANUFACTURER





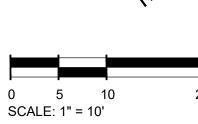

EXISTING UTILITY NOTE:

THE LOCATION OF EXISTING UNDERGROUND UTILITIES ARE SHOWN IN AN APPROXIMATE WAY ONLY AND HAVE NOT BEEN INDEPENDENTLY VERIFIED BY THE OWNER OR ITS REPRESENTATIVE. THE CONTRACTOR SHALL DETERMINE THE EXACT LOCATION OF ALL EXISTING UTILITIES BEFORE COMMENCING ANY WORK, AND AGREES TO BE FULLY RESPONSIBLE FOR ANY AND ALL DAMAGES WHICH MIGHT OCCUR DUE TO THE CONTRACTOR'S FAILURE TO EXACTLY LOCATE AND PRESERVE ANY AND ALL UNDERGROUND

SEAMONWHITESIDE

MOUNT PLEASANT, SC 843.884.1667 GREENVILLE, SC 864.298.0534 SUMMERVILLE, SC

843.972.0710 SPARTANBURG, SC 864.272.1272 CHARLOTTE, NC 980.312.5450

980.312.5450 www.seamonwhiteside.com





JESVILLE, NC

ROJECT: 10772 1/28/24 I BY: CPE ED BY: TLL

DRAWN BY: CPE
CHECKED BY: TLL


REVISION HISTORY

10/30/23 | A 12/22/23 | F 11/06/24 | B 03/01/24 | G 12/20/24 | C 09/04/24 | H 1/03/25 | D 10/01/24 |

E 11/01/24

OFFSITE WATER MAIN EXTENSION

C7.3

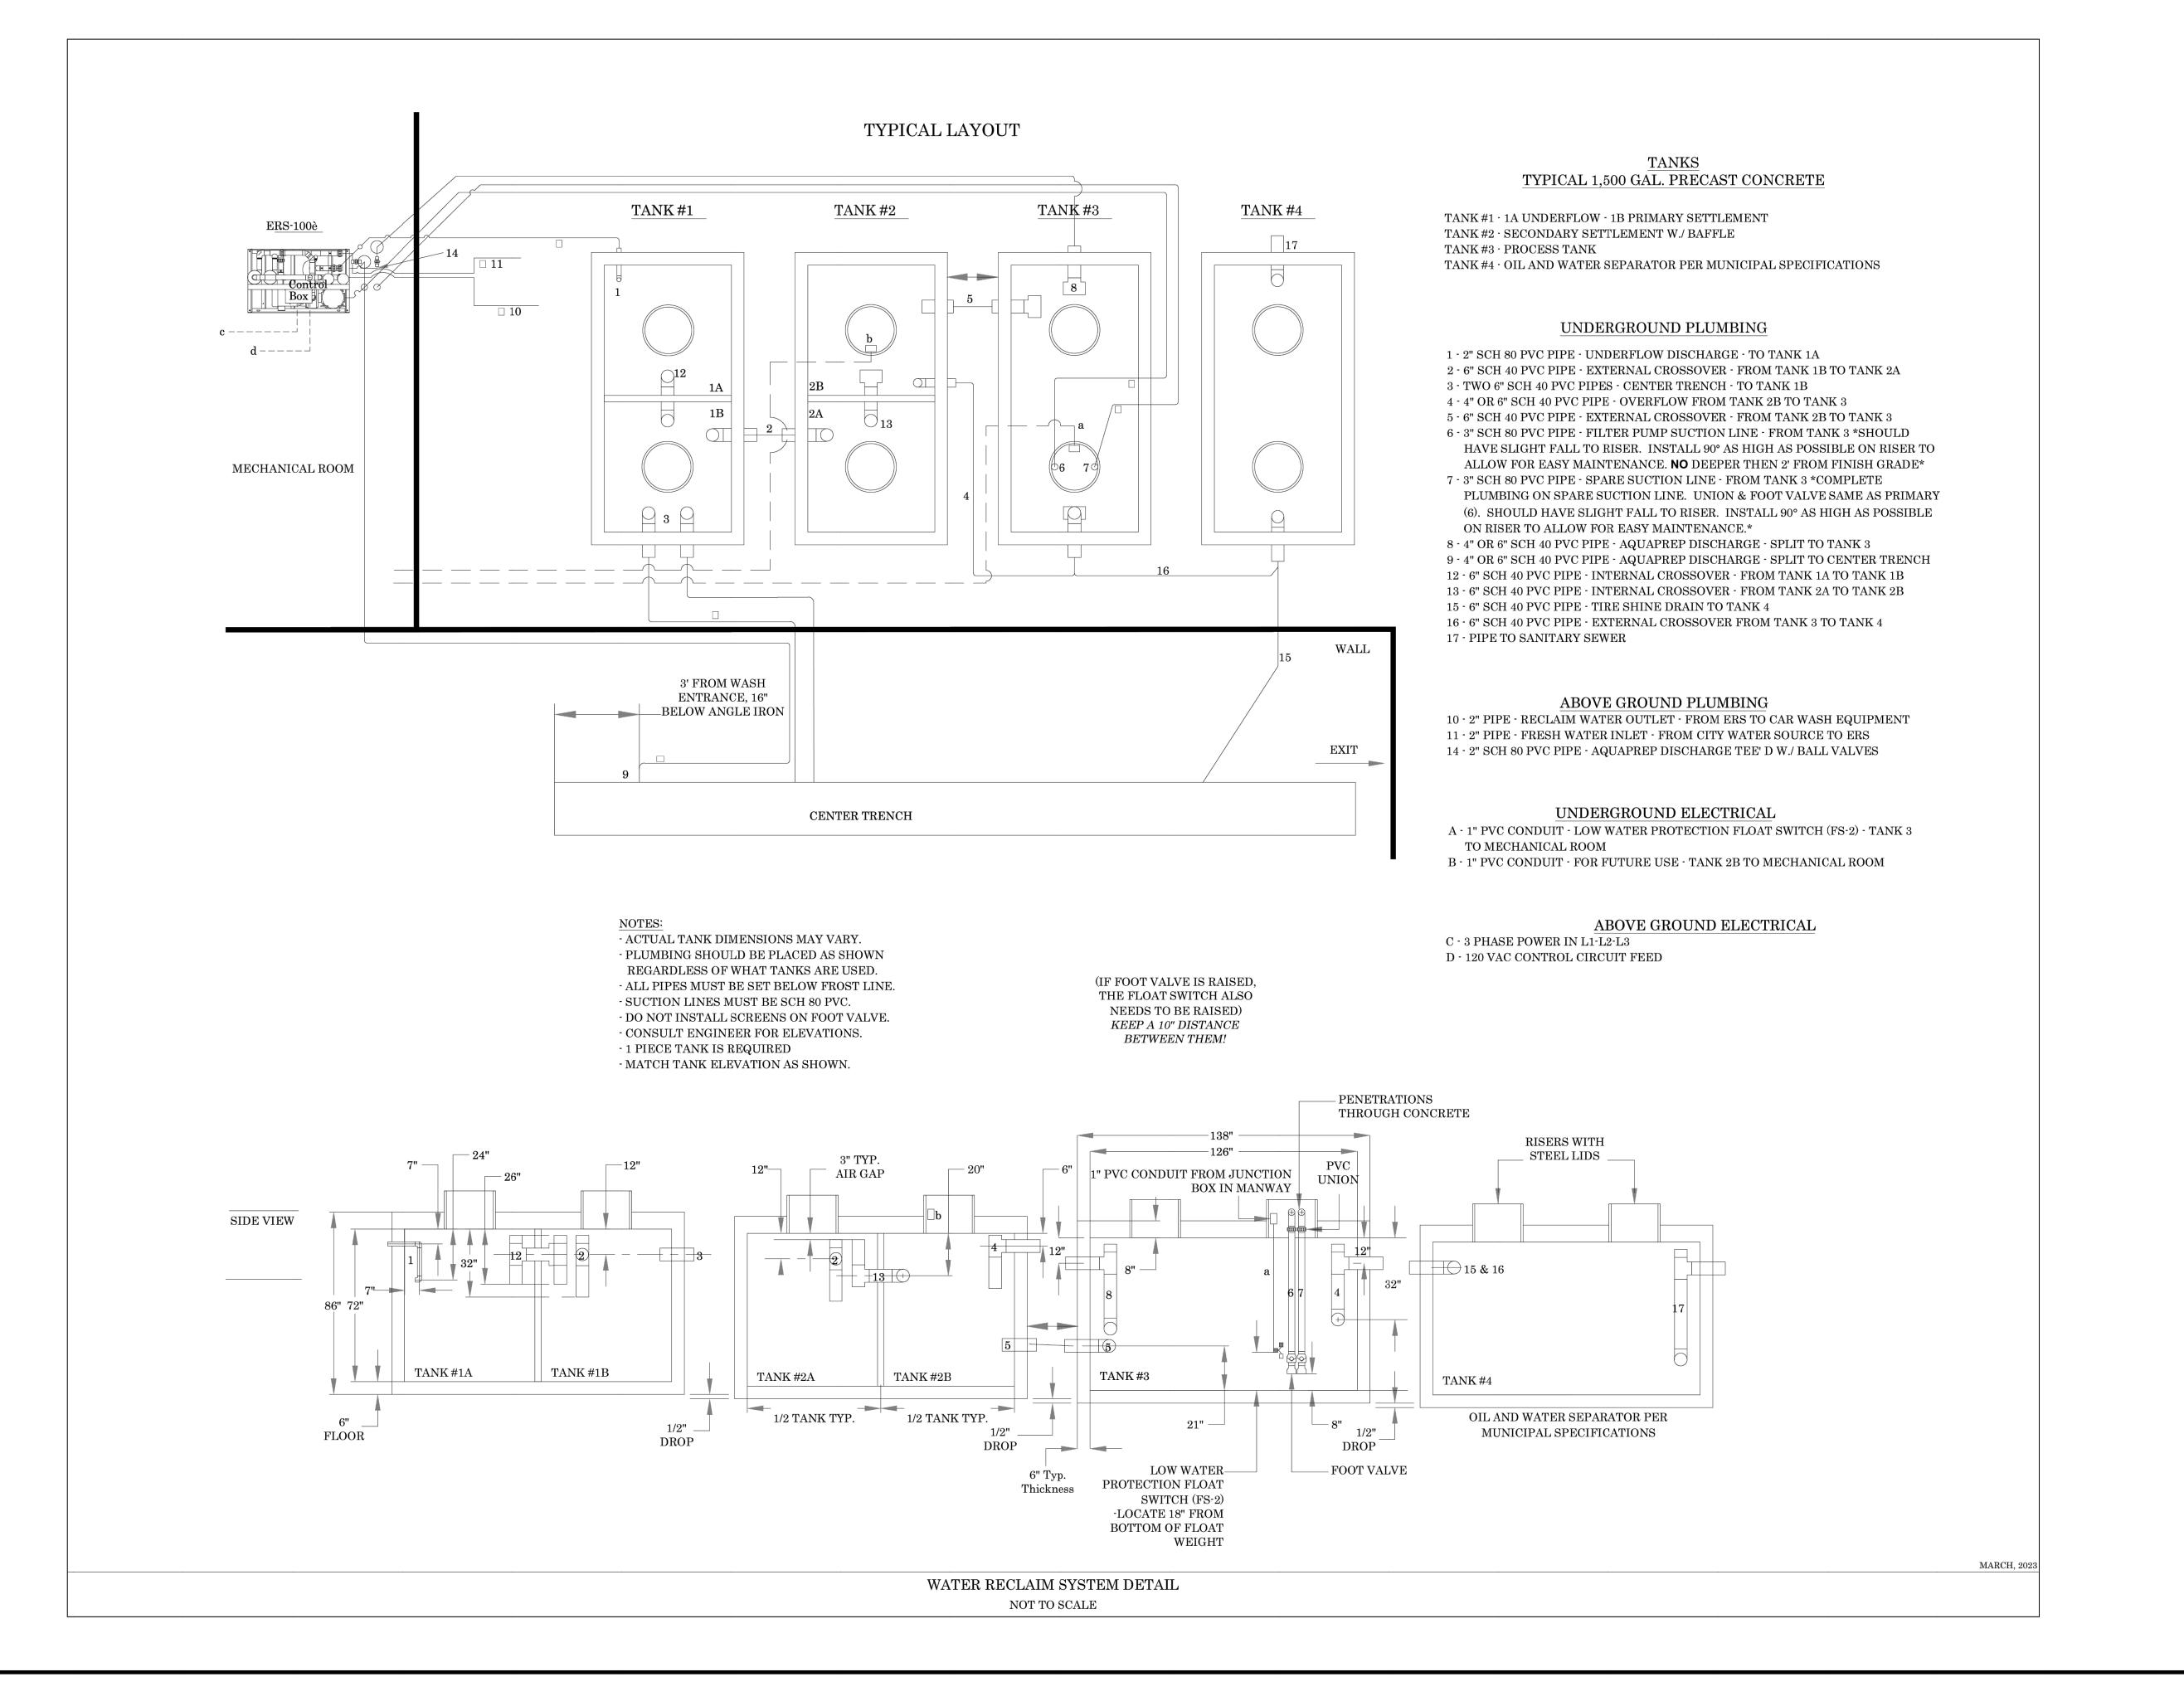



SHJ
Construction Group
A Design-Build Firm

DATE OF PLANS

REVISIONS

YSTEM

RECL

WATER

03/31/2023

D. DATE DESCRIPTION

CRITERI

TECHNIC

MOUNT PLEASANT, SC 843.884.1667 GREENVILLE, SC 864.298.0534 SUMMERVILLE, SC 843.972.0710 SPARTANBURG, SC 864.272.1272 CHARLOTTE, NC 980.312.5450

WWW.SEAMONWHITESIDE.COM

SEAMON,
WHITESIDE &
ASSOCIATES, INC.
NO. C-2466
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OF AUTHOR

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OMMIE L. LIT

AL WAVE AUTO SPA

SW+ PROJECT: 10772
DATE: 1/28/24
DRAWN BY: CPE
CHECKED BY: TLL

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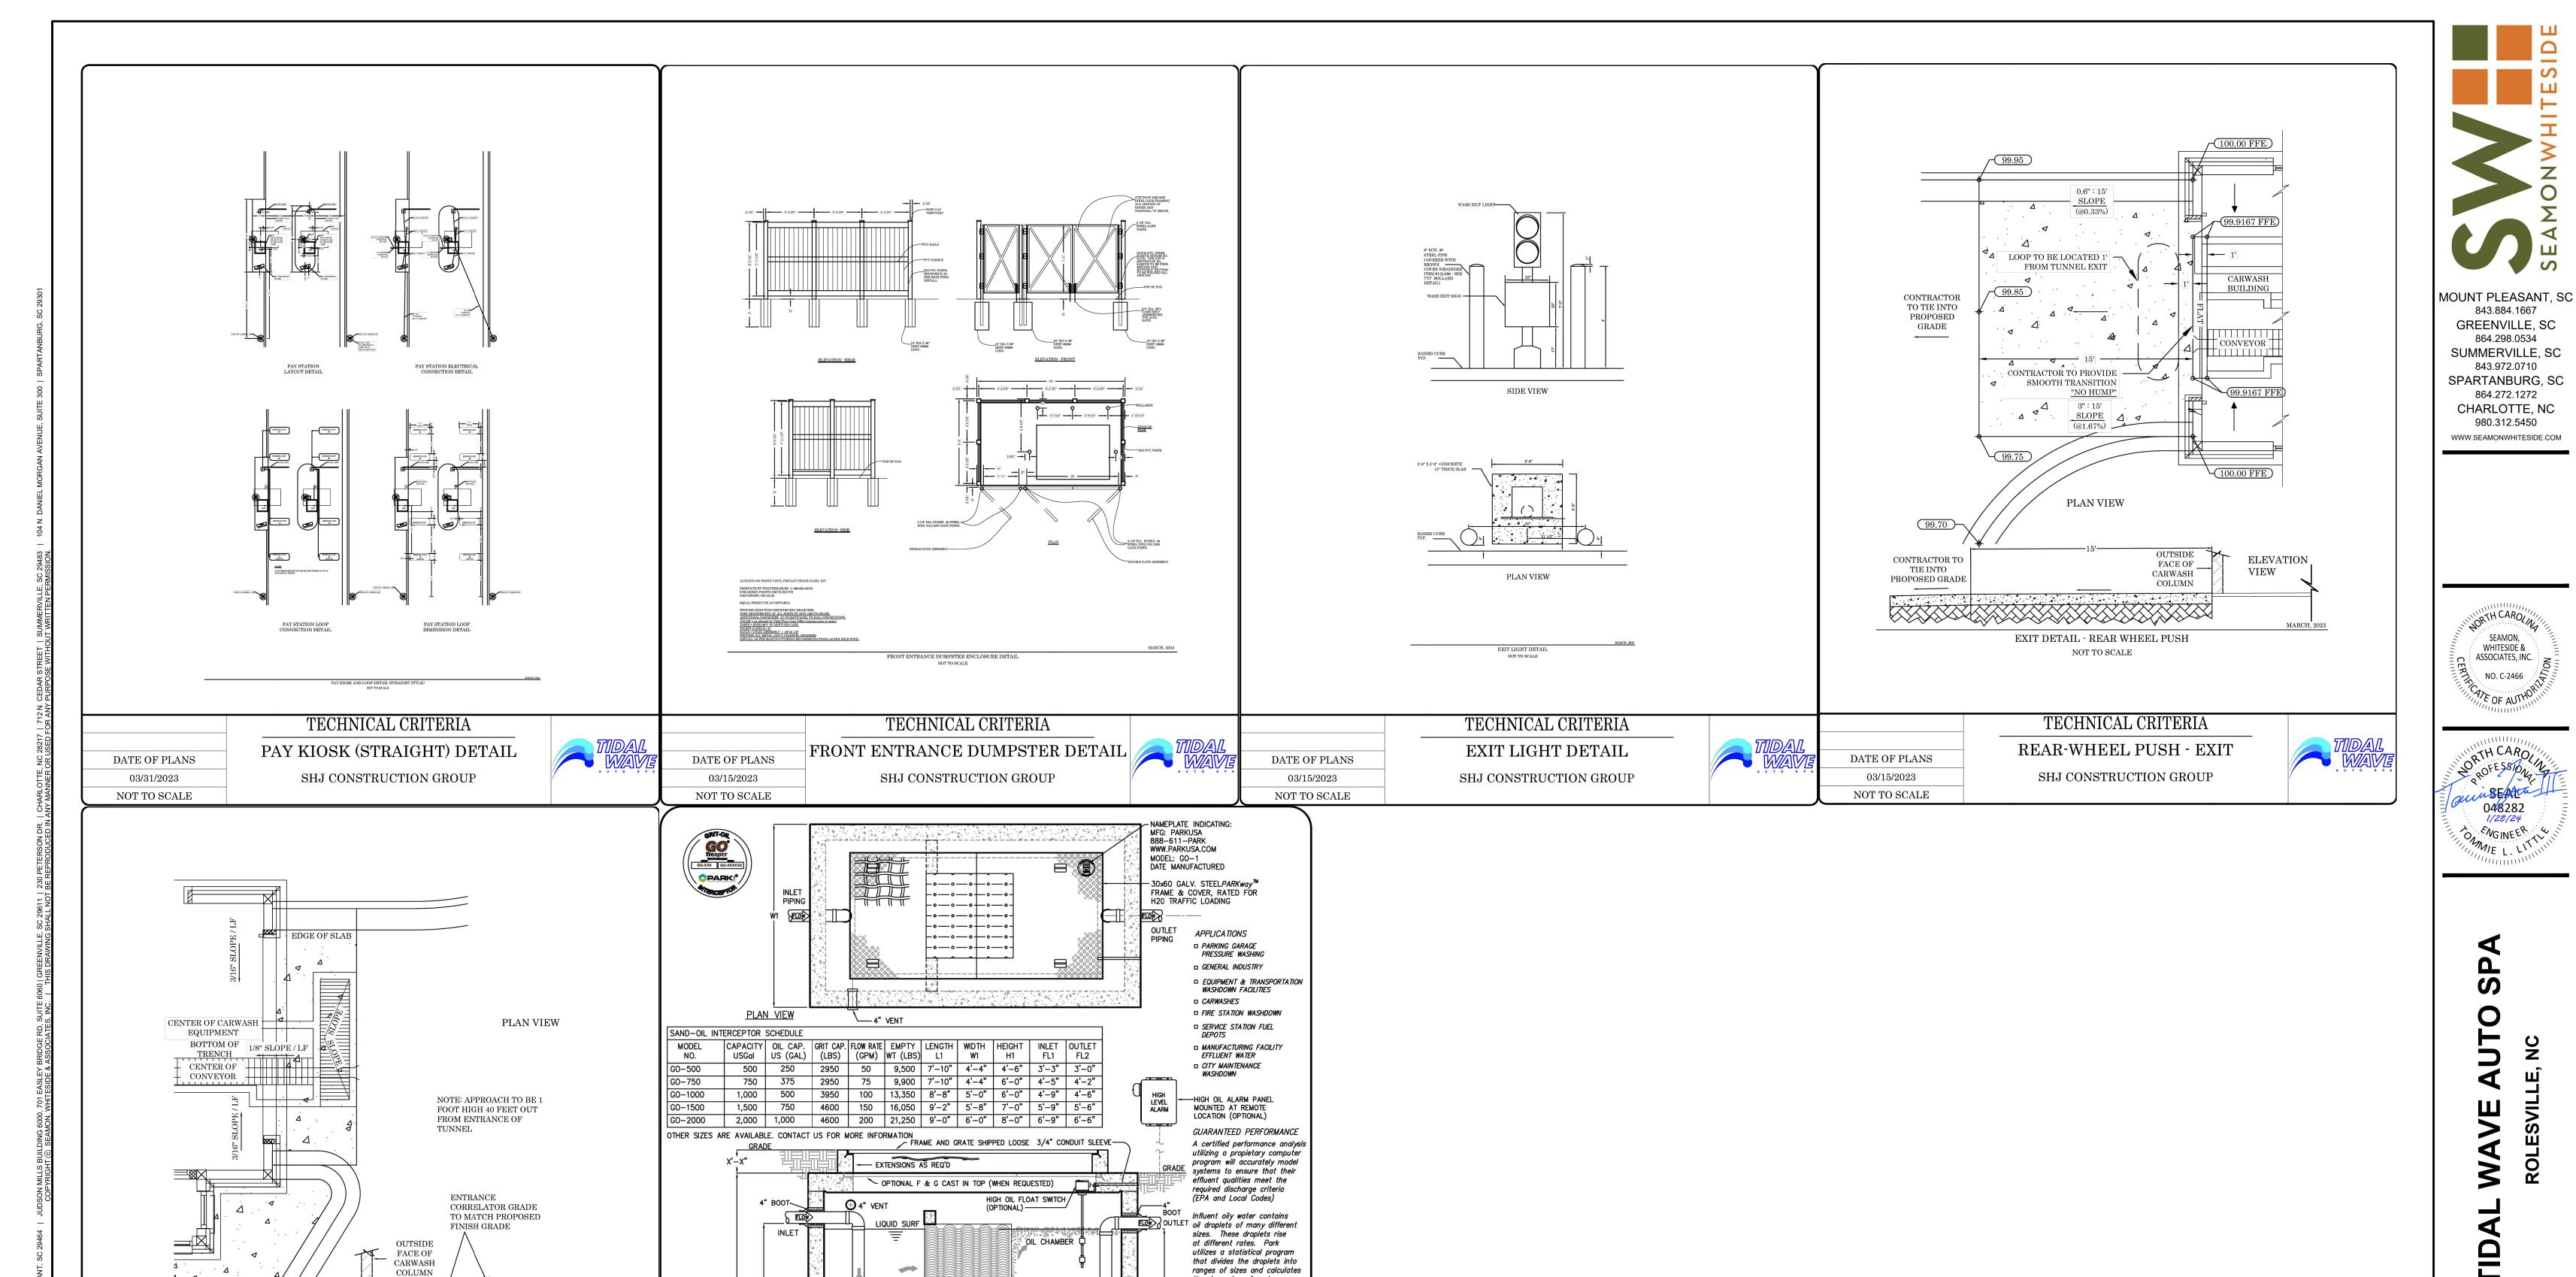
A B C

NOT TO SCALE

SHEET

A 12/22/23 F 11/06/24 B 03/01/24 G 12/20/24 C 09/04/24 H 1/03/25 D 10/01/24 E 11/01/24

CONSTRUCTION DETAILS



the rise rates of each range. This calculation determines

which droplets the separator

Contact our Engineering Dept. @ 888–611–PARK for a free

performance evaluation.

Trooper

Trooper

can capture.

COALESCING -

⊥MEDIA PACK™

INLET

WEIR

Class I/II concrete with design strength of 4500 PSI at 28 days. Unit is of monolithic

with sectional riser to required depth.

construction at floor and first stage of wall

to ASTM A615 on required centers or equal.

1/4" thick nonskid floor plate, boltdown, & lifting handles. All materials to be corrosion

Access frame & cover shall be fabricated with min.

-DIFFUSION

BAFFLE

REINFORCEMENT: Grade 60 reinforced with steel rebar conforming

Interceptor is structurally and hydraulically engineered conforming to Uniform Plumbing Code. Nominal total liquid capacity

and oil holding capacity as indicated. Recommended for flow rates

of 5 to 180 GPM (consult Park for proper sizing). Manufacturer shall submit performance calculations for oil & water seperation certified by a licensed professional engineer. Field excavation and preparation shall be completed prior to delivery of interceptor.

Specifications

CONCRETE:

MATERIALS:

Engineering Data

OIL DAM PIPING -

BITUMASTIC

INT. COATING

CUSTOMER:

ENGINEER:

ORDER #:

PROJ #:

PARK

Grit Oil Interceptor Model GO

Sizes 500 thru 2000

GUARANTEED PERFORMANCE FOR CODE MAXIMUM OIL CONCENTRATION (SANITARY SEWER 400 PPM, STORM SEWER 15 PPM) @ ParkUSA. ALL RIGHTS RESERVED.

ELEVATION

3" PVC DRAIN FROM

CORRELATOR PIT TO

ENTRANCE DETAIL - REAR WHEEL PUSH

NOT TO SCALE

TECHNICAL CRITERIA

REAL-WHEEL PUSH - ENTRANCE

SHJ CONSTRUCTION GROUP

DATE OF PLANS

03/15/2023

NOT TO SCALE

843.884.1667

864.298.0534

843.972.0710

864.272.1272

980.312.5450

WHITESIDE &

ASSOCIATES, INC.

SW+ PROJECT: DATE: 1/28/24 DRAWN BY: CPE CHECKED BY: **REVISION HISTORY**

A 12/22/23 F 11/06/24 B 03/01/24 G 12/20/24 C 09/04/24 H 1/03/25 D 10/01/24 E 11/01/24

CONSTRUCTION **DETAILS**

MATERIAL:

PREPARED IN-SITU SUBSOIL OR SUBGRADE STRUCTURAL FILL

BASE COURSE GRADED AGGREGATE

BASE COURSE

CONCRETE CAST-IN-PLACE CONCRETE PAVEMENT STEEL WELDED WIRE -REINFORCEMENT 6X6-W2.9XW2.9 CAST-IN-PLACE CONCRETE PAVEMENT GRADED AGGREGATE

BASE COURSE

SUBGRADE

NOTES: 1. WHERE SHOWN, SEE PLAN FOR EXPANSION AND CONTROL JOINT LOCATIONS. OTHERWISE, SEE SPECS FOR REQUIRED LOCATION AND SPACING. 2. CONTRACTOR IS ADVISED THAT PAVING DESIGN RECOMMENDED BY GEOTECHNICAL ENGINEER IS BASED ON PREDICTED TRAFFIC LOADING AND ESTABLISHED STRENGTHS FOR PROPERLY INSTALLED PAVEMENTS. CONTRACTOR MUST COORDINATE REQUIRED GEOTECHNICAL TESTING & INSPECTION TO ENSURE THAT SUBGRADE AND PAVEMENT STRENGTH REQUIREMENTS ARE MET.


\ CONCRETE PAVEMENT - HEAVY DUTY

MATERIAL: ITEM:

SUBGRADE PREPARED IN-SITU SUBSOIL OR STRUCTURAL FILL

BASE COURSE GRADED AGGREGATE BASE COURSE


CONCRETE CAST-IN-PLACE CONCRETE

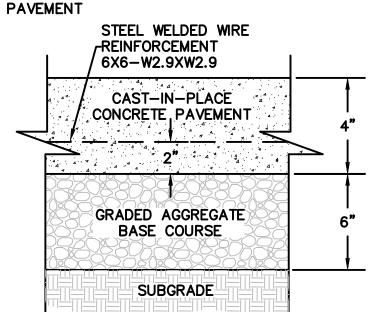


5 CONCRETE PAVEMENT - STANDARD DUTY
SCALE: NOT TO SCALE

NOTES:

1. WHERE SHOWN, SEE PLAN FOR EXPANSION AND CONTROL JOINT LOCATIONS. OTHERWISE, SEE SPECS FOR REQUIRED LOCATION AND SPACING. 2. CONTRACTOR IS ADVISED THAT PAVING DESIGN RECOMMENDED BY GEOTECHNICAL ENGINEER IS BASED ON PREDICTED TRAFFIC LOADING AND ESTABLISHED STRENGTHS FOR PROPERLY INSTALLED PAVEMENTS. CONTRACTOR MUST COORDINATE REQUIRED GEOTECHNICAL TESTING & INSPECTION TO ENSURE THAT SUBGRADE AND PAVEMENT STRENGTH REQUIREMENTS ARE MET.

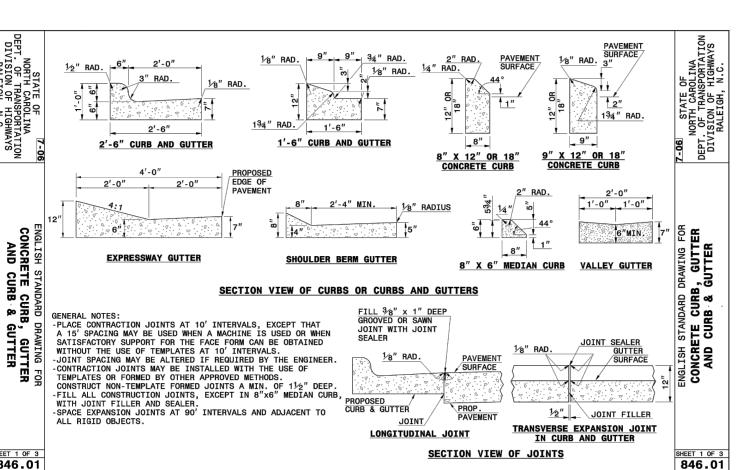

NCDOT 30" CURB AND GUTTER
SCALE: NOT TO SCALE

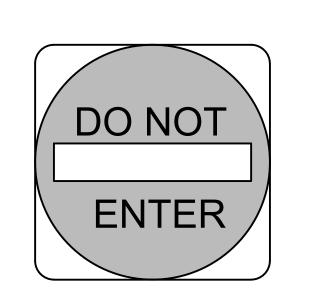


DO NOT ENTER SIGN AND INSTALLATION TO CONFORM WITH S.C.M.U.T.D. SPECIFICATIONS.

NUMBER: R5-1-30 SIZE: 30" X 30" CLASS: STANDARD

LEGEND AND BACKGROUND: WHITE-REFLECTORIZED CIRCLE: RED-REFLECTORIZED


SIGN POST: GALVANIZED U-CHANNEL PER SCDOT SPECIFICATIONS

SIGN - DO NOT ENTER SCALE: NOT TO SCALE

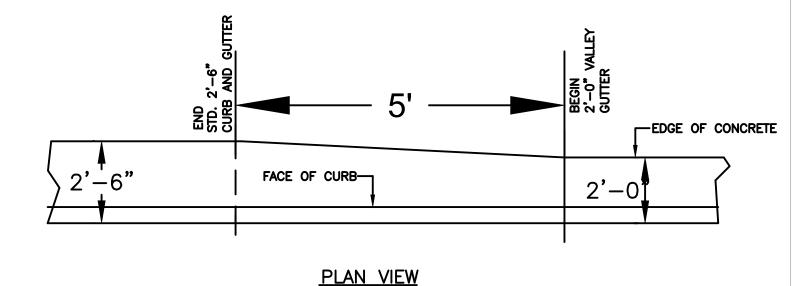


1. TRANSITION IS NOT TO BE LOCATED WITHIN THE CURB RADIUS.

24" TO 30" CURB AND GUTTER TRANSITION

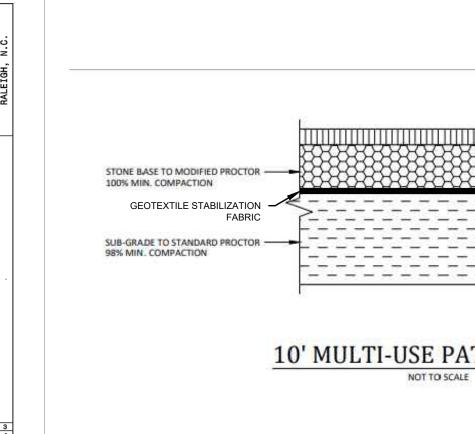


10' MULTI-USE PATH SECTION

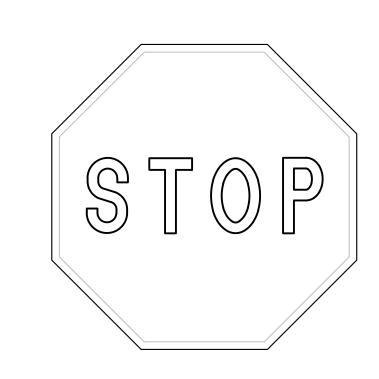


STOP SIGN AND INSTALLATION TO CONFORM WITH NCSMUTCD SPECIFICATIONS. NUMBER: R1-1-30 SIZE: 30" X 30" CLASS: STANDARD BACKGROUND: RED-REFLECTORIZED LEGEND AND BORDER: WHITE-REFLECTORIZED


SIGN POST: GALVANIZED U-CHANNEL PER NCDOT SPECIFICATIONS

\ SIGN - STOP SCALE: NOT TO SCALE

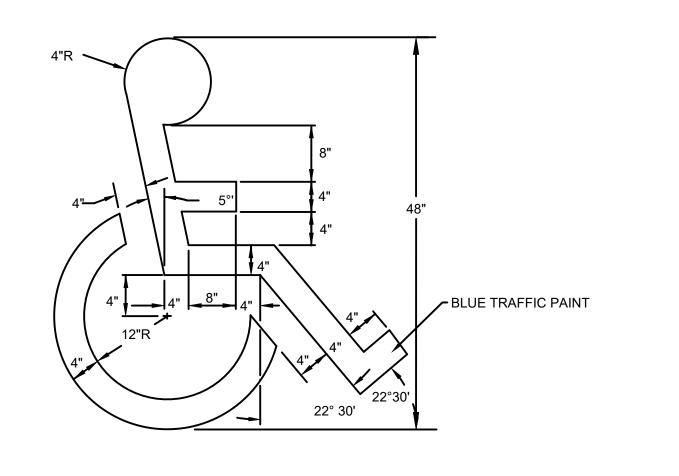


PAINTED ADA PARKING SYMBOL

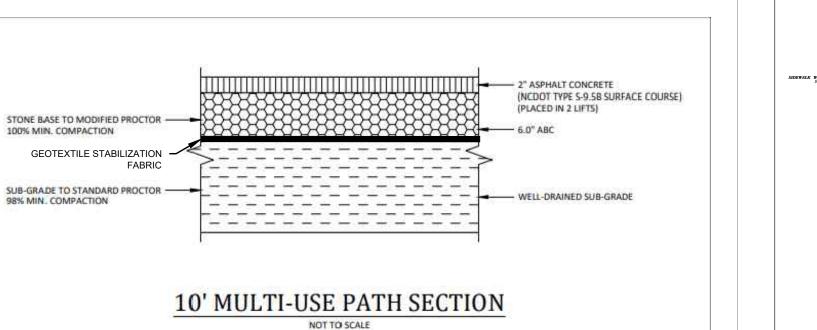

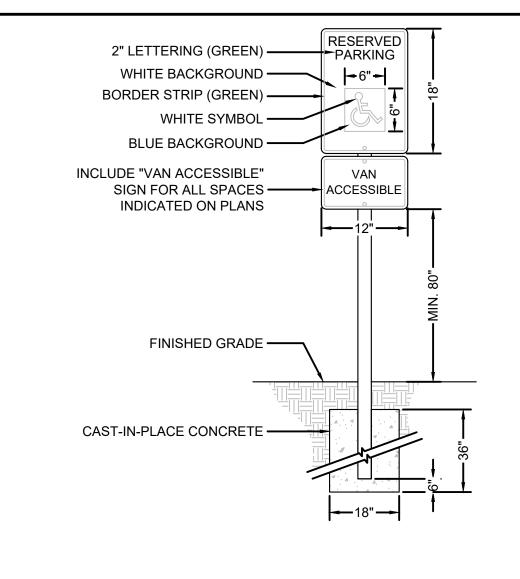


1. SIGN SHALL BE 0.080" THICK ALUMINUM WITH APPLIED REFLECTIVE SHEETING IN ACCORDANCE WITH SCDOT STANDARD SPECIFICATIONS. 2. POST SHALL BE 3" SQUARE OR 3" DIA. STEEL TUBE WITH WELDED CAP (PAINTED BLACK). 3. CONTRACTOR TO WALL MOUNT SIGN WHERE SPECIFIED.

ADA PARKING SIGN SCALE: NOT TO SCALE

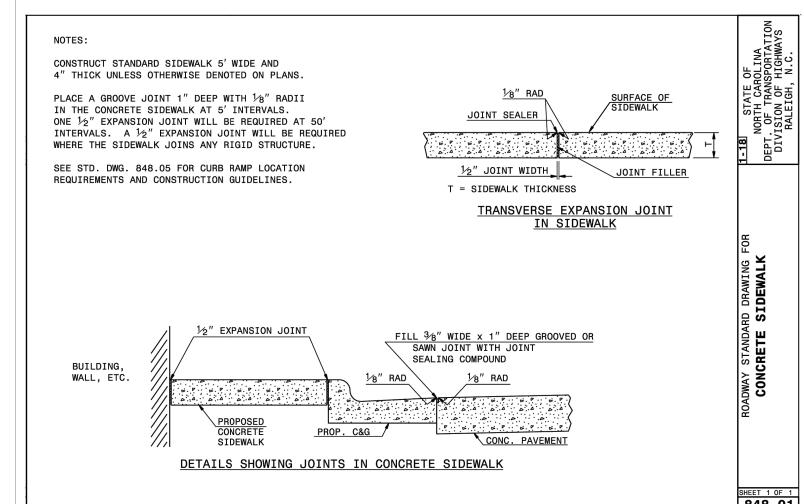

NCDOT CONCRETE SIDEWALK

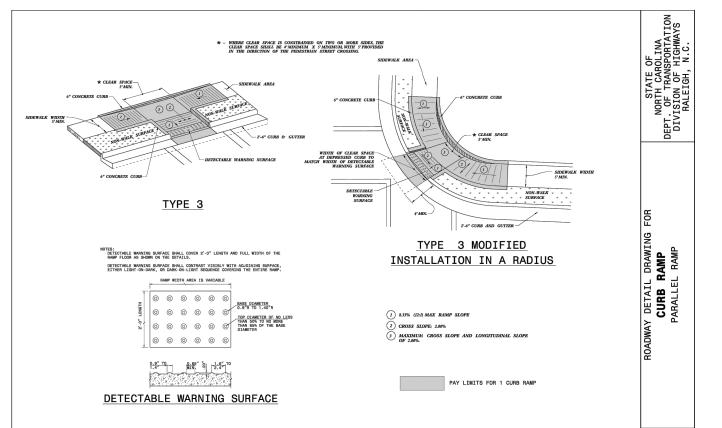

ADA CURB RAMP

DETAILS

MOUNT PLEASANT, SC 843.884.1667

GREENVILLE, SC 864.298.0534 SUMMERVILLE, SC 843.972.0710 SPARTANBURG, SC 864.272.1272

CHARLOTTE, NC 980.312.5450 WWW.SEAMONWHITESIDE.COM

TH CARO WHITESIDE & ASSOCIATES, INC. NO. C-2466



SW+ PROJECT: DATE: 1/28/24 DRAWN BY: CPE CHECKED BY: **REVISION HISTORY**

A 12/22/23 F 11/06/24 B 03/01/24 G 12/20/24 C 09/04/24 H 1/03/25 D 10/01/24 E 11/01/24

CONSTRUCTION

9 PAVEMENT-MARKING


R1=3'-3"

R2=2'-3"

CAROLINA MANUAL ON UNIFORM TRAFFIC CONTROL DEVICES.

1. ALL MARKINGS SHALL BE PAINT. 2. ALL MARKINGS SHALL BE INSTALLED IN ACCORDANCE WITH N.C.D.O.T. STANDARD SPECIFICATIONS AND NORTH

C8.3

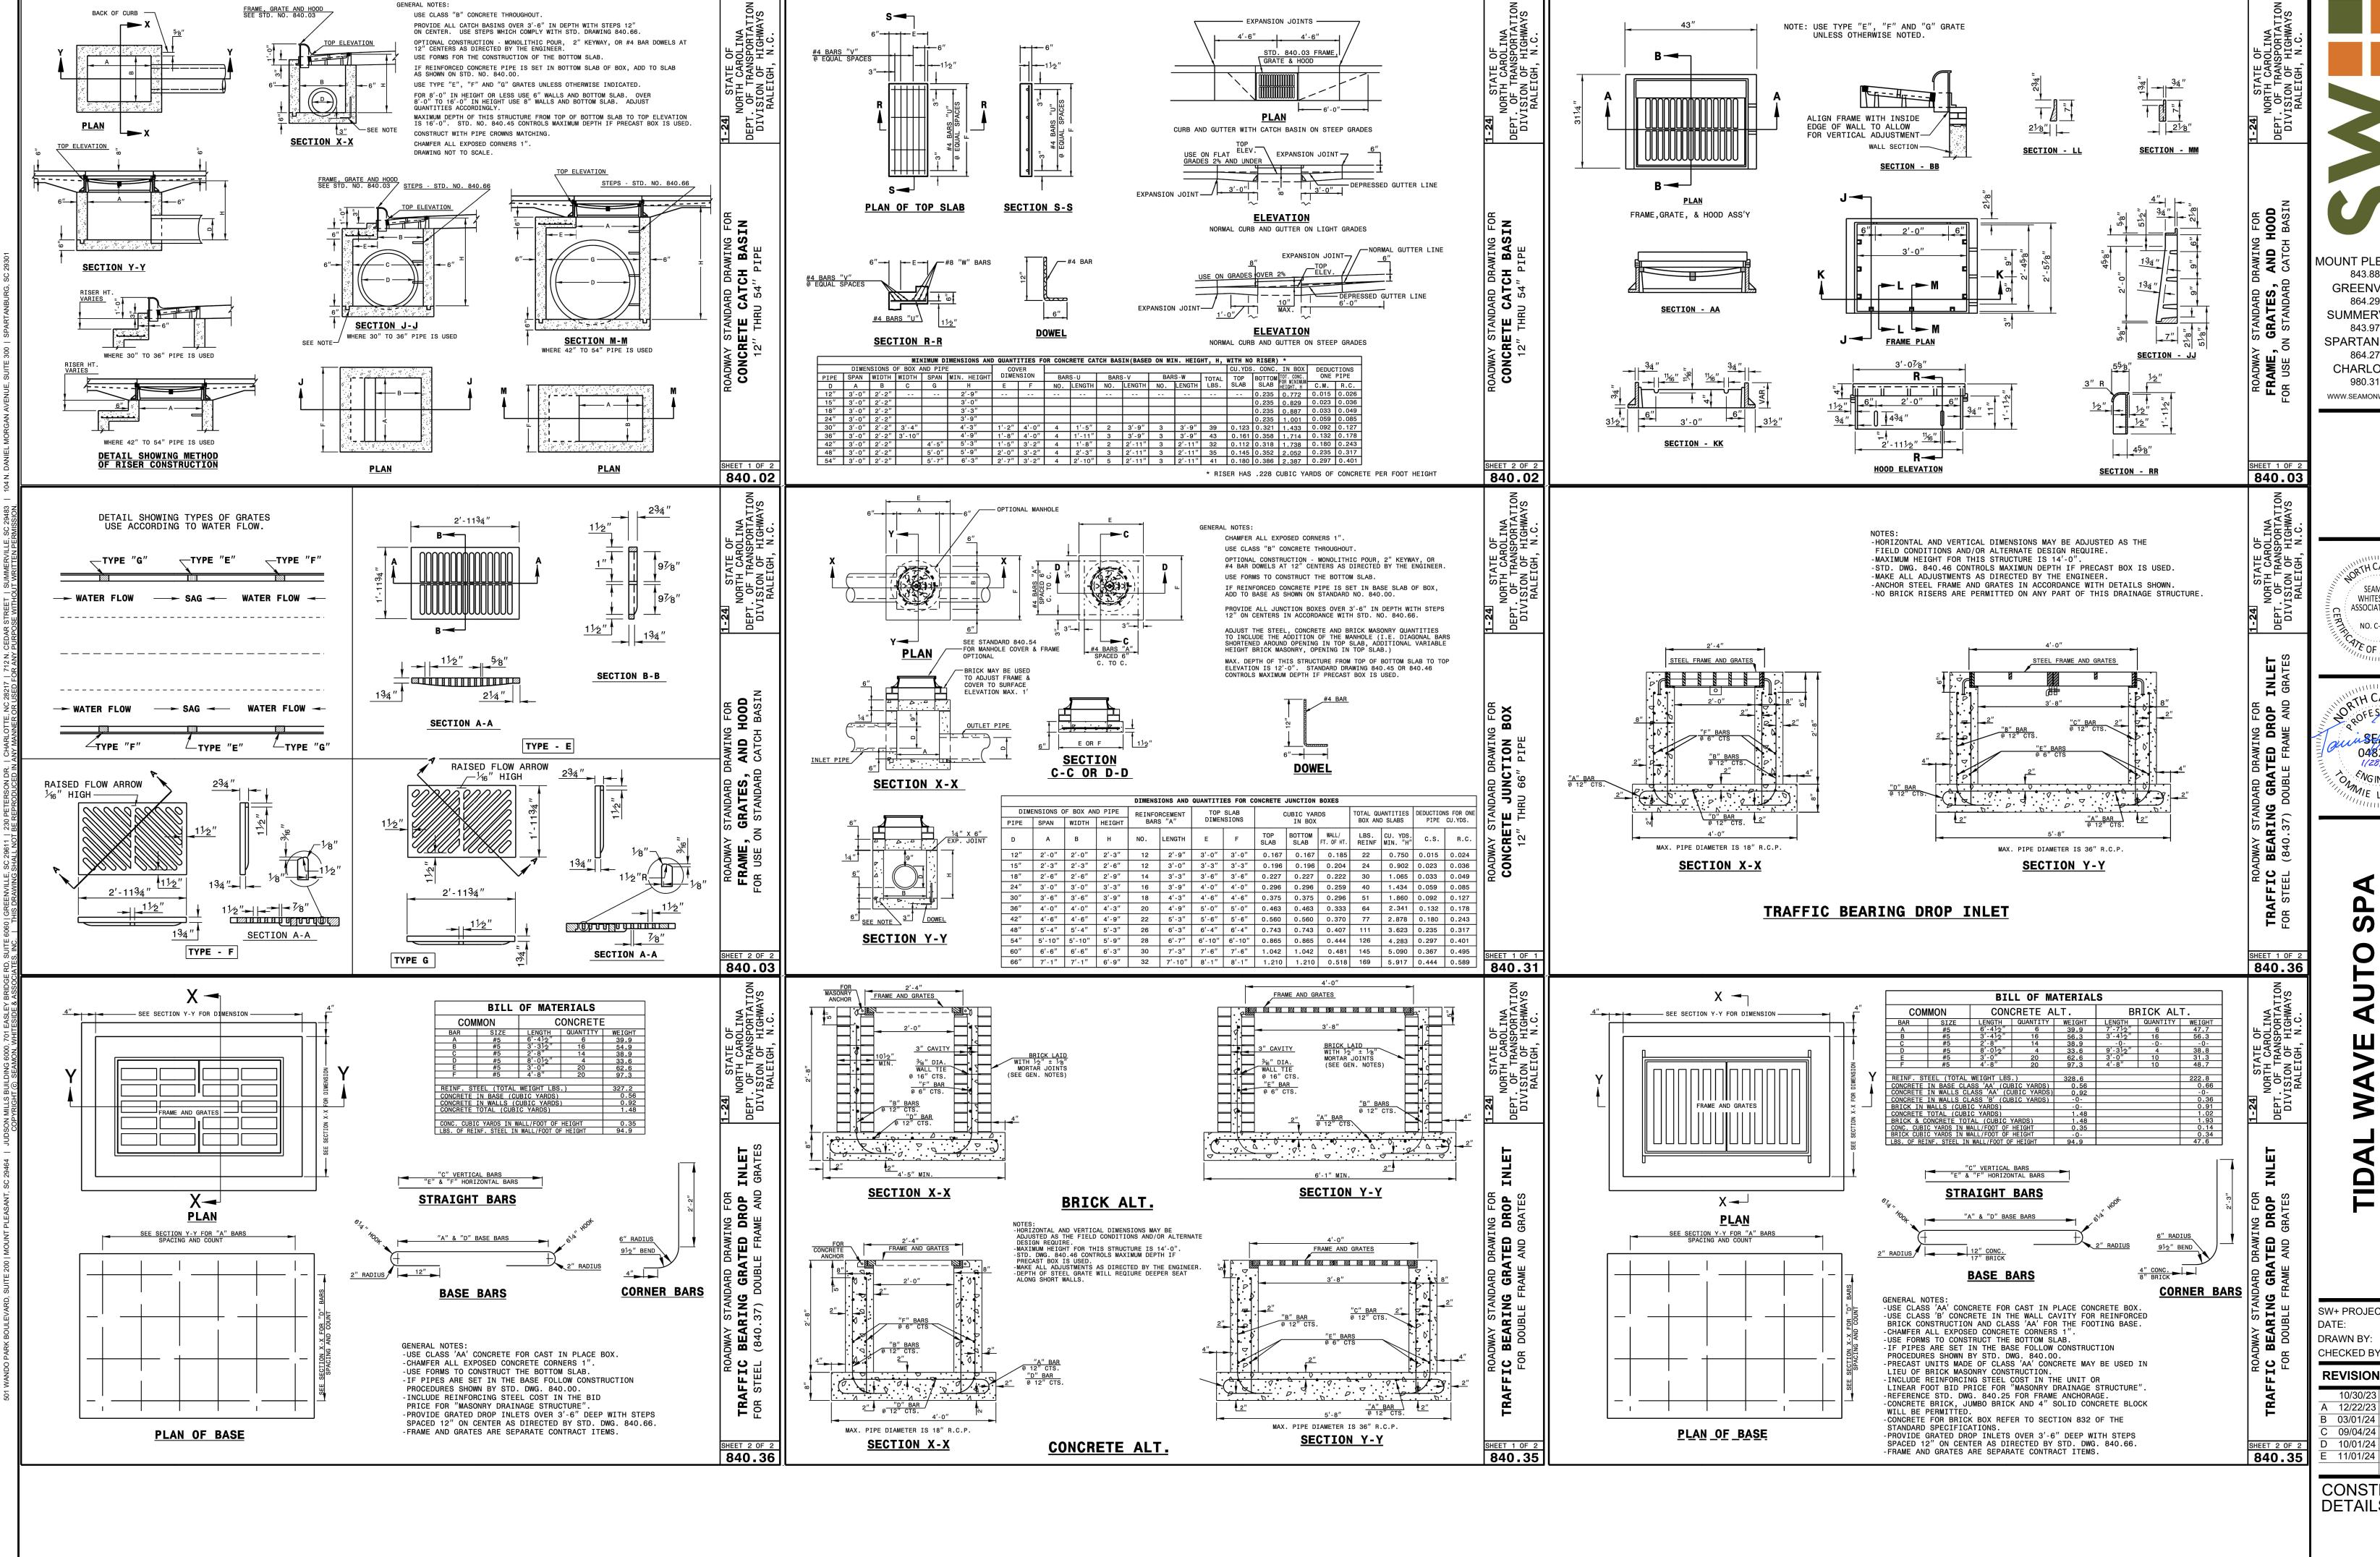

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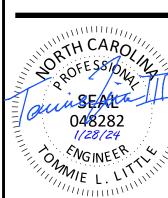
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CONSTRUCTION **DETAILS**

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REVISION HISTORY A 12/22/23 F 11/06/24 B 03/01/24 G 12/20/24 C 09/04/24 H 1/03/25

CONSTRUCTION **DETAILS**

3-30-00 D.H.L


5-34

S-20

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- WAVE AUIO SPA ROLESVILLE, NC

SW+ PROJECT: 10772
DATE: 1/28/24
DRAWN BY: CPE
CHECKED BY: TLL

REVISION HISTORY

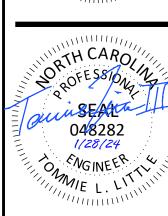10/30/23

A 12/22/23 F 11/06/24

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C 09/04/24 H 1/03/25


D 10/01/24

E 11/01/24

5-29

3-30-00

CONSTRUCTION DETAILS

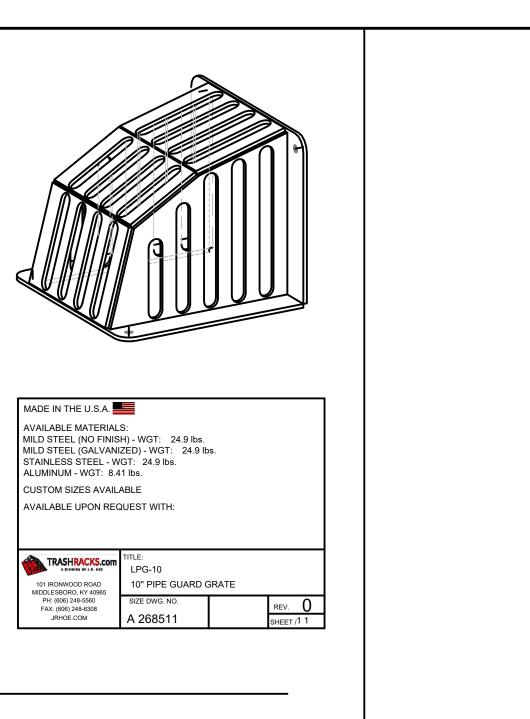


1'-1 1

Water Quality Orifice Grate

SCALE: NOT TO SCALE

6- LOCATE MARKINGS CENTERED ON BICYCLE LANE LINES. MARKINGS SHALL NOT BE LOCATED IN THE CENTER OF THE BICYCLE PATH.

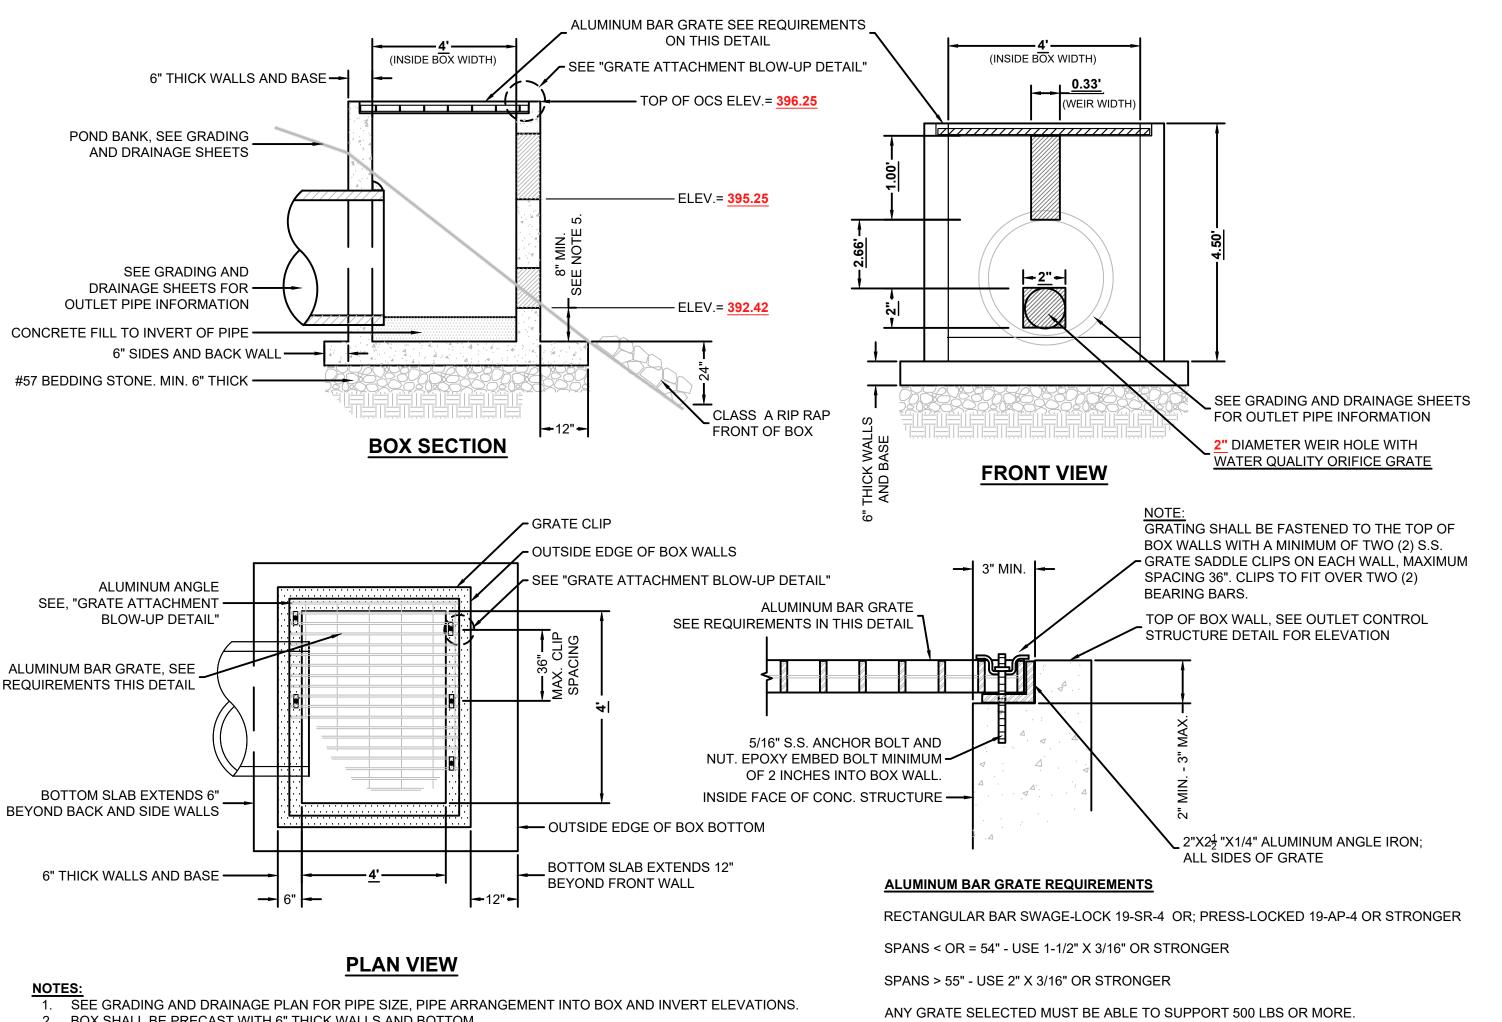

BOX SHALL BE PRECAST WITH 6" THICK WALLS AND BOTTOM. BOTTOM OF BOX TO BE CONCRETE FILLED TO INVERT OF PIPE AS SHOWN.


4- STOP BARS SHOULD BE PLACED A 4' MIN. IN ADVANCE OF NEAREST CROSSWALK LINE.

4. SEE SEPARATE "TRASH RACK" DETAIL AND "OCS RECESS STRUCTURE" DETAIL WHEN APPLICABLE.

Outlet Control Structure (OCS) with Aluminum Bar Grate

5. THIS DIMENSION MAY BE GREATER DEPENDING ON PIPE INVERT ELEVATION.

GRATE ATTACHMENT BLOW-UP DETAIL

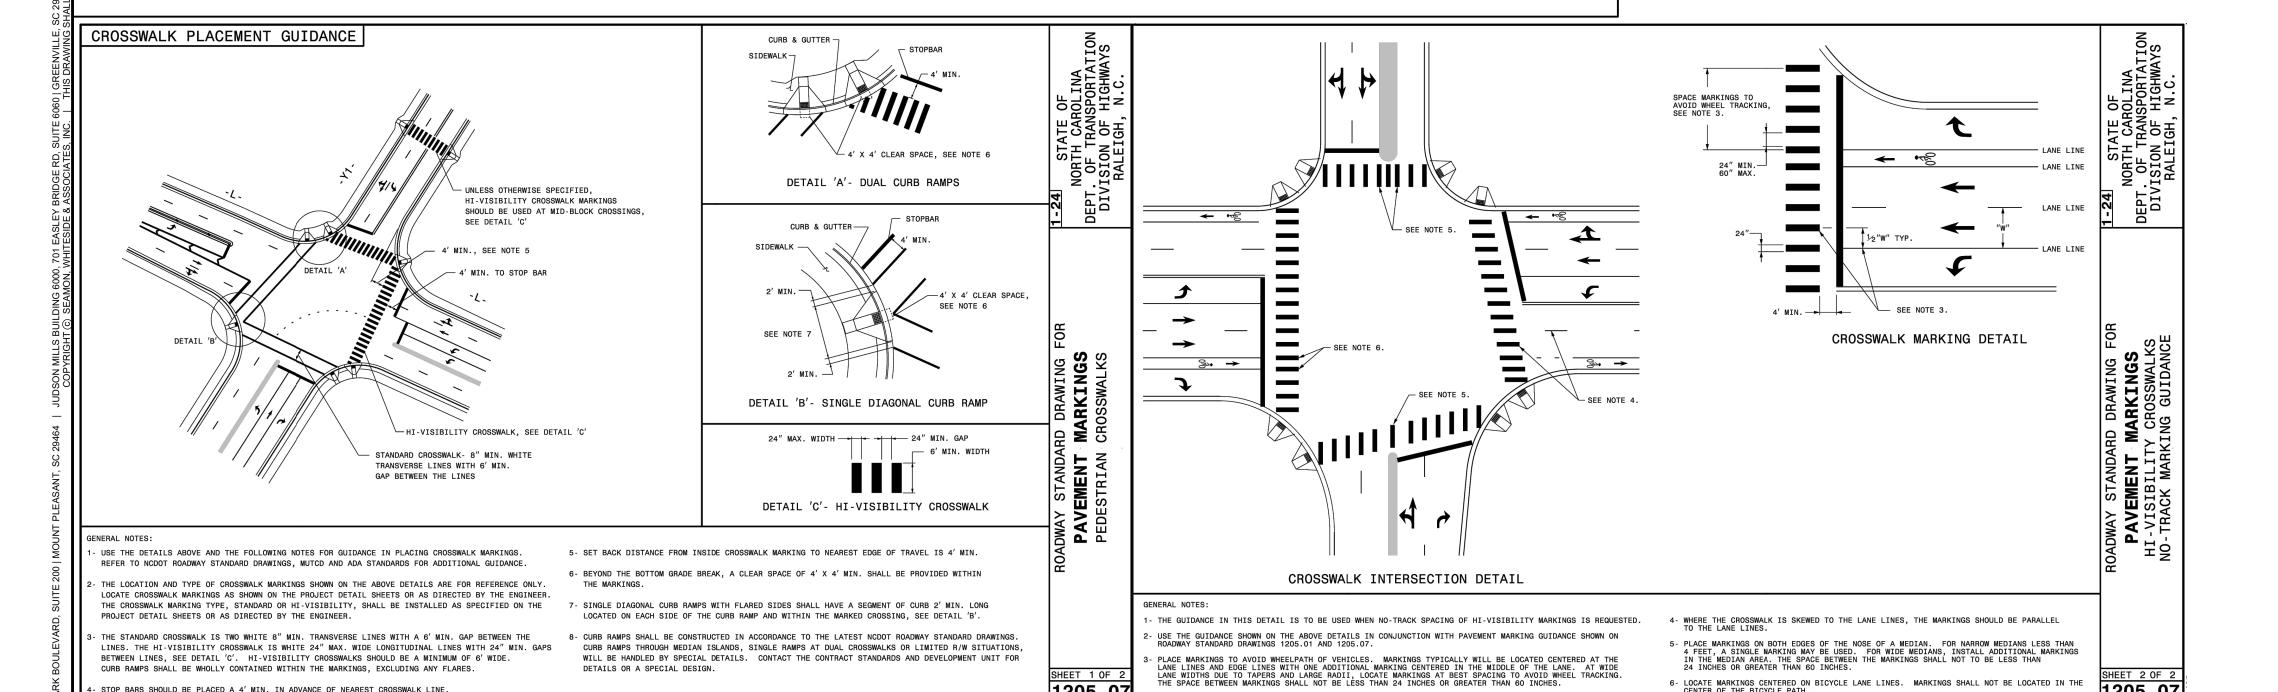

1205.07

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E 11/01/24

CONSTRUCTION **DETAILS**

PROJECT INFORMATION					
ENGINEERED PRODUCT MANAGER					
ADS SALES REP					
PROJECT NO.					





TWAS REV C ROLESVILLE, NC, USA

SC-310 STORMTECH CHAMBER SPECIFICATIONS

- CHAMBERS SHALL BE STORMTECH SC-310.
- 2. CHAMBERS SHALL BE ARCH-SHAPED AND SHALL BE MANUFACTURED FROM VIRGIN, IMPACT-MODIFIED POLYPROPYLENE OR POLYETHYLENE COPOLYMERS.
- CHAMBERS SHALL MEET THE REQUIREMENTS OF ASTM F2922 (POLETHYLENE) OR ASTM F2418 (POLYPROPYLENE), "STANDARD SPECIFICATION FOR CORRUGATED WALL STORMWATER COLLECTION CHAMBERS".
- 4. CHAMBER ROWS SHALL PROVIDE CONTINUOUS, UNOBSTRUCTED INTERNAL SPACE WITH NO INTERNAL SUPPORTS THAT WOULD IMPEDE FLOW OR LIMIT ACCESS FOR INSPECTION.
- 5. THE STRUCTURAL DESIGN OF THE CHAMBERS, THE STRUCTURAL BACKFILL, AND THE INSTALLATION REQUIREMENTS SHALL ENSURE THAT THE LOAD FACTORS SPECIFIED IN THE AASHTO LRFD BRIDGE DESIGN SPECIFICATIONS, SECTION 12.12, ARE MET FOR: 1) LONG-DURATION DEAD LOADS AND 2) SHORT-DURATION LIVE LOADS, BASED ON THE AASHTO DESIGN TRUCK WITH CONSIDERATION FOR IMPACT AND MULTIPLE VEHICLE PRESENCES.
- 6. CHAMBERS SHALL BE DESIGNED, TESTED AND ALLOWABLE LOAD CONFIGURATIONS DETERMINED IN ACCORDANCE WITH ASTM F2787, "STANDARD PRACTICE FOR STRUCTURAL DESIGN OF THERMOPLASTIC CORRUGATED WALL STORMWATER COLLECTION CHAMBERS". LOAD CONFIGURATIONS SHALL INCLUDE: 1) INSTANTANEOUS (<1 MIN) AASHTO DESIGN TRUCK LIVE LOAD ON MINIMUM COVER 2) MAXIMUM PERMANENT (75-YR) COVER LOAD AND 3) ALLOWABLE COVER WITH PARKED (1-WEEK). AASHTO DESIGN TRUCK.
- 7. REQUIREMENTS FOR HANDLING AND INSTALLATION:
 - TO MAINTAIN THE WIDTH OF CHAMBERS DURING SHIPPING AND HANDLING, CHAMBERS SHALL HAVE INTEGRAL, INTERLOCKING STACKING LUGS.
 - TO ENSURE A SECURE JOINT DURING INSTALLATION AND BACKFILL, THE HEIGHT OF THE CHAMBER JOINT SHALL NOT BE LESS THAN 2"
 - TO ENSURE THE INTEGRITY OF THE ARCH SHAPE DURING INSTALLATION, a) THE ARCH STIFFNESS CONSTANT SHALL BE GREATER THAN OR EQUAL TO 400 LBS/FT/%. THE ASC IS DEFINED IN SECTION 6.2.8 OF ASTM F2418. AND b) TO RESIST CHAMBER DEFORMATION DURING INSTALLATION AT ELEVATED TEMPERATURES (ABOVE 73° F / 23° C), CHAMBERS SHALL BE PRODUCED FROM REFLECTIVE GOLD OR YELLOW COLORS.
- 8. ONLY CHAMBERS THAT ARE APPROVED BY THE SITE DESIGN ENGINEER WILL BE ALLOWED. UPON REQUEST BY THE SITE DESIGN ENGINEER OR OWNER, THE CHAMBER MANUFACTURER SHALL SUBMIT A STRUCTURAL EVALUATION FOR APPROVAL BEFORE DELIVERING CHAMBERS TO THE PROJECT SITE AS FOLLOWS:
 - THE STRUCTURAL EVALUATION SHALL BE SEALED BY A REGISTERED PROFESSIONAL ENGINEER.
 - THE STRUCTURAL EVALUATION SHALL DEMONSTRATE THAT THE SAFETY FACTORS ARE GREATER THAN OR EQUAL TO 1.95 FOR DEAD LOAD AND 1.75 FOR LIVE LOAD, THE MINIMUM REQUIRED BY ASTM F2787 AND BY SECTIONS 3 AND 12.12 OF THE AASHTO LRFD BRIDGE DESIGN SPECIFICATIONS FOR THERMOPLASTIC PIPE.
 - THE TEST DERIVED CREEP MODULUS AS SPECIFIED IN ASTM F2922 SHALL BE USED FOR PERMANENT DEAD LOAD DESIGN EXCEPT THAT IT SHALL BE THE 75-YEAR MODULUS USED FOR DESIGN.
- 9. CHAMBERS AND END CAPS SHALL BE PRODUCED AT AN ISO 9001 CERTIFIED MANUFACTURING FACILITY.
- 10. MANIFOLD SIZE TO BE DETERMINED BY SITE DESIGN ENGINEER. SEE TECH NOTE #6.32 FOR MANIFOLD SIZING GUIDANCE. DUE TO THE ADAPTATION OF THIS CHAMBER SYSTEM TO SPECIFIC SITE AND DESIGN CONSTRAINTS, IT MAY BE NECESSARY TO CUT AND COUPLE ADDITIONAL PIPE TO STANDARD MANIFOLD COMPONENTS IN THE FIELD.
- 11. ADS DOES NOT DESIGN OR PROVIDE MEMBRANE LINER SYSTEMS. TO MINIMIZE THE LEAKAGE POTENTIAL OF LINER SYSTEMS, THE MEMBRANE LINER SYSTEM SHOULD BE DESIGNED BY A KNOWLEDGEABLE GEOTEXTILE PROFESSIONAL AND INSTALLED BY A QUALIFIED CONTRACTOR.

IMPORTANT - NOTES FOR THE BIDDING AND INSTALLATION OF THE SC-310 SYSTEM

- STORMTECH SC-310 CHAMBERS SHALL NOT BE INSTALLED UNTIL THE MANUFACTURER'S REPRESENTATIVE HAS COMPLETED A
 PRE-CONSTRUCTION MEETING WITH THE INSTALLERS.
- 2. STORMTECH SC-310 CHAMBERS SHALL BE INSTALLED IN ACCORDANCE WITH THE "STORMTECH SC-310/SC-740/DC-780 CONSTRUCTION GUIDE".
- CHAMBERS ARE NOT TO BE BACKFILLED WITH A DOZER OR AN EXCAVATOR SITUATED OVER THE CHAMBERS.
 STORMTECH RECOMMENDS 3 BACKFILL METHODS:
 - STONESHOOTER LOCATED OFF THE CHAMBER BED.
 - BACKFILL AS ROWS ARE BUILT USING AN EXCAVATOR ON THE FOUNDATION STONE OR SUBGRADE.
 - BACKFILL FROM OUTSIDE THE EXCAVATION USING A LONG BOOM HOE OR EXCAVATOR.
- 4. THE FOUNDATION STONE SHALL BE LEVELED AND COMPACTED PRIOR TO PLACING CHAMBERS.
- 5. JOINTS BETWEEN CHAMBERS SHALL BE PROPERLY SEATED PRIOR TO PLACING STONE.
- MAINTAIN MINIMUM 6" (150 mm) SPACING BETWEEN THE CHAMBER ROWS.
- 7. EMBEDMENT STONE SURROUNDING CHAMBERS MUST BE A CLEAN, CRUSHED, ANGULAR STONE 3/4-2" (20-50 mm).
- 3. THE CONTRACTOR MUST REPORT ANY DISCREPANCIES WITH CHAMBER FOUNDATION MATERIALS BEARING CAPACITIES TO THE SITE DESIGN ENGINEER.
-). ADS RECOMMENDS THE USE OF "FLEXSTORM CATCH IT" INSERTS DURING CONSTRUCTION FOR ALL INLETS TO PROTECT THE SUBSURFACE STORMWATER MANAGEMENT SYSTEM FROM CONSTRUCTION SITE RUNOFF.


NOTES FOR CONSTRUCTION EQUIPMENT

- . STORMTECH SC-310 CHAMBERS SHALL BE INSTALLED IN ACCORDANCE WITH THE "STORMTECH SC-310/SC-740/DC-780 CONSTRUCTION GUIDE".
- 2. THE USE OF CONSTRUCTION EQUIPMENT OVER SC-310 & SC-740 CHAMBERS IS LIMITED:
 - NO EQUIPMENT IS ALLOWED ON BARE CHAMBERS.
 - NO RUBBER TIRED LOADERS, DUMP TRUCKS, OR EXCAVATORS ARE ALLOWED UNTIL PROPER FILL DEPTHS ARE REACHED IN ACCORDANCE WITH THE "STORMTECH SC-310/SC-740/DC-780 CONSTRUCTION GUIDE".
 - WEIGHT LIMITS FOR CONSTRUCTION EQUIPMENT CAN BE FOUND IN THE "STORMTECH SC-310/SC-740/DC-780 CONSTRUCTION GUIDE"
- 3. FULL 36" (900 mm) OF STABILIZED COVER MATERIALS OVER THE CHAMBERS IS REQUIRED FOR DUMP TRUCK TRAVEL OR DUMPING.

USE OF A DOZER TO PUSH EMBEDMENT STONE BETWEEN THE ROWS OF CHAMBERS MAY CAUSE DAMAGE TO THE CHAMBERS AND IS NOT AN ACCEPTABLE BACKFILL METHOD. ANY CHAMBERS DAMAGED BY THE "DUMP AND PUSH" METHOD ARE NOT COVERED UNDER THE STORMTECH STANDARD WARRANTY.

CONTACT STORMTECH AT 1-800-821-6710 WITH ANY QUESTIONS ON INSTALLATION REQUIREMENTS OR WEIGHT LIMITS FOR CONSTRUCTION EQUIPMENT.

	PROPOSED LAYOUT	PROPOSED ELEVATIONS:					T ABOVE BAS	E OF CHAMBER	
146	STORMTECH SC-310 CHAMBERS	MAXIMUM ALLOWABLE GRADE (TOP OF PAVEMENT/UNPAVED):	401.83 403.08	PART TYPE	LAYOU		INVERT*	MAX FLOW	
6	STORMTECH SC-310 END CAPS STONE ABOVE (in)	MINIMUM ALLOWABLE GRADE (UNPAVED WITH TRAFFIC): MINIMUM ALLOWABLE GRADE (UNPAVED NO TRAFFIC):	395.83 397.00 395.33 396.50	PREFABRICATED EZ END CAP		12" BOTTOM PREFABRICATED EZ END CAP, PART#: SC310ECEZ / TYP OF ALL 12" BOTTOM CONNECTIONS AND ISOLATOR PLUS ROWS	0.90"		
	STONE BELOW (in) STONE VOID	MINIMUM ALLOWABLE GRADE (TOP OF RIGID CONCRETE PAVEMENT): MINIMUM ALLOWABLE GRADE (BASE OF FLEXIBLE PAVEMENT):	395.33 396.58 395.33 396.58	FLAMP	В	INSTALL FLAMP ON 12" ACCESS PIPE / PART#: SC31012RAMP (TYP 2 PLACES)			1 .
	INSTALLED SYSTEM VOLUME (CF) (PERIMETER STONE INCLUDED)	TOP OF STONE:	204 22 205 50	MANIFOLD MANIFOLD		8" x 8" BOTTOM MANIFOLD, MOLDED FITTINGS 8" x 8" BOTTOM MANIFOLD, MOLDED FITTINGS	0.60" 0.60"		
5090	,	TOP OF SC-310 CHAMBER: 8" x 8" BOTTOM MANIFOLD INVERT:	302 55 202 00	AIPIPE CONNECTION	E	8" BOTTOM CONNECTION	0.60"		ַ [
4068	(BASE STONE INCLUDED) SYSTEM AREA (SF)	12" ISOLATOR ROW PLUS INVERT: 12" ISOLATOR ROW PLUS INVERT:	392.58 393.83 392.58 393.83	CONCRETE STRUCTURE	F	(DESIGN BY ENGINEER / PROVIDED BY OTHERS)		4.5 CFS IN	2
	(/	8" x 8" BOTTOM MANIFOLD INVERT:	392.55 393.80	CONCRETE STRUCTURE	G	(DESIGN BY ENGINEER / PROVIDED BY OTHERS)		4.5 CFS IN	<
		8" BOTTOM CONNECTION INVERT: 12" x 8" BOTTOM MANIFOLD INVERT (8" PIPE):	392.55 393.80 392.55 393.80	NYLOPLAST (OUTLET)	Н	30" DIAMETER (DESIGN BY ENGINEER)		1.4 CFS OUT	}
		BOTTOM OF SC-310 CHAMBER: 12" x 8" BOTTOM MANIFOLD INVERT (12" PIPE):	392.50 393.7 5	UNDERDRAIN	i	4" ADS N-12 DUAL WALL PERFORATED HDPE UNDERDRAIN		0. 0 001]
		UNDERDRAIN INVERT:	392.20 393.45 392.00 393.25						
		BOTTOM OF STONE:	392.00 393.25						

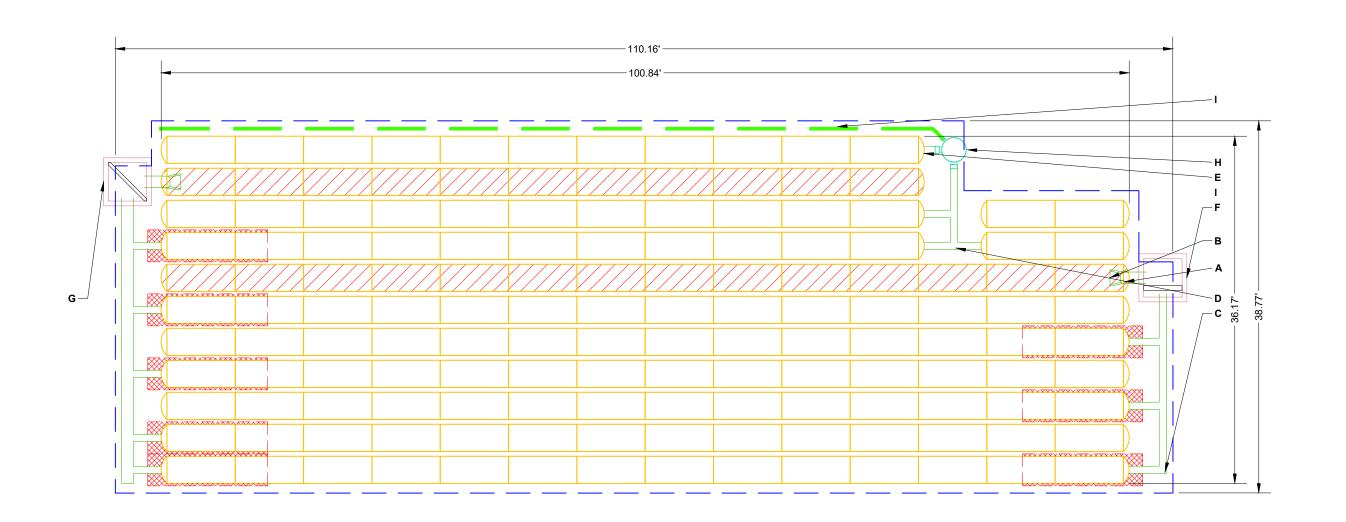

ISOLATOR ROW PLUS (SEE DETAIL)

PLACE MINIMUM 12.50' OF ADSPLUS625 WOVEN GEOTEXTILE OVER BEDDING STONE AND UNDERNEATH CHAMBER FEET FOR SCOUR PROTECTION AT ALL CHAMBER INLET ROWS

---- BED LIMITS

NOTES

THE SITE DESIGN ENGINEER MUST REVIEW ELEVATIONS AND IF NECESSARY ADJUST GRADING TO ENSURE THE CHAMBER COVER REQUIREMENTS ARE MET.

NOT FOR CONSTRUCTION: THIS LAYOUT IS FOR DIMENSIONAL PURPOSES ONLY TO PROVE CONCEPT & THE REQUIRED STORAGE VOLUME CAN BE ACHIEVED ON SITE.

ROLESVILLE, NC, USA

/2024 DRAWN: KH

CHECKED: N/A

TINTENDED FOR USE IN BIDDING OR CONST

CATED DETAILS MEET ALL APPLICABLE

DATE: 08/22/2024 PROJECT #:

DRW R OF RECO

StormTechChamber System

4640 TRUEMAN BLVD HILLIARD, OH 43026 1-800-733-7473

SHEET


2 OF 6

ACCEPTABLE FILL MATERIALS: STORMTECH SC-310 CHAMBER SYSTEMS

	MATERIAL LOCATION	DESCRIPTION	AASHTO MATERIAL CLASSIFICATIONS	COMPACTION / DENSITY REQUIREMENT
D	FINAL FILL: FILL MATERIAL FOR LAYER 'D' STARTS FROM THE TOP OF THE 'C' LAYER TO THE BOTTOM OF FLEXIBLE PAVEMENT OR UNPAVED FINISHED GRADE ABOVE. NOTE THAT PAVEMENT SUBBASE MAY BE PART OF THE 'D' LAYER.	ANY SOIL/ROCK MATERIALS, NATIVE SOILS, OR PER ENGINEER'S PLANS. CHECK PLANS FOR PAVEMENT SUBGRADE REQUIREMENTS.	N/A	PREPARE PER SITE DESIGN ENGINEER'S PLANS. PAVED INSTALLATIONS MAY HAVE STRINGENT MATERIAL AND PREPARATION REQUIREMENTS.
С	INITIAL FILL: FILL MATERIAL FOR LAYER 'C' STARTS FROM THE TOP OF THE EMBEDMENT STONE ('B' LAYER) TO 18" (450 mm) ABOVE THE TOP OF THE CHAMBER. NOTE THAT PAVEMENT SUBBASE MAY BE A PART OF THE 'C' LAYER.	GRANULAR WELL-GRADED SOIL/AGGREGATE MIXTURES, <35% FINES OR PROCESSED AGGREGATE. MOST PAVEMENT SUBBASE MATERIALS CAN BE USED IN LIEU OF THIS LAYER.	AASHTO M145 ¹ A-1, A-2-4, A-3 OR AASHTO M43 ¹ 3, 357, 4, 467, 5, 56, 57, 6, 67, 68, 7, 78, 8, 89, 9, 10	BEGIN COMPACTIONS AFTER 12" (300 mm) OF MATERIAL OVER THE CHAMBERS IS REACHED. COMPACT ADDITIONAL LAYERS IN 6" (150 mm) MAX LIFTS TO A MIN. 95% PROCTOR DENSITY FOR WELL GRADED MATERIAL AND 95% RELATIVE DENSITY FOR PROCESSED AGGREGATE MATERIALS. ROLLER GROSS VEHICLE WEIGHT NOT TO EXCEED 12,000 lbs (53 kN). DYNAMIC FORCE NOT TO EXCEED 20,000 lbs (89 kN).
В	EMBEDMENT STONE: FILL SURROUNDING THE CHAMBERS FROM THE FOUNDATION STONE ('A' LAYER) TO THE 'C' LAYER ABOVE.	CLEAN, CRUSHED, ANGULAR STONE OR RECYCLED CONCRETE5	AASHTO M43¹ 3, 357, 4, 467, 5, 56, 57	NO COMPACTION REQUIRED.
А	FOUNDATION STONE: FILL BELOW CHAMBERS FROM THE SUBGRADE UP TO THE FOOT (BOTTOM) OF THE CHAMBER.	CLEAN, CRUSHED, ANGULAR STONE OR RECYCLED CONCRETE5	AASHTO M43¹ 3, 357, 4, 467, 5, 56, 57	PLATE COMPACT OR ROLL TO ACHIEVE A FLAT SURFACE. ^{2,3}

PLEASE NOTE:


- 1. THE LISTED AASHTO DESIGNATIONS ARE FOR GRADATIONS ONLY. THE STONE MUST ALSO BE CLEAN, CRUSHED, ANGULAR. FOR EXAMPLE, A SPECIFICATION FOR #4 STONE WOULD STATE: "CLEAN, CRUSHED, ANGULAR NO. 4 (AASHTO M43) STONE".
- 2. STORMTECH COMPACTION REQUIREMENTS ARE MET FOR 'A' LOCATION MATERIALS WHEN PLACED AND COMPACTED IN 6" (150 mm) (MAX) LIFTS USING TWO FULL COVERAGES WITH A VIBRATORY COMPACTOR.
- 3. WHERE INFILTRATION SURFACES MAY BE COMPROMISED BY COMPACTION, FOR STANDARD DESIGN LOAD CONDITIONS, A FLAT SURFACE MAY BE ACHIEVED BY RAKING OR DRAGGING WITHOUT COMPACTION EQUIPMENT. FOR SPECIAL LOAD DESIGNS, CONTACT STORMTECH FOR COMPACTION REQUIREMENTS
- 4. ONCE LAYER 'C' IS PLACED, ANY SOIL/MATERIAL CAN BE PLACED IN LAYER 'D' UP TO THE FINISHED GRADE. MOST PAVEMENT SUBBASE SOILS CAN BE USED TO REPLACE THE MATERIAL REQUIREMENTS OF LAYER 'C' OR 'D' AT THE SITE DESIGN ENGINEER'S DISCRETION.
- 5. WHERE RECYCLED CONCRETE AGGREGATE IS USED IN LAYERS 'A' OR 'B' THE MATERIAL SHOULD ALSO MEET THE ACCEPTABILITY CRITERIA OUTLINED IN TECHNICAL NOTE 6.20 "RECYCLED CONCRETE STRUCTURAL BACKFILL".

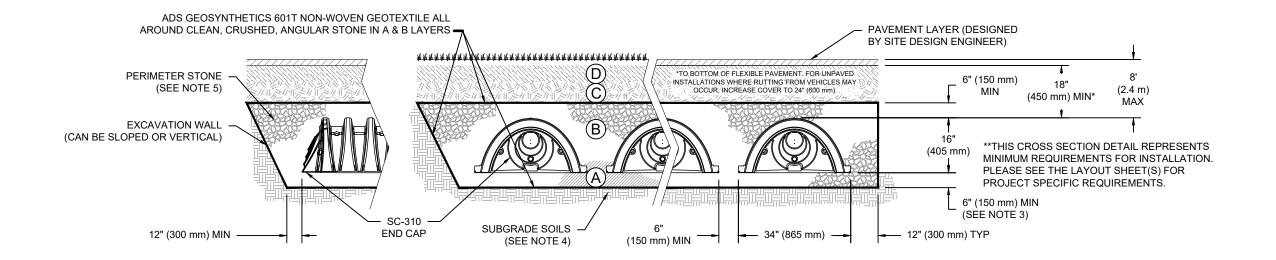

NOTES:

- 1. CHAMBERS SHALL MEET THE REQUIREMENTS OF ASTM F2922 (POLETHYLENE) OR ASTM F2418 (POLYPROPYLENE), "STANDARD SPECIFICATION FOR CORRUGATED WALL STORMWATER COLLECTION CHAMBERS"
- 2. SC-310 CHAMBERS SHALL BE DESIGNED IN ACCORDANCE WITH ASTM F2787 "STANDARD PRACTICE FOR STRUCTURAL DESIGN OF THERMOPLASTIC CORRUGATED WALL STORMWATER COLLECTION CHAMBERS"
- 3. THE SITE DESIGN ENGINEER IS RESPONSIBLE FOR ASSESSING THE BEARING RESISTANCE (ALLOWABLE BEARING CAPACITY) OF THE SUBGRADE SOILS AND THE DEPTH OF FOUNDATION STONE WITH CONSIDERATION FOR THE RANGE OF EXPECTED SOIL MOISTURE CONDITIONS. REFERENCE STORMTECH DESIGN MANUAL FOR BEARING CAPACITY GUIDANCE.
- 4. PERIMETER STONE MUST BE EXTENDED HORIZONTALLY TO THE EXCAVATION WALL FOR BOTH VERTICAL AND SLOPED EXCAVATION WALLS.
- 5. REQUIREMENTS FOR HANDLING AND INSTALLATION:
 - TO MAINTAIN THE WIDTH OF CHAMBERS DURING SHIPPING AND HANDLING, CHAMBERS SHALL HAVE INTEGRAL, INTERLOCKING STACKING LUGS.
 - TO ENSURE A SECURE JOINT DURING INSTALLATION AND BACKFILL, THE HEIGHT OF THE CHAMBER JOINT SHALL NOT BE LESS THAN 2".
 - TO ENSURE THE INTEGRITY OF THE ARCH SHAPE DURING INSTALLATION, a) THE ARCH STIFFNESS CONSTANT SHALL BE GREATER THAN OR EQUAL TO 400 LBS/FT/%. THE ASC IS DEFINED IN SECTION 6.2.8 OF ASTM F2418. AND b) TO RESIST CHAMBER DEFORMATION DURING INSTALLATION AT ELEVATED TEMPERATURES (ABOVE 73° F / 23° C), CHAMBERS SHALL BE PRODUCED FROM REFLECTIVE GOLD OR YELLOW COLORS.



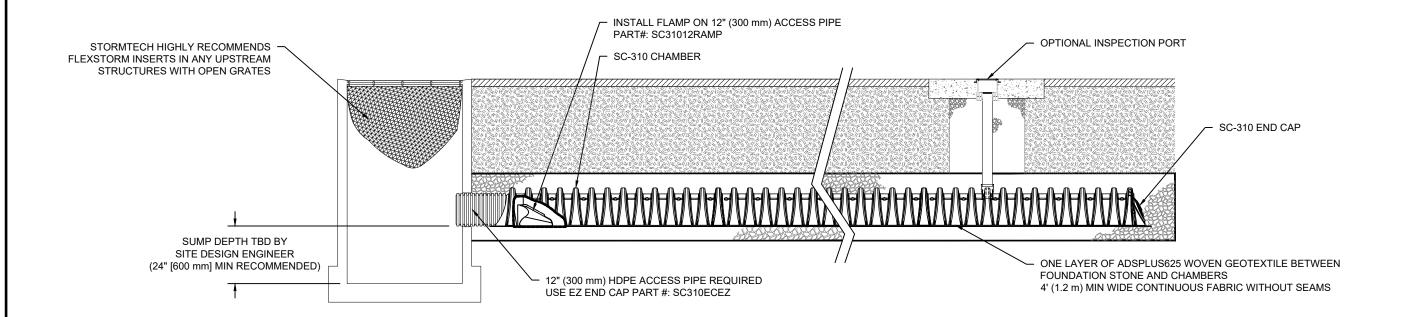

SC-310 ISOLATOR ROW PLUS DETAIL

INSPECTION & MAINTENANCE

INSPECT ISOLATOR ROW PLUS FOR SEDIMENT

A. INSPECTION PORTS (IF PRESENT)

- REMOVE/OPEN LID ON NYLOPLAST INLINE DRAIN
- REMOVE AND CLEAN FLEXSTORM FILTER IF INSTALLED
- USING A FLASHLIGHT AND STADIA ROD, MEASURE DEPTH OF SEDIMENT AND RECORD ON MAINTENANCE LOG LOWER A CAMERA INTO ISOLATOR ROW PLUS FOR VISUAL INSPECTION OF SEDIMENT LEVELS (OPTIONAL)
- IF SEDIMENT IS AT, OR ABOVE, 3" (80 mm) PROCEED TO STEP 2. IF NOT, PROCEED TO STEP 3.


B. ALL ISOLATOR PLUS ROWS

- REMOVE COVER FROM STRUCTURE AT UPSTREAM END OF ISOLATOR ROW PLUS
- USING A FLASHLIGHT, INSPECT DOWN THE ISOLATOR ROW PLUS THROUGH OUTLET PIPE
 - i) MIRRORS ON POLES OR CAMERAS MAY BE USED TO AVOID A CONFINED SPACE ENTRY
 - ii) FOLLOW OSHA REGULATIONS FOR CONFINED SPACE ENTRY IF ENTERING MANHOLE IF SEDIMENT IS AT, OR ABOVE, 3" (80 mm) PROCEED TO STEP 2. IF NOT, PROCEED TO STEP 3.
- CLEAN OUT ISOLATOR ROW PLUS USING THE JETVAC PROCESS
 - A. A FIXED CULVERT CLEANING NOZZLE WITH REAR FACING SPREAD OF 45" (1.1 m) OR MORE IS PREFERRED
 - APPLY MULTIPLE PASSES OF JETVAC UNTIL BACKFLUSH WATER IS CLEAN
 - C. VACUUM STRUCTURE SUMP AS REQUIRED
- REPLACE ALL COVERS, GRATES, FILTERS, AND LIDS; RECORD OBSERVATIONS AND ACTIONS.
- STEP 4) INSPECT AND CLEAN BASINS AND MANHOLES UPSTREAM OF THE STORMTECH SYSTEM.


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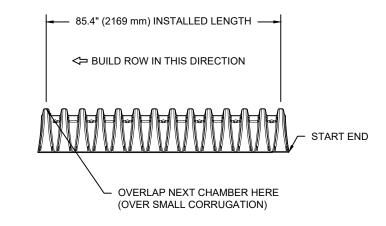
- INSPECT EVERY 6 MONTHS DURING THE FIRST YEAR OF OPERATION. ADJUST THE INSPECTION INTERVAL BASED ON PREVIOUS OBSERVATIONS OF SEDIMENT ACCUMULATION AND HIGH WATER ELEVATIONS.
- 2. CONDUCT JETTING AND VACTORING ANNUALLY OR WHEN INSPECTION SHOWS THAT MAINTENANCE IS NECESSARY.


ROLESVILLE, NC, USA 2024 DRAWN: KH CHECKED: N \circ TWAS REV **StormTech**® Chamber System 4640 TRUEMAN BLVD HILLIARD, OH 43026 1-800-733-7473 SHEET 4 OF 6

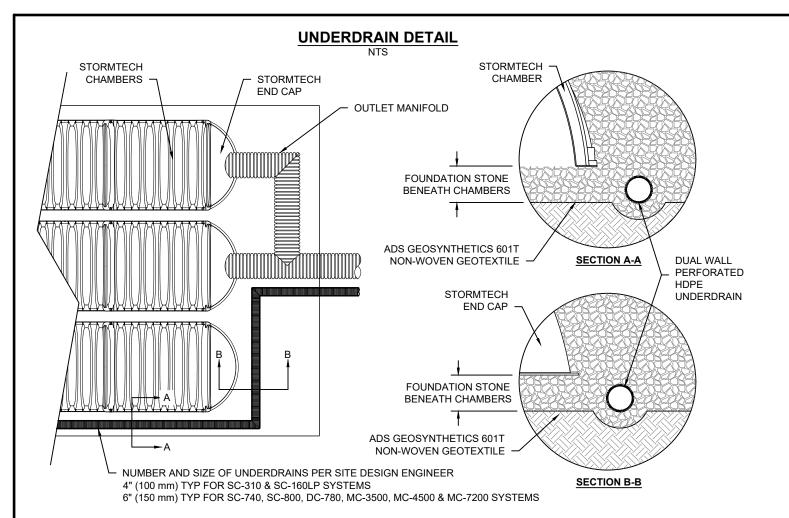



SC-310 TECHNICAL SPECIFICATION



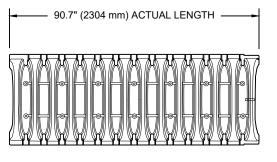

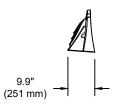

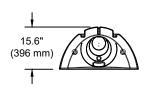

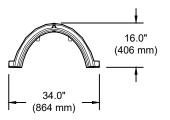



NOMINAL CHAMBER SPECIFICATIONS SIZE (W X H X INSTALLED LENGTH) CHAMBER STORAGE MINIMUM INSTALLED STORAGE* WEIGHT

34.0" X 16.0" X 85.4" 14.7 CUBIC FEET 31.0 CUBIC FEET 35.0 lbs.

(864 mm X 406 mm X 2169 mm) (0.42 m³) (0.88 m³) (16.8 kg)

*ASSUMES 6" (152 mm) ABOVE, BELOW, AND BETWEEN CHAMBERS

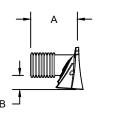

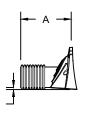

PRE-FAB STUB AT BOTTOM OF END CAP WITH FLAMP END WITH "BR" PRE-FAB STUBS AT BOTTOM OF END CAP FOR PART NUMBERS ENDING WITH "B" PRE-FAB STUBS AT TOP OF END CAP FOR PART NUMBERS ENDING WITH "T" PRE CORED END CAPS END WITH "PC"

PART#	STUB	Α	В	С
SC310EPE06T / SC310EPE06TPC	6" (150 mm)	9.6" (244 mm)	5.8" (147 mm)	
SC310EPE06B / SC310EPE06BPC	0 (130 11111)	9.0 (244 11111)		0.5" (13 mm)
SC310EPE08T / SC310EPE08TPC	8" (200 mm) 11.9" (302 mm)		3.5" (89 mm)	
SC310EPE08B / SC310EPE08BPC	0 (200 111111)	11.9 (302 11111)		0.6" (15 mm)
SC310EPE10T / SC310EPE10TPC	10" (250 mm)	12.7" (323 mm)	1.4" (36 mm)	
SC310EPE10B / SC310EPE10BPC	10 (230 11111)	12.7 (323 11111)		0.7" (18 mm)
SC310ECEZ*	12" (300 mm)	13.5" (343 mm)		0.9" (23 mm)

ALL STUBS, EXCEPT FOR THE SC310ECEZ ARE PLACED AT BOTTOM OF END CAP SUCH THAT THE OUTSIDE DIAMETER OF THE STUB IS FLUSH WITH THE BOTTOM OF THE END CAP. FOR ADDITIONAL INFORMATION CONTACT STORMTECH AT

* FOR THE SC310ECEZ THE 12" (300 mm) STUB LIES BELOW THE BOTTOM OF THE END CAP APPROXIMATELY 0.25" (6 mm). BACKFILL MATERIAL SHOULD BE REMOVED FROM BELOW THE N-12 STUB SO THAT THE FITTING SITS LEVEL.

NOTE: ALL DIMENSIONS ARE NOMINAL

TWAS REV C		ROLESVILLE, NC, USA	DATE: 08/22/2024		PROJECT #: CHECKED: N/A	IE PROJECT'S ENGINEER OF RECORD ("EOR") OR OTHER PROJECT REPRESENTATIVE. THIS DRAWING IS NOT INTENDED FOR USE IN BIDDING OR CONST THE ULTIMATE RESPONSIBILITY OF THE EOR TO ENSURE THAT THE PRODUCT(S) DEPICTED AND ALL ASSOCIATED DETAILS MEET ALL APPLICABLE
					DESCRIPTION	DR") OR OTHER PROJECT REPRESENTATIVE. TH FOR TO ENSURE THAT THE PRODUCT(S) DEPICT
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					DATE DRW CHK	T'S ENGINEEF ATE RESPON
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StormTech® Chamber System

4640 TRUEMAN BLVD HILLIARD, OH 43026 1-800-733-7473



SHEET

5 OF 6

TIDAL WAVE LANDSCAPE NOTES

- ALL DISTURBED AREAS NOT COVERED BY STRUCTURES, PAVING OR LANDSCAPING SHALL BE SODDED. NO SEEDING SHALL BE USED.
- 2. ALL PLANT BEDS SHALL BE UNDERLAIN WITH LANDSCAPING FABRIC AND HAVE 3" OF DYED BROWN OR BLACK WOOD MULCH WITH EDGING AS REQUIRED. NO PINE STRAW MULCH WILL BE ALLOWED.
- 3. ALL RIVER ROCK SHALL BE 4"-6" MINIMUM IN DIAMETER AND SHALL BE UNDERLAIN WITH LANDSCAPING FABRIC.
- AN UNDERGROUND IRRIGATION SYSTEM, SHALL BE INSTALLED AND SHALL COMPLY WITH ALL LOCAL MUNICIPAL CODES AND REGULATIONS AND ALSO COMPLY WITH THE LATEST NATIONAL ELECTRIC CODE RULES FOR ALL ELECTRIC WORKS AND MATERIALS.
- 5. IF THERE IS NO PLANT BED AGAINST THE CAR WASH TUNNEL, VAC HOUSE(S), OR DUMPSTER ENCLOSURE, THEN THERE SHALL BE A 18 INCH MINIMUM STRIP OF RIVER ROCK INSTALLED.

GENERAL NOTES:

- 1. SEE EROSION CONTROL PLANS PLANS [SHEETS C4.1 C4.3] FOR SILT FENCE LOCATIONS, TREE PROTECTION ZONES AND BARRICADES, AND ADDITIONAL NOTES AND DETAILS.
- 2. FOR TREE REMOVALS, PLEASE REFER TO SHEETS C3.1.
- 3. FOR REQUIRED TREE MITIGATION AND DEVELOPMENT INCHES PER THE TOWN OF ROLESVILLE LAND DEVELOPMENT ORDINANCE (LDO), PLEASE REFER TO SHEET L1.1 FOR PLANT SCHEDULE QUANTITY AND
- 4. THE OVERALL PLANT QUANTITY FOR THE ENTIRE SITE CAN BE FOUND ON THE MASTER PLAN SCHEDULE,
- 5. SEE SITE PLAN [C5.1] FOR SITE LABELS, INFORMATION AND DETAILS.
- 6. CONTRACTOR TO CONTACT CIVIL ENGINEER OR LANDSCAPE ARCHITECT REGARDING ANY SITE WORK MODIFICATIONS FROM THESE PLANS PRIOR TO CHANGES IN THE FIELD. **CONTACT:** 980-312-5450
- 7. OWNER OR GRANTEE SHALL BE RESPONSIBLE FOR TREE REPLACEMENT TO ANY TREES THAT ARE DAMAGED OR DIE DURING CONSTRUCTION.

OPEN SPACE

- SITE AREA = 83,635 SF OPEN SPACE REQUIREMENTS = 5% OF TOTAL SITE AREA OPEN SPACE REQUIRED = 4,182 SF
- OPEN SPACE PROVIDED = 4,182 SF + ACTIVE OPEN SPACE = 2,091 SF OF PLAZA / SEATING AREA + PASSIVE OPEN SPACE = 2,091 SF OF LAWN / NATURAL AREA

US HWY 401 / LOUISBURG ROAD (317 LF)						
	STREET BUFFER	PLANTINGS REQUIRED	PLANTINGS PROVIDED			
MINIMUM BUFFER WIDTH	30' MIN.					
CANOPY TREE	1 TREE PER 40 LF	1	1			
UNDERSTORY TREE*	2 TREES PER 40 LF	14	14			

*UNDERSTORY TREES SHALL BE USED WHERE OVERHEAD UTILITIES CONFLICTS WITH STREET BUFFER


PLANT SCHE	DULE HWY	401 BU	FFER					
SYMBOL	CODE	QTY	BOTANICAL / COMMON NAME	SIZE	HEIGHT	SPREAD	SPACING	REMARKS
UNDERSTOR	RY TREES							
+	CERO	2	CERCIS CANADENSIS 'OKLAHOMA' / OKLAHOMA REDBUD	1.5" CAL	8` MIN	8`	AS SHOWN	FWF, SP
Section of the sectio	CHIV	7	CHIONANTHUS VIRGINICUS / WHITE FRINGETREE	1.5" CAL	8` MIN	8`	AS SHOWN	FWF, SP
	MAGS	5	MAGNOLIA X SOULANGIANA / SAUCER MAGNOLIA	1.5" CAL	8, WIN	8,	AS SHOWN	MS, FWF, SP


GRAND PARK DRIVE (275 LF)						
	STREET BUFFER	PLANTINGS REQUIRED	PLANTINGS PROVIDED			
MINIMUM BUFFER WIDTH	10' MIN.					
CANOPY TREE	1 TREE PER 60 LF	5	5 (4 PROPOSED TREES 1 EX. TREE TO REMAIN*)			

*(1) 10" CRAPE MYRTLE (LAGEROSTROEMIA INDICA)

SYMBOL	CODE	QTY	BOTANICAL / COMMON NAME	SIZE	HEIGHT	SPREAD	SPACING
TREES	1	1		1	T	1	i
				1			

SYMBOL	CODE	QTY	BOTANICAL / COMMON NAME
TREES	_	_	
(o	ACRO	3	ACER RUBRUM 'OCTOBER GLORY' TM / OCTOBER GLORY MAPLE
	ILEO	2	ILEX OPACA / AMERICAN HOLLY
\bigcirc	QUEP	7	QUERCUS PALUSTRIS / PIN OAK
UNDERSTO	ORY TREES	- !	•
	АСРВ	5	ACER PALMATUM `BLOODGOOD` / BLOODGOOD JAPANESE MAPLE
+	CERO	2	CERCIS CANADENSIS 'OKLAHOMA' / OKLAHOMA REDBUD
Section of the sectio	CHIV	7	CHIONANTHUS VIRGINICUS / WHITE FRINGETREE
SHRUBS			
•	ABES	21	ABELIA X GRANDIFLORA `SHERWOODII` / DWARF ABELIA
$\langle \cdot \rangle$	AZAF	10	AZALEA INDICA 'FORMOSA' / FORMOSA AZALEA
) 	ILCB	21	ILEX CORNUTA 'BURFORDII NANA' / DWARF BURFORD HOLLY
(+)	LCRR	29	LOROPETALUM CHINENSE RUBRUM 'RUBY' / DWARF RUBY FRINGE FLOWE
	PODM	10	PODOCARPUS MACROPHYLLUS / SOUTHERN YEW
GRASSES	•	•	•
(+)	MUHL	16	MUHLENBERGIA FILIPES / SWEETGRASS
	PANV	11	PANICUM VIRGATUM 'HEAVY METAL' / HEAVY METAL SWITCH GRASS
GROUND C	COVERS		
XXXXXXXXXXXXXXXXXXXXXXXXXXXXXXXXXXXXXXX	LMBB	207	LIRIOPE MUSCARI 'BIG BLUE' / BIG BLUE LILYTURF

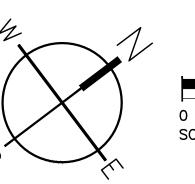

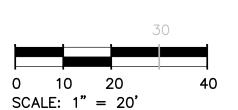






MOUNT PLEASANT, SC 843.884.1667 GREENVILLE, SC 864.298.0534 SUMMERVILLE, SC 843.972.0710 SPARTANBURG, SC 864.272.1272 CHARLOTTE, NC 980.312.5450 WWW.SEAMONWHITESIDE.COM



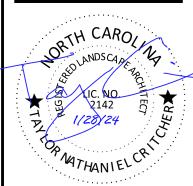

SW+ PROJECT: 10772 DATE: 1/28/24 DRAWN BY: CPE CHECKED BY:

REVISION HISTORY A 12/22/23 F 11/06/24 B 03/01/24 G 12/20/24

C 09/04/24 H 1/03/25

D 10/01/24

E 11/01/24 LANDSCAPE

PLAN

SHOWN ON THE PLANT LIST. TRUNKS SHALL BE UNDAMAGED AND SHAPE SHALL BE TYPICAL OF THE SPECIES.

17. ALL PLANT BEDS TO BE MULCHED WITH 4" OF DOUBLE SHREDDED HARDWOOD MULCH UNLESS OTHERWISE SPECIFIED. 18. ALL AREAS OF PLANTING, INCLUDING AREAS OF GRASS SEEDING AND SOD, SHALL BE GRADED TO PROVIDE POSITIVE

20. ALL DISTURBED AREAS NOT SPECIFICALLY CALLED OUT ON THIS PLAN SHALL BE SEEDED PER THE PROVIDED SEEDING

PROJECT AND SHALL MAINTAIN THE SITE IN A REASONABLY NEAT AND CLEAN STATE THROUGHOUT THE INSTALLATION

PROCESS. STREETS AND PAVED AREAS SHALL BE CLEANED REGULARLY TO REMOVE CONSTRUCTION MATERIALS AND

WITH THE LANDSCAPE ARCHITECT ON REASON FOR PLANT DECLINE/DEATH AND HOW TO AVOID FUTURE INSTANCES.

THE FUNDS OF THE RETAINAGE TO HAVE THE REPLACEMENTS MADE IN ACCORDANCE WITH THE SPECIFICATIONS BY

FOR EACH UNAMENDED SOIL TYPE, FURNISH SOIL ANALYSIS AND A WRITTEN REPORT BY A QUALIFIED SOIL-TESTING

AND FERTILIZERS IN THE QUANTITIES RECOMMENDED IN THE SOIL ANALYSIS REPORT TO PRODUCE SATISFACTORY

IN ALL PLANTING AREAS, SPREAD PLANTING SOIL TO A DEPTH OF 8 INCHES BUT NOT LESS THAN REQUIRED TO MEET

PLANTING SOIL FOR HEALTHY, VIABLE PLANTS. PLANTING SOILS SHALL HAVE A PH LEVEL BETWEEN 6.0 AND 7.0.

LANDSCAPE CONTRACTOR SHALL PROVIDE SHOP DRAWINGS OF PROPOSED IRRIGATION SYSTEM TO LANDSCAPE

ARCHITECT AND OWNER FOR ACCEPTANCE, LANDSCAPE CONTRACTOR TO SUPPLY AUTOMATIC IRRIGATION SYSTEMS.

PROVIDE 100% HEAD TO HEAD COVERAGE OF ALL NEW SODDED AND IMPROVED EXISTING GRASS AREAS, TREES, SHRUBS

LANDSCAPE CONTRACTOR SHALL OBTAIN ALL NECESSARY PERMITS FOR AUTOMATIC IRRIGATION SYSTEMS. LANDSCAPE CONTRACTOR SHALL PROVIDE ELECTRIC METER, BACKFLOW PREVENTER AND SERVICE IN ACCORDANCE WITH STATE AND

LOCAL CODES FOR IRRIGATION SYSTEM. LOCATION OF METERS AND CONTROL PANELS FOR IRRIGATION SHALL BE APPROVED BY OWNER'S REPRESENTATIVE PRIOR TO INSTALLATION. COORDINATE WATER METER REQUIREMENTS WITH

LANDSCAPE CONTRACTOR TO PROVIDE DRIP IRRIGATION TO ALL ABOVE GROUND PLANTERS. IRRIGATION LINE TO BE

FOR GRAPHIC CLARITY. ALL VALVE BOXES AND EQUIPMENT VAULTS SHALL BE LOCATED IN MULCH BEDS. NO IRRIGATION COMPONENTS, INCLUDING BUT NOT LIMITED TO, VALVE BOXES, CONTROL BOXES, BACKFLOW PREVENTERS, AND/OR RAIN SENSORS ARE ALLOWED TO BE INSTALLED WITHIN DEPARTMENT OF TRANSPORTATION

THERE WILL BE NO SUBSTITUTIONS, DELETIONS OR ADDITIONS WITHOUT APPROVAL OF THIS OFFICE.

CT = CLEAR TRUNK

FTG = FULL TO GROUND

ESP = ESPALIER

IRRIGATION PIPING, SPRINKLERS, AND OTHER EQUIPMENT MAY BE SHOWN OUTSIDE OF LANDSCAPE AREAS ON DRAWING

THE TECHNICAL SPECIFICATIONS ARE MADE A PART OF THESE PLANS AND SHALL BE CONSULTED BY THE LANDSCAPE CONTRACTOR. THE LANDSCAPE CONTRACTOR IS RESPONSIBLE FOR IMPLEMENTING WORK AS SPECIFIED IN THE

THE LANDSCAPE CONTRACTOR SHALL NOTIFY THIS OFFICE OF ANY DISCREPANCIES PRIOR TO BEGINNING OR CONTINUING

SIZE OF PLANT MATERIALS SHALL CONFORM WITH THE CURRENT EDITION OF 'AMERICAN STANDARD FOR NURSERY STOCK'

GAL = GALLON CONTAINER

HC = HURRICANE CUT MS = MULTI-STEMMED TRUNK

OC = ON-CENTER

SEE LANDSCAPE NOTES AND SPECIFICATIONS FOR FURTHER REQUIREMENTS RELATED TO THIS DETAIL

ADD EXCESS SOIL TO ADJACENT PLANT BED AFTER PULLING BACK EXISTING MULCH. RAKE SOIL AND

SP = SPECIMEN MATERIAL

TF = TREE FORM HABIT

TYP = TYPICAL

FOR NUMBER ONE GRADE NURSERY STOCK AS ADOPTED BY THE AMERICAN ASSOCIATION OF NURSERYMEN AND

THE QUANTITIES ON THE SCHEDULE ARE ONLY A GUIDE. ALL QUANTITIES SHALL BE VERIFIED BY THE LANDSCAPE

LANDSCAPE CONTRACTOR SHALL SUBMIT TO LANDSCAPE ARCHITECT THE LAB RECOMMENDATIONS FOR SOIL

AMENDMENTS TO BE ADDED TO PRODUCE PLANTING SOIL SUITABLE FOR HEALTHY, VIABLE PLANTS.

AND PLANTING BEDS. COORDINATE IRRIGATION WITH OWNER'S REPRESENTATIVE.

INSTALLED BENEATH ADJACENT HARDSCAPE AS NECESSARY.

TECHNICAL SPECIFICATIONS AND ON THESE PLANS.

CON = CONTAINERIZED MATERIAL FWF = FULL WELL FORMED

Landscape Notes

AMERICAN NATIONAL STANDARDS INSTITUTE.

CONTRACTOR ON THE PLANTING PLAN.

SCALE: NOT TO SCALE

&B = BALLED & BURLAPPED

BR = BARE ROOT MATERIAL

CAL = TRUNK CALIPER (MIN)

LABORATORY STATING PERCENTAGES OF ORGANIC MATTER; GRADATION OF SAND, SILT, AND CLAY CONTENT; CATION

EXCHANGE CAPACITY; SODIUM ABSORPTION RATIO; DELETERIOUS MATERIAL; BUFFER PH LEVELS; AND MINERAL AND

22. PLANTINGS SHALL BE PRUNED TO CONFORM WITH THE REQUIREMENTS OF ALL AUTHORITIES HAVING JURISDICTION,

23. THE LANDSCAPE CONTRACTOR SHALL BE RESPONSIBLE FOR CLEANING UP THE SITE AT THE COMPLETION OF THE

OR LANDSCAPE ARCHITECT SHALL INSPECT REPLACED PLANTS WHEN ALL REPLACEMENTS HAVE BEEN MADE. REPLACEMENTS ARE TO BE ALIVE AND IN A HEALTHY CONDITION WHEN THE REPLACEMENTS ARE COMPLETE.

DRAINAGE AND SHALL BE PROVIDED APPROPRIATE SOIL FOR THE PROPOSED PLANTINGS, SEE SOIL NOTES. 19. ALL EXISTING VEGETATION WITHIN AREAS TO BE PLANTED, SODDED AND/OR SEEDED SHALL BE REMOVED PRIOR TO PLANTING, SODDING, AND SEEDING. ALL AREAS INDICATED TO BE GRASS SEED SHALL BE SEEDED PER GRASSING

SCHEDULE. ALL DISTURBED NATURAL AREAS SHALL BE MULCHED (SEE MULCH SPECIFICATIONS).

INCLUDING BUT NOT LIMITED TO THE CITY, COUNTY, STATE AND FEDERAL REQUIREMENTS.

NO EXCAVATION OR PLANTING PIT SHALL BE LEFT UNATTENDED OVERNIGHT.

13. REMOVE PAPER, PLASTIC OR METAL AROUND ROOT BALLS OF SHRUBS.

WATER ALL PLANT MATERIAL IMMEDIATELY AFTER PLANTING.

SPECIFICATIONS FOR PERMANENT STABILIZATION.

16. TREE GUYING MATERIAL SHALL BE 'ARBOR-TIE' OR EQUIVALENT.

21. DRAINAGE TO BE PROVIDED FOR ALL ABOVE GROUND PLANTERS.

OTHER DEBRIS RESULTING FROM WORK OF THE PROJECT.

12. REMOVE BURLAP/STRAPPING AND WIRE BASKET FROM TOP 1/3 OF ROOT BALL ON TREES.

GROWTH (TOP CANDLE).

ANOTHER CONTRACTOR.

RRIGATION NOTES:

CIVIL ENGINEER

PLANT-NUTRIENT CONTENT OF THE SOIL.

OR AMENDED FOR PLANTING PURPOSES.


FINISH GRADES AFTER NATURAL SETTLEMENT.

14. DO NOT WRAP TREES.

— SINGLE CENTRAL LEADER ROOT BALL SURFACE SHALL BE POSITIONED TO BE ONE - QUARTER ABOVE FINISHED GRADE TRUNK CALIPER SHALL MEET ANSI Z60 — CURRENT EDITION FOR ROOT BALL SIZE. PRIOR TO MULCHING, LIGHTLY TAMP SOIL AROUND THE ROOT BALL IN 6" LIFTS TO BRACE TREE. DO NOT OVER ROOT BALL MODIFIED AS REQUIRED. COMPACT. WHEN THE PLANTING HOLE HAS BEEN BACKFILLED, POUR ROUND-TOPPED SOIL BERM 4" HIGH X 8" WATER AROUND THE ROOT BALL TO WIDE ABOVE ROOT BALL SURFACE SHALL SETTLE THE SOIL. BE CONSTRUCTED AROUND THE ROOT — BALL. BERM SHALL BEGIN AT ROOT BALL 4" LAYER OF MULCH. NO MORE THAN —1" OF MULCH ON TOP OF ROOT BALL. (SEE SPECIFICATIONS FOR MULCH). EXISTING SITE SOIL ADDED TO CREATE A SMOOTH TRANSITION FROM THE TOP OF — ORIGINAL GRADE THE RAISED ROOT BALL TO THE FINISHED GRADE AT A 15% MAX. SLOPE - FINISHED GRADE -EXISTING SOIL IO. MEASUREMENT OF CONIFER HEIGHT SHALL INCLUDE NOT MORE THAN FIFTY (50) PER CENT OF THIS YEARS' VERTICAL LOOSENED SOIL **BOTTOM OF ROOT BALL** - DIG AND TURN THE SOIL TO RESTS ON EXISTING OR -→ 3X WIDEST DIMENSION OF ROOT BALL. → REDUCE COMPACTION TO THE RECOMPACTED SOIL. AREA AND DEPTH SHOWN. SECTION VIEW


NOTES:

1. SEE LANDSCAPE NOTES AND SPECIFICATIONS FOR FURTHER REQUIREMENTS RELATED TO THIS DETAIL

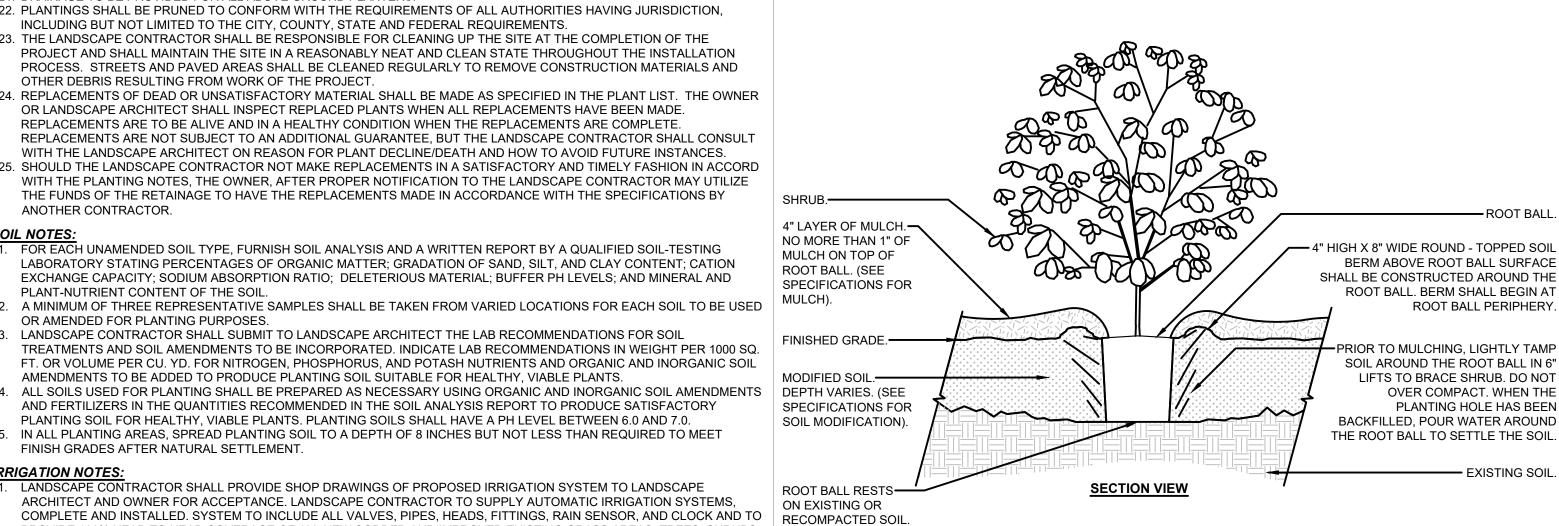

1. SEE LANDSCAPE NOTES AND SPECIFICATIONS FOR FURTHER REQUIREMENTS RELATED TO THIS DETAIL.


Shrub Planting - Modified Soil

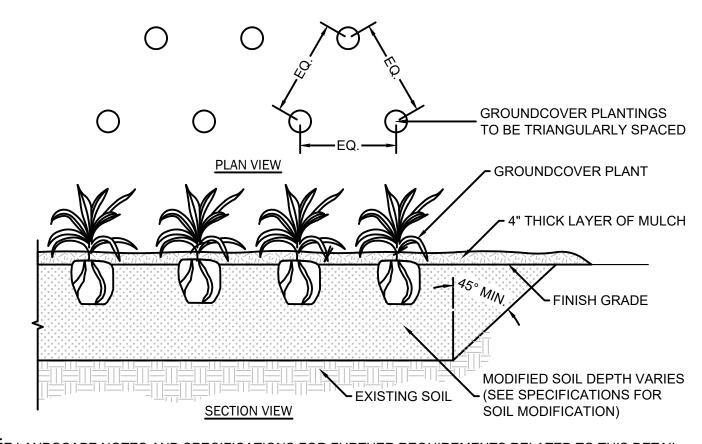

1. SEE LANDSCAPE NOTES AND SPECIFICATIONS FOR FURTHER REQUIREMENTS RELATED TO THIS DETAIL. 2. SEE PLANT SCHEDULE FOR PLANT SPECIES, SIZE, AND SPACING DIMENSION.

- SMALL ROOTS (χ " OR LESS) THAT GROW AROUND, UP, OR DOWN THE ROOT BALL PERIPHERY ARE CONSIDERED A NORMAL CONDITION IN CONTAINER PRODUCTION AND ARE ACCEPTABLE HOWEVER THEY SHOULD BE ELIMINATED AT THE TIME OF PLANTING. ROOTS ON THE PERIPHERY CAN BE REMOVED AT THE TIME OF PLANTING.
- BED AREA. WORK SOIL TO LOOSE, UNIFORMLY FINE TEXTURE.
- CONTRACTOR IS RESPONSIBLE FOR PROVIDING DRAINAGE FROM PLANTING HOLE/BEDS IF COMPACTED

6 Groundcover / Ornamental Grass Planting Detail

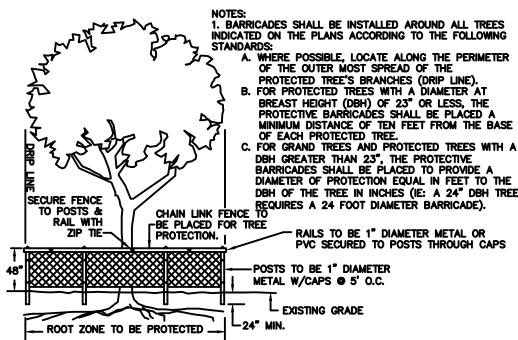





2.5" CAL

2.5" CAL

2.5" CAL

1.5" CAL

1.5" CAL

1.5" CAL

3 GAL

3 GAL

3 GAL

3 GAL

3 GAL

3 GAL

4" POT

SOD

8' MIN

8' MIN

8' MIN

8' MIN

18"-24"

18"-24"

18"-24"

18"-24"

18"-24"

8"-12"

18"-24"

18"-24"

18"-24"

18"-24"

18"-24"

18"-24"

18"-24"

8"-12"

N/A



CHARCOAL ONE RECEPTACLE WILL HAV OTHER WILL HAVE TRASH

BELSON OUTDOORS

BELSON.COM

MANUFACTURER

Trash And Recycling Receptacles

IFWF. SP

FWF, SP

AS SHOWN

24"

N/A

WHITESIDE & ASSOCIATES, INC. NO. C-2466

MOUNT PLEASANT, SC

843.884.1667

GREENVILLE, SC

864.298.0534

SUMMERVILLE, SC

843.972.0710


SPARTANBURG, SC

864.272.1272

CHARLOTTE, NC

980.312.5450

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SW+ PROJECT:	10772
DATE:	1/28/2
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CHECKED BY:	TL
	·

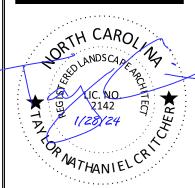R	EVISION	Н	STOR'
	10/30/23		
A	12/22/23	F	11/06/2
В	03/01/24	G	12/20/2
С	09/04/24	Н	1/03/2
D	10/01/24		
E	11/01/24		

PLANT SCHEDULE & NOTES

ROOT BALL.

PLANT SCHEDULE

ACRO

ILEO

QUEP

ACPB

CERO

CHIV

ABES

AZAF

ILCB

LCRR

PODM

MUHL

LMBB

SOD2

27,770 SF

INDERSTORY TREES

BOTANICAL / COMMON NAME

LEX OPACA / AMERICAN HOLLY

QUERCUS PALUSTRIS / PIN OAK

ACER RUBRUM 'OCTOBER GLORY' TM / OCTOBER GLORY MAPLE

ACER PALMATUM `BLOODGOOD` / BLOODGOOD JAPANESE MAPLE

CERCIS CANADENSIS 'OKLAHOMA' / OKLAHOMA REDBUD

ABELIA X GRANDIFLORA `SHERWOODII` / DWARF ABELIA

LEX CORNUTA 'BURFORDII NANA' / DWARF BURFORD HOLLY

LOROPETALUM CHINENSE RUBRUM `RUBY` / DWARF RUBY FRINGE FLOWER

PANICUM VIRGATUM 'HEAVY METAL' / HEAVY METAL SWITCH GRASS

CHIONANTHUS VIRGINICUS / WHITE FRINGETREE

AZALEA INDICA `FORMOSA` / FORMOSA AZALEA

PODOCARPUS MACROPHYLLUS / SOUTHERN YEW

LIRIOPE MUSCARI 'BIG BLUE' / BIG BLUE LILYTURF

CYNODON DACTYLON 'TIFTUF' / TIFTUF BERMUDA GRASS

MUHLENBERGIA FILIPES / SWEETGRASS

4. THOROUGHLY TILL IN PLANTING SOIL MIXTURE AMENDMENTS TO DEPTH OF 8" IN ENTIRE GROUNDCOVER


SOILS OR POORLY DRAINED SOIL IS ENCOUNTERED. HAND-TAMP BACKFILL TO REMOVE VOIDS AND AIR POCKETS. WATER IMMEDIATELY AFTER PLANTING UNTIL


SMOOTH BEFORE MULCHING.

SUBGRADE -

EXCAVATE TRENCH BY HAND WITH SPADE.

L1.1

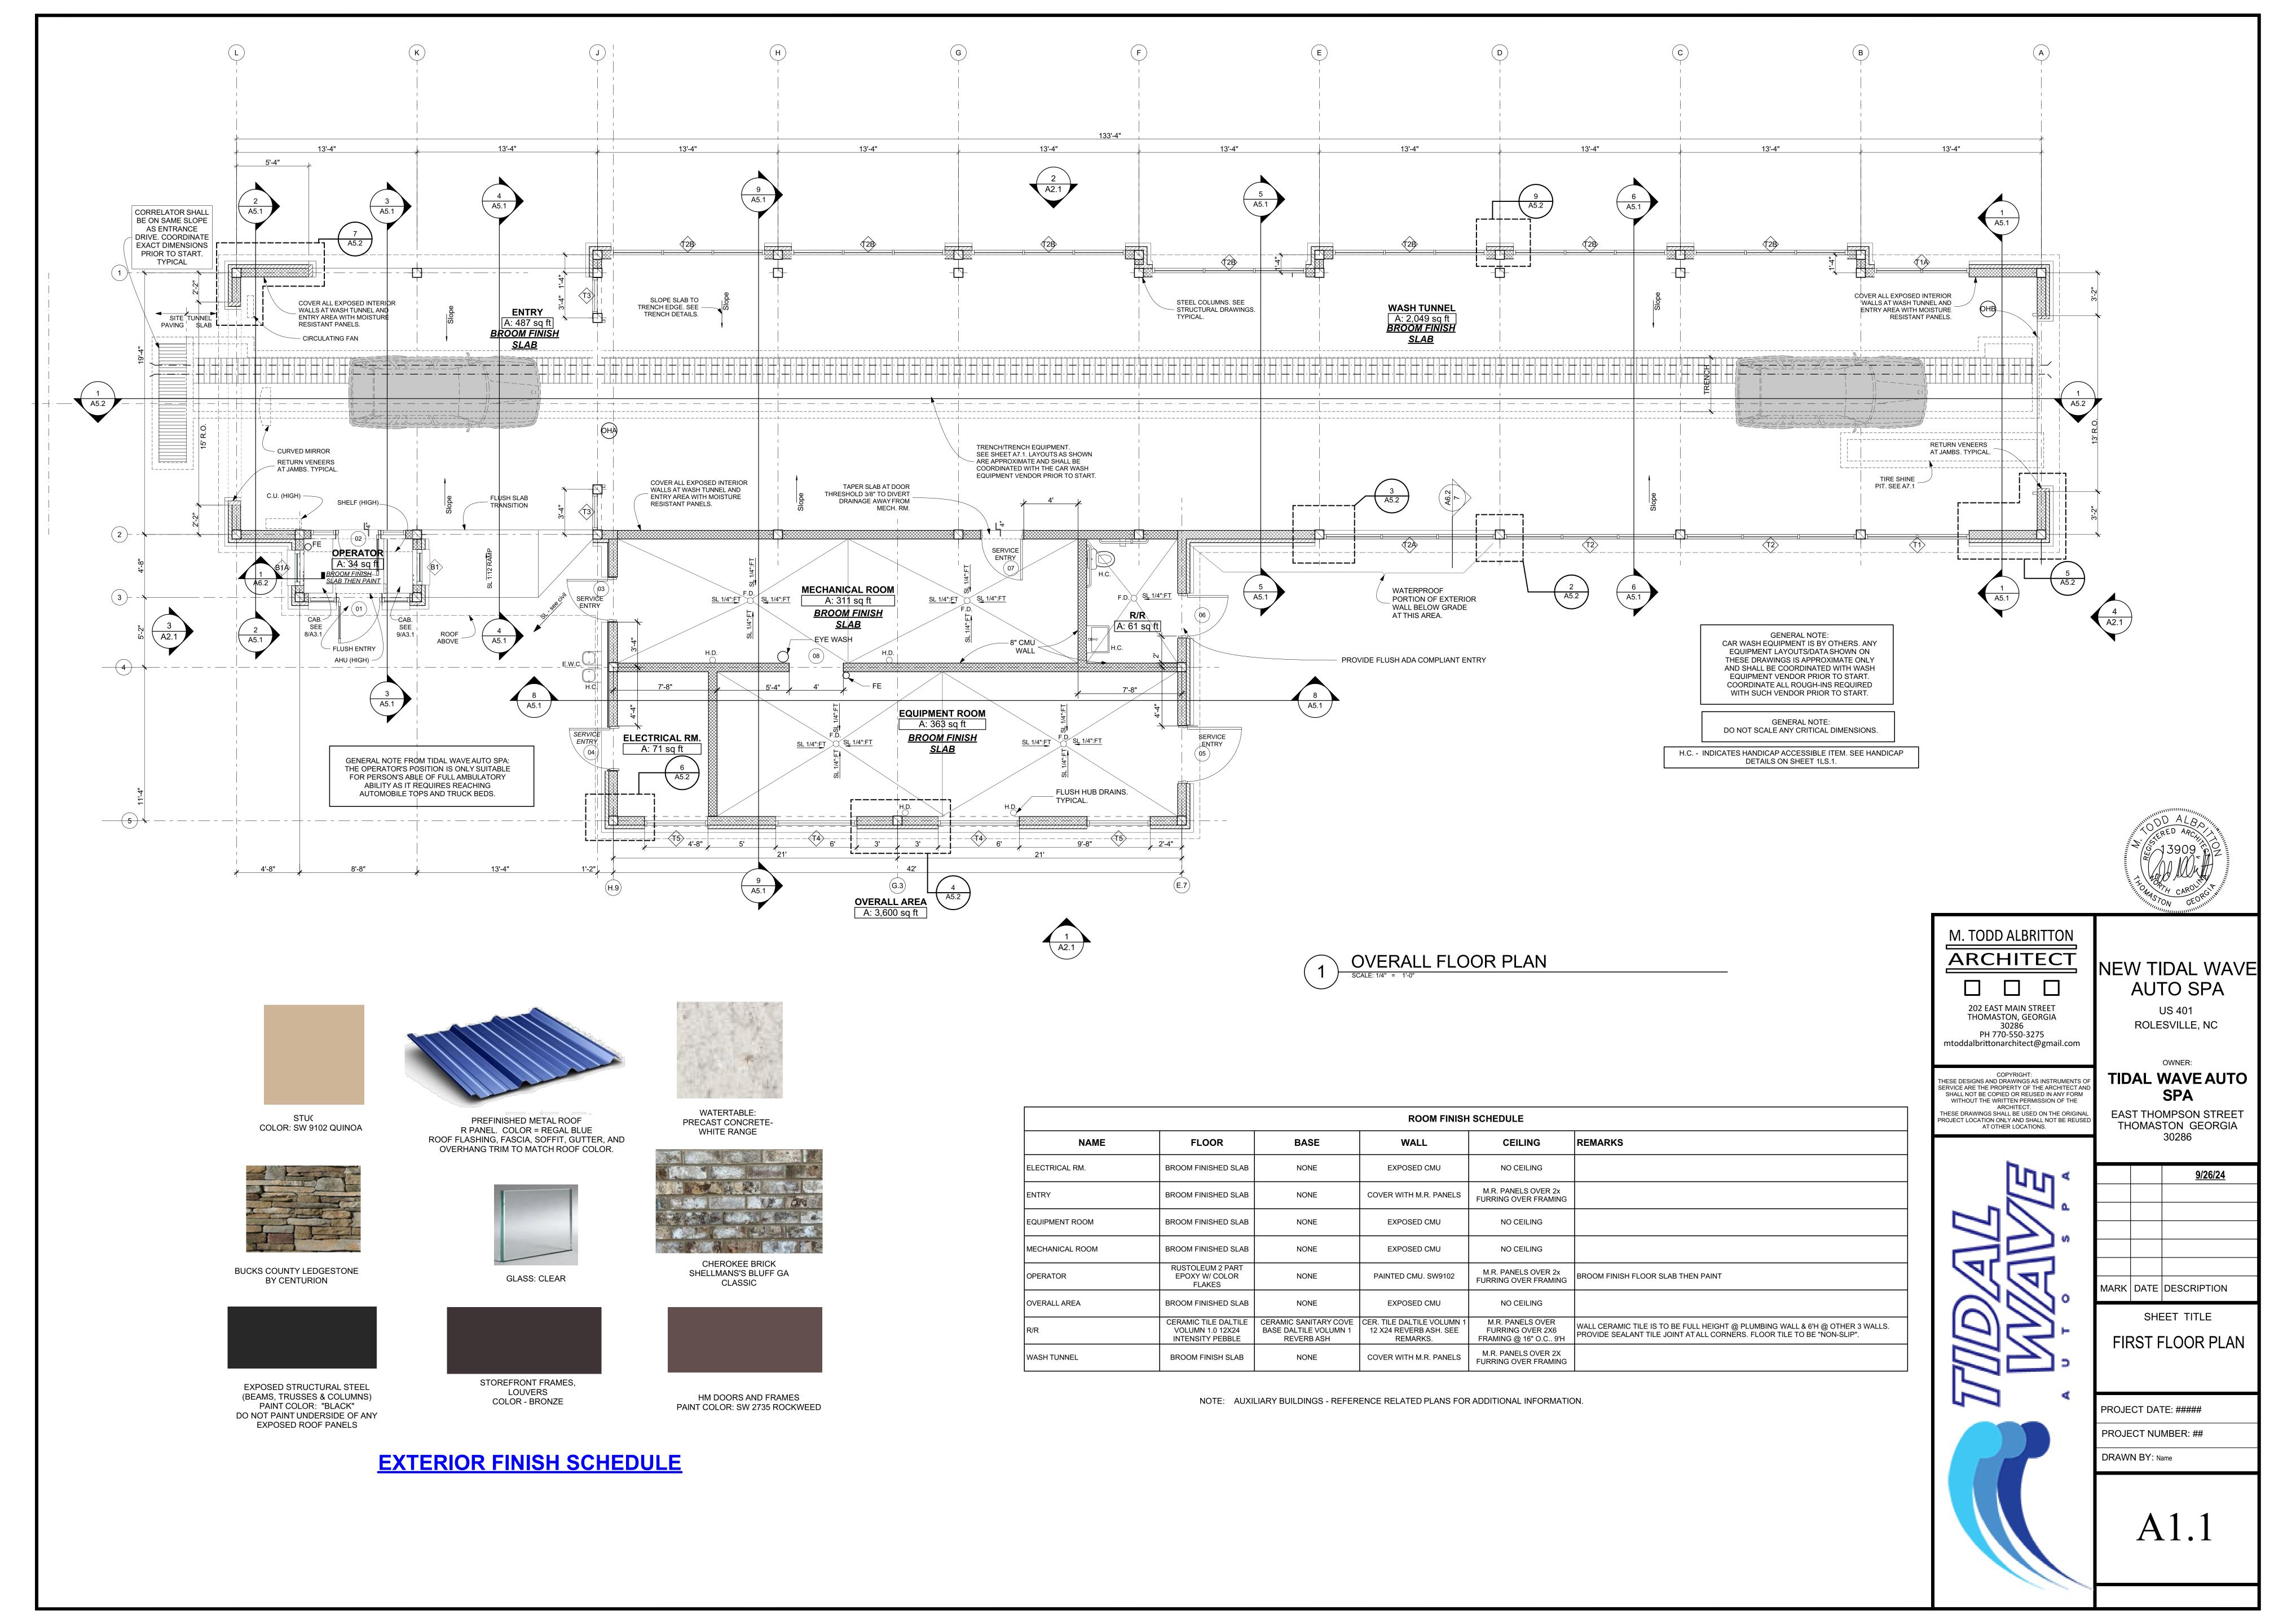

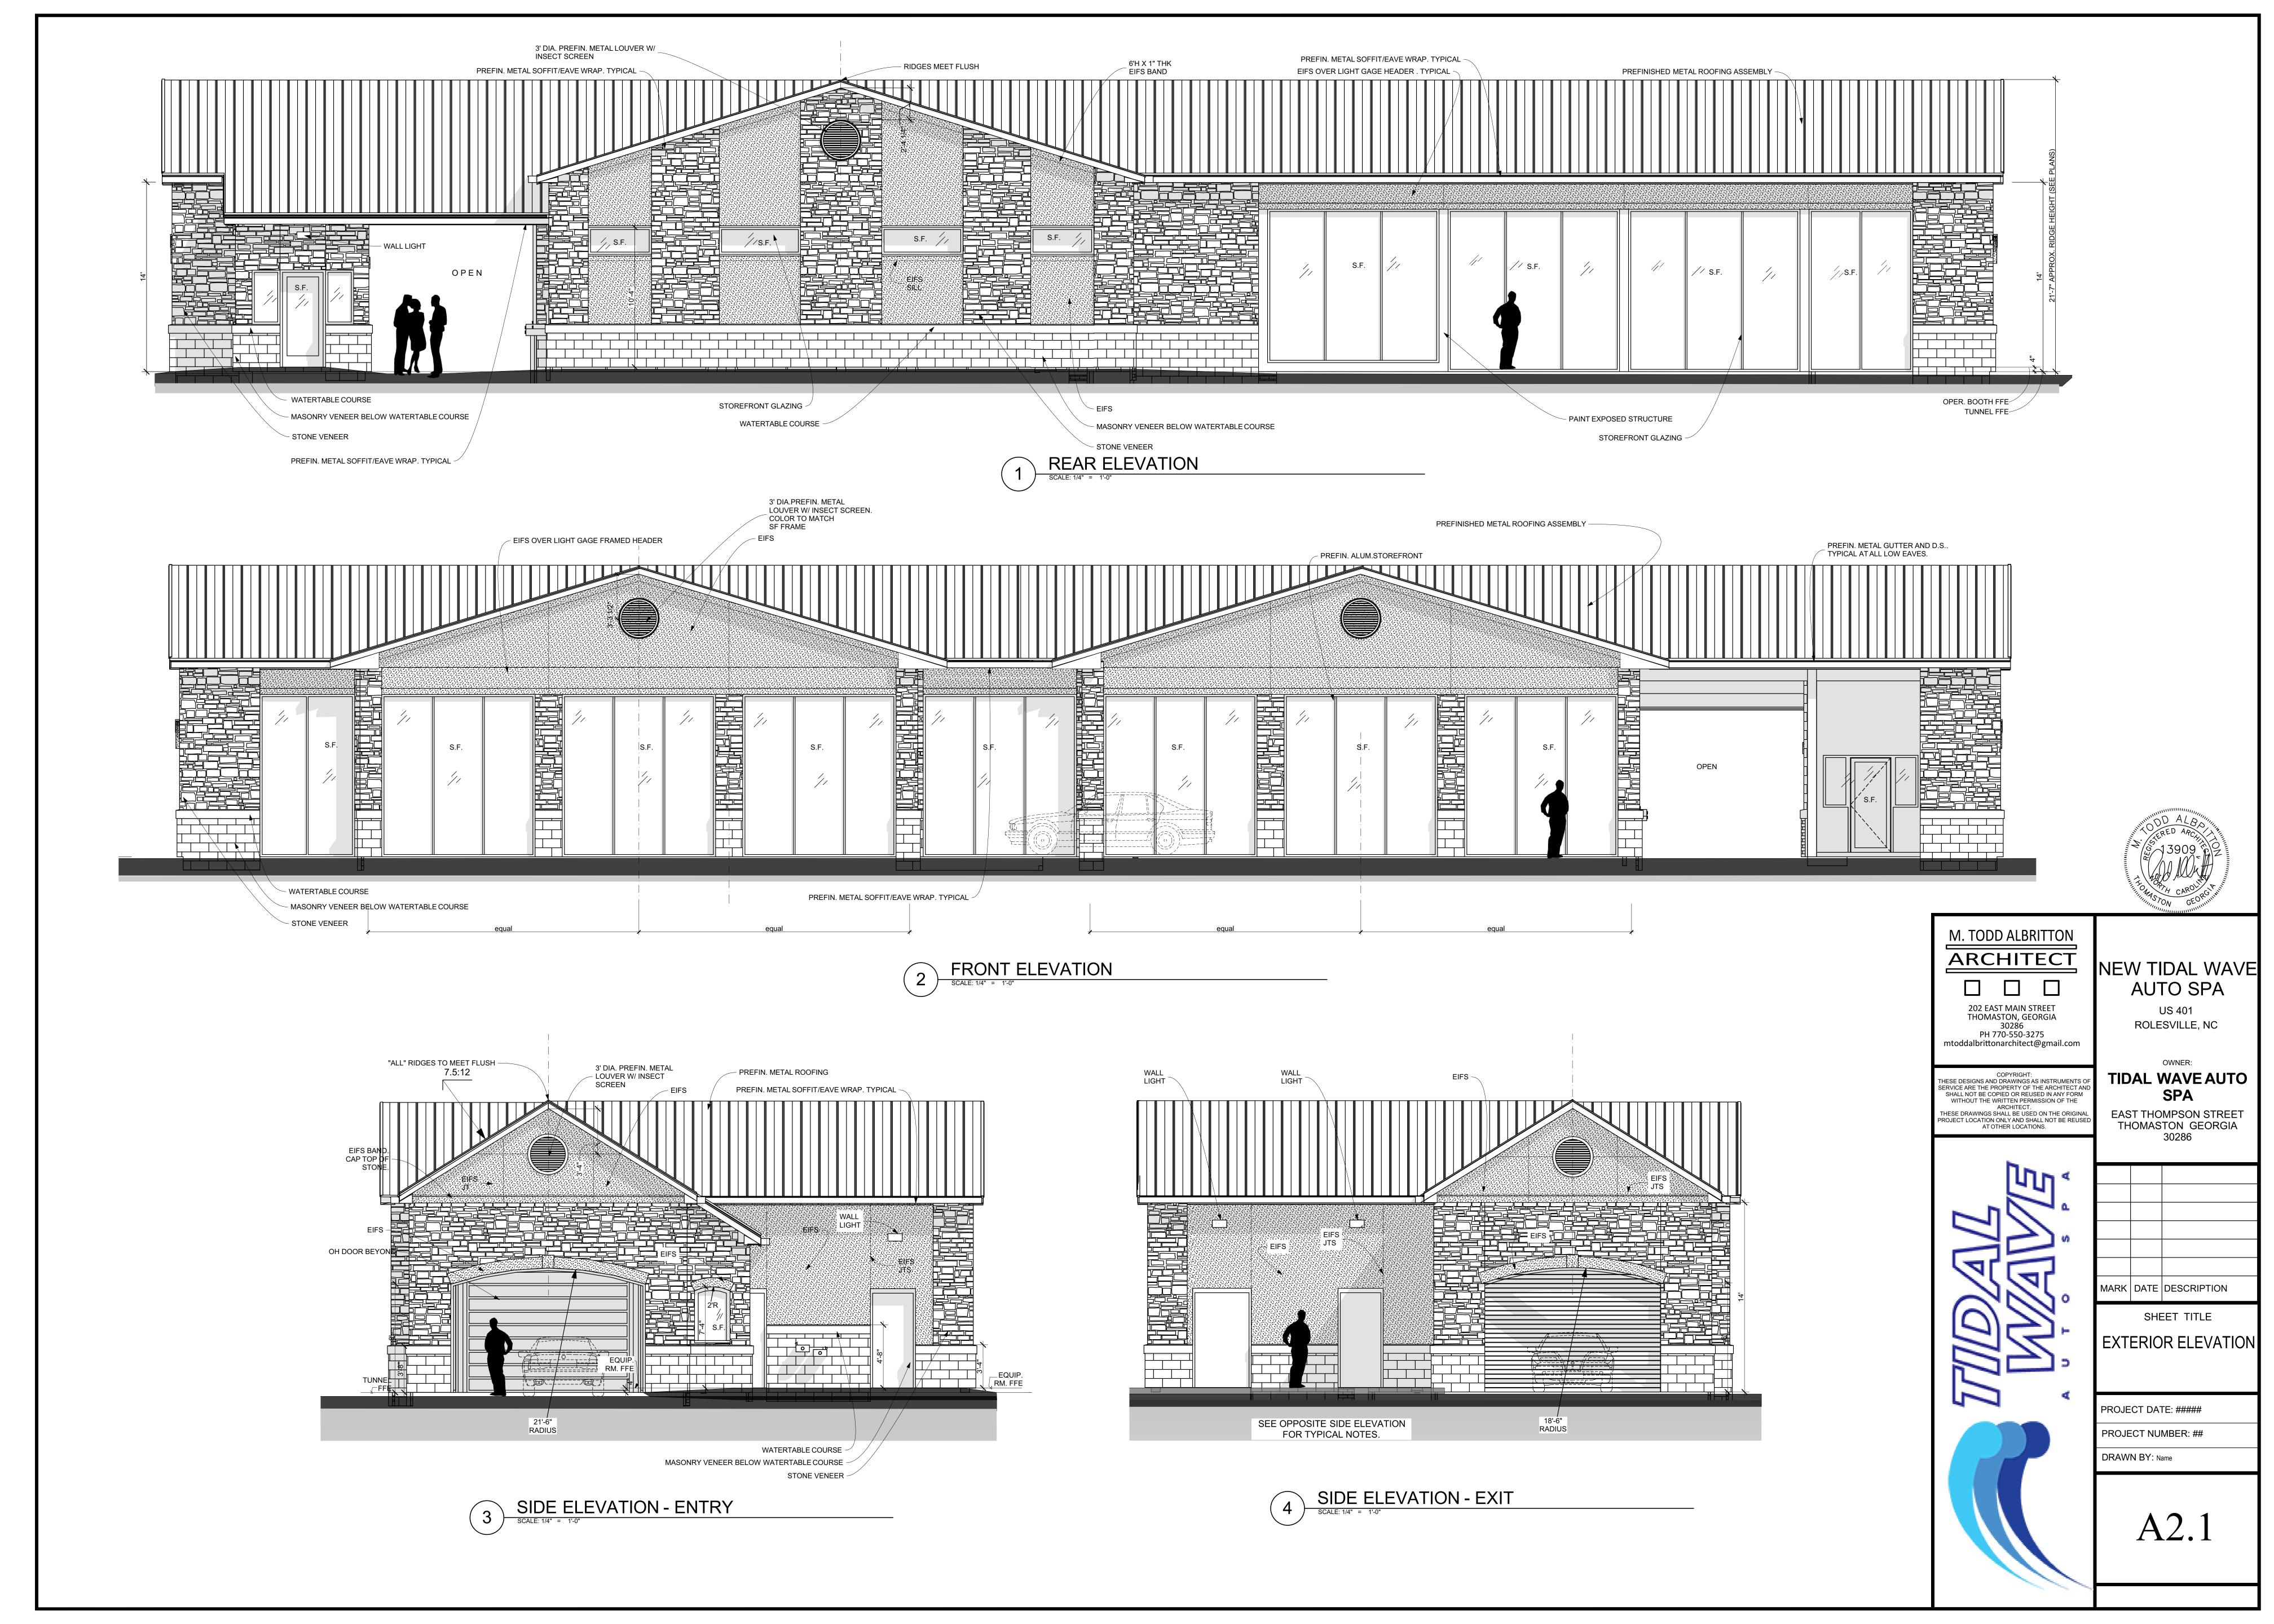



SIDE ELEVATION - ENTRY(NORTHEAST)

SCALE: 1/4" = 1'-0"

CULTURED STONE AREA = 176 SF


GLAZED AREA = 8 SF + 124 SF OPEN ARCHED AREA = 132 SF = 31 % WE REQUEST THAT THE OPEN ARCHED AREA COUNT AS GLAZED AREA.

BRICK/STONE AREA = 214 SF = 74% OF NON-GLAZED FACADE AREA


STUCCO AREA = 75 SF

NOT A PRIMARY FACADE 4 HVAC - SECOND FLOOR (SOUTHWEST) NEW TIDAL WAVE **AUTO SPA** US 401 ROLESVILLE, NC

> EAST THOMPSON STREET THOMASTON GEORGIA 30286

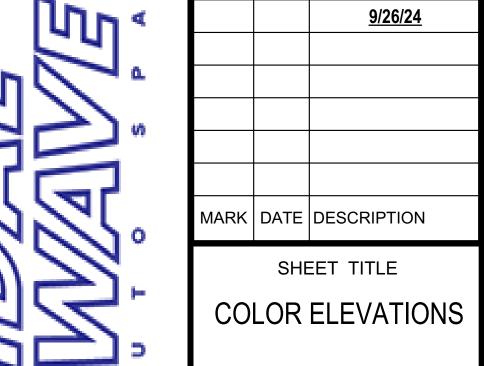

PROJECT NUMBER: ## DRAWN BY: Name

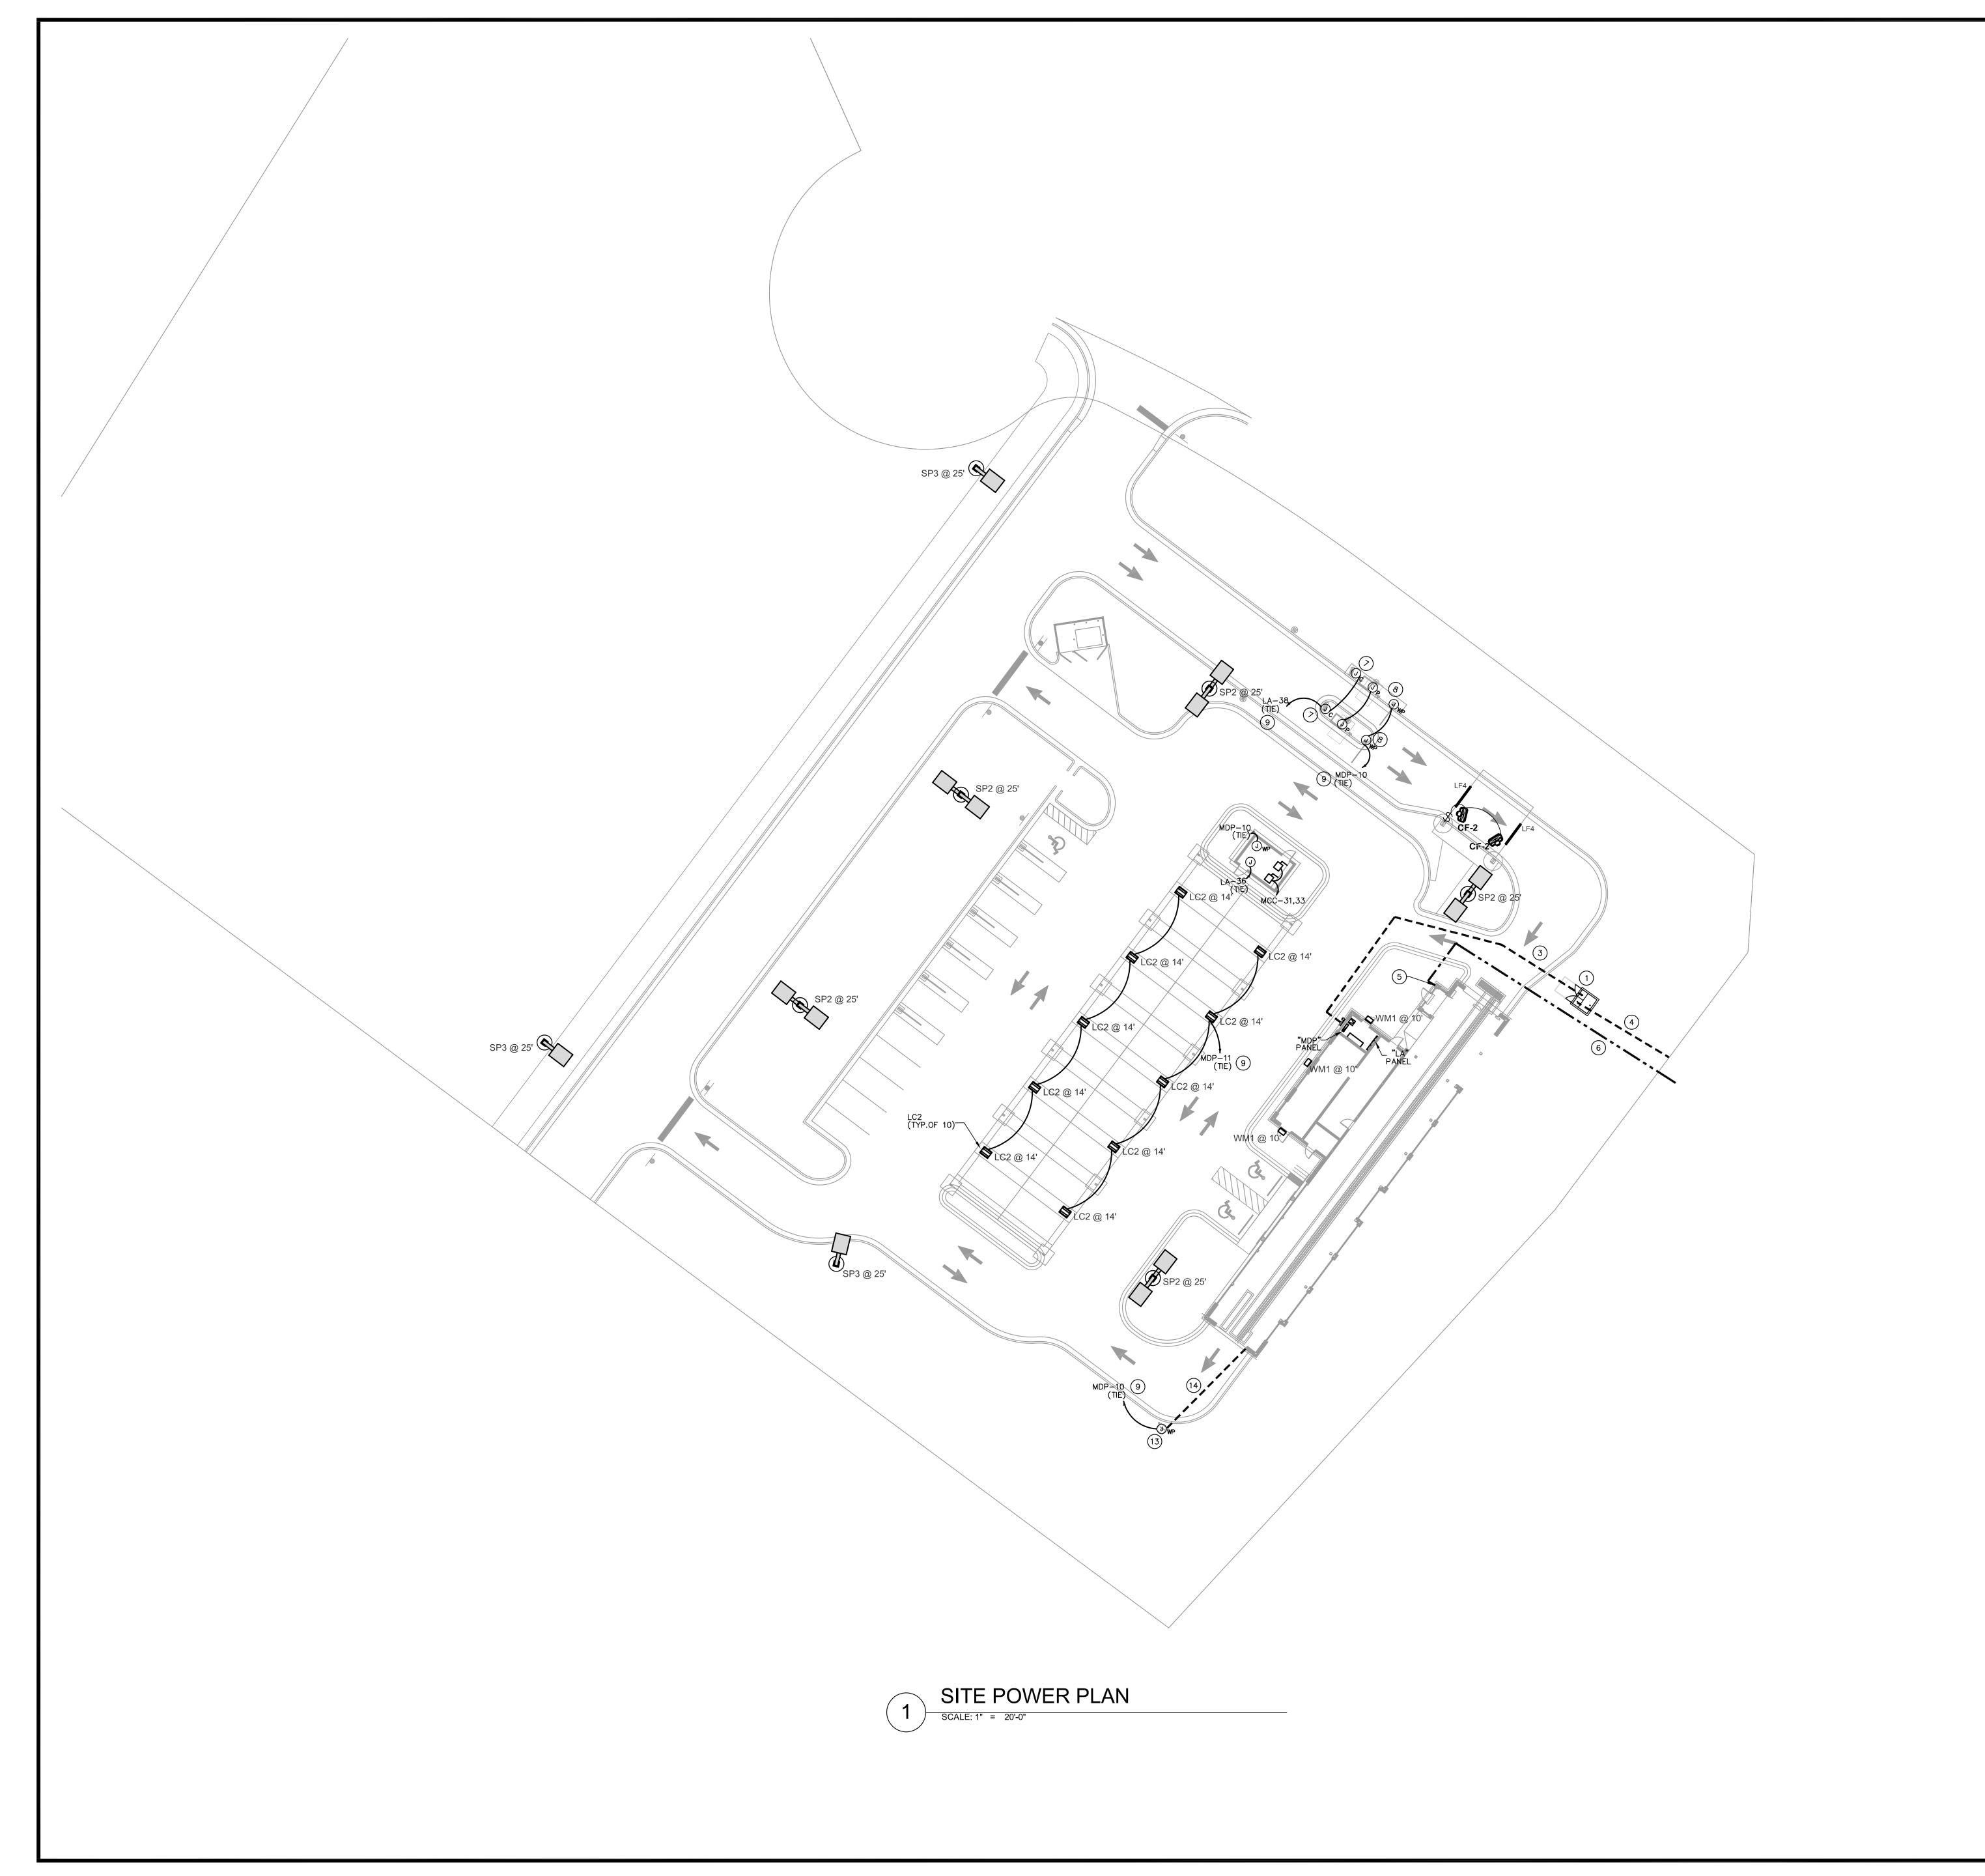

KEY NOTES

- 1) PROPOSED LOCATION OF PAD MOUNTED UTILITY TRANSFORMER. COORDINATE EXACT LOCATION WITH UTILITY PRIOR TO ROUGH IN.
- PROPOSED LOCATION OF BUILDING METER / SHUNT TRIP BUTTON, REFER TO ELECTRICAL RISER DIAGRAM ON SHEET E5.1 FOR REQUIREMENTS.
- PROPOSED ROUTING OF UNDERGROUND SERVICE LATERAL, COORDINATE EXACT ROUTING AS REQUIRED, REFER TO ELECTRICAL RISER DIAGRAM ON SHEET E5.1 FOR REQUIREMENTS.
- PROPOSED ROUTING OF UNDERGROUND UTILITY PRIMARY. CONTRACTOR TO COORDINATE EXACT LOCATION AND REQUIREMENTS WITH UTILITY PRIOR TO STARTING ANY WORK.
- 5 LOCATION OF COMMUNICATION OUTLET IN OPERATOR'S STATION, REFER TO TELEPHONE DETAIL ON SHEET E5.1 FOR REQUIREMENTS.
- 6 PROPOSED ROUTING OF COMMUNICATION CONDUITS, COORDINATE EXACT ROUTING AS REQUIRED. REFER TO TELEPHONE DETAIL ON SHEET E5.1 FOR REQUIREMENTS.
- 7 PROVIDE ELECTRICAL AND DATA CONNECTION FOR PAY STATION KIOSKS. COORDINATE EXACT LOCATION AND REQUIREMENTS WITH SYSTEM INSTALLER AND CONNECT FOR OPERATION.
- (8) JUNCTION BOX FOR PAY STATION / PREP CANOPY LIGHTING.
- 9 WIRE CIRCUIT THRU TIME CLOCK AND LIGHTING CONTACTOR. REFER TO ELECTRICAL RISER DIAGRAM ON SHEET E5.1 FOR REQUIREMENTS.
- JUNCTION BOX FOR VACUUM ENCLOSURE LIGHTING. PROVIDE MANUAL SWITCH(ES) AT ENCLOSURE ENTRANCE FOR LIGHTING CONTROL.
- 11) JUNCTION BOX FOR VACUUM ENCLOSURE VENDING RECEPTACLE.
- PROVIDE 60 AMP, NEMA 3R ELECTRICAL DISCONNECT FOR VACUUM MOTOR. COORDINATE EXACT LOCATION AND REQUIREMENTS WITH SYSTEM INSTALLER AND CONNECT FOR OPERATION.
- JUNCTION BOX FOR ELECTRICAL CONNECTION TO WAIT & GO LIGHT (30-C). COORDINATE EXACT LOCATION AND REQUIREMENTS WITH CAR WASH VENDOR DRAWINGS PRIOR TO ROUGH IN AND CONNECT
- (2) 3/4" CONDUITS UNDER SLAB FOR WAIT & GO CAMERA AND WAIT & GO LIGHT 120V RELAY. COORDINATE EXACT LOCATION AND REQUIREMENTS WITH CAR WASH VENDOR DRAWINGS PRIOR TO ROUGH IN AND CONNECT FOR OPERATION.
- (15) JUNCTION BOX FOR POWER TO CANOPY FAN.

GENERAL NOTES

- REFER TO SITE LIGHTING FIXTURE SCHEDULE ON SHEET E1.2 FOR REQUIREMENTS OF FIXTURES.
- REFER TO LIGHTING PLAN ON SHEET E2.1 FOR WALL PACK ELECTRICAL REQUIREMENTS.
- ALL SITE LIGHTING POLES INDICATED ON THIS SHEET WILL BE POWERED, CONTROLLED, AND SERVICED BY THE LOCAL UTILITY

GENERAL MECHANICAL POWER NOTE

REFER TO SHEET E5.1, MECHANICAL EQUIPMENT—ELECTRICAL SCHEDULE, FOR POWER REQUIREMENTS TO ALL MECHANICAL EQUIPMENT INDICATED ON THIS SHEET.

M. TODD ALBRITTON **ARCHITECT**

202 EAST MAIN STREET THOMASTON, GEORGIA

30286 PH 770-550-3275

mtoddalbrittonarchitect@gmail.com

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NEW TIDAL WAVE AUTO SPA

> US 401 ROLESVILLE,

TIDAL WAVE **AUTO SPA**

EAST THOMPSON STREET THOMASTON GEORGIA 30286



02/26/24 PERMIT COMMENT MARK DATE DESCRIPTION

SHEET TITLE


PROJECT DATE: 02/26/2024 PROJECT NUMBER: 2023-0208 DRAWN BY: GMF

SCOTT MERIWETHER, P.E. NORTH CAROLINA LICENSE #36775 4245 LAND RD BALL GROUND, GA 30107 PROJECT MANAGER: SCOTT MERIWETHER

PHONE 678.246.5166

SHEET 2

OF 5

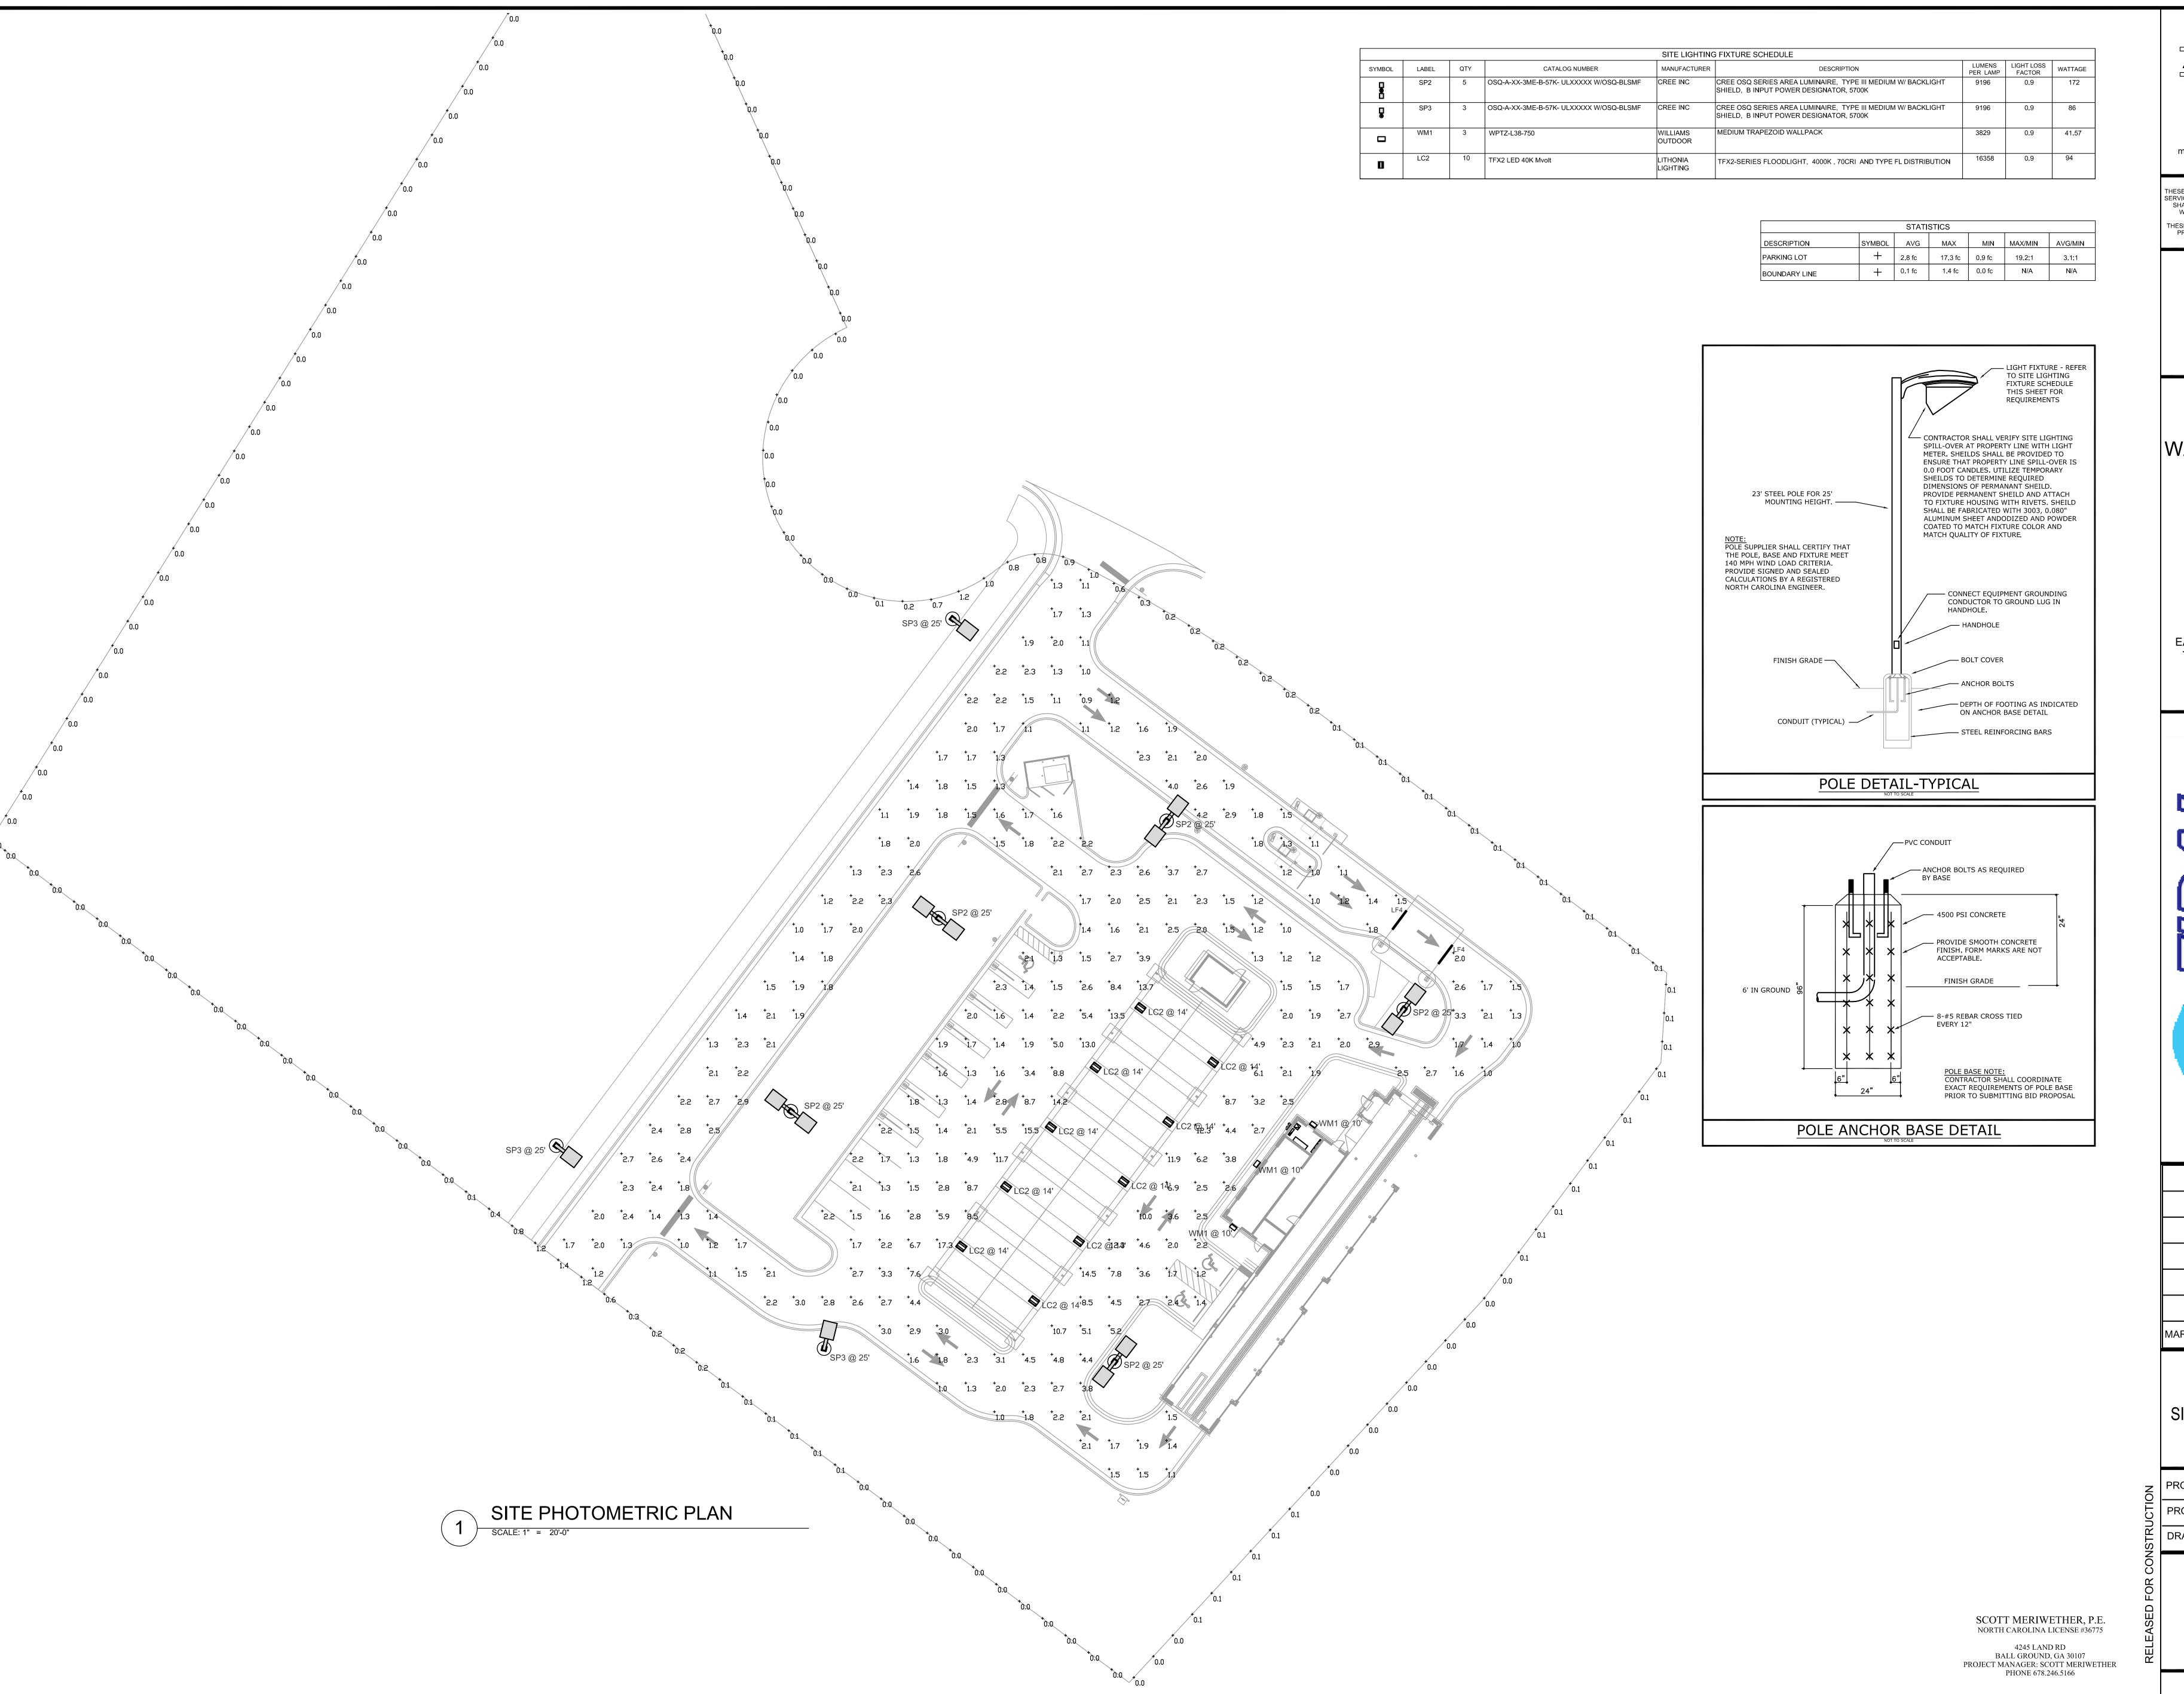

M. TODD ALBRITTON

ARCHITECT

202 EAST MAIN STREET THOMASTON, GEORGIA 30286 PH 770-550-3275 mtoddalbrittonarchitect@gmail.com

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NEW TIDAL WAVE AUTO SPA

> US 401 ROLESVILLE, NC

OWNER:
TIDAL WAVE
AUTO SPA

EAST THOMPSON STREET THOMASTON GEORGIA 30286



02/26/24 PERMIT COMMENT
12/20/23 PERMIT SET

MARK DATE DESCRIPTION

SHEET TITLE

SITE PHOTOMETRIC PLAN

PROJECT DATE: 02/26/2024
PROJECT NUMBER: 2023-0208

DRAWN BY: GMF

E1.2